

Jones Gillam Renz Architects

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Report No.

Web

igrarchitects.com

One (1)

ARCHITECT'S SUPPLEMENTAL INSTRUCTIONS

JONES GILLAM RENZ DOCUMENT JGR 710

PROJECT: The Reserves at Magnolia

New Apartment Complex Denton, TX

Overland Property Group OWNER:

Dan Maximuk

234 N. Santa Fe Ave, Suite A

Salina, KS 67401

CONTRACTOR: Snyder Construction Group

4820 N. Town Centre Dr. Ozark, MO 65721

Date Oct. 22, 2024

Architect's Proj No. 21-3205

Contract For: General Construction

Mechanical, Electrical

The work shall be carried out in accordance with the following supplemental instructions issued in accordance with the Contract Documents without change in Contract Sum or Contract Time. Prior to proceeding in accordance with these instructions, indicate your acceptance of these instructions for minor change to the Work as consistent with the Contract Documents and return a copy to the Architect.

Please Note: Drawings and Specification Edits associated with this ASI are dated as 7-17-2024. This date above is the date this ASI was issued.

DESCRIPTION:

Contractor to make adjustments as needed and required per the modifications as indicated on attached drawings and in the below descriptions. Items associated with a VE item, will be noted as such.

- At Perimeter Fence: Utilize Doug Fir pickets (in lieu of Cedar) with galvanized post (in lieu of wood posts) and treated pine rails. All "Structure" (posts, rails, etc) must face inside, towards the property. (VE Item #3)
- Omit staining and sealing of the wood fence and dumpster fence enclosure pickets. (VE Item #4)
- Utilize a black chain link fence in lieu of the Aluminum Ameristar Montage Fence product. Fence must be 4' tall. (VE Item #5)
- 4) Omit sealed finish at all interior concrete areas designated as "sealed concrete". These shall be exposed concrete finish. (VÉ Item #7)
- 5) Utilize king sized brick in lieu of standard specified modular sized brick. (VE Item #8)
- Omit all interior thin pre-cast panels at Community Room #106 accent wall, and the entry vestibule area. (VE Item #9) Reference Revised plans and details on Sheets A2.1, A4.2, A4.8 and A8.2.
- Utilize standard vertical pickets at the metal stair/landing handrails/quardrail systems in lieu of the custom metal panel railings. (VE Item #10). Reference revised details on Sheets A6.2 & A6.3.
- Utilize 5/8" OSB Roof deck sheathing in lieu of the specified 3/4" Zip System Roof Sheathing. (VE Item #11)
- Casework in Food Pantry #107 has been reduced and reconfigured. (VE Item #12). Reference revised plan on Sheet A2.1 and 9) revised details on Sheet A8.3.
- 10) Omit all wood heads and jambs at pocket doors and bypass doors in apartment units. All will have a drywall return. (VE Item #13)
- 11) Omit all solid surface/marble windowsills. All windows to have painted wood windows sills. (VE Item #14)
- 12) Omit the requirement of water repellants at all exterior masonry. (VE Item #15)
- Utilize a ½" HD wood fiber coverboard in lieu of the specified ½" secure rock coverboard at the roofing assembly. (VE Item #16) 13)
- Utilize residential grade aluminum soffit panels in lieu of the specified Nichiha soffit panels at the underside of the entry canopy. Aluminum panels must have a "wood look" appearance and are subject to Architect's review and approval. (VE Item #18)
- 15) Utilize 5/8" type 'x' exterior-grade gypsum board finish at exterior breezeways in lieu of fiber cement siding and soffit. (VÉ Item #19) Exception: within 10 feet of each exterior opening. At these areas, fiber cement panel and trim shall be used. Reference revised details on Sheets A2.0, A3.3, A4.1, A4.6, A4.7, A4.8, A6.1, A6.2, A6.3, A7.1, A7.2, A7.3, and A7.4
- 16) Utilize hardie board and batten (smooth finish) in lieu of hardie reveal panels on the exterior façade. Reference revised elevations on A3.1 and A3.2 (VE Item #20)
- Omit Security Gate and Doors #114, #116, #121 and #122. (VE item #22). Reference revised plans and details on Sheets A2.1, A3.1, A3.2, A6.1, A6.2 and A10.2.
- Utilize 20-minute rated PVC Composite Door Jambs in lieu of 20-minute Hollow metal Door Jambs. Reference revised Sheet A10.2 (VE Item #23)
- Reduce the indicated door hardware allowance from \$120,000 to \$60,000. (VE Item #24)
- Omit tile backsplashes, at the kitchen, in all apartment units. (VE Item #25) Add 4" P.Lam backsplash to all kitchen countertops.
- Utilize Earthwerks Chassis Advantage 7"x48" 12 mil LVT flooring in lieu of the specified Patcraft Timber Grove 12 mil LVT Flooring. Final color to be selected by Architect from full range of collection's selections. (VE Item # 26)
- Utilize 1-1/4" beveled edge plate glass mirrors in lieu of the specified wood framed mirrors, at apartment unit bathrooms. (VE Item #27)

- 23) Utilize standard metal fire extinguisher cabinets in lieu of specified stainless steel fire extinguisher cabinets. (VE Item #28) Firerated cabinets must been provided where indicated on floor plans.
- Omit mirrors in Fitness Room #102. (VE Item #29)
- Omit all in-unit Washer and Dryer Appliances. (VÉ Item #30) 25)
- 26) Fill floor and roof truss cavities completely with blown-in insulation in lieu of fire sprinkler coverage within these cavities. (VE Item
- 27) Utilize a Watts model PLT-5 or equal expansion tank at HWH-A water heaters in lieu of the specified Watts Model DETA-12 expansion tanks. (VE Item #32) Reference revised Sheet P6.1
- Utilize residential grade plastic p-traps at all sinks in lieu of brass p-traps. (VE Item #33) Reference revised sheet P6.1
- Utilize foam insulation in lieu of specified fiberglass insulation at indicated domestic water piping. Conditional upon review of shop drawings and submittals. (VE item #34)
- 30) Omit domestic cold water piping insulation in its entirety (exception: where piping crosses the breezeway). (VE Item #35) Reference revised sheet P2.5
- Utilize PEX plumbing fixture stub outs in lieu of the specified copper stub outs. (VE Item #37)
- Utilize CPVC mains and risers in lieu of specified copper at plumbing systems. (VE Item #38)
- 33) Utilize EP fittings and multiport tees in lieu of copper mainfolds and brass fittings at plumbing systems. (VE Item #39) Reference revised sheets P4.1, P4.2, P4.3 and P6.1
- Utilize rubber condensing unit pads in lieu of specified Nvent Caddy Pyramid supports at rooftop condensing units. (VE Item #40). Reference revised Sheet ME2.1
- 35) Utilize an alternative light fixture package in lieu of the specified light fixtures. Conditional upon review of shop drawings and submittals. (VE Item #41)
- Utilize SER aluminum feeders in lieu of aluminum feeders. (VE Item #42). Reference revised Sheet E6.2
- Omit sales taxes from all material purchases. (VE Item #43)
 Reduction in Storefront (VE Item #44) Reference revised Sheets A2.1, A3.1 and A10.2
 - Omit Storefront Windows C & D, replace all with Window A.
 - Storefront Door 101 (frame type 5) has been reduced in size. b.
 - Storefront window F has been eliminated.
 - Door 102 has been changed to a Solid Core Wood Door with Hollow Metal Frame, Frame type 1. d.
 - Door 104 has been changed to a Solid Core Wood Door (type L) with PVC Composite Frame (type 1). Door and frame to be rated 20-minute.
 - Doors 107, 109, 111 & 112 have been changed to a Solid Core Wood Door with Hollow Metal Frame.
- 39) Utilize a \$200,000 landscaping and irrigation allowance in lieu of received bids. (VE Item #46). Landscaping design must meet City's requirements and calculations as noted on the landscaping plan. Final design will be subject to Architect's review and
- Omit all individual unit water submeters from the project. (VE Item #47). Reference revised sheets P5.2 and P5.3
- 41) Omit the island casework in Community Room #106. (VE Item #48). Reference revised plans and details on A2.1 and A8.2.

Attachments:

Revised Architectural Sheets: A2.0, A2.1 A3.1, A3.2, A3.3, A4.1, A4.2, A4.6, A4.7, A4.8, A6.1, A6.2, A6.3, A7.1, A7.2, A7.3, A7.4, A8.2, A8.3, A10.2

Revised MEP Sheets: ME2.1, E6.2, P2.5, P4.1, P4.2, P4.3, P5.2, P5.3, P6.1

Issued by: Jones Gillam Renz Architects PO Box 2928, Salina, KS 67402

Jeff Gillam, Project Architect Maggie Gillam, Project Manager jgillam@jgrarchitects.com 785 827 0386 mgillam@jgrarchitects.com

Copies to:

Josh Fisher - Snyder Construction Group Dan Maximuk, April Engstrom – Overland Property Group
John Lewis-Smith, Ryan Lies - LST Mike Falbe - BDC Andrea Taylor - MMA


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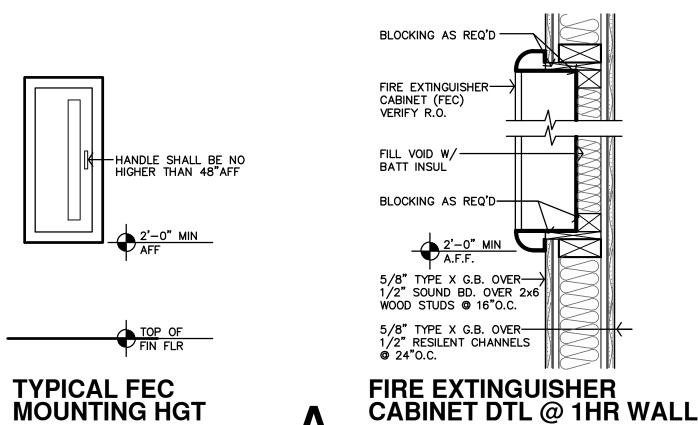
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850	OF 1	
REVISION:		
AØD₩1	6-19-2023	
ADD#2	9-8-2023	
ASIN 1	7-22-2024	
DATE:	5-17-2023	
JOB:	21-3205	(O)

SHEET NO.: **A2.0**





1 1/2"=1'-0"

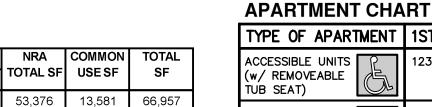1 BD 2 BD 3 BD

60

20 28

PROJECT UNIT SUMMARY

BUILDING

LABEL

APT BLDG

B

TYPE OF APARTMENT IST FLOOR 2ND FLOOR 3RD FLOOR 4TH FLOOR TOTAL (w/ REMOVEABLE TUR SEAT) 424 HEARING/VISION IMPAIRED & ADAPTABLE UNITS 11.112.113.114. 211.212.213.214. 311.312.313.314. 413.414.416.417 ALL REMAINING UNITS 116,118,121,124, 216,217,221,223, 316,317,318,319, 418,419,421,423, 126,127,128,129, 224,226,227, 323,324,326, 426,327,428,429 ADAPTABLE 327,328,329,331 4 228,229,231 TOTAL

123 - 1BED ACCESSIBLE 219 - 2BED ACCESSIBLE 321 - 3BED ACCESSIBLE 218 - 1BED HEARING & VISION 424 - 2BED HEARING & VISION

G.B. OR 1/2" PLYWOOD TO EXTEND THRU

3. STC RATING 50 MIN & IIC RATING 50 MIN

PER IBC 2021, SEC. 1206.2 & 1206.3

G.B. OR 1/2" PLYWOOD TO EXTEND THRU

ONLY WHERE ASSEMBLY IS OVER/UNDER

3. BATT INSULATION & RESILANT CHANNELS

CONDITIONED SPACES.

SEC. 718.2. (1) LAYER - 5/8" TYPE X G.B. OR 1/2" PLYWOOD TO EXTEND THRU

3. BATT INSULATION & RESILANT CHANNELS

CONDITIONED SPACES.

ONLY WHERE ASSEMBLY IS OVER/UNDER

ROOF/CEILING A

1-HOUR RATED (UL P522)


INSTALL PER ul REQUIREMENTS

UNIT NUMBERS SHOWN ARE FOR CONSTRUCTION PURPOSES ONLY & DO NOT REFLECT FINAL UNIT NUMBERING/LETTERING.

14

16

16

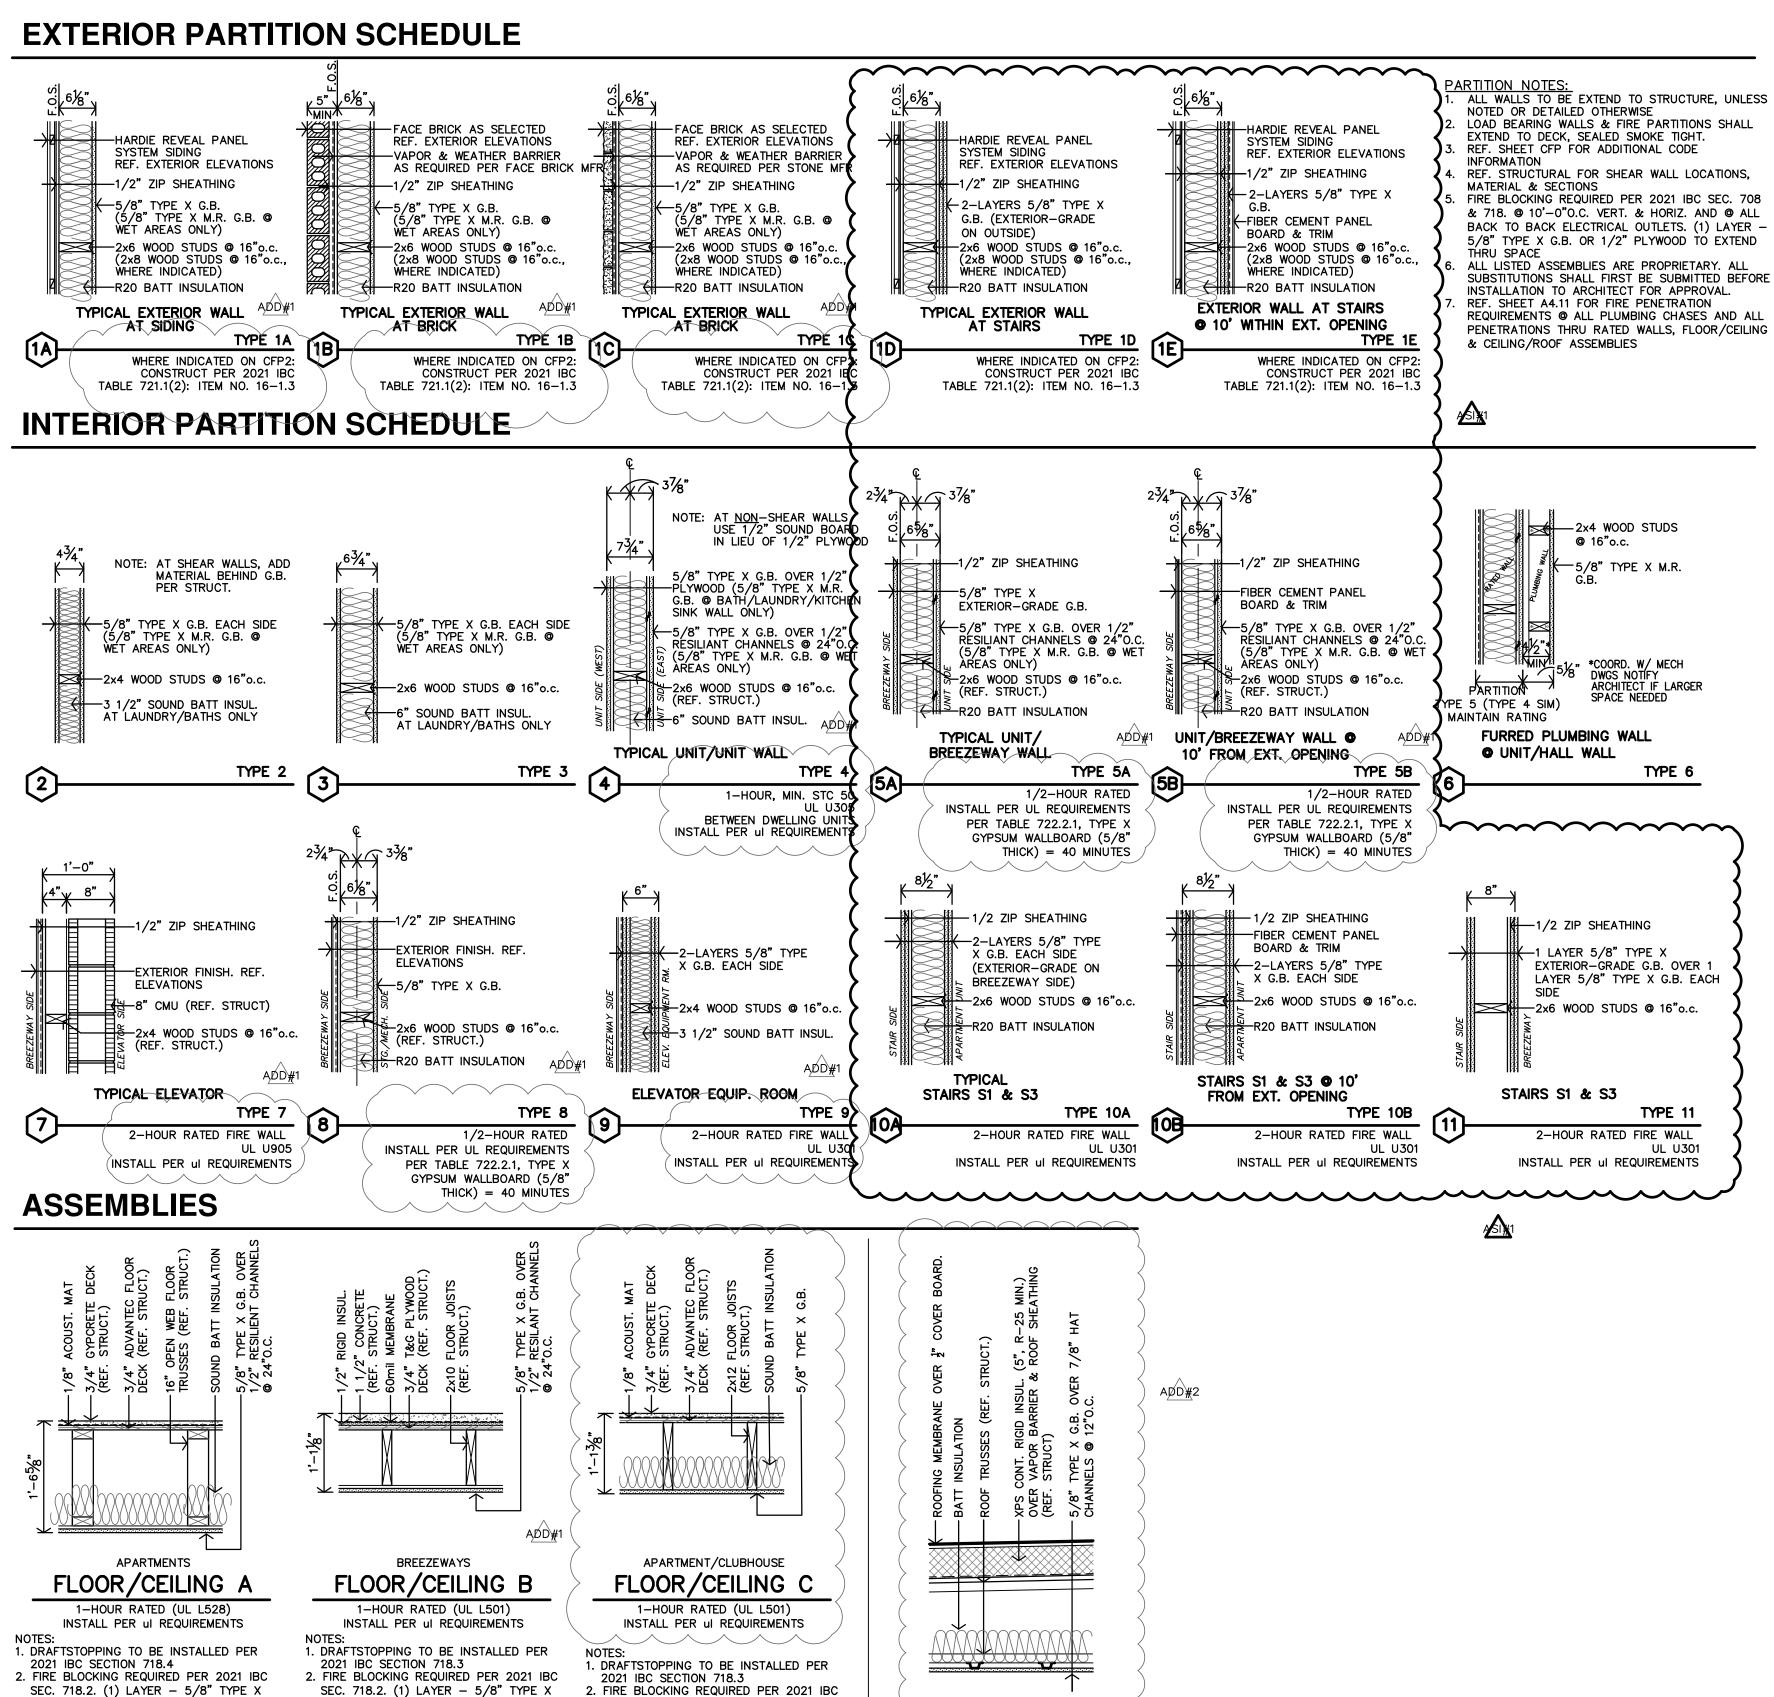

ARCHITECTURAL GENERAL NOTES

ALL WORK SHALL BE IN CONFORMANCE W/ APPLICABLE BUILDING CODES & ORDINANCES.

INSTALL MATERIALS AND/OR FINISHES AS INDICATED, IMPLIED OR AS REQUIRED FOR COMPLETE & FINISHED

ALL NEW CONSTRUCTION SHALL BE IN CONFORMANCE TO ADA REQUIREMENTS. REFERENCE ADA FOR

DOORS ARE TYPICALLY LOCATED WITH HINGE-SIDE JAMB 4" FROM ADJACENT WALL UNLESS NOTED OTHERWISE OR REQUIRED TO MEET LATCH-SIDE CLEARANCE PER ADA.

FEC - INDICATES LOCATION OF RECESSED FIRE EXTINGUISHER CABINET, REF SPECS, AND DETAILS

IF THERE IS A DISCREPANCY BETWEEN DRAWINGS AND FIELD CONDITIONS NOTIFY ARCHITECT PRIOR TO PROCEEDING WITH WORK SO THAT ANY ISSUES MAY BE CLARIFIED.

A/B-A2.0 FIRE EXTINGUISHERS SHALL BE INSTALLED & PROVIDED IN ACCORDANCE W/ NFPA 10 & 2021

F.O.S. - INDICATES DIMENSIONS ARE TO THE FACE OF STUD AT THE EXTERIOR/BREEZEWAY WALLS U.N.O.


CONTRACTOR SHALL FIELD VERIFY ALL DIMENSIONS & CONDITIONS.

TYPICAL MINIMUM CLEARANCE REQUIRED.

MHO - INDICATES DOOR WITH MAGNETIC HOLD OPEN.

O. FURNITURE SHOWN IS BY OWNER.

1. ROICATES RADON PIPE LOCATION. REF. MEP DRAWINGS.

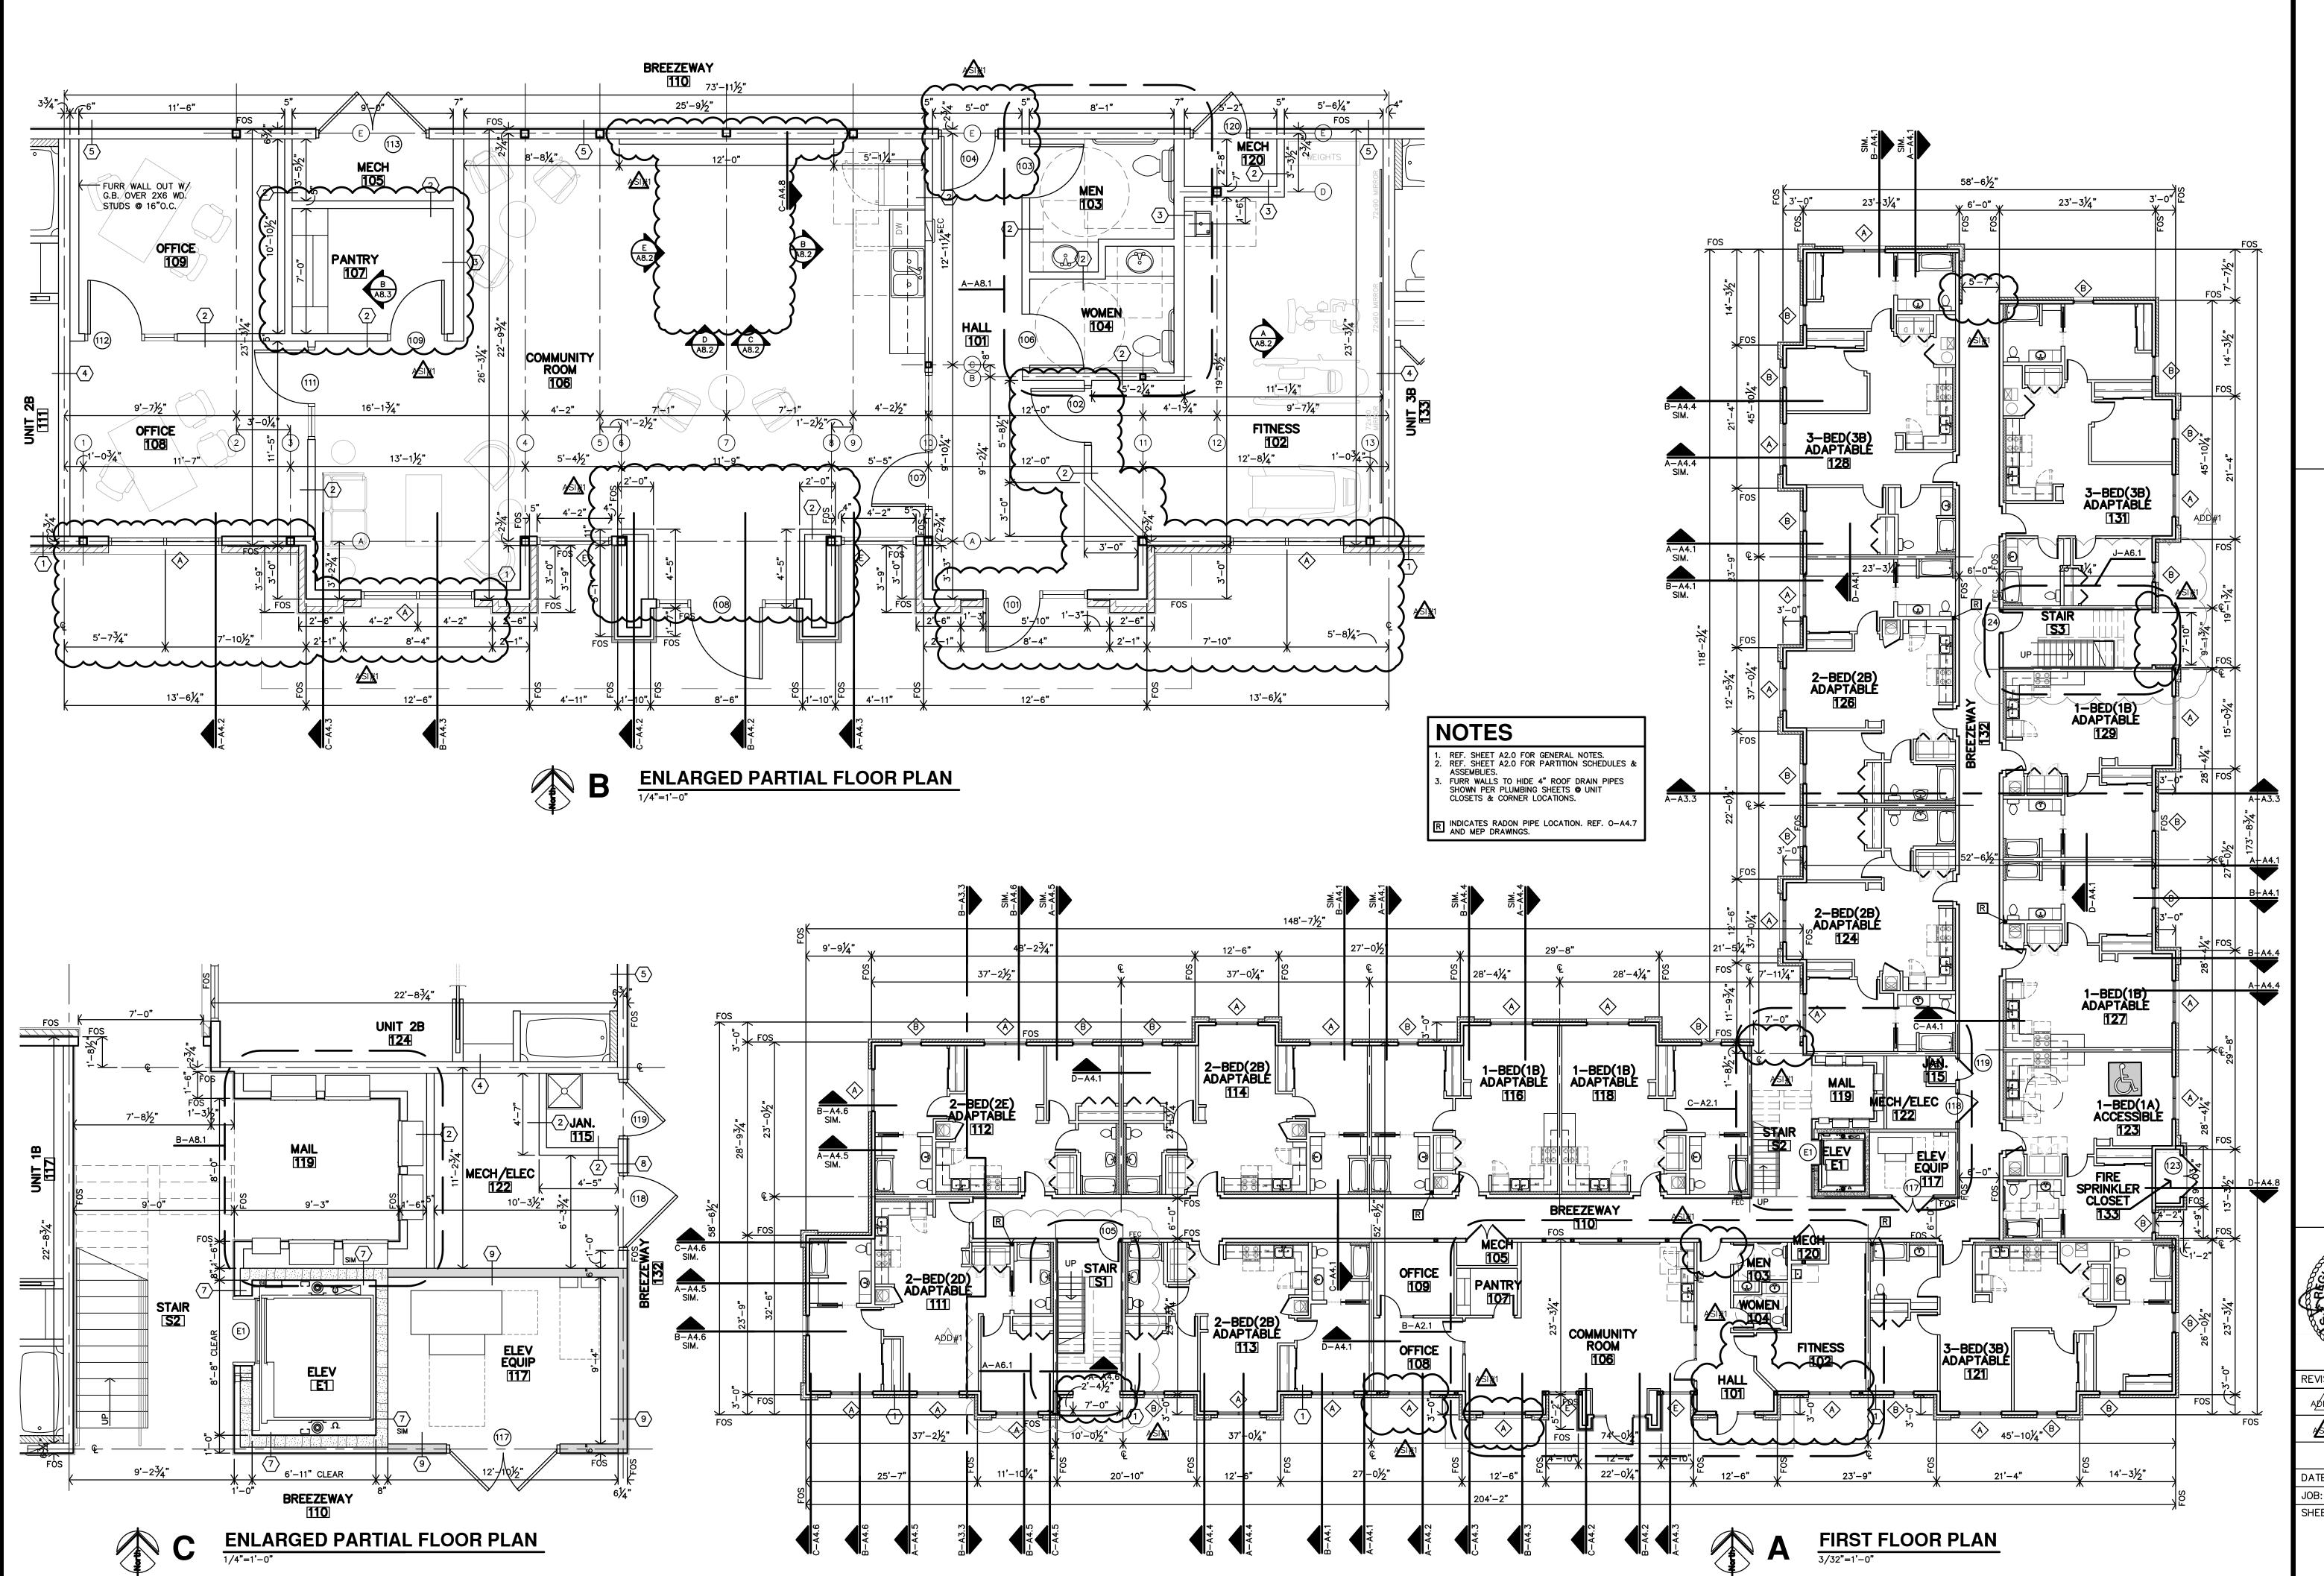

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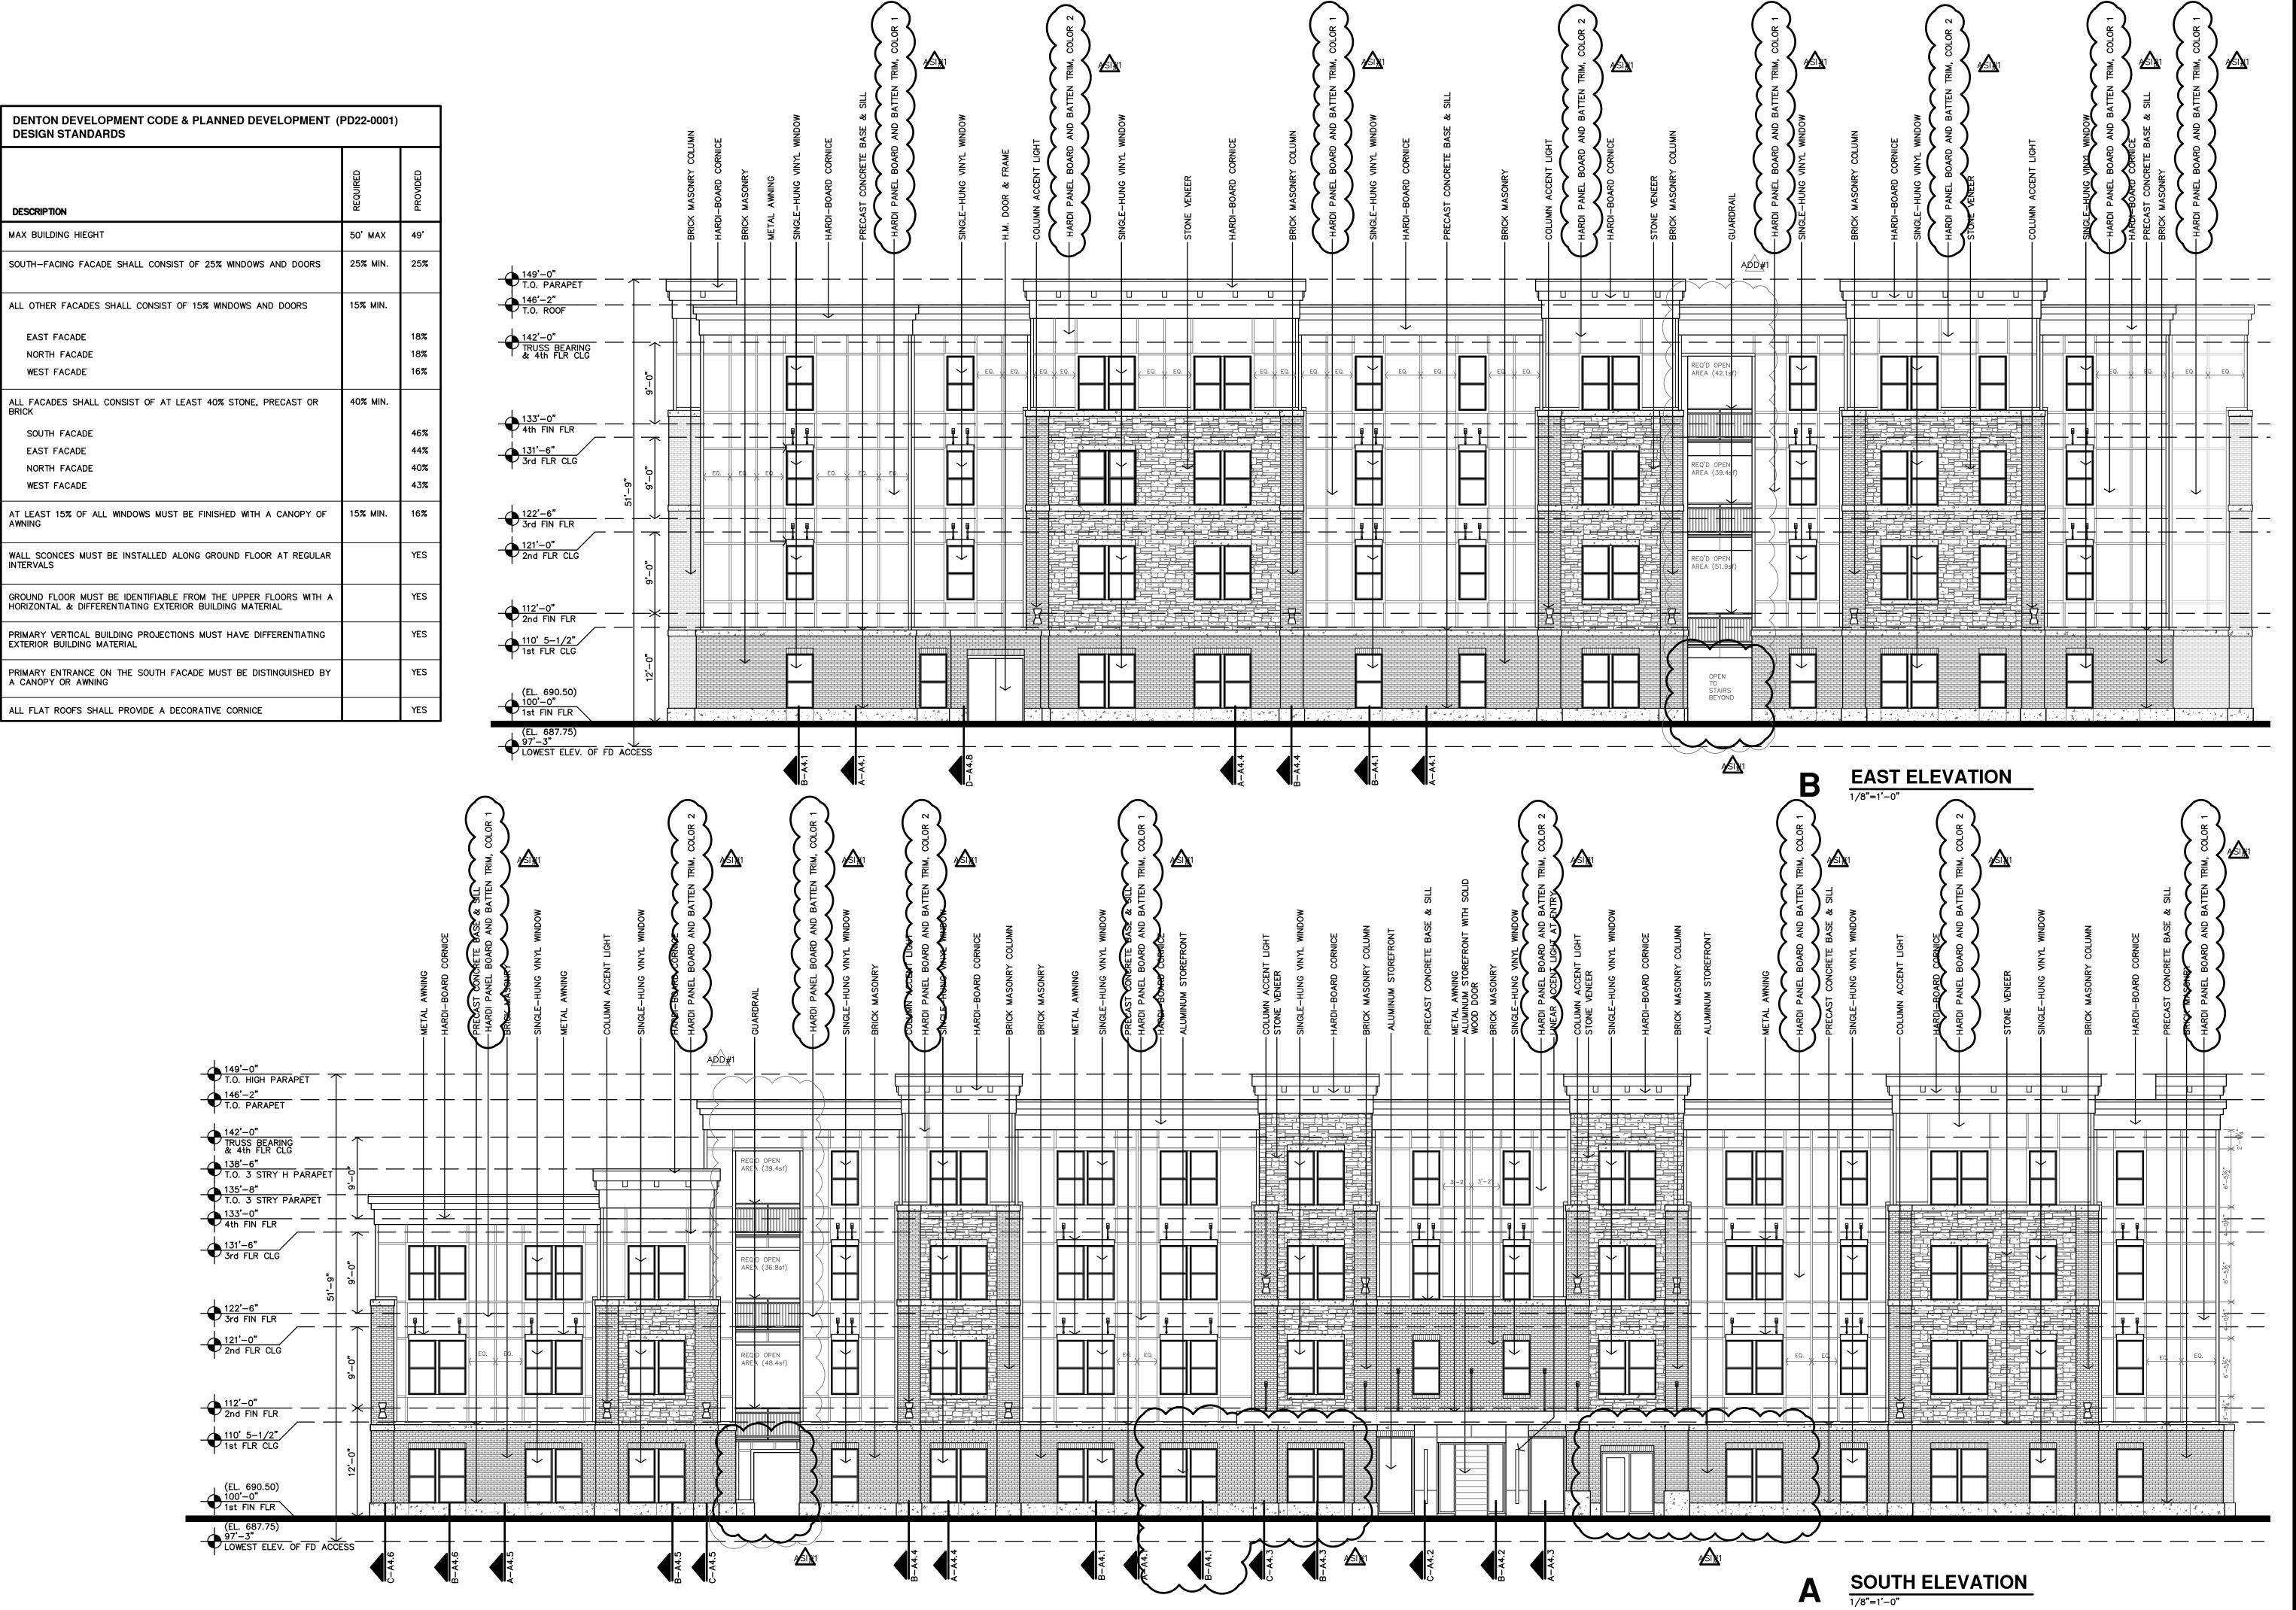
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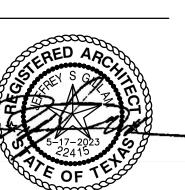
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A2.1




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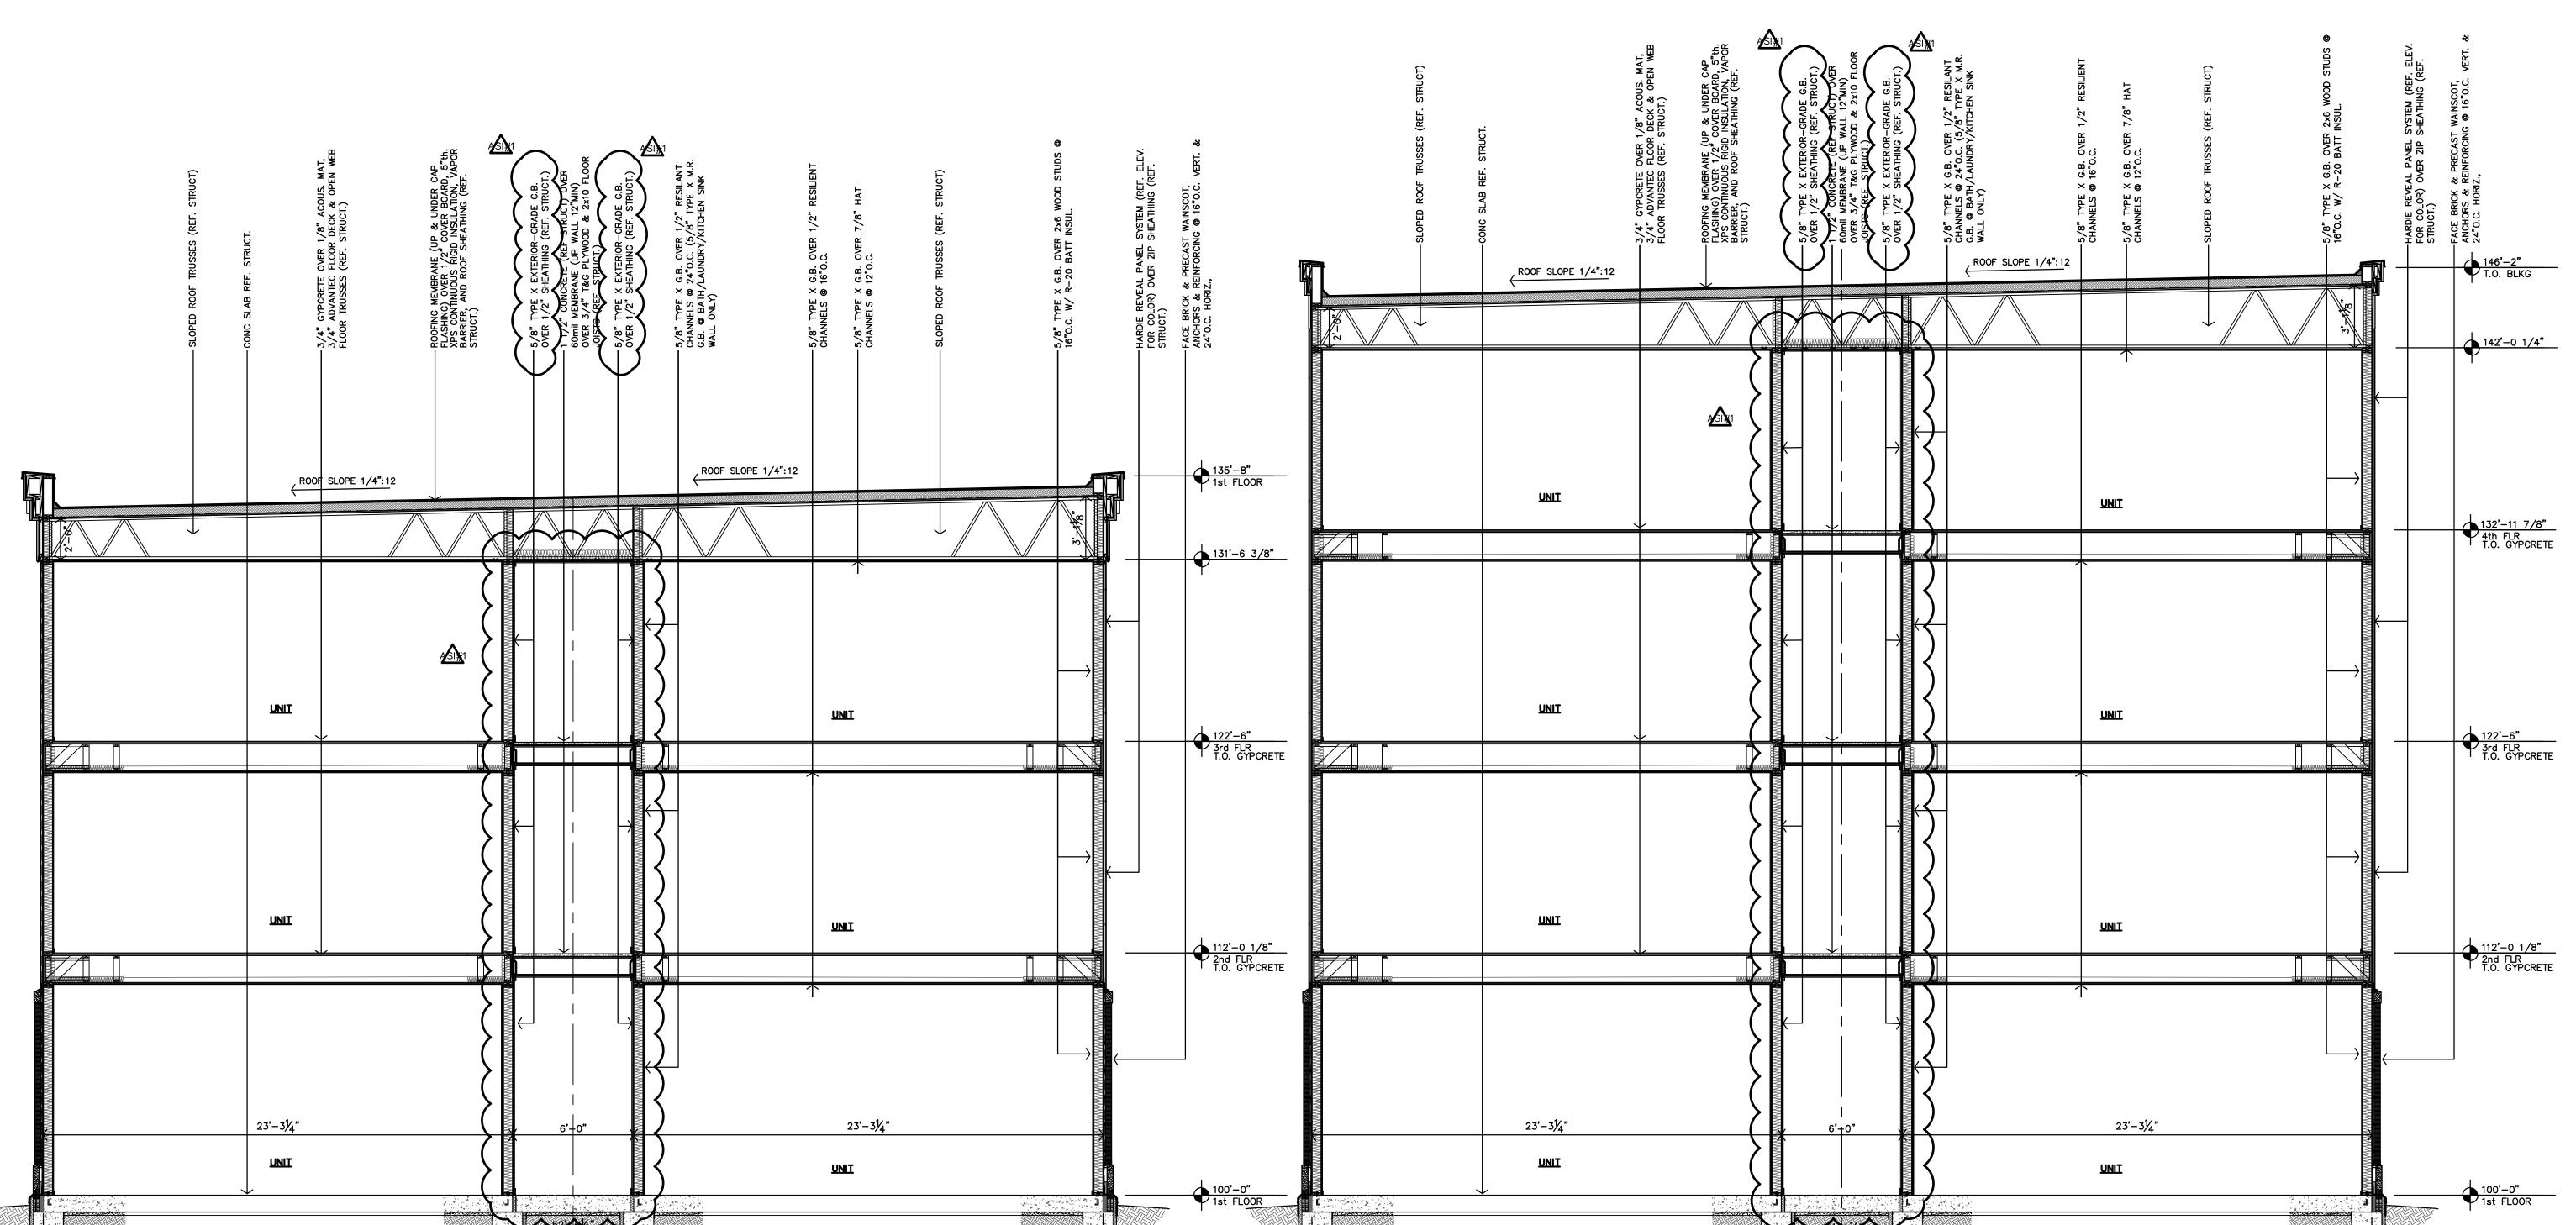
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TYPICAL 3-STORY BUILDING SECTION

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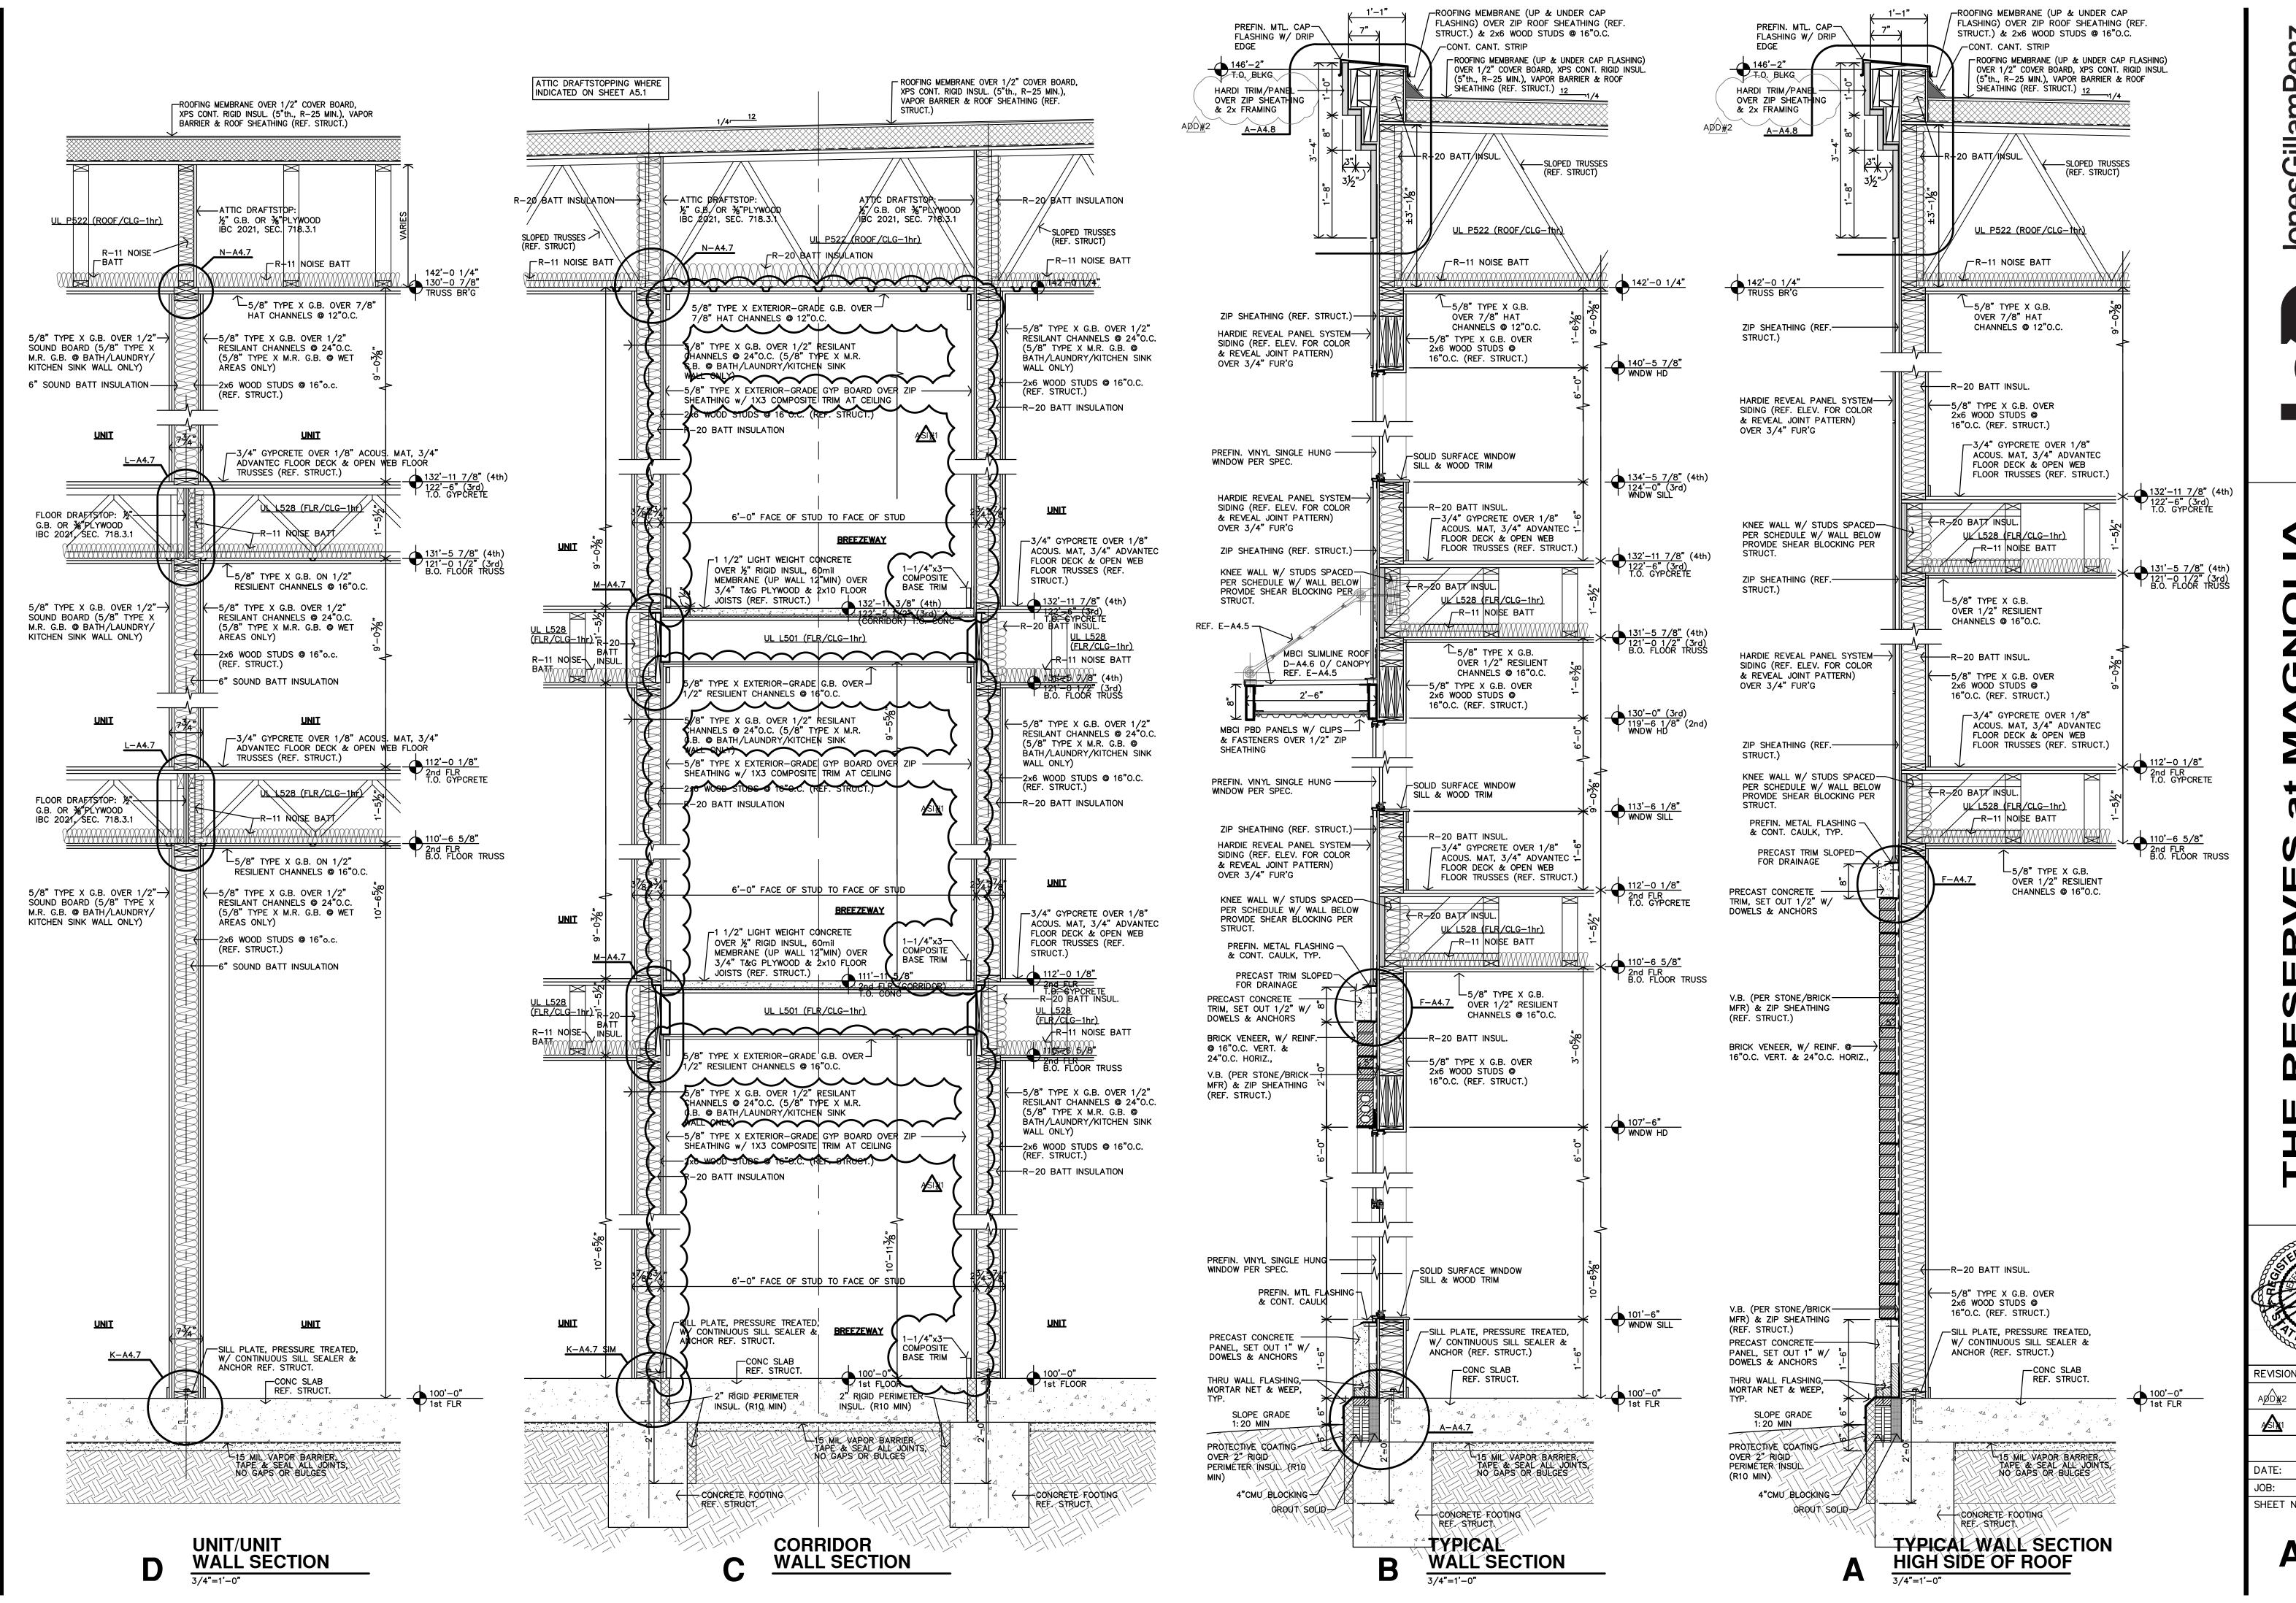
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TYPICAL 4-STORY BUILDING SECTION




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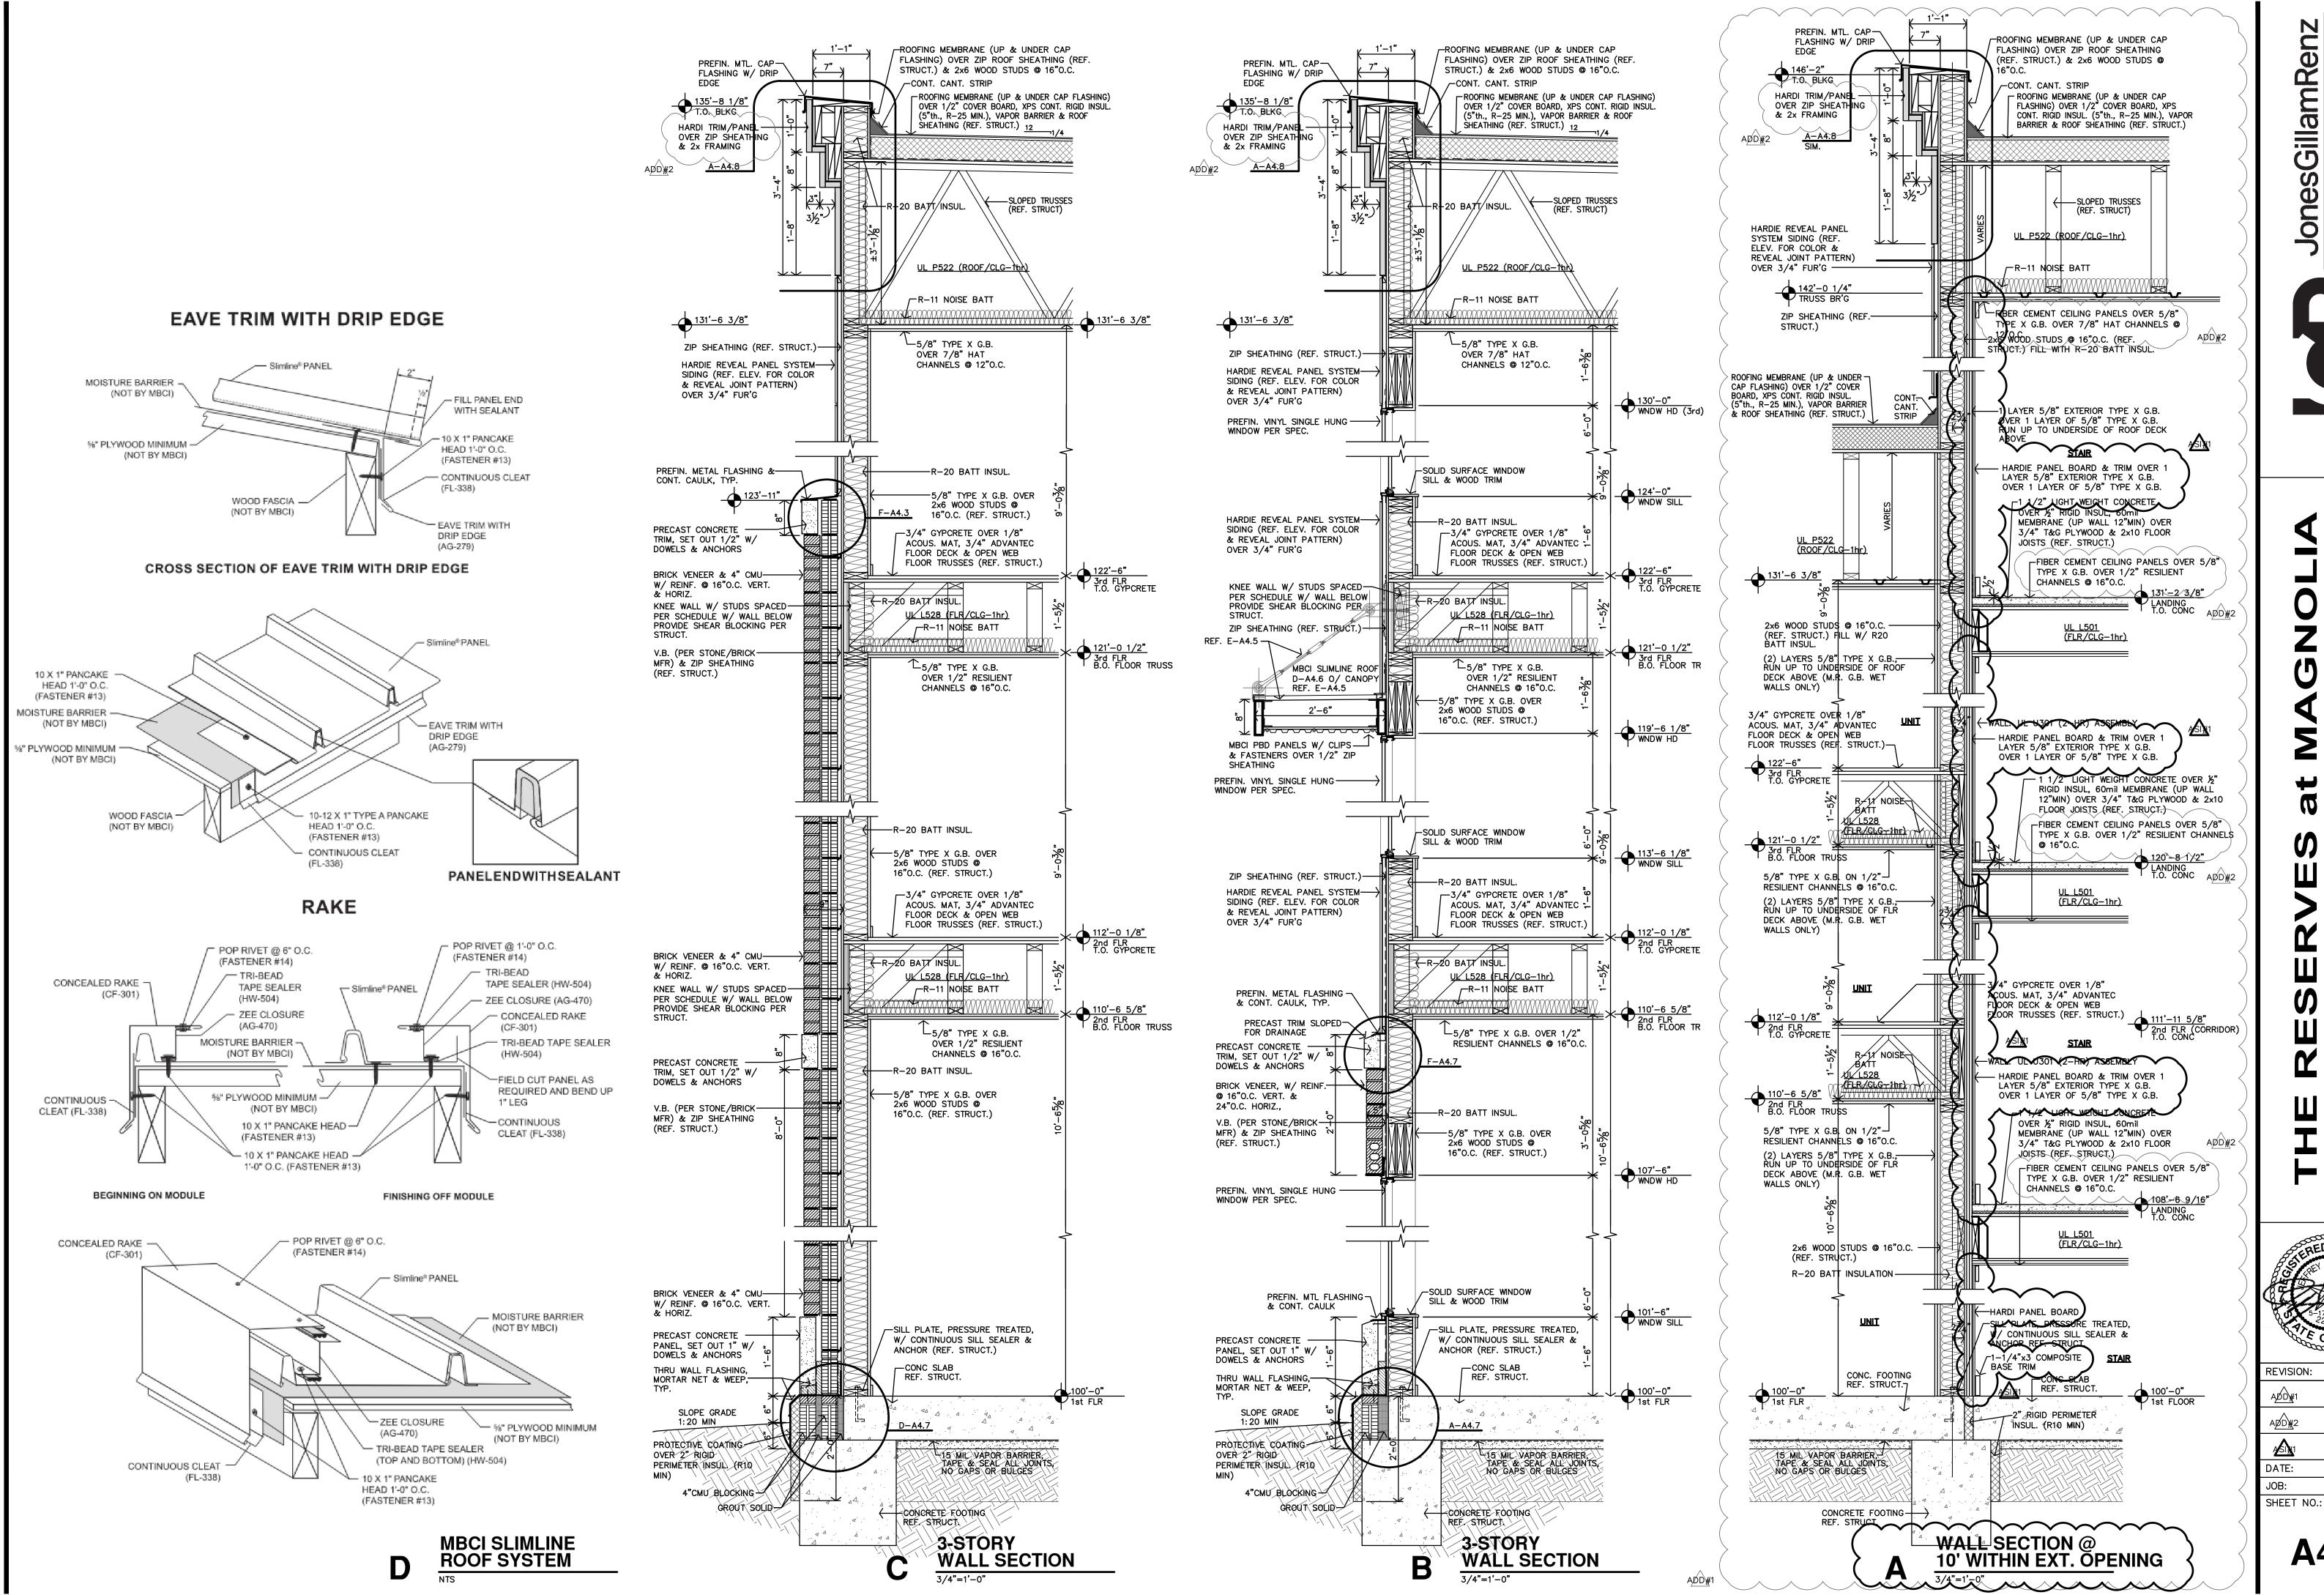
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Kansas City, MO 64108

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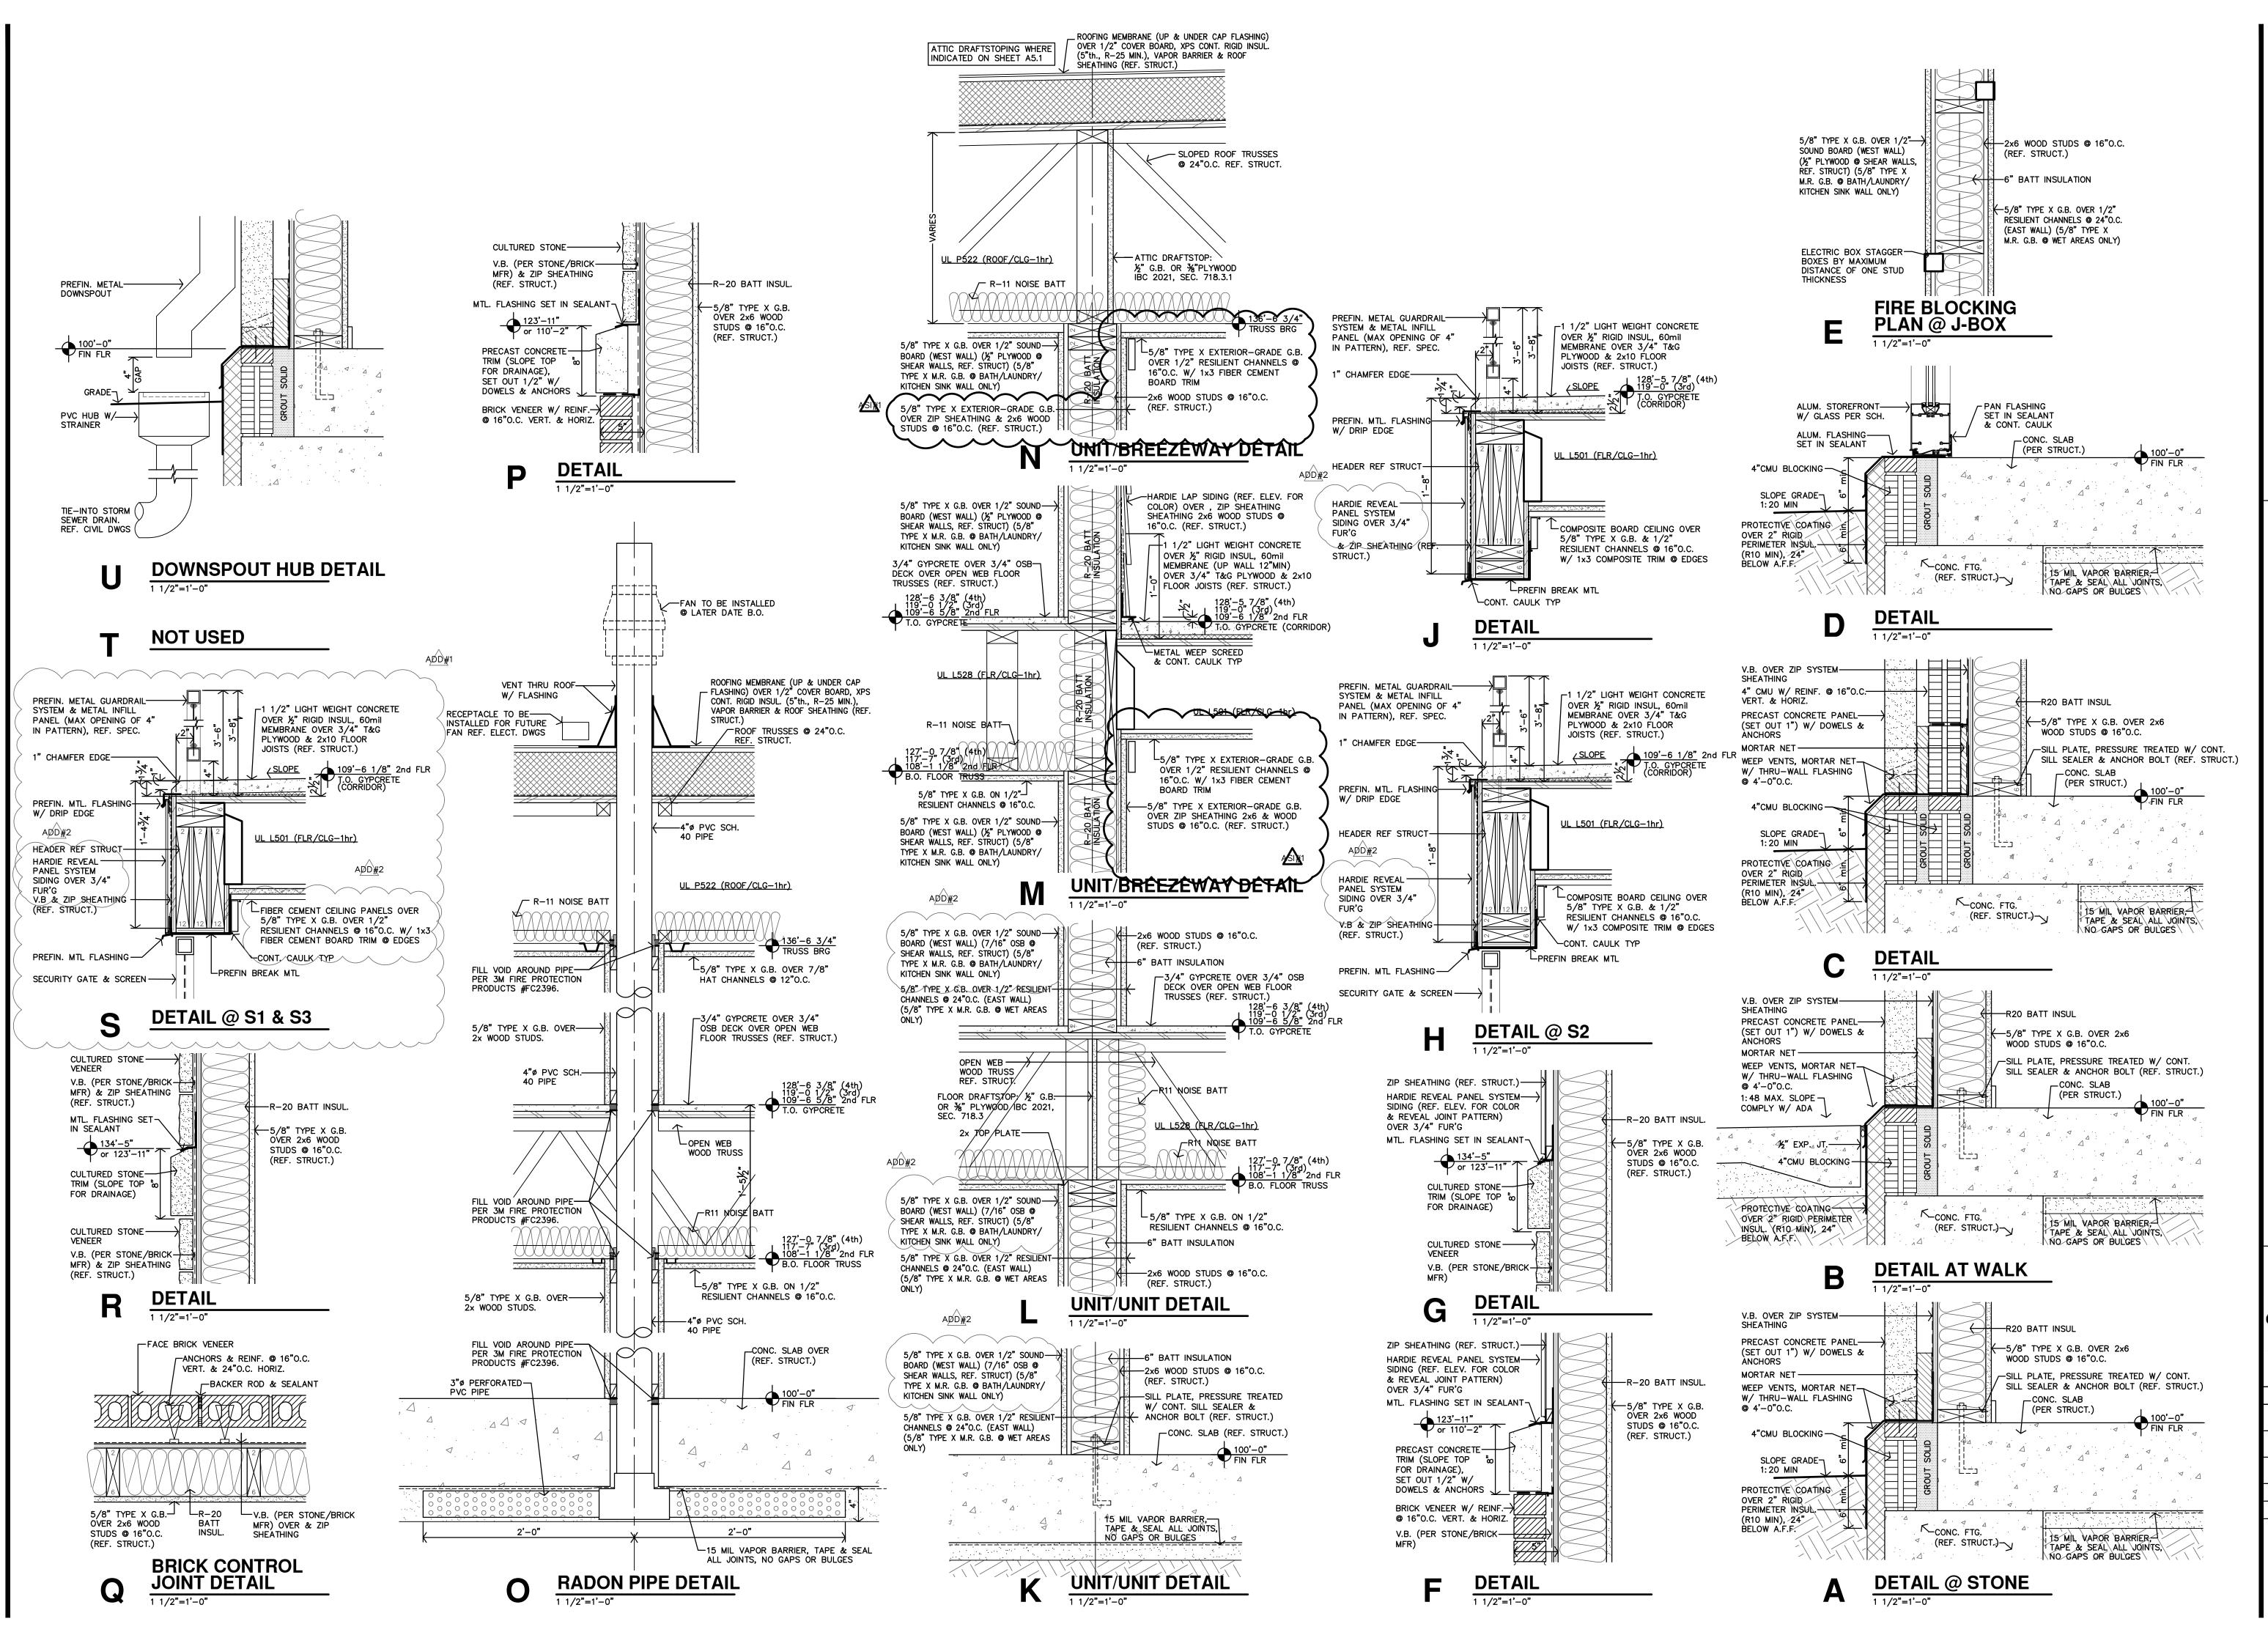
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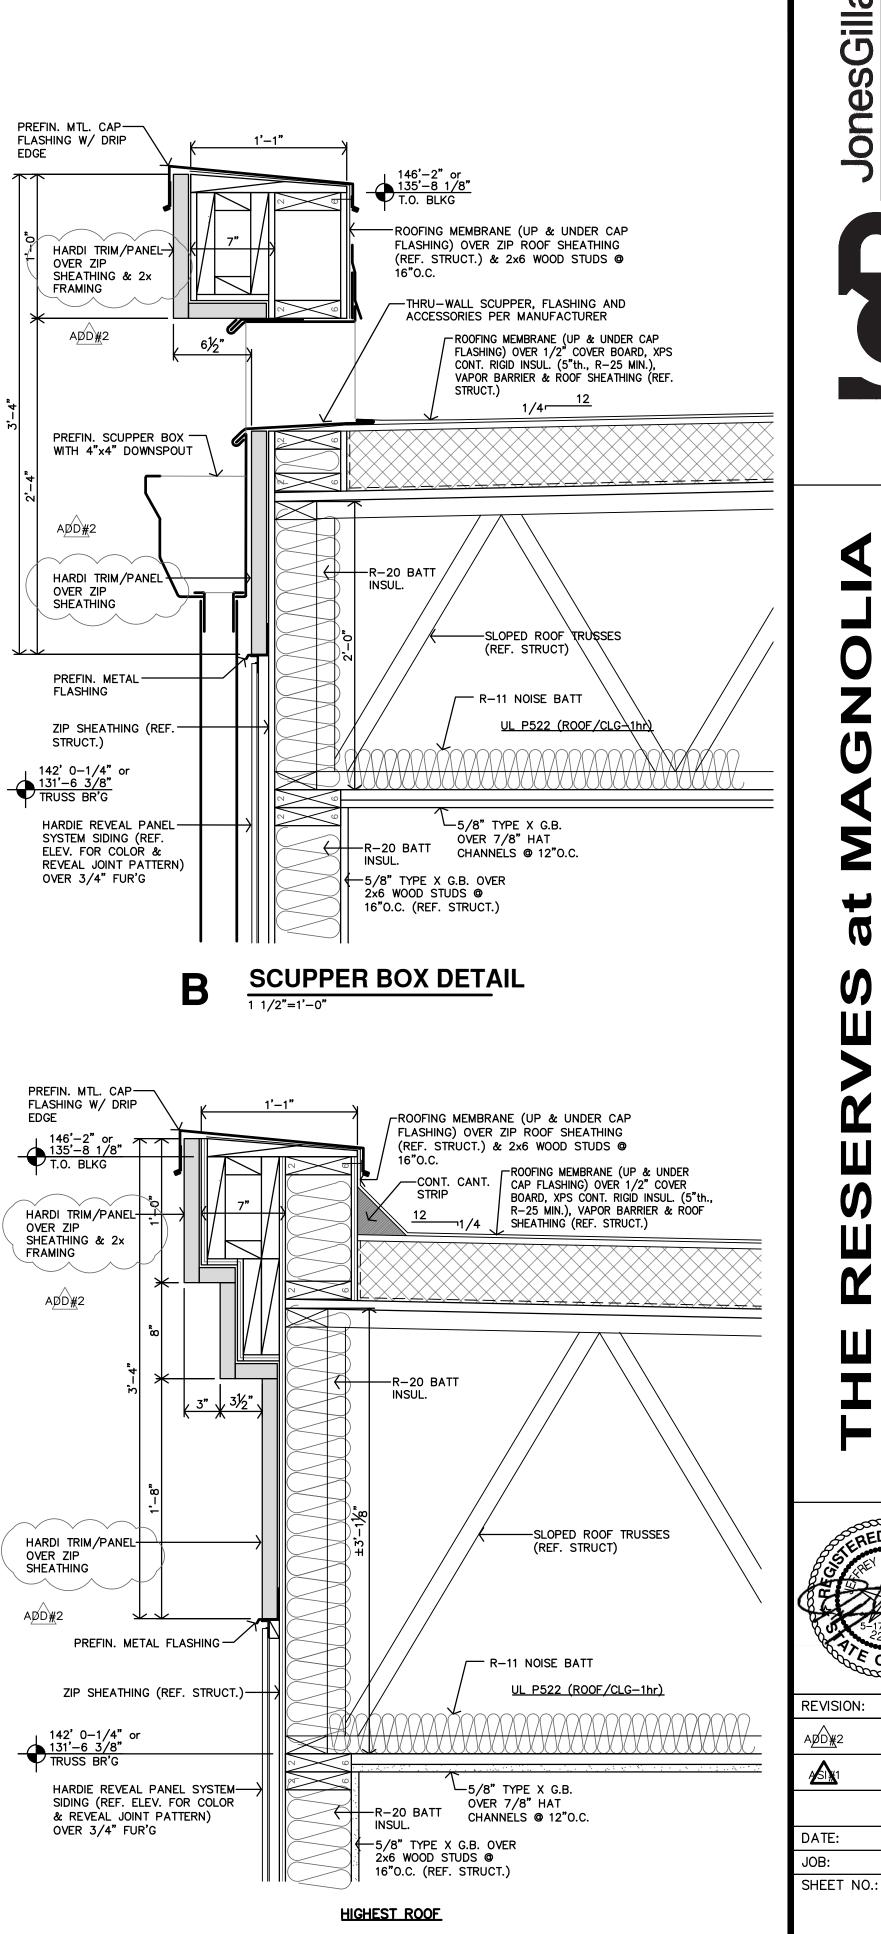
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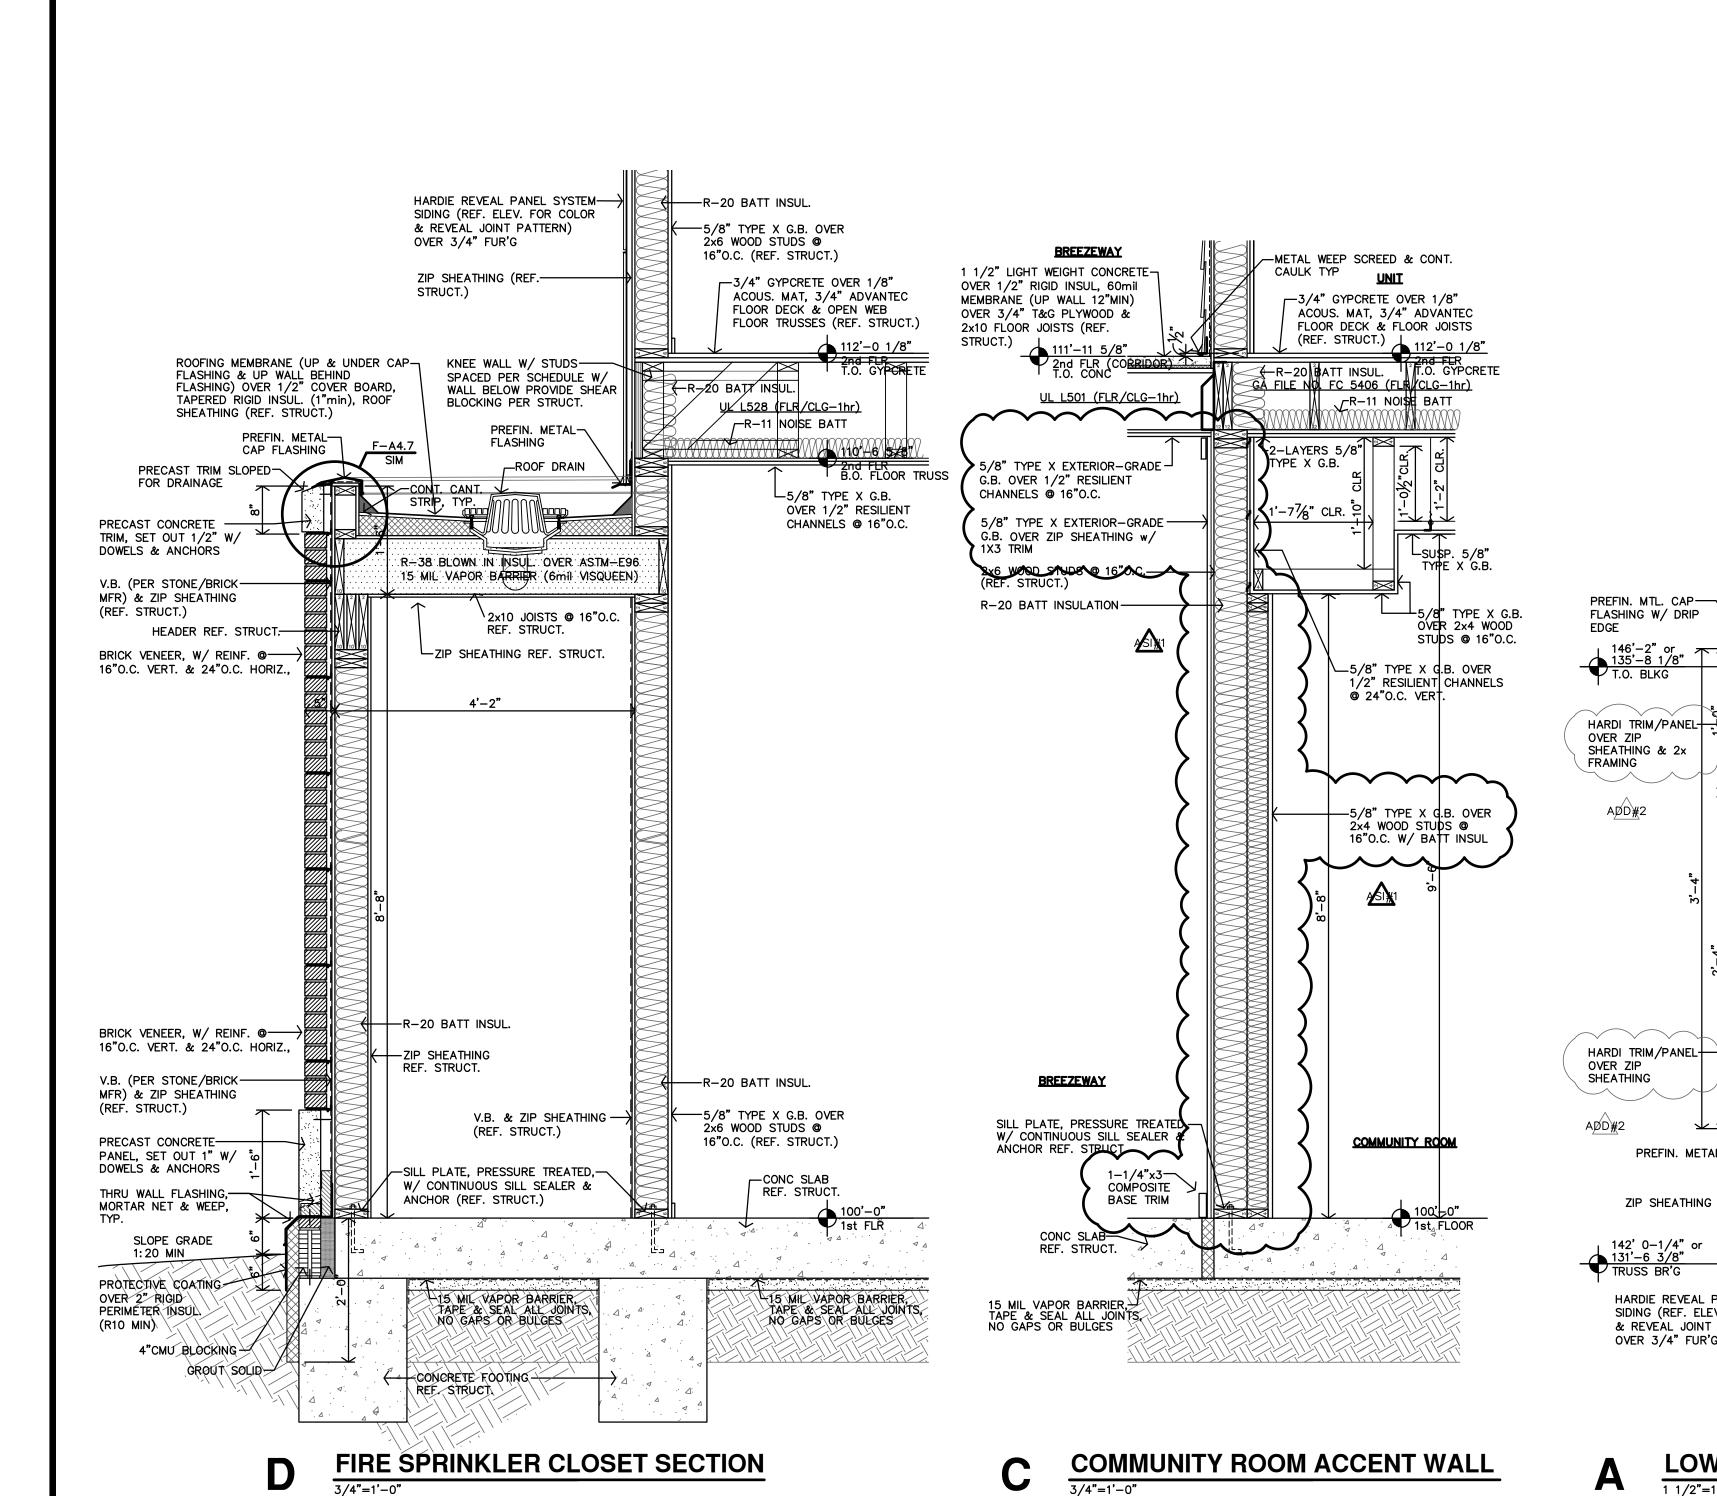
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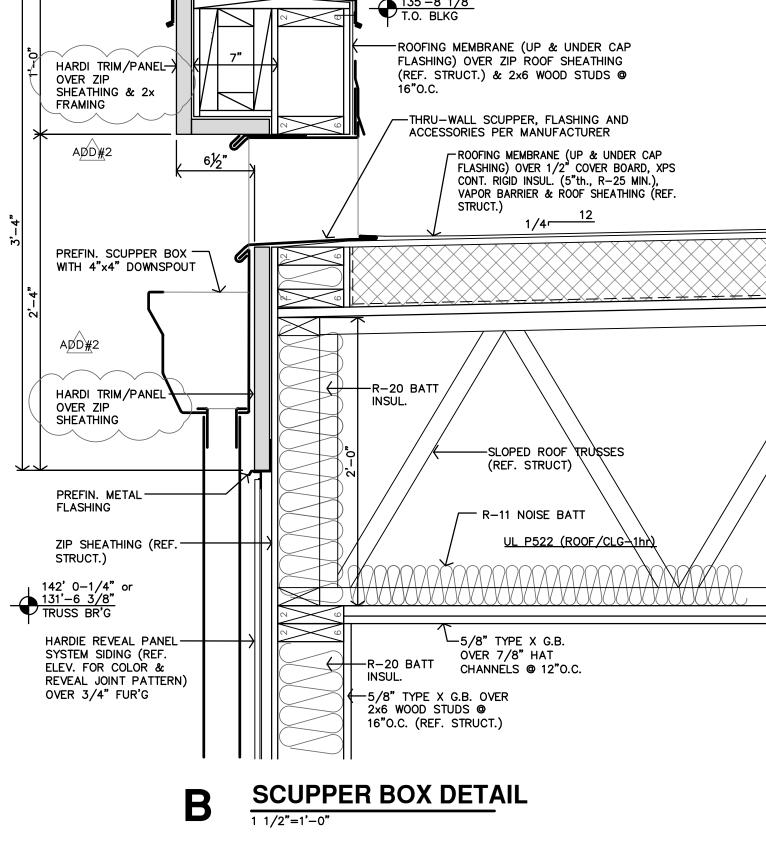
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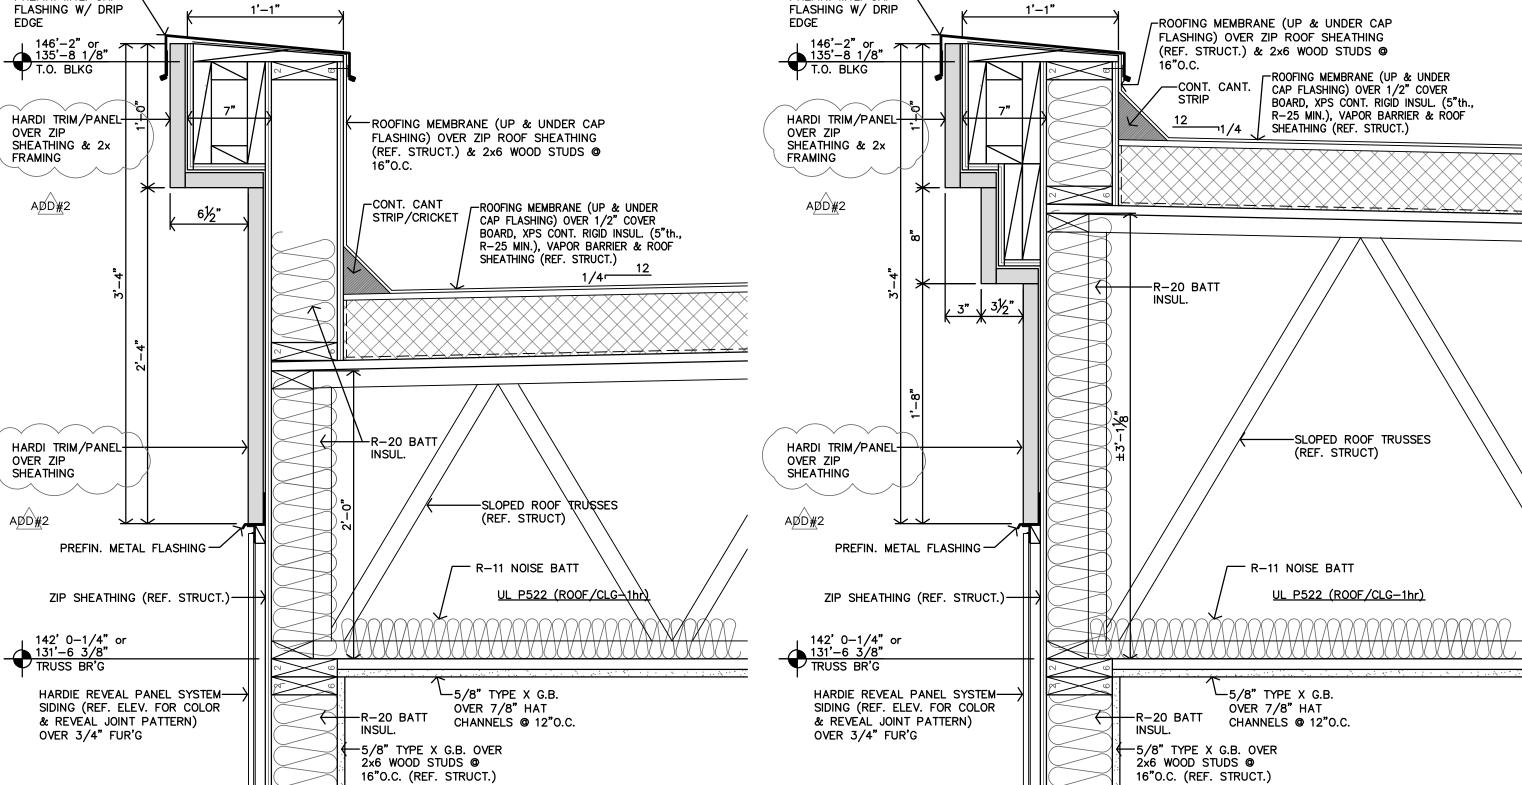
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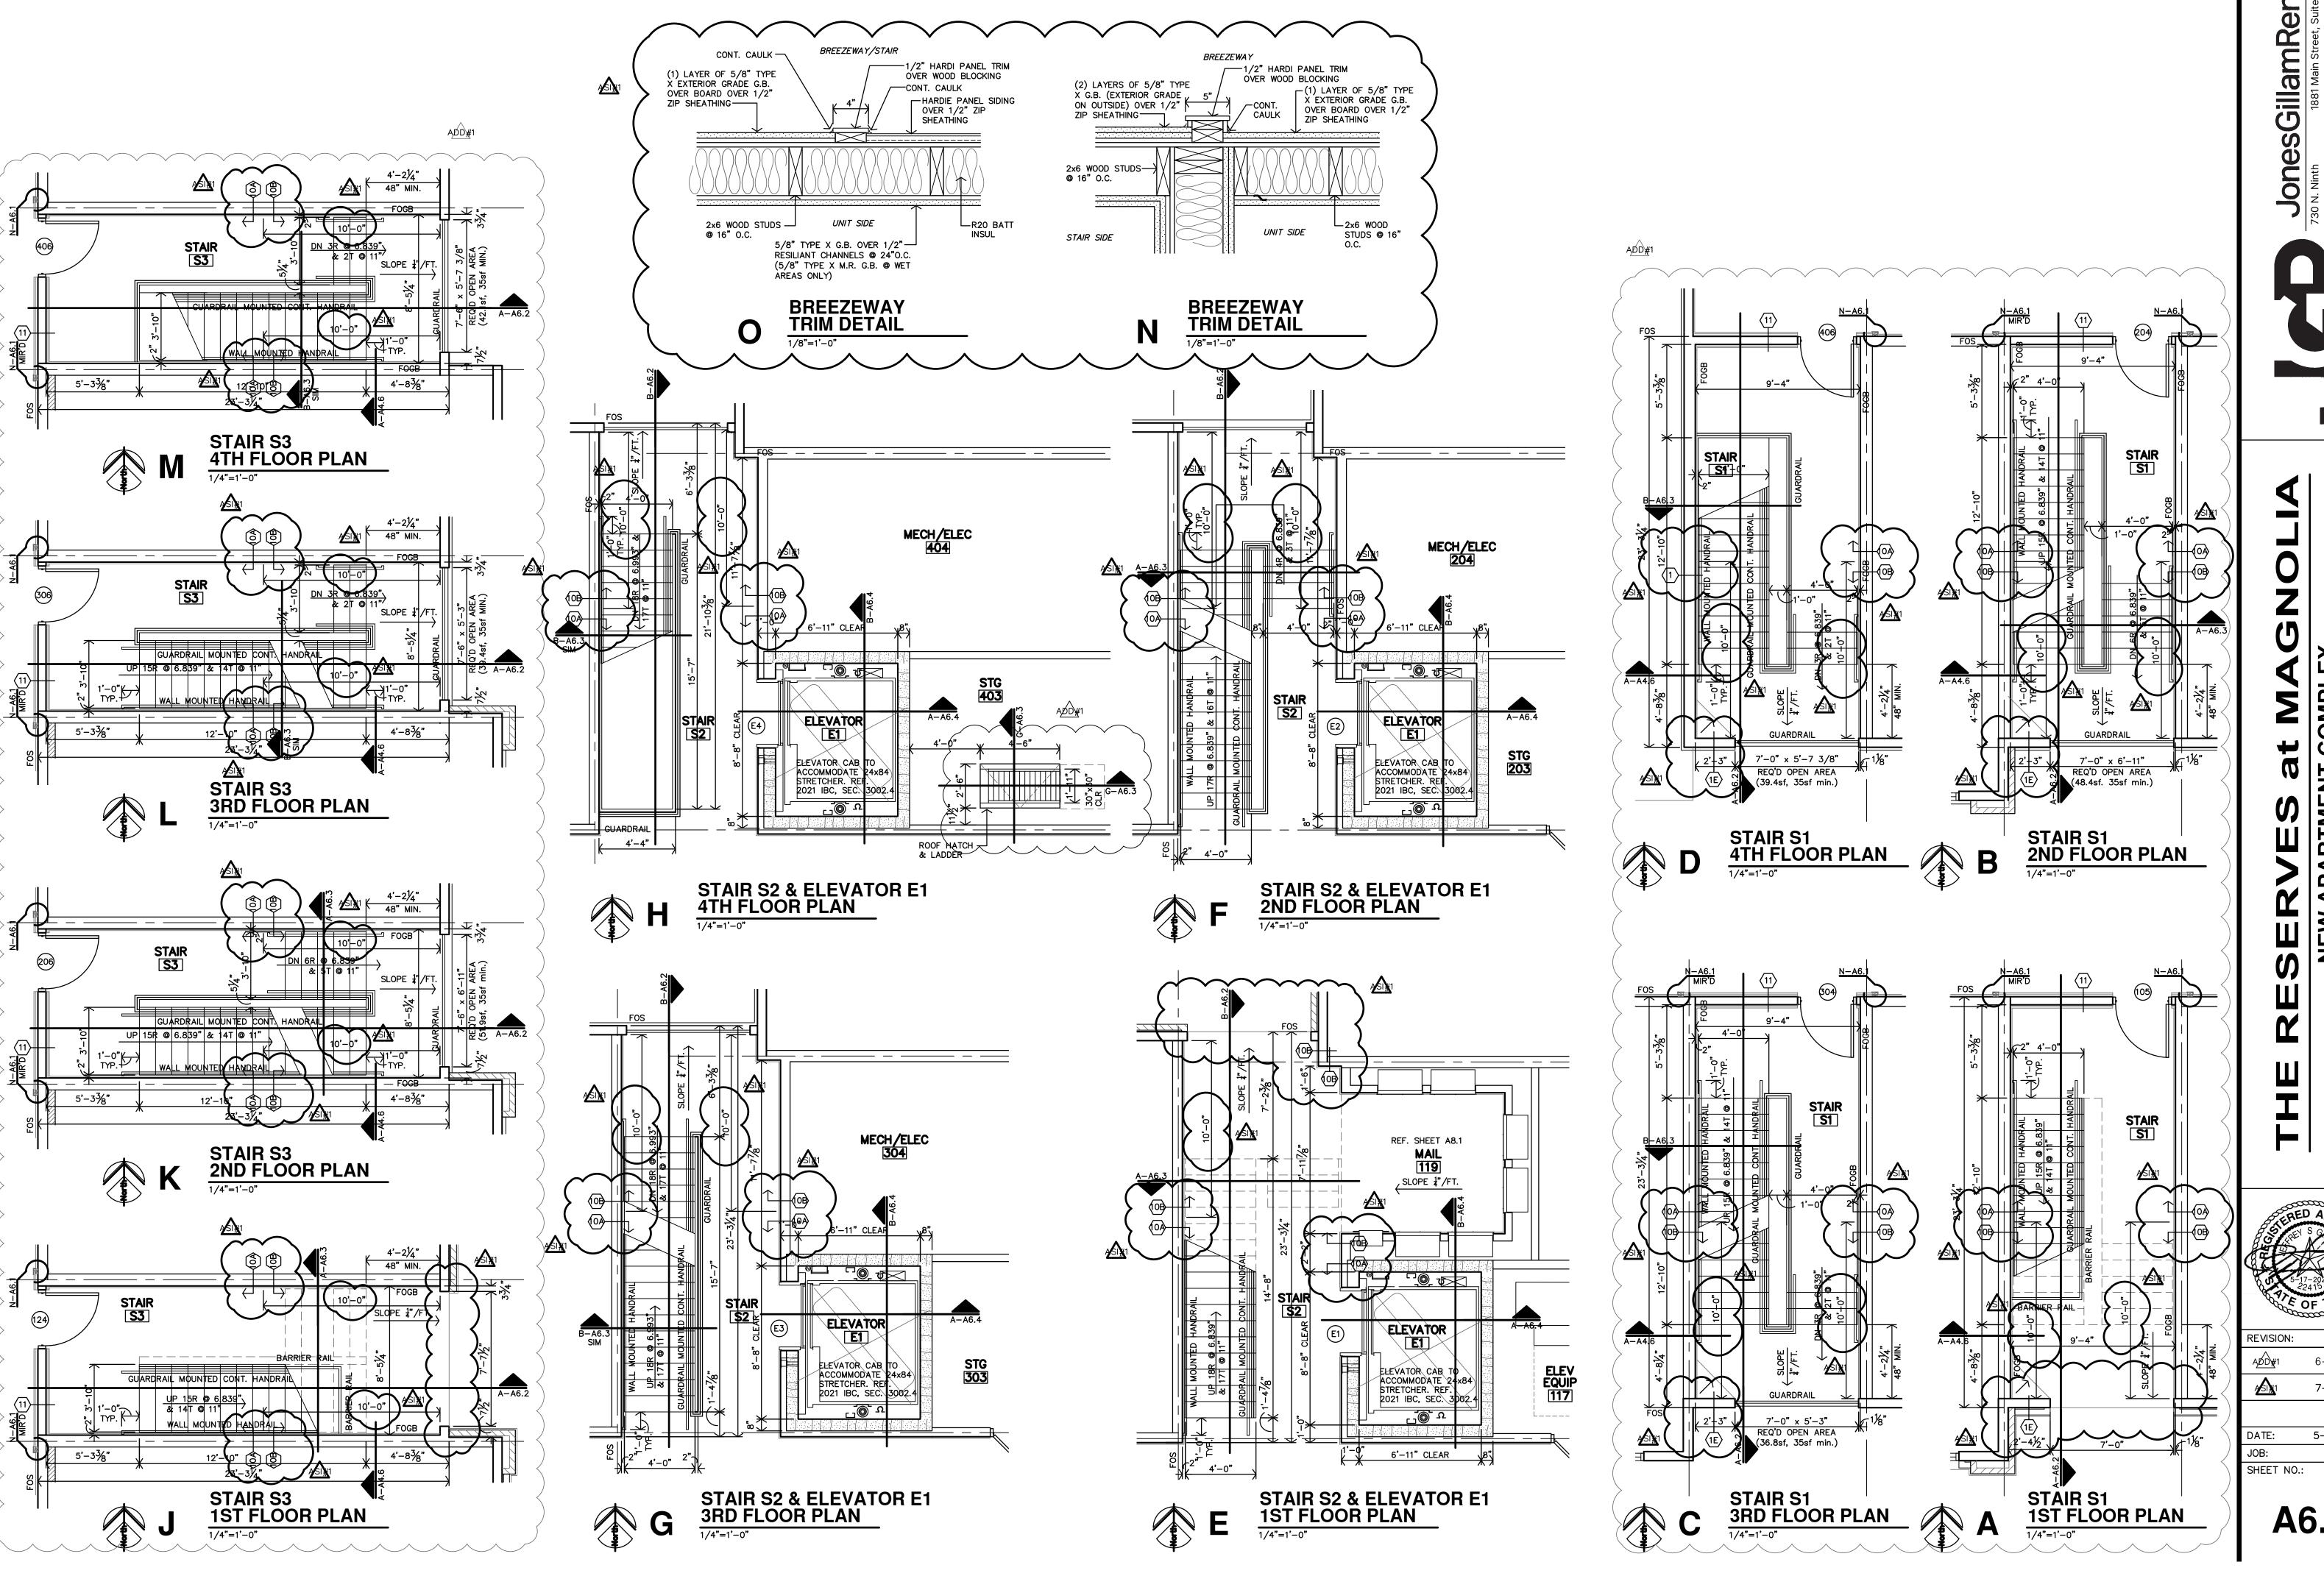
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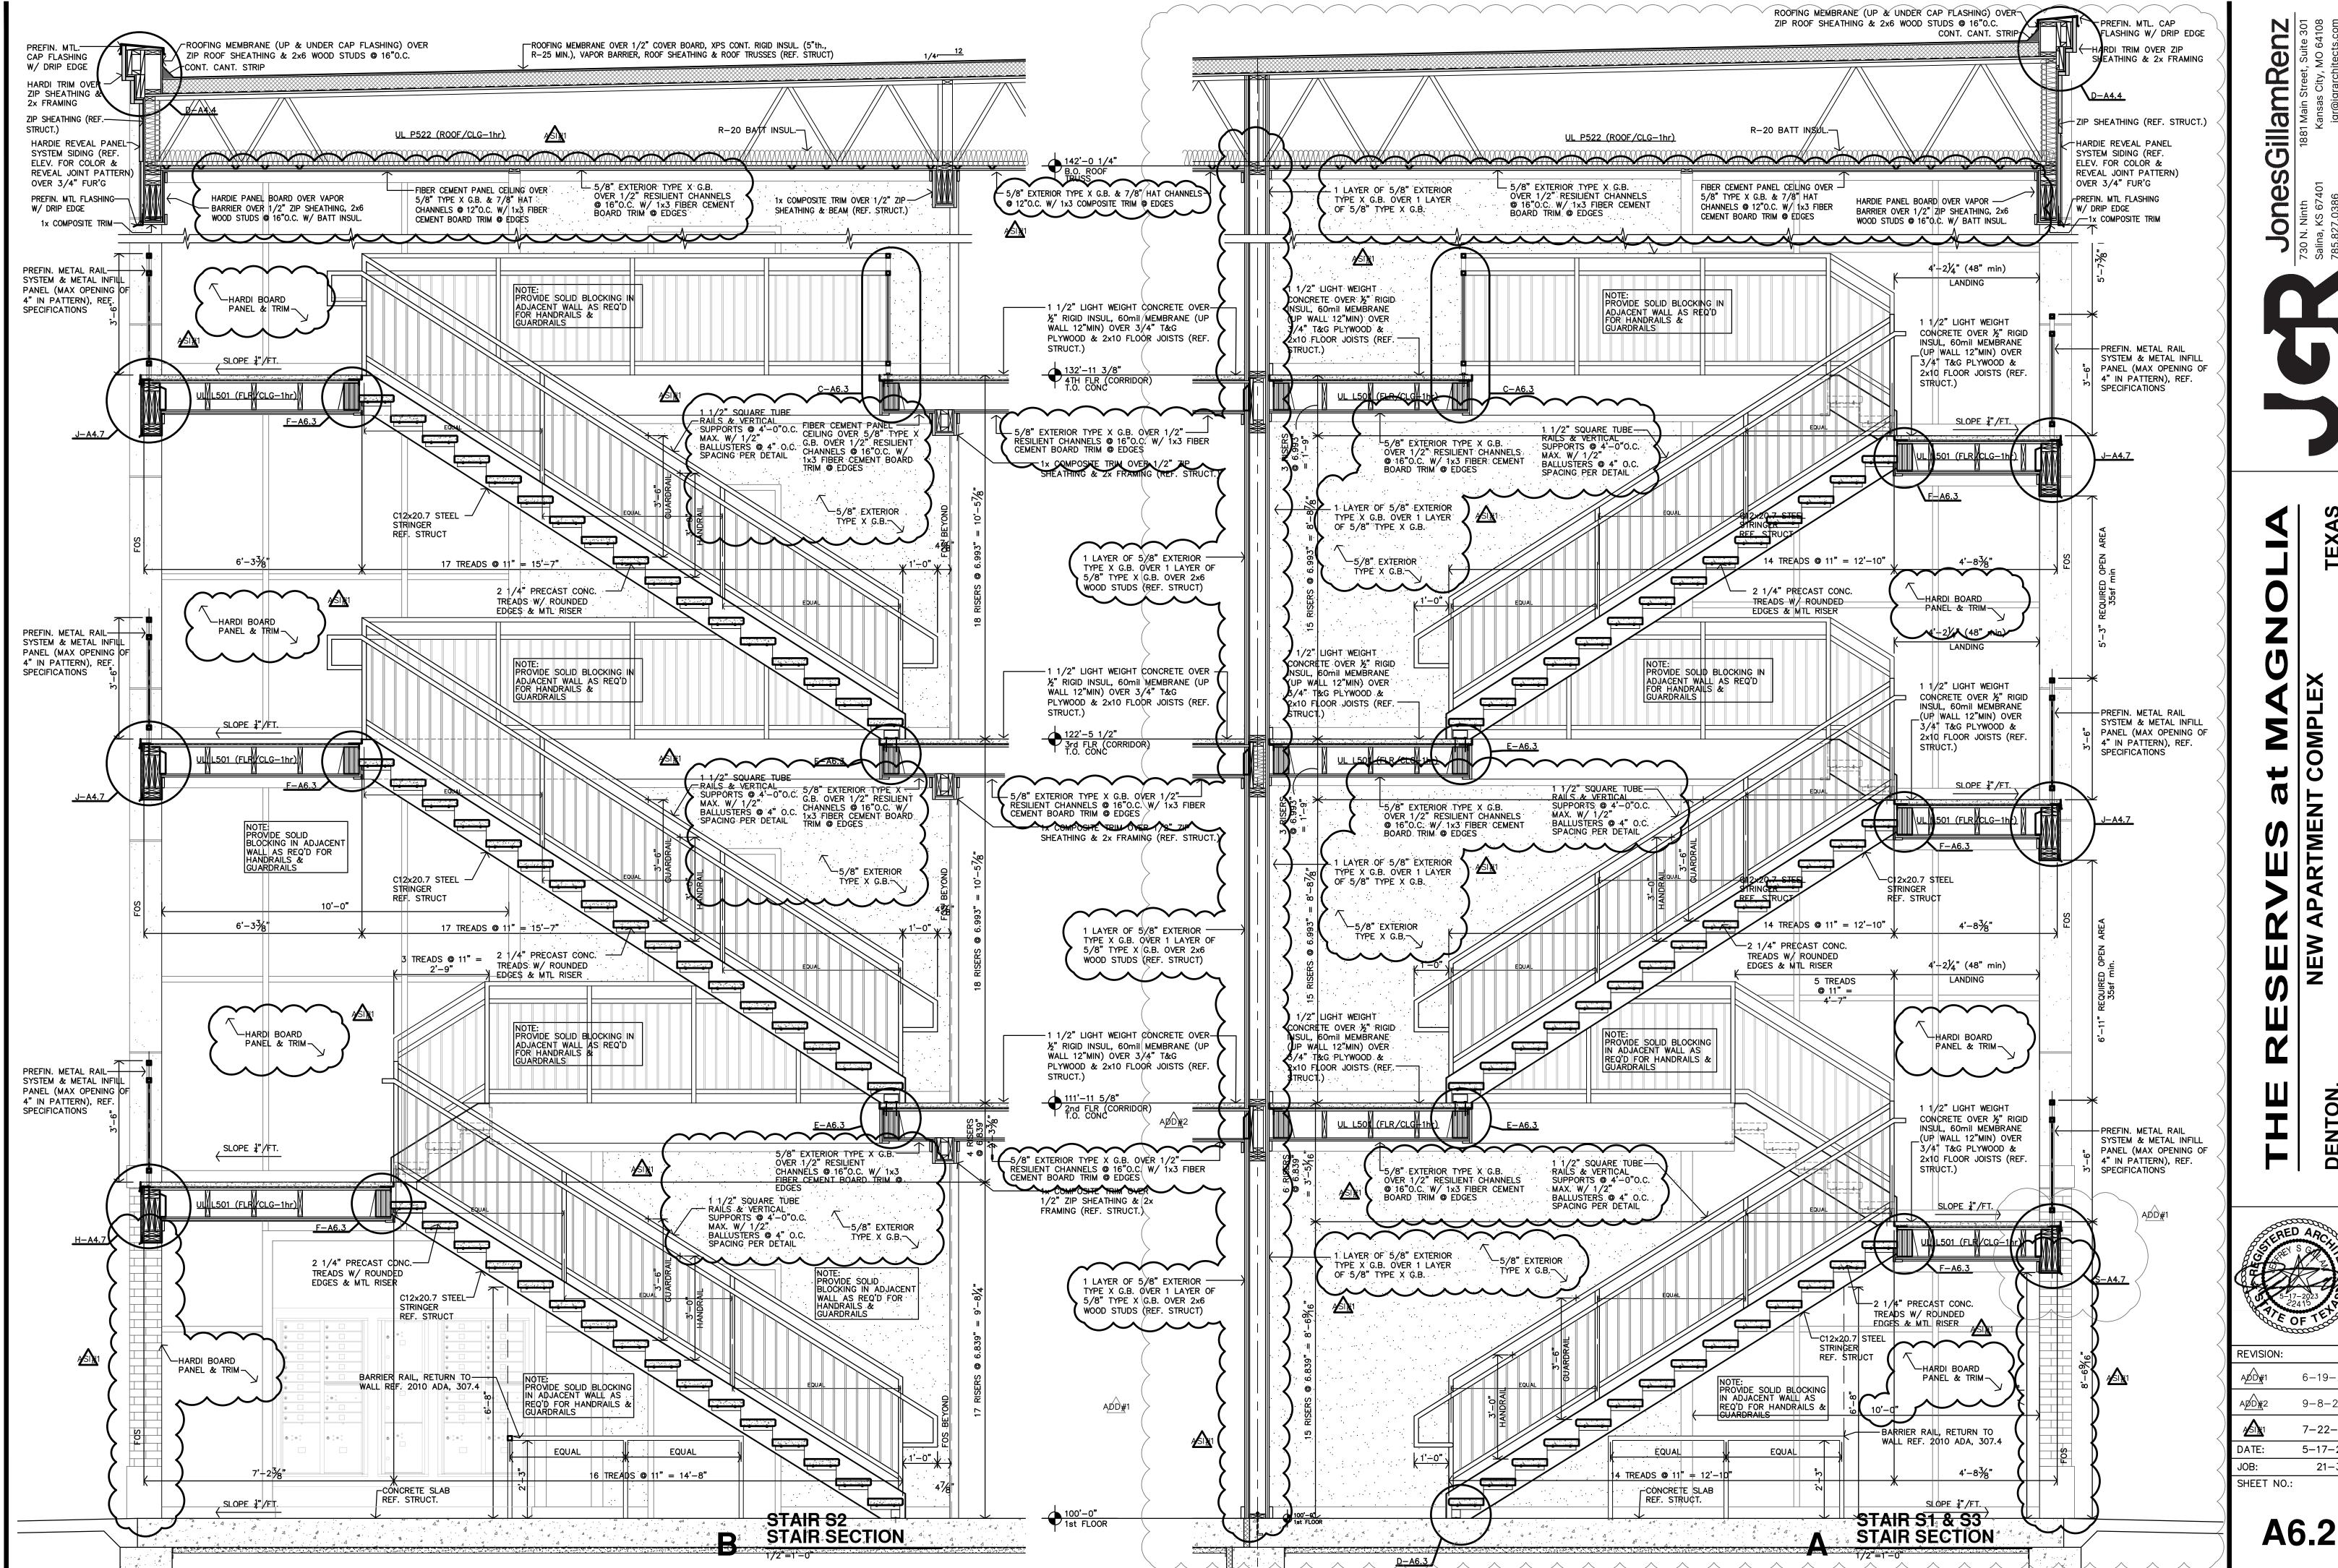
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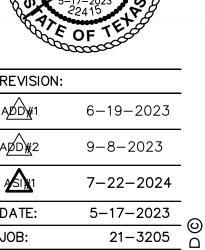
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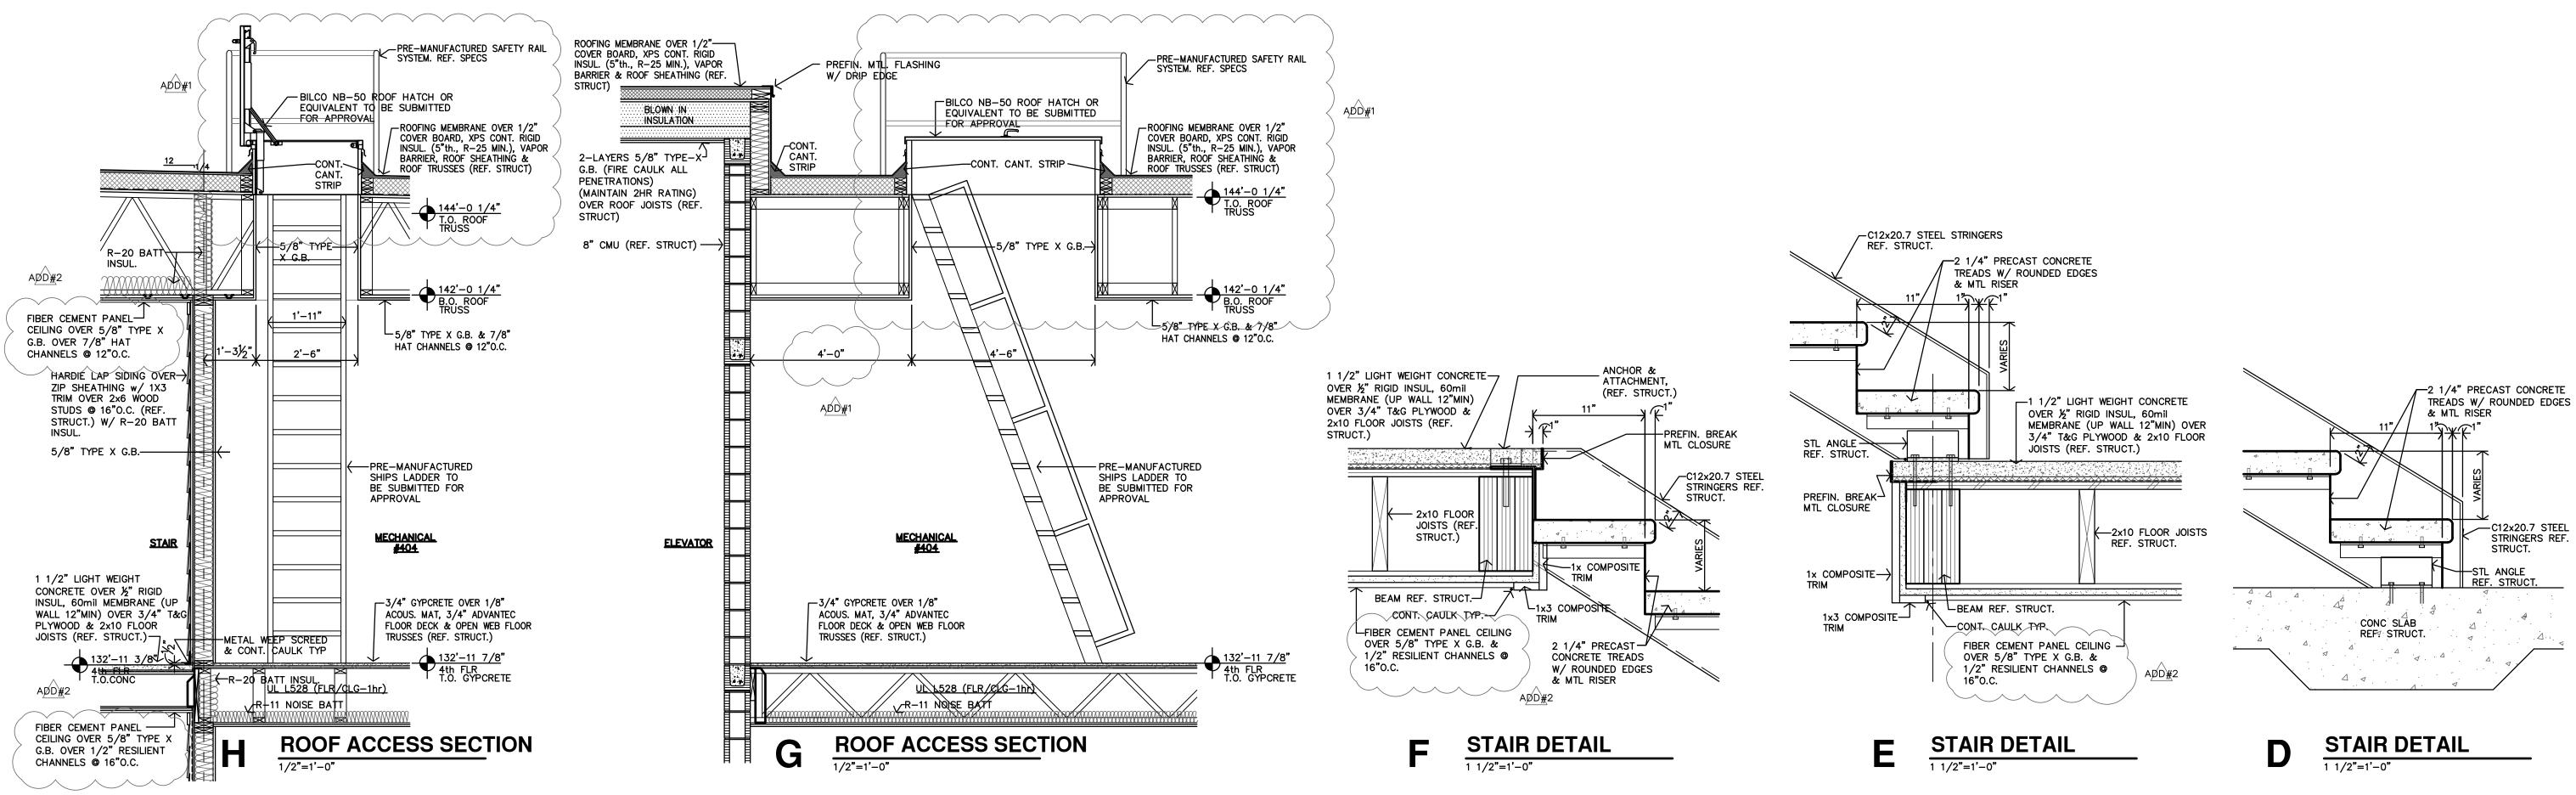
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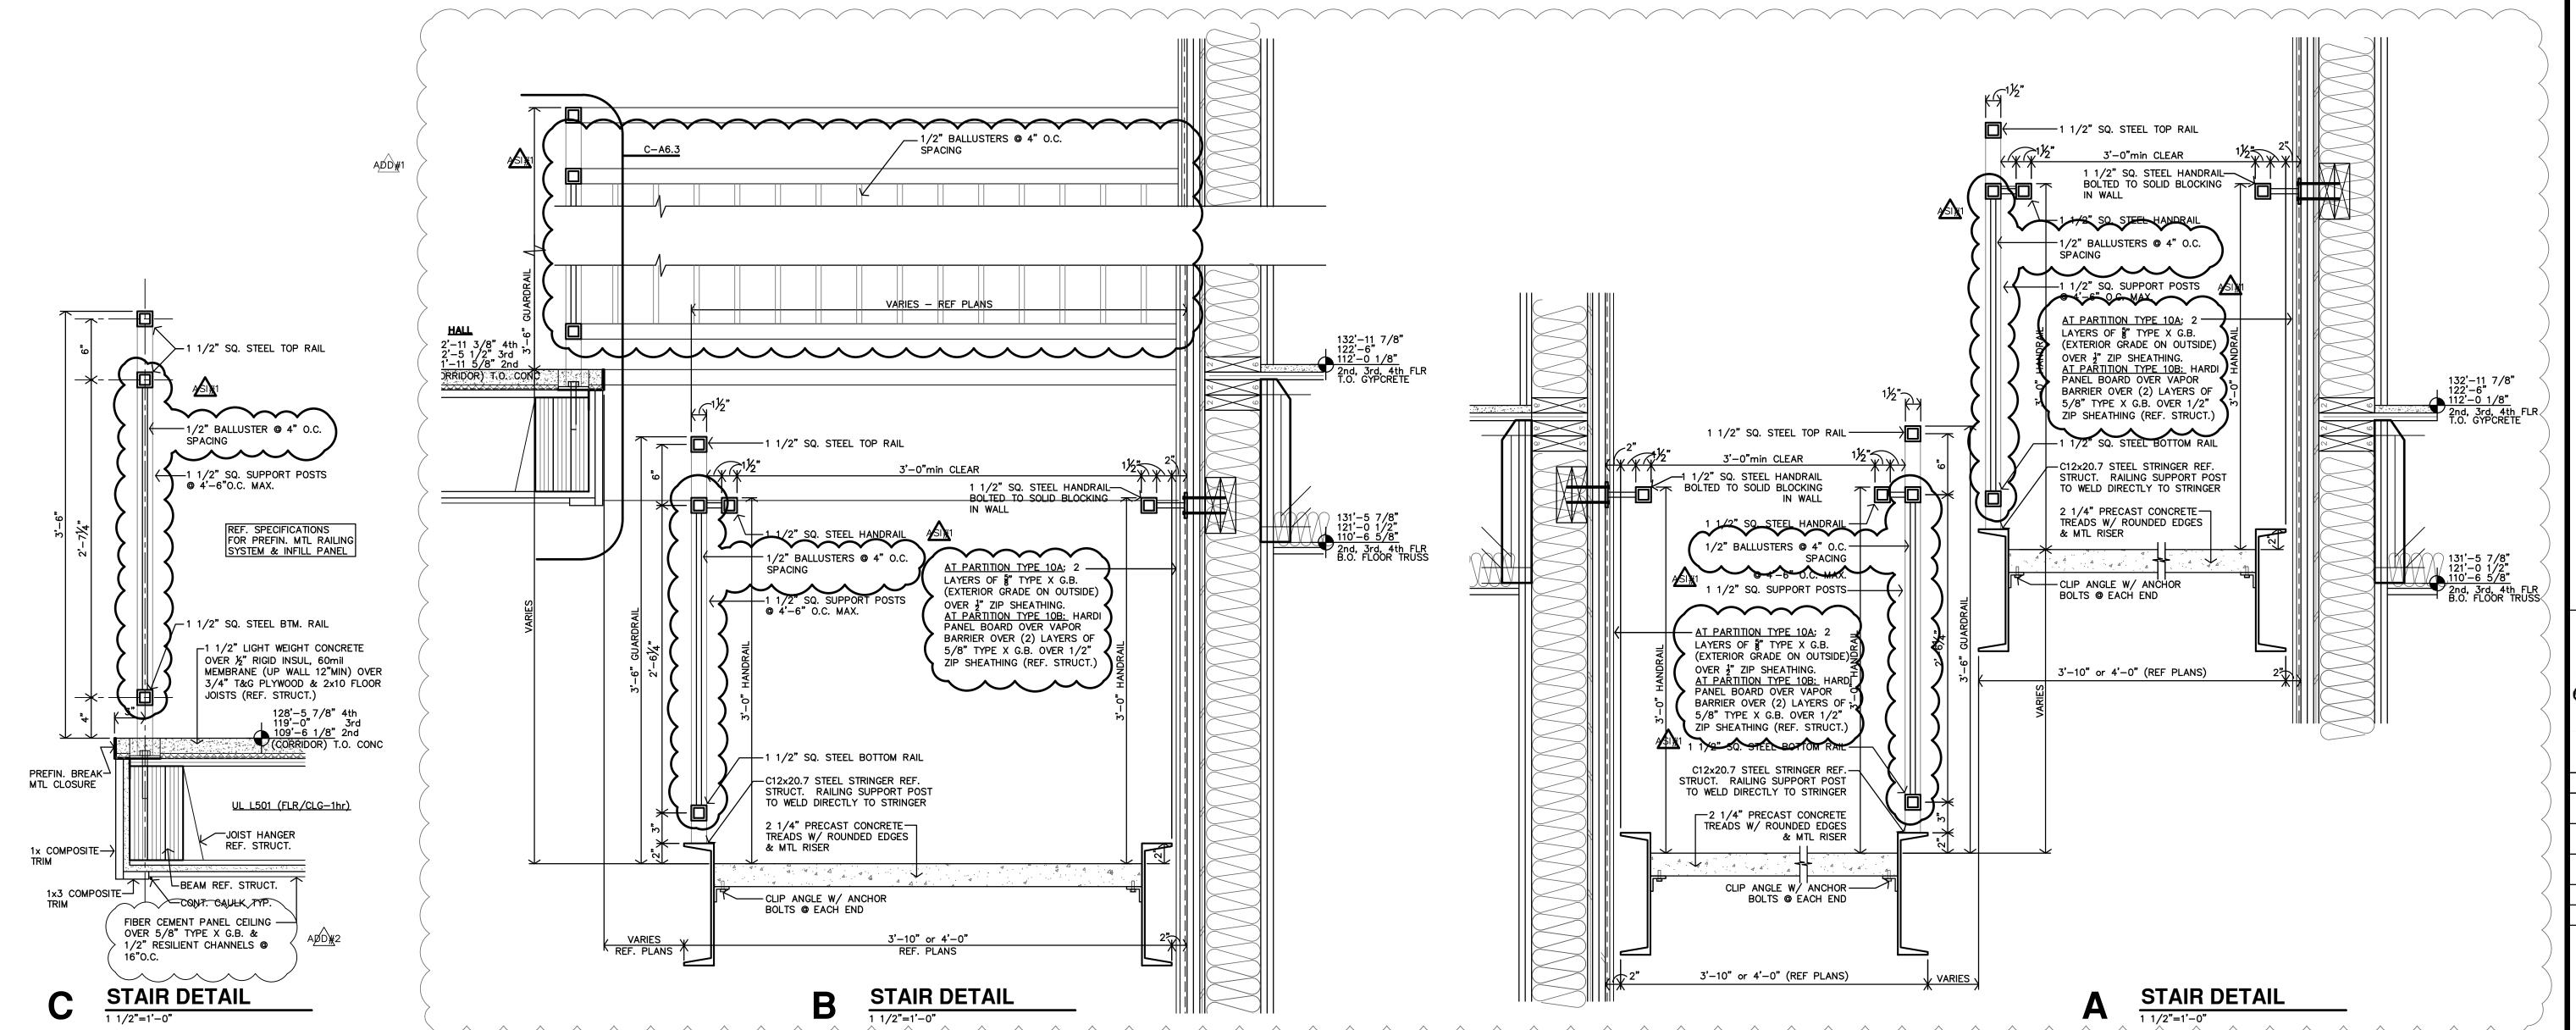
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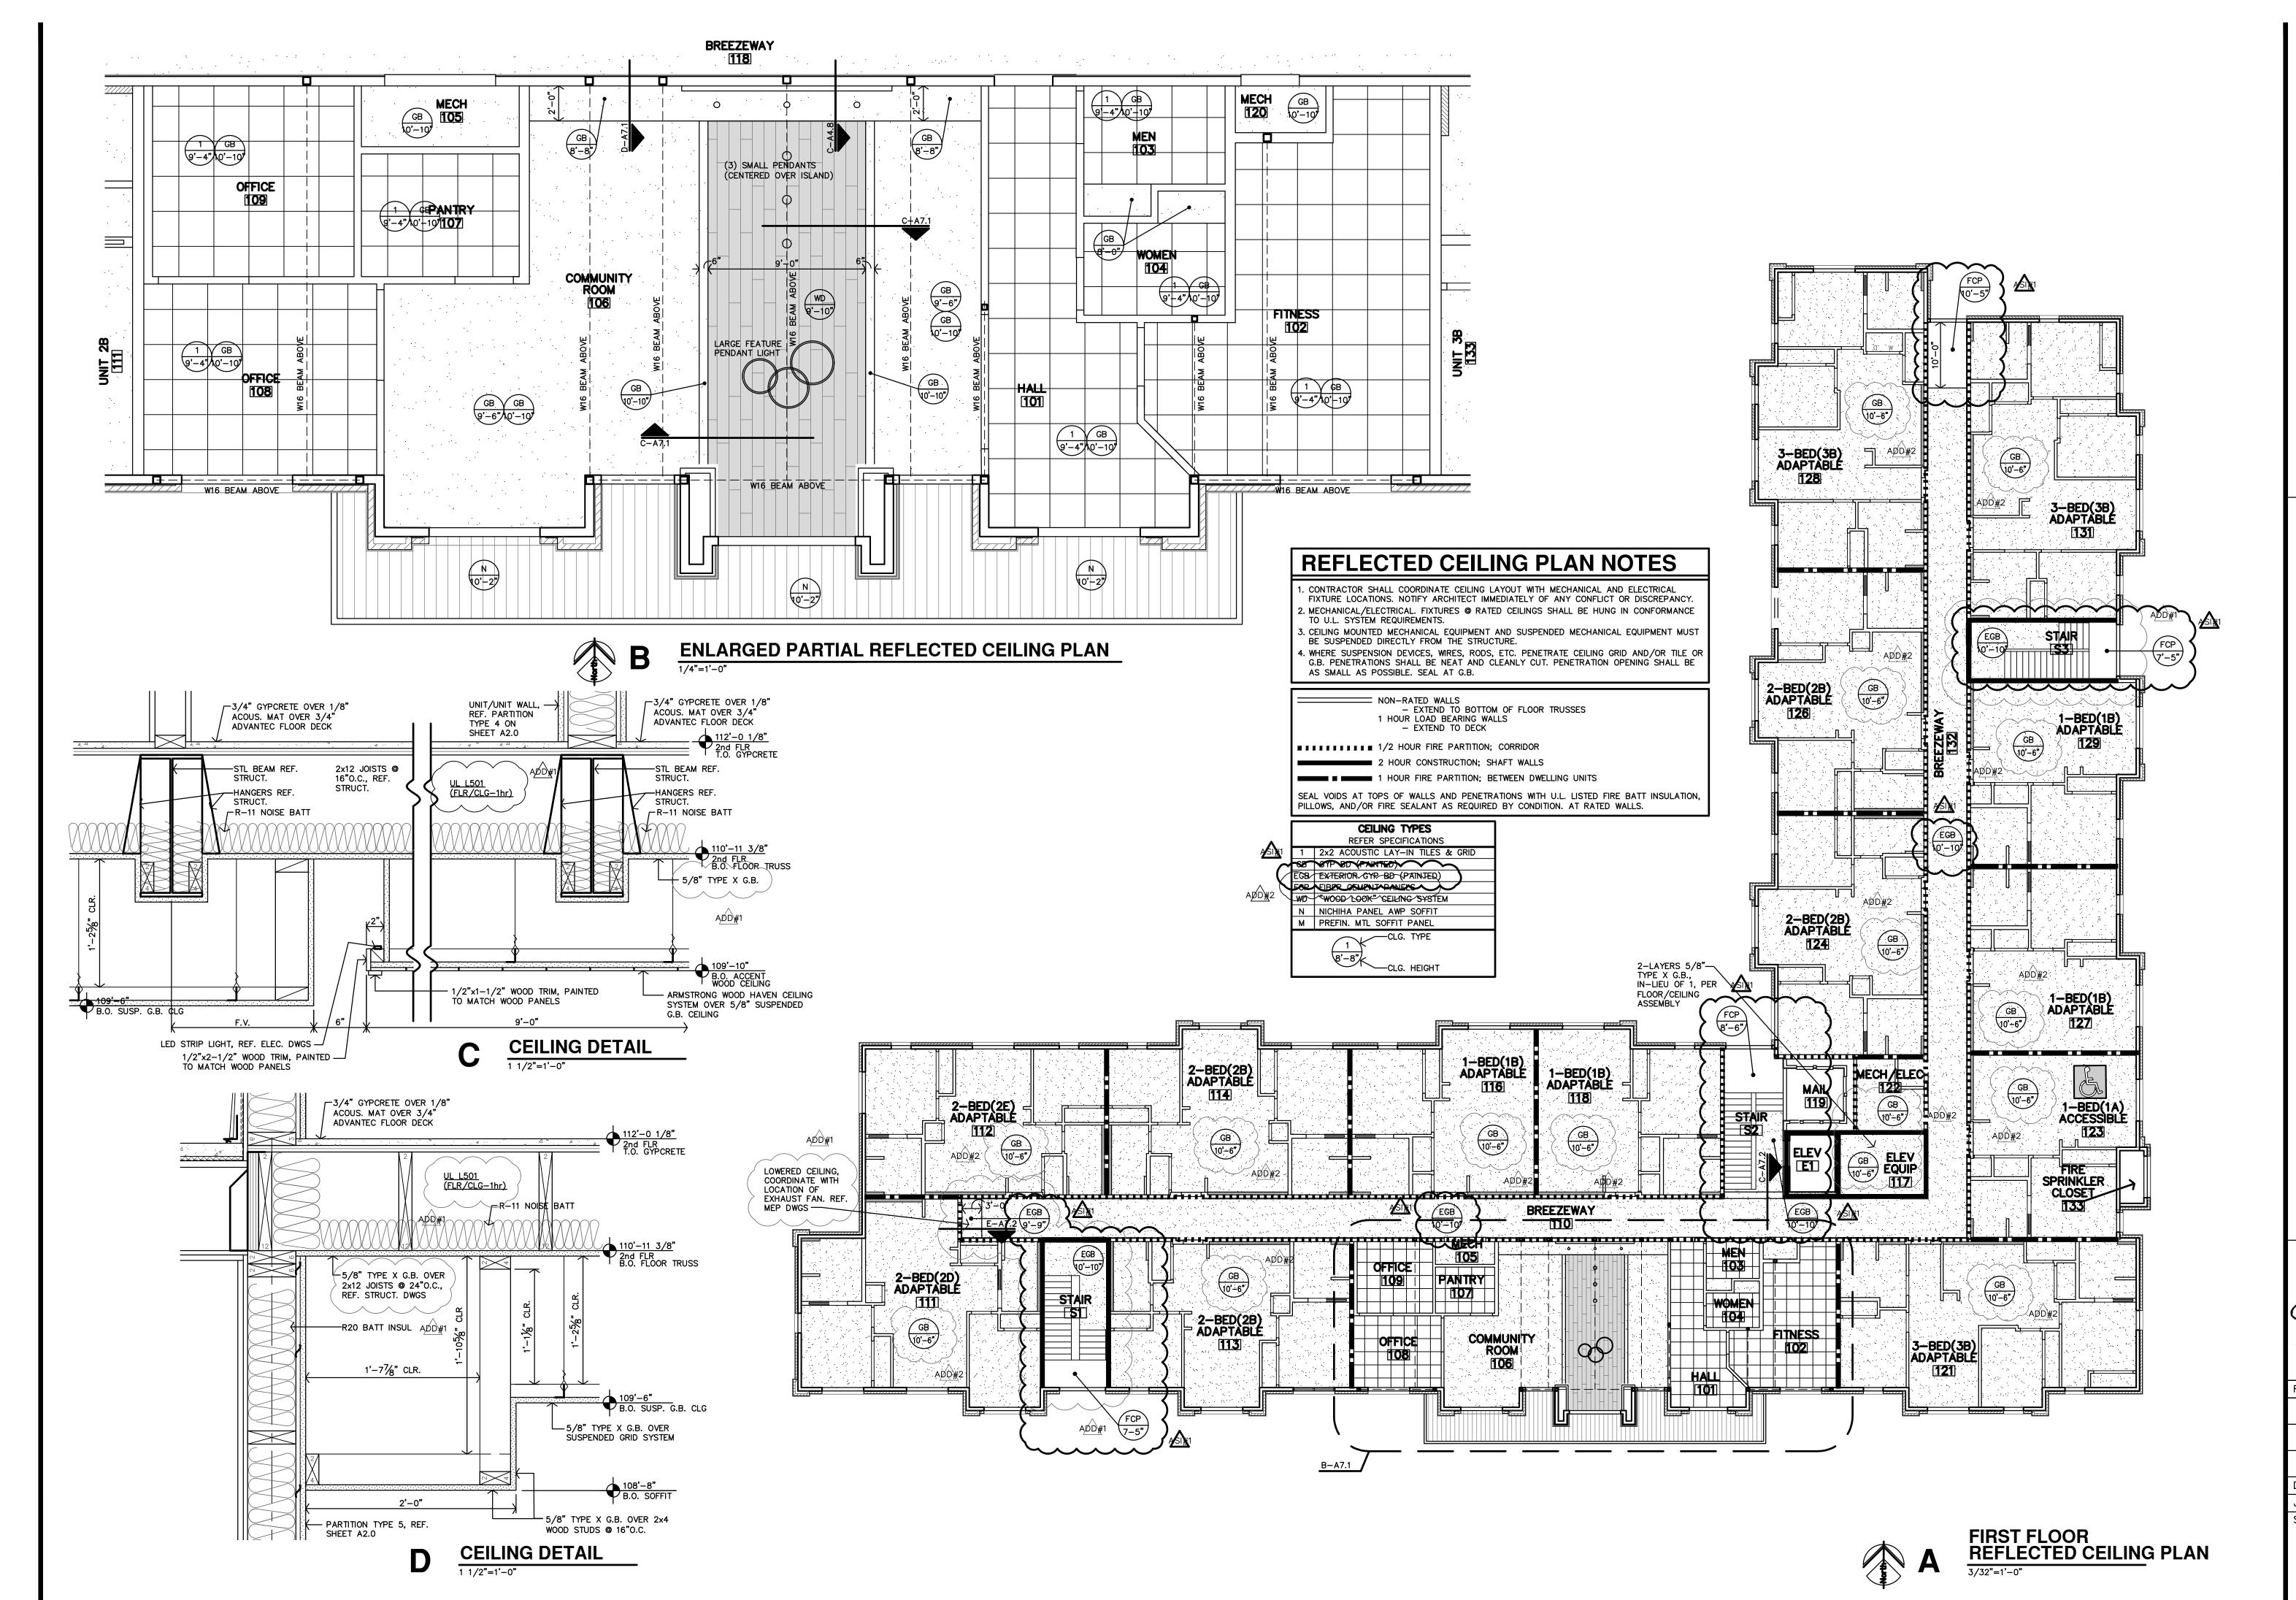
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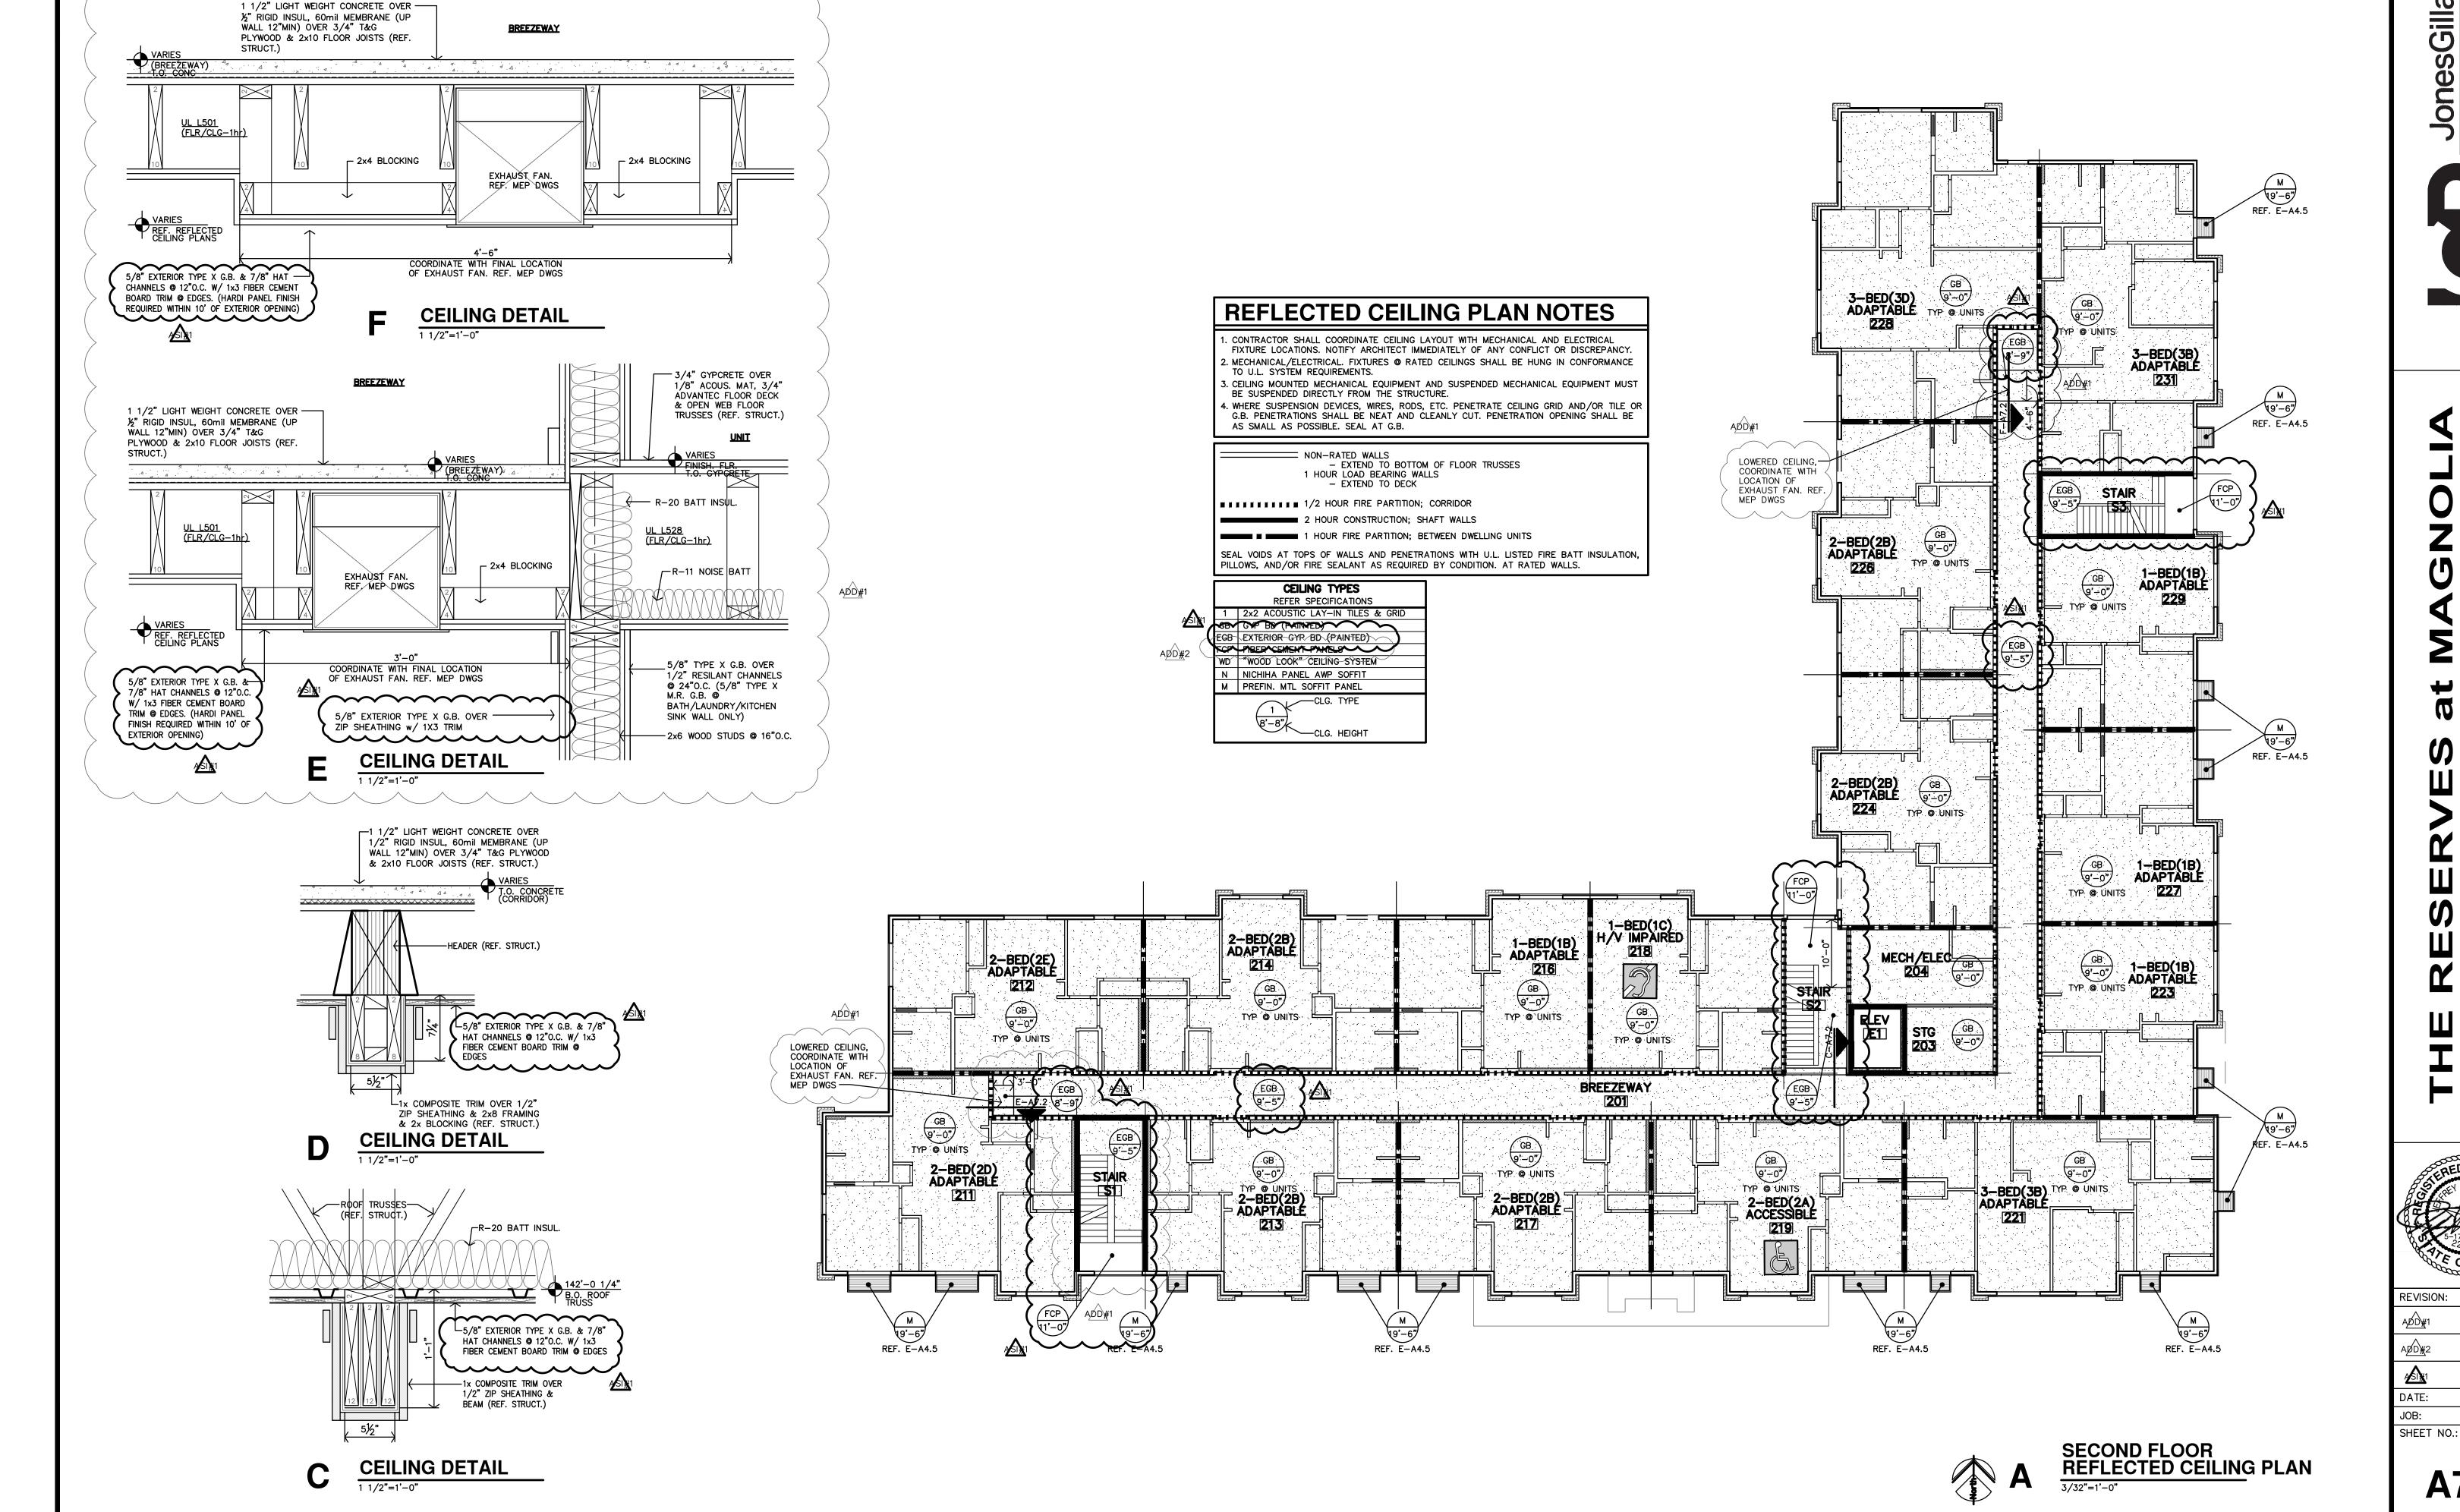


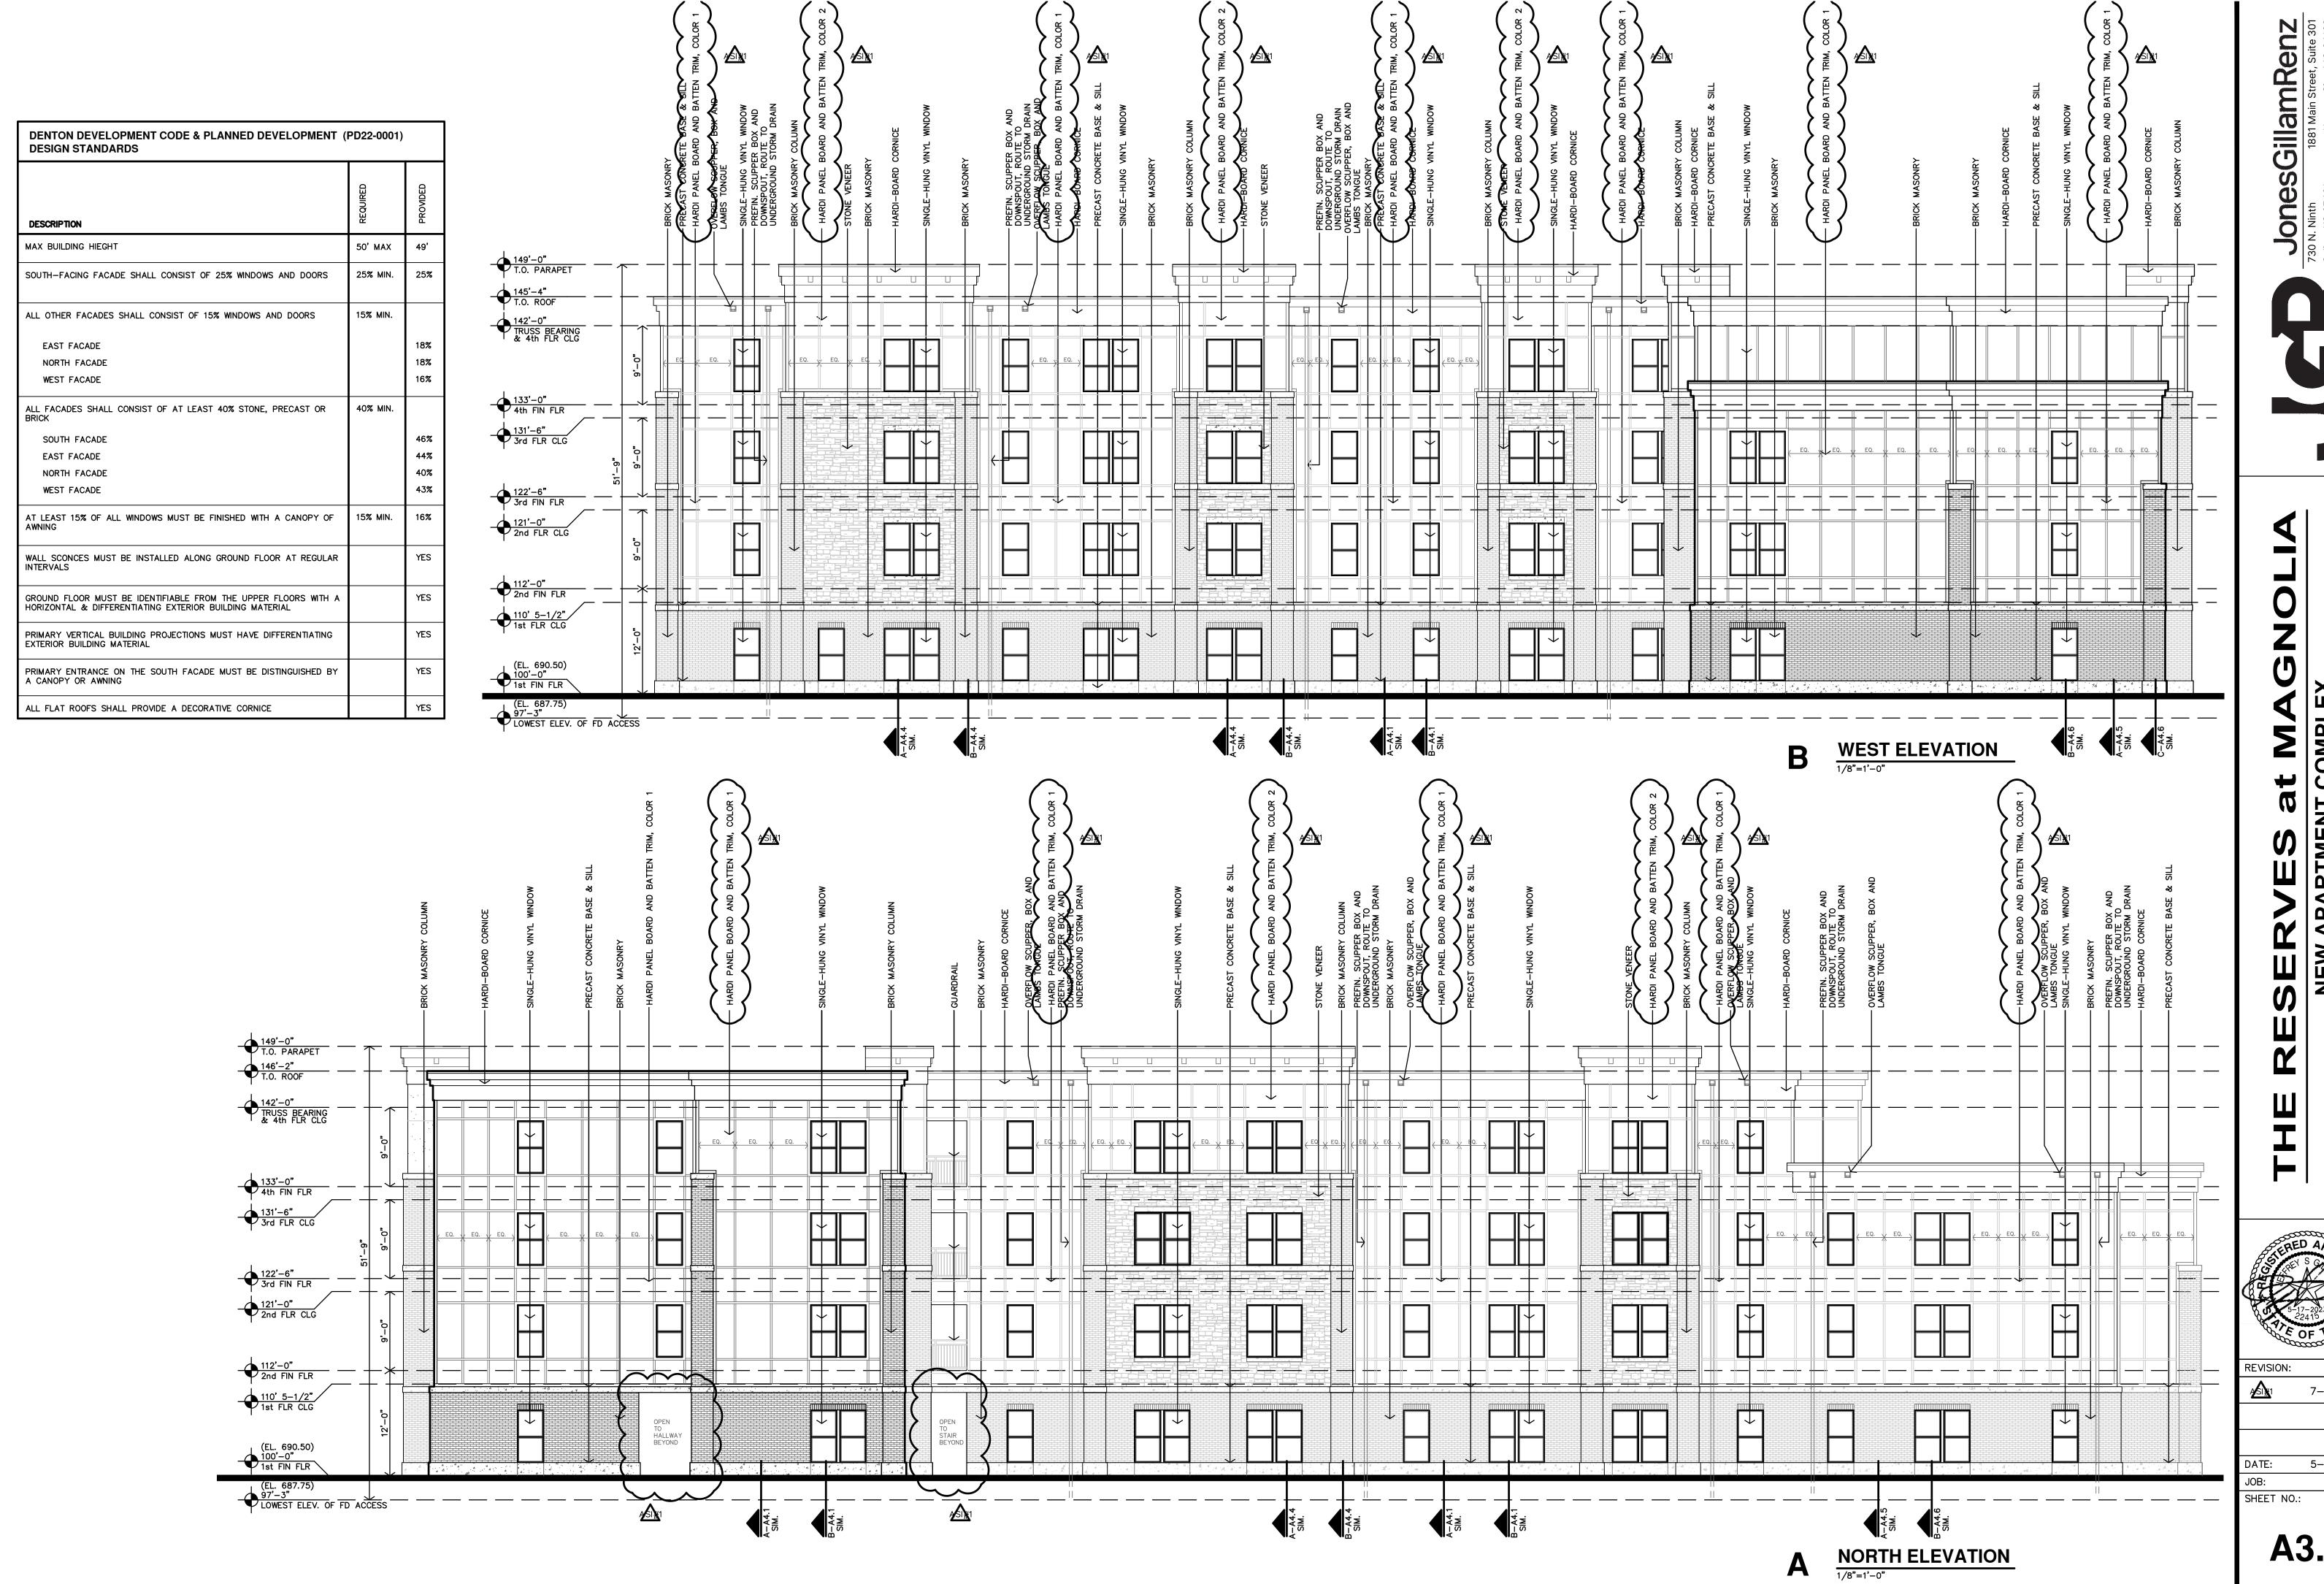


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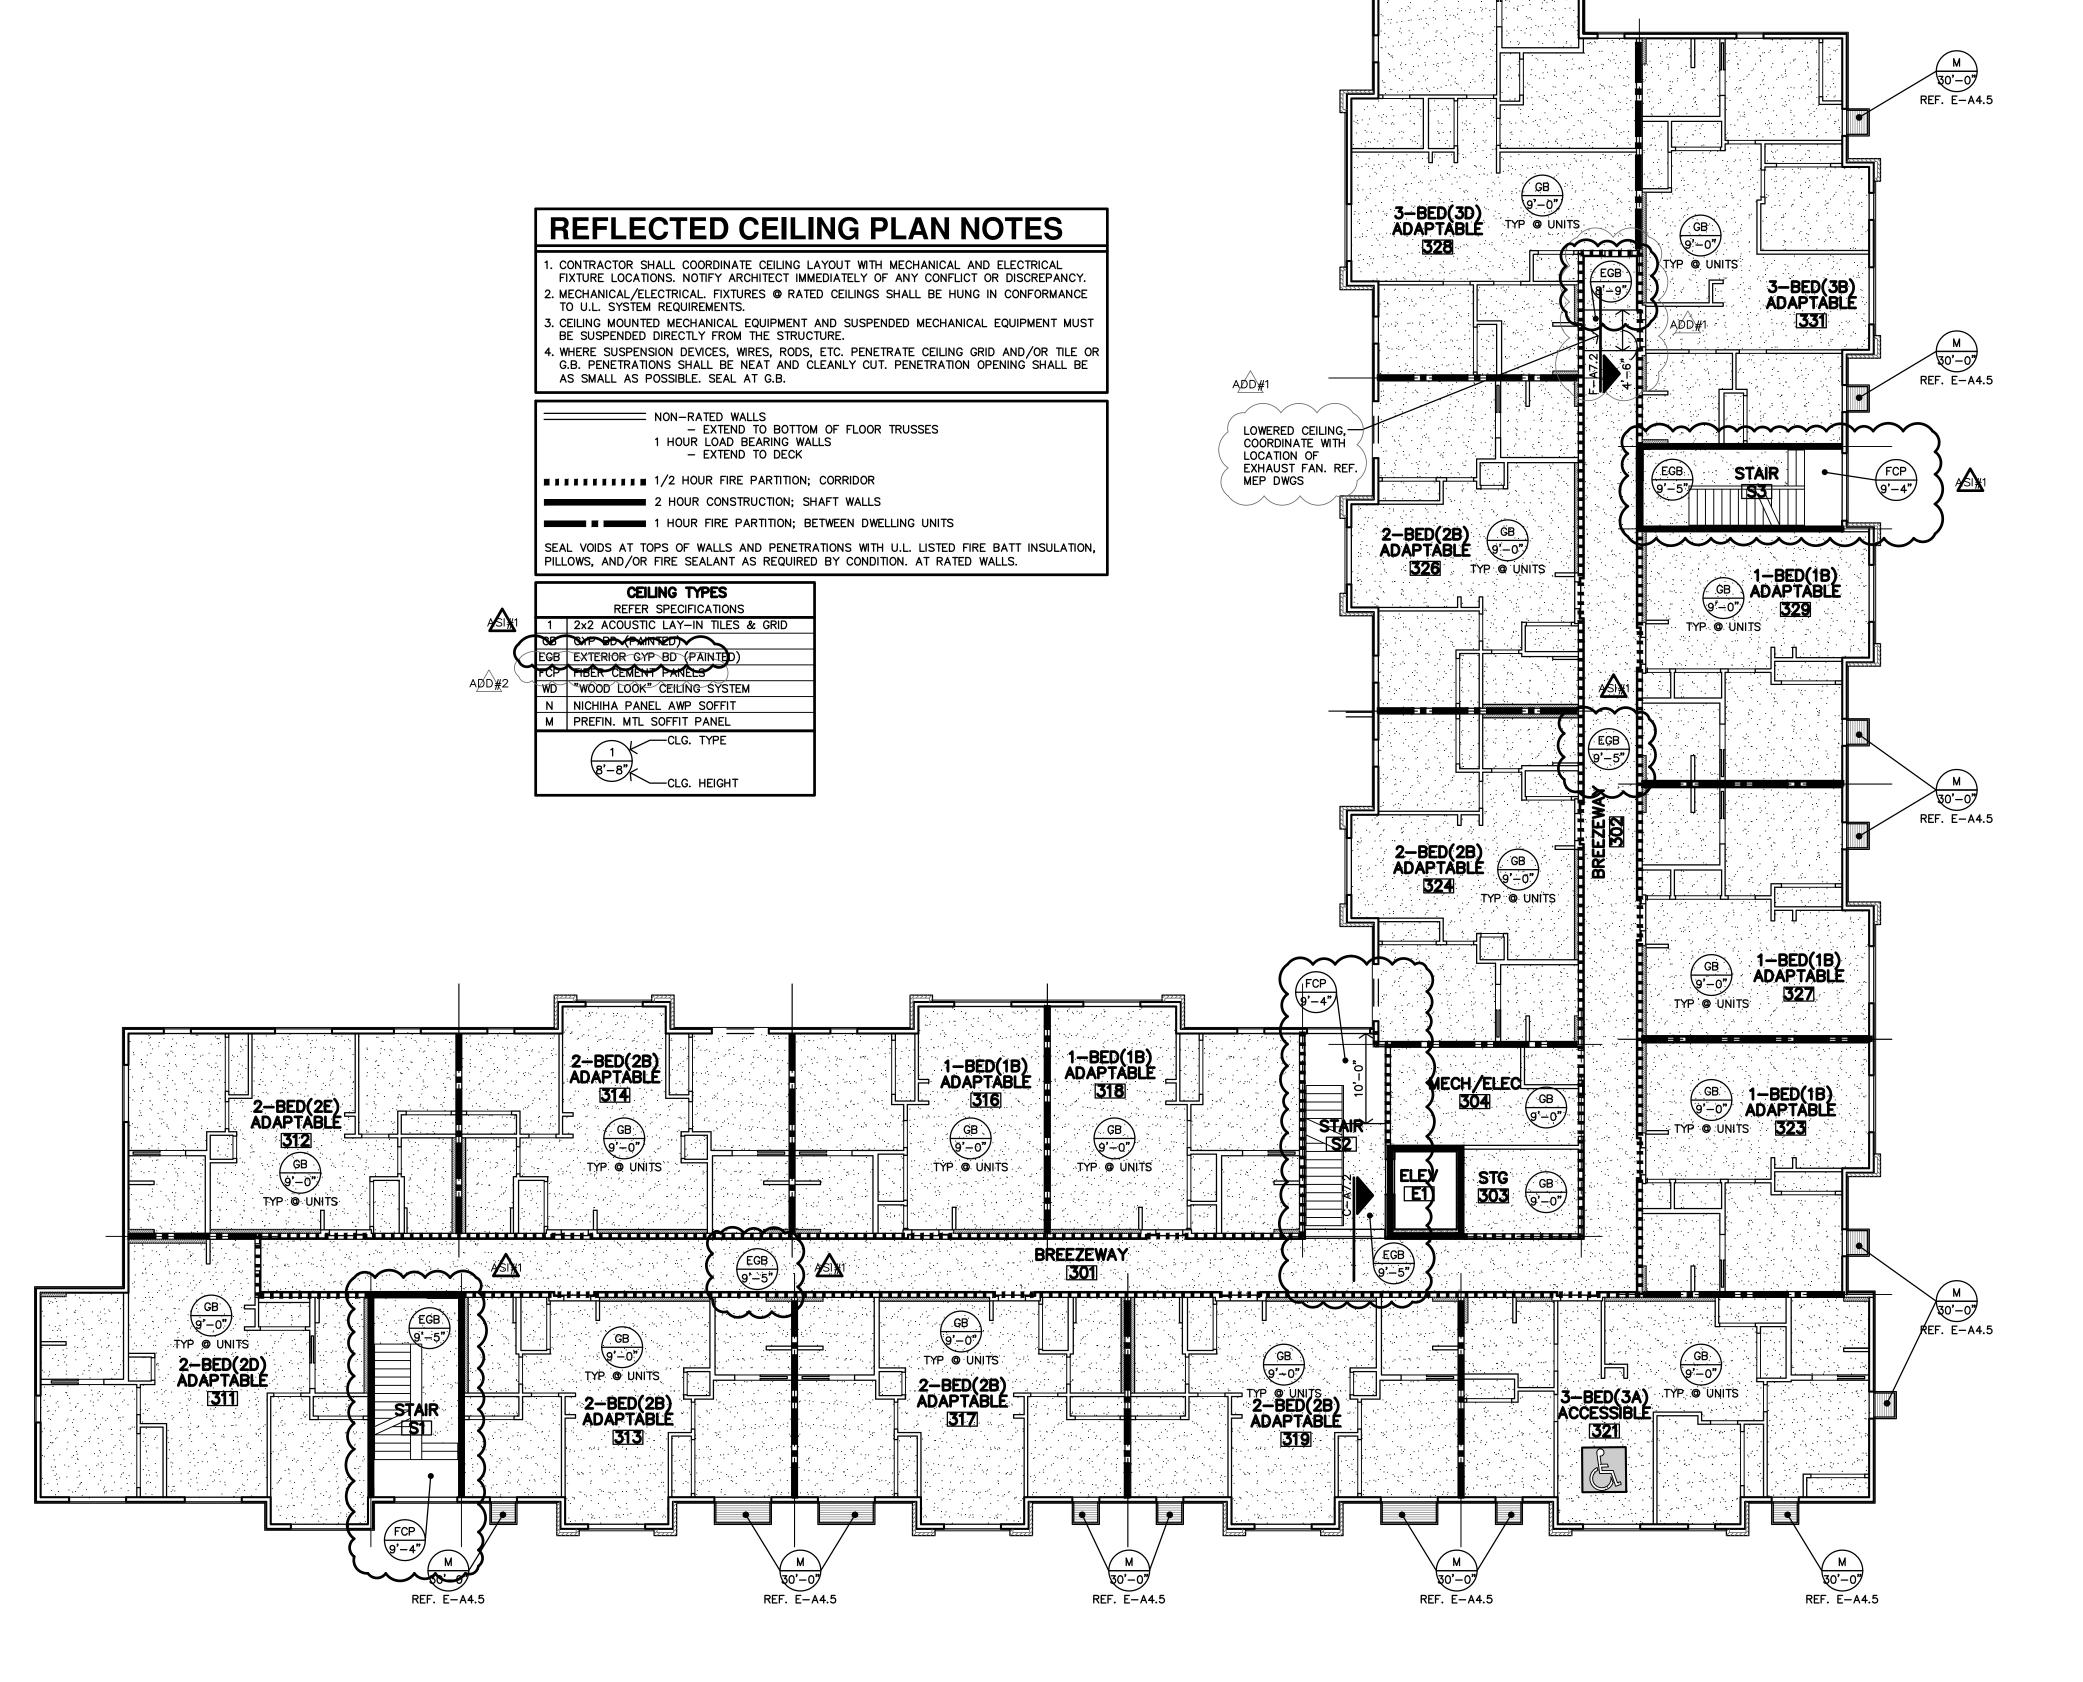
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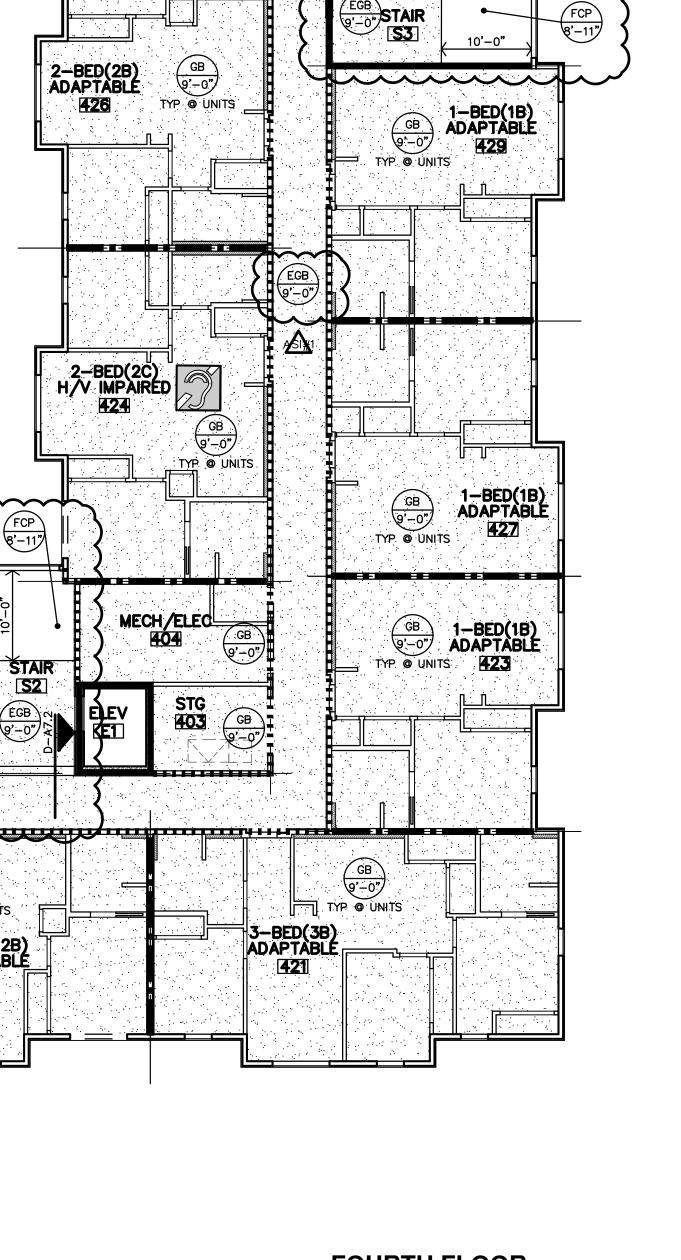
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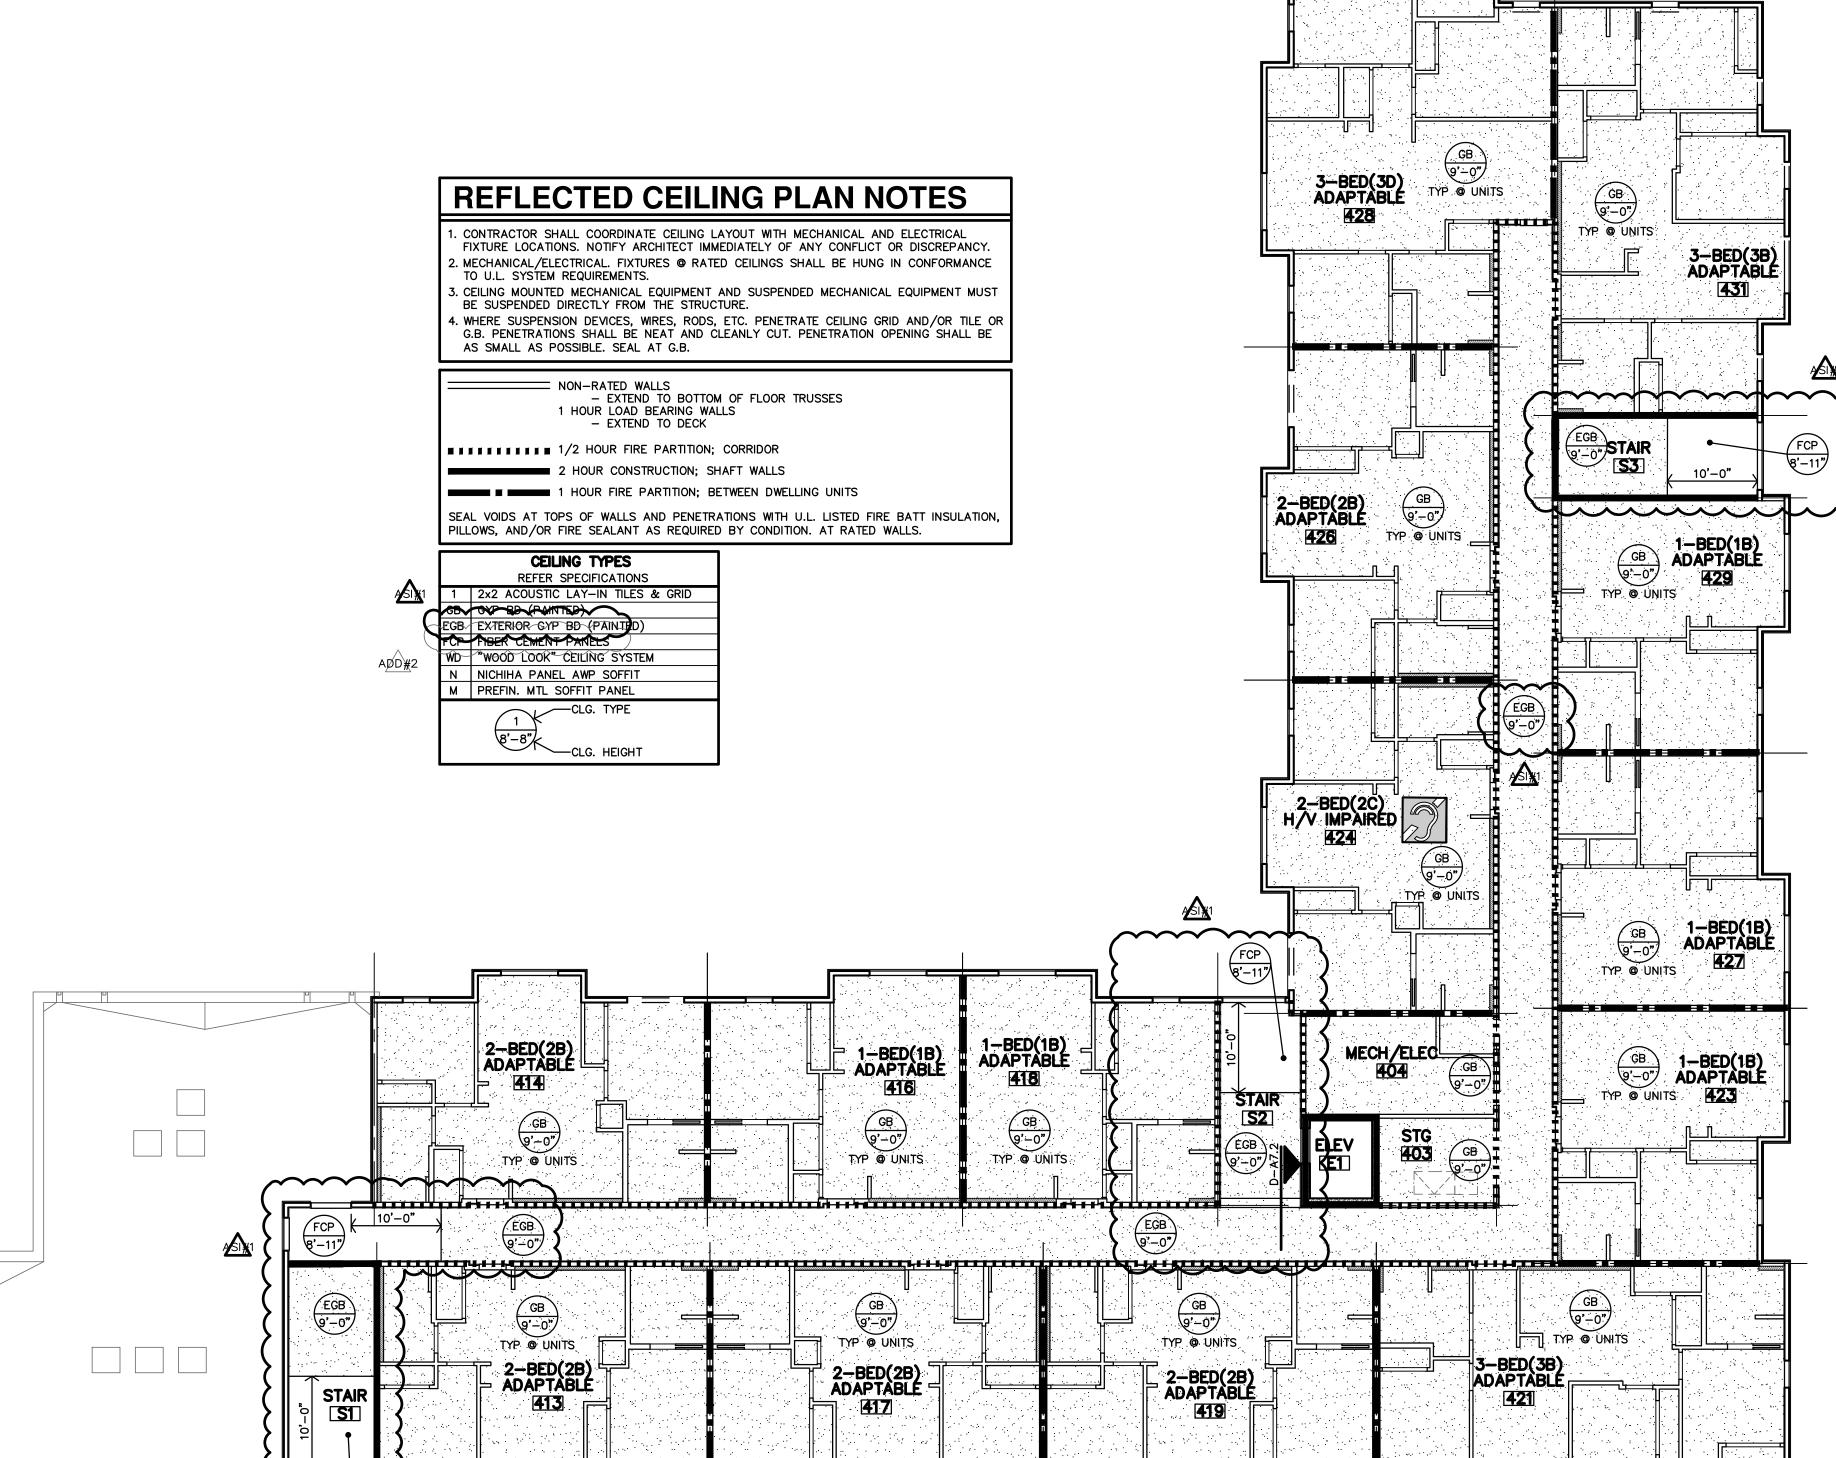
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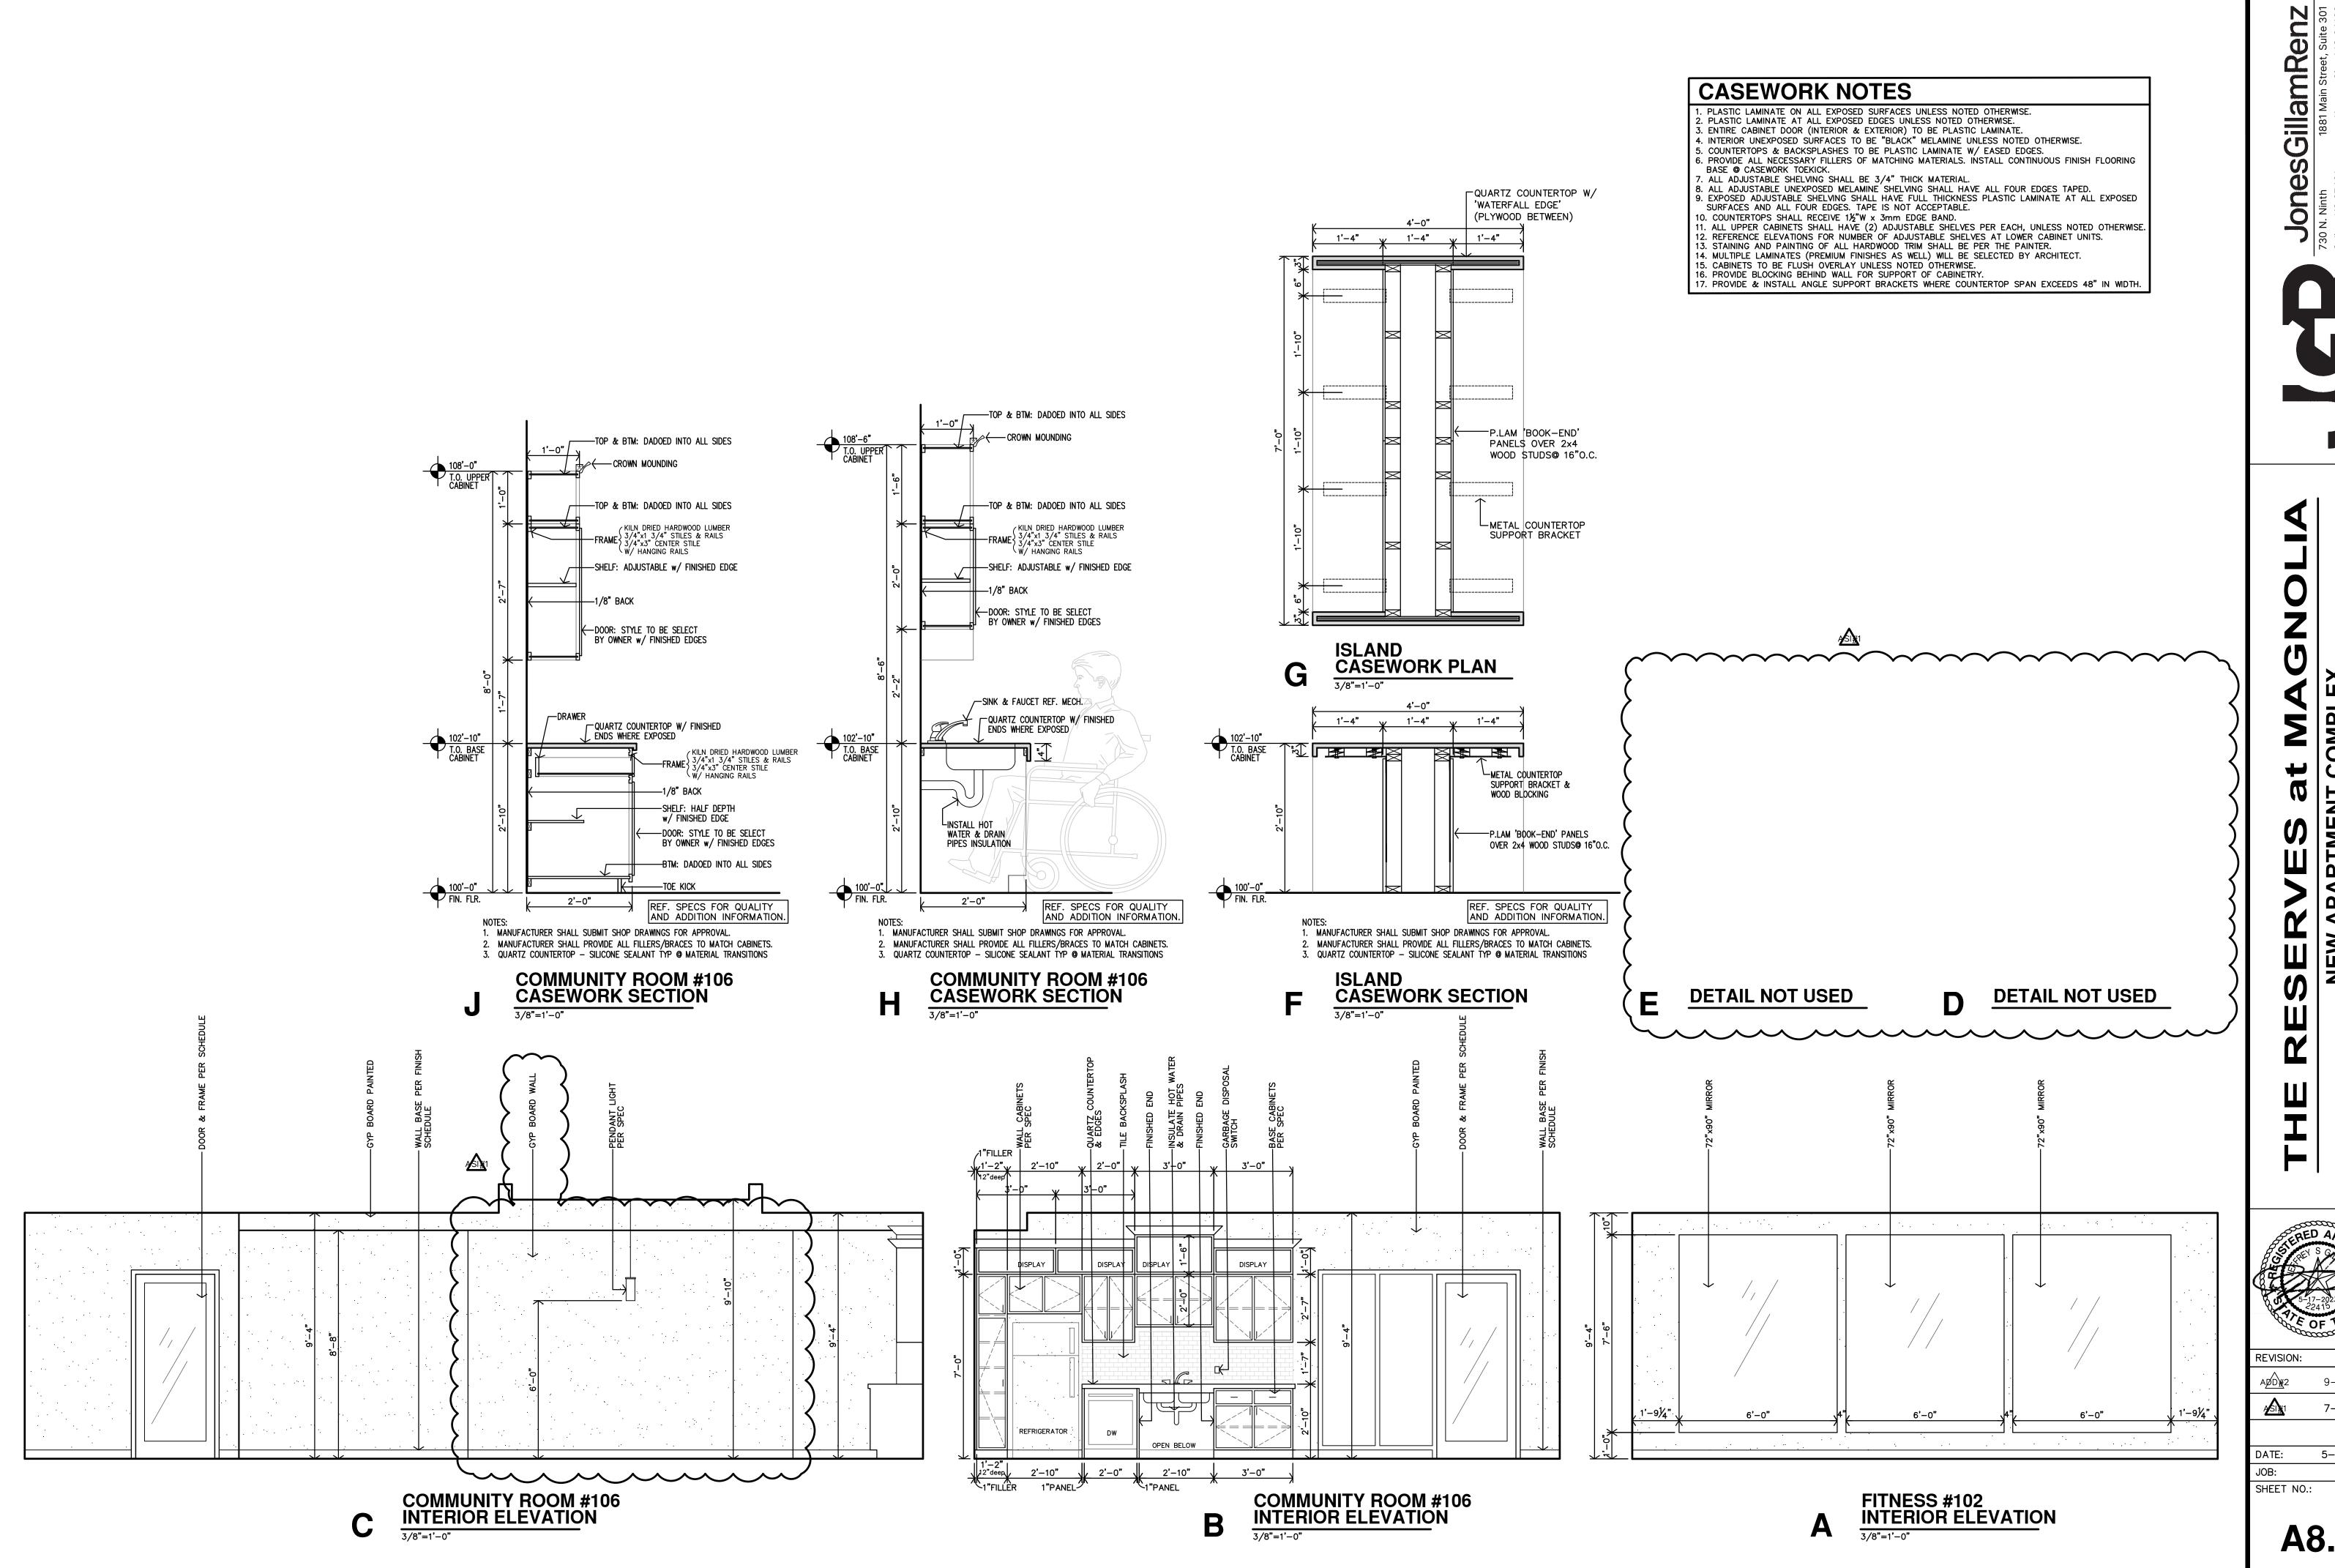
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FCP 8'-11"

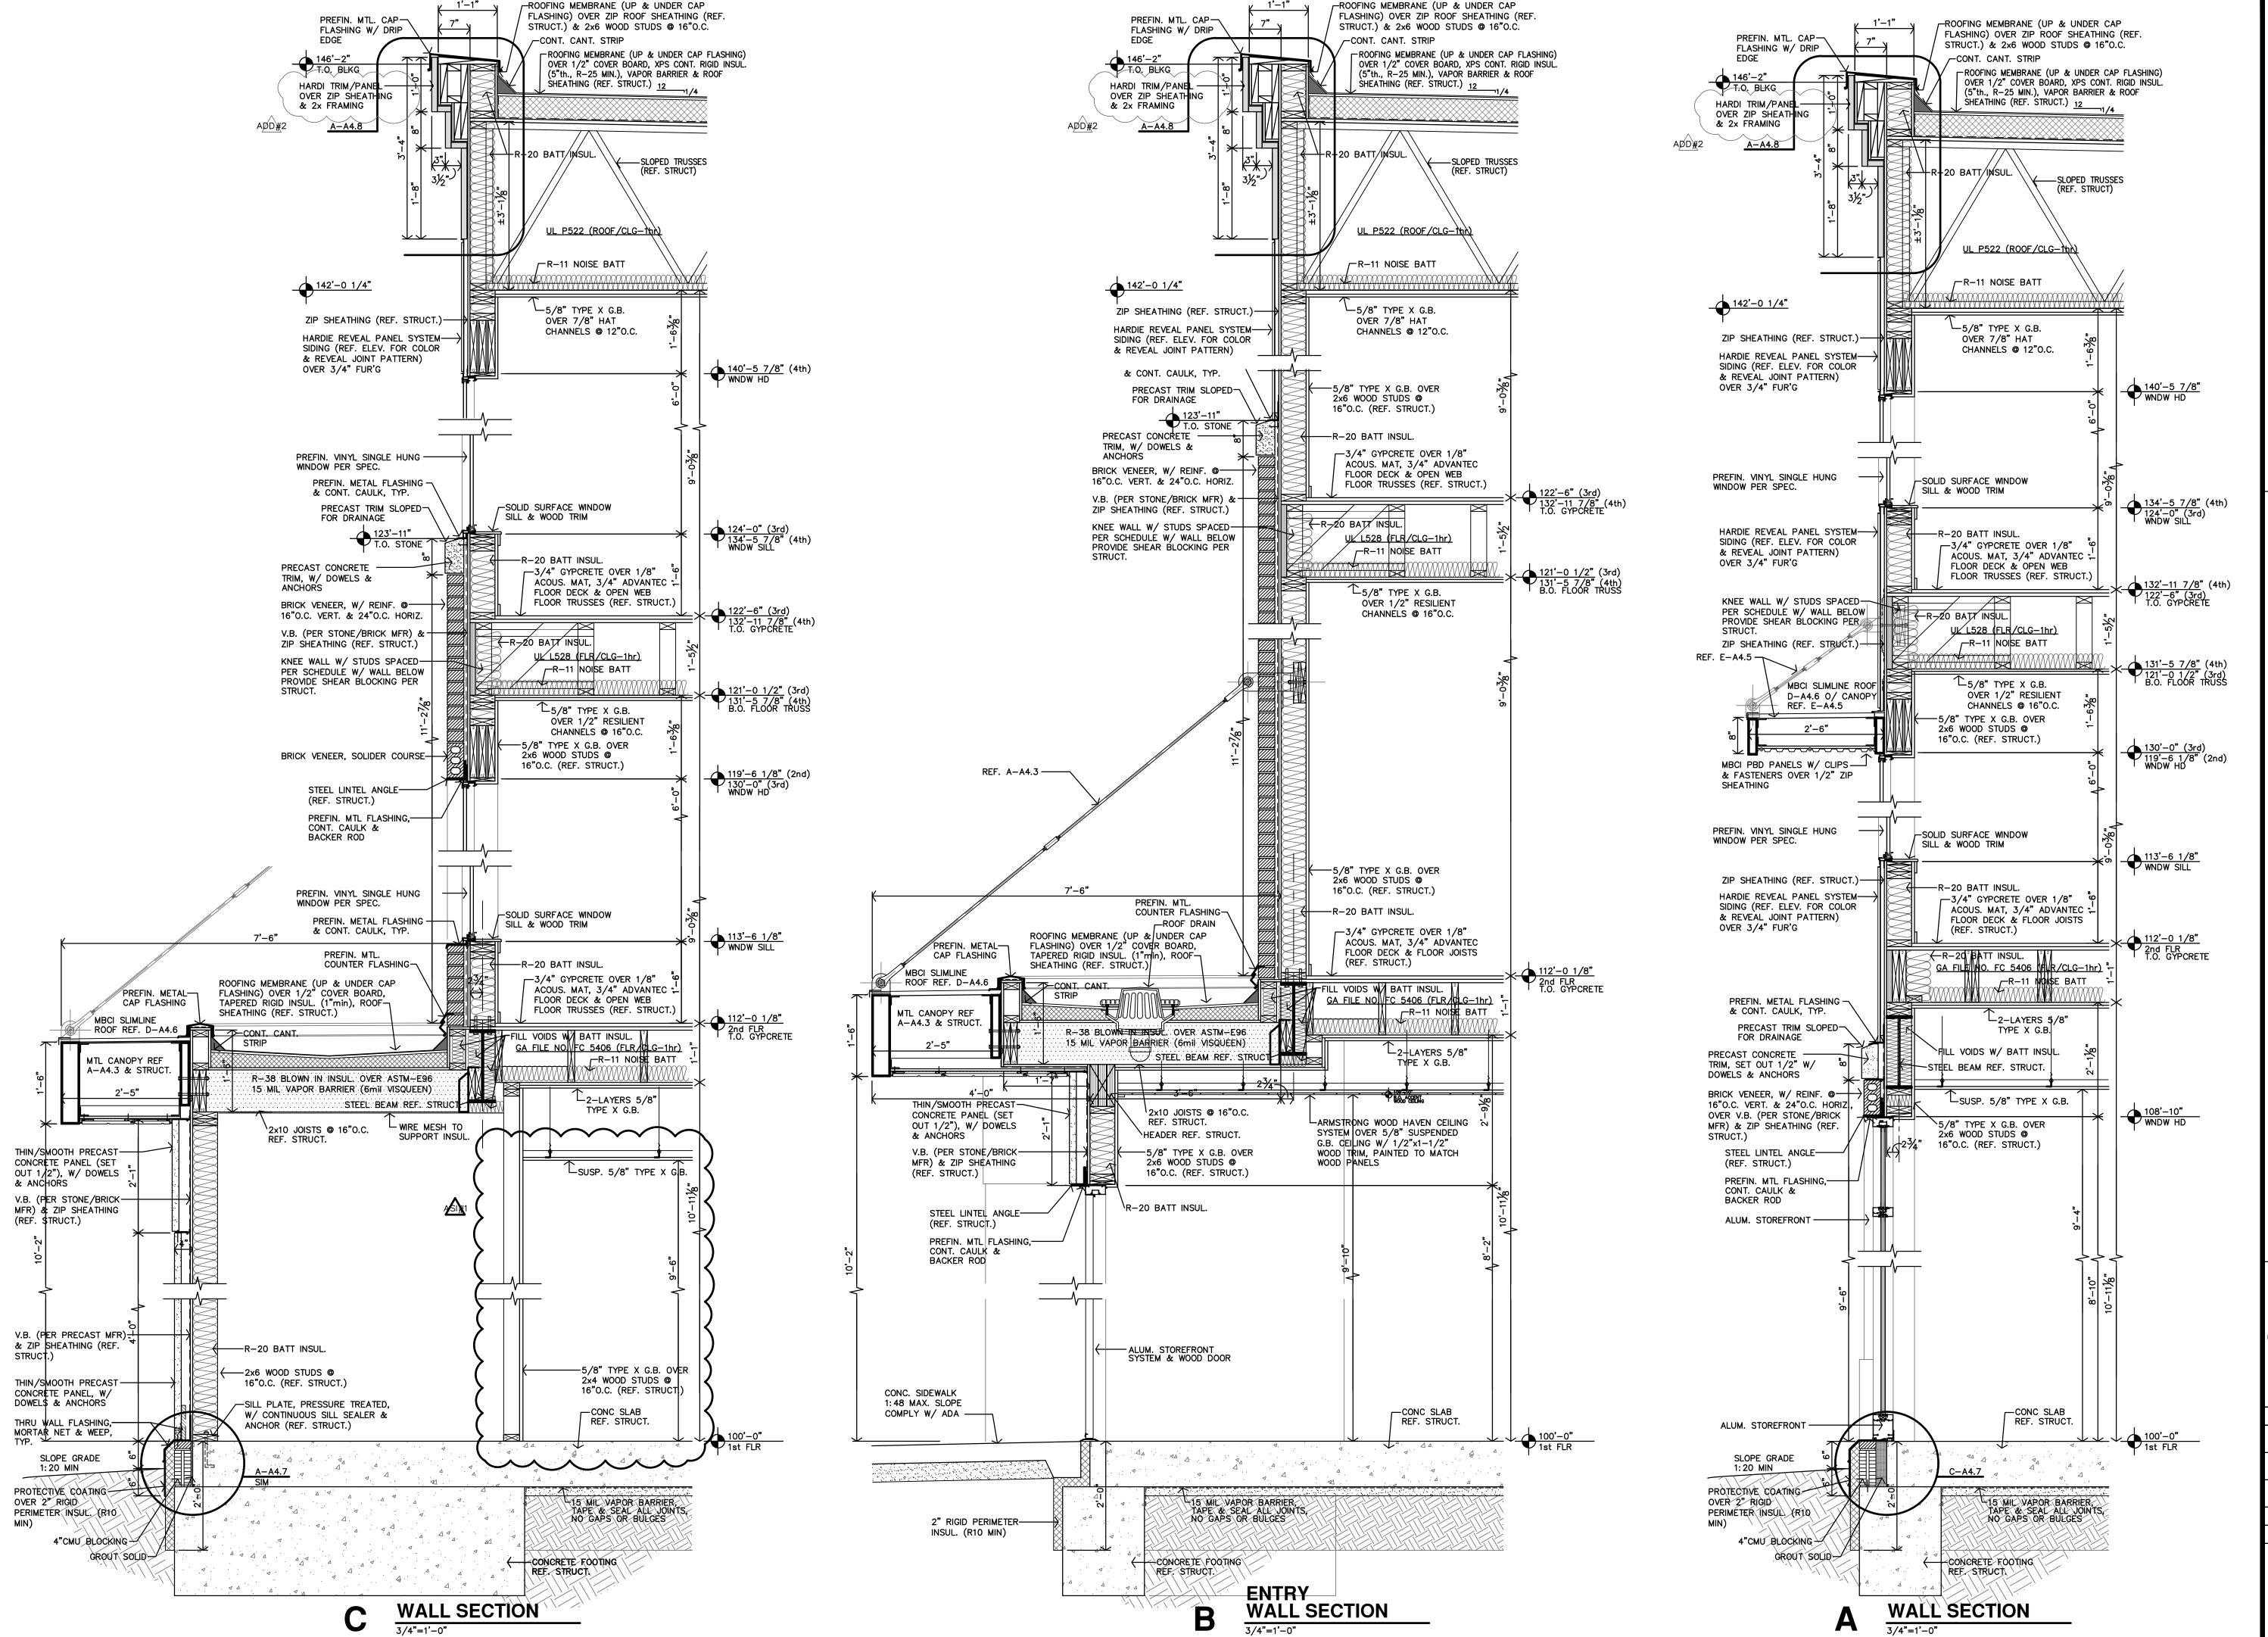


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785.827.0386 jgr@jgrarchitects.com


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Kansas City, MO 64108
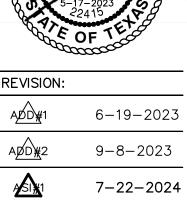
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730 N. Ninth
Salina, KS 67401
785.827.0386

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SERVES at MAGINEW APARTMENT COMPLEX

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REVISION:
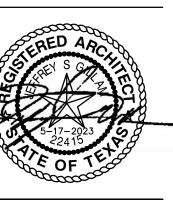
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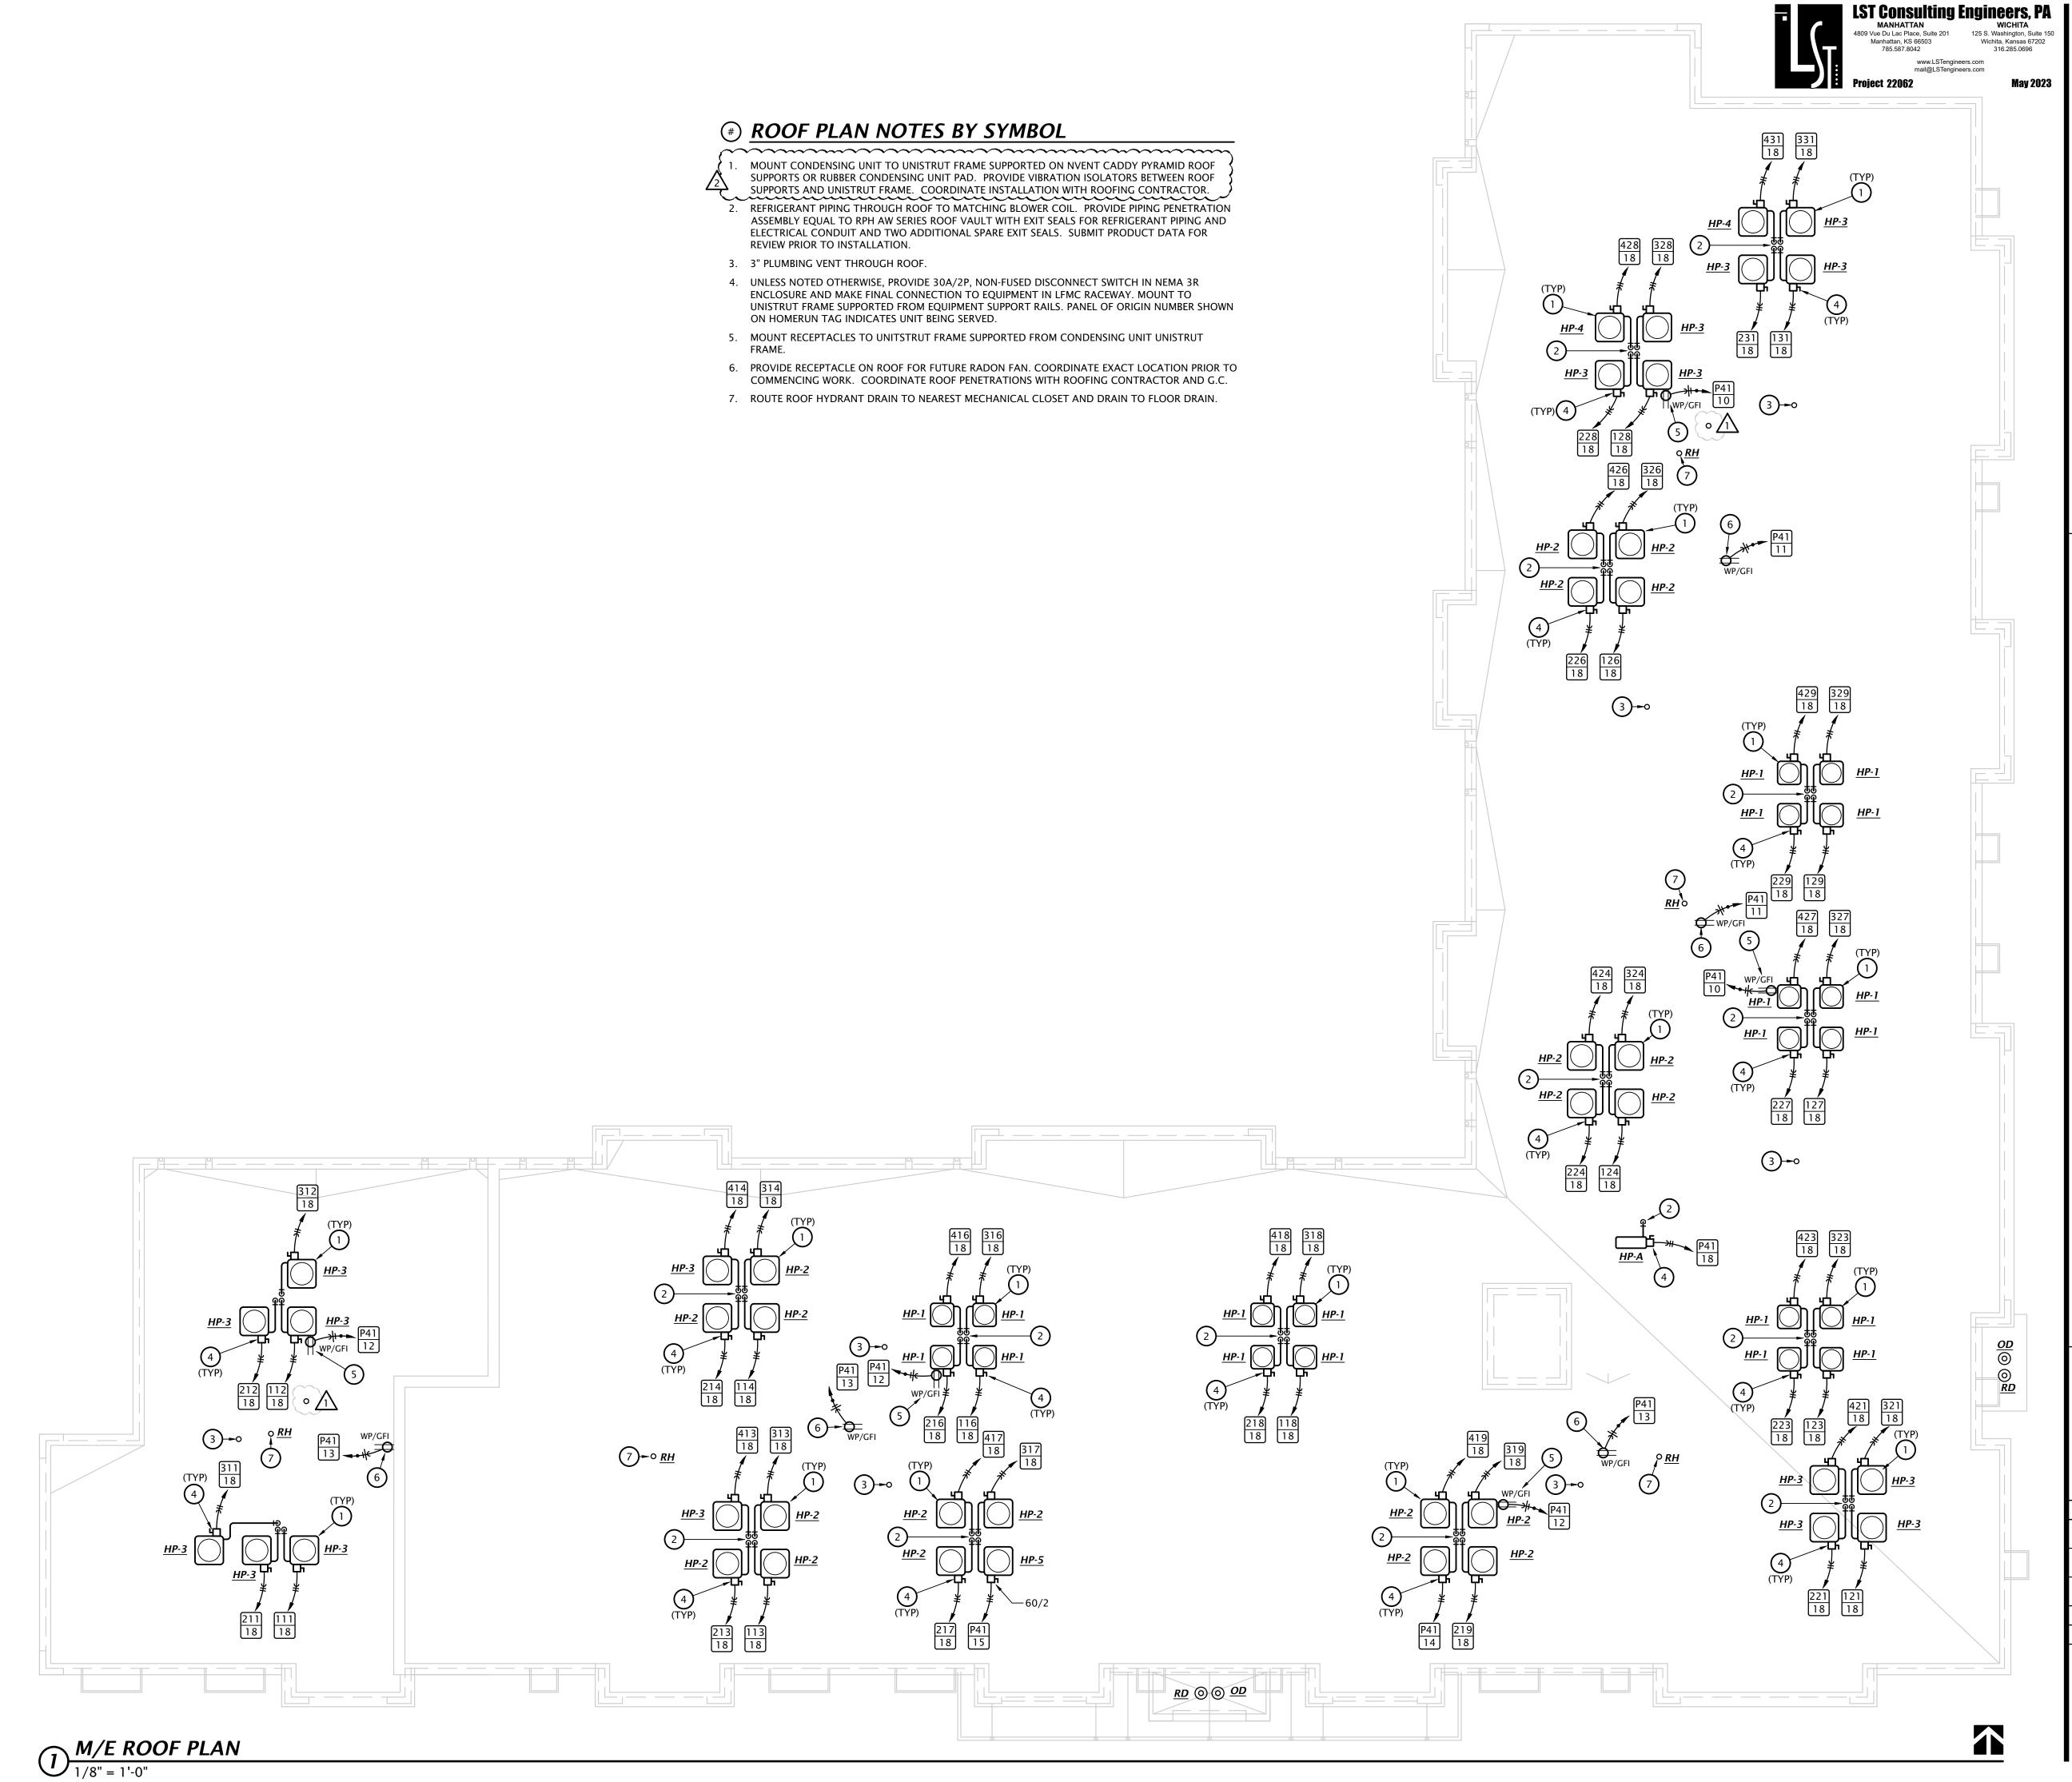
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JOB: 21-3205

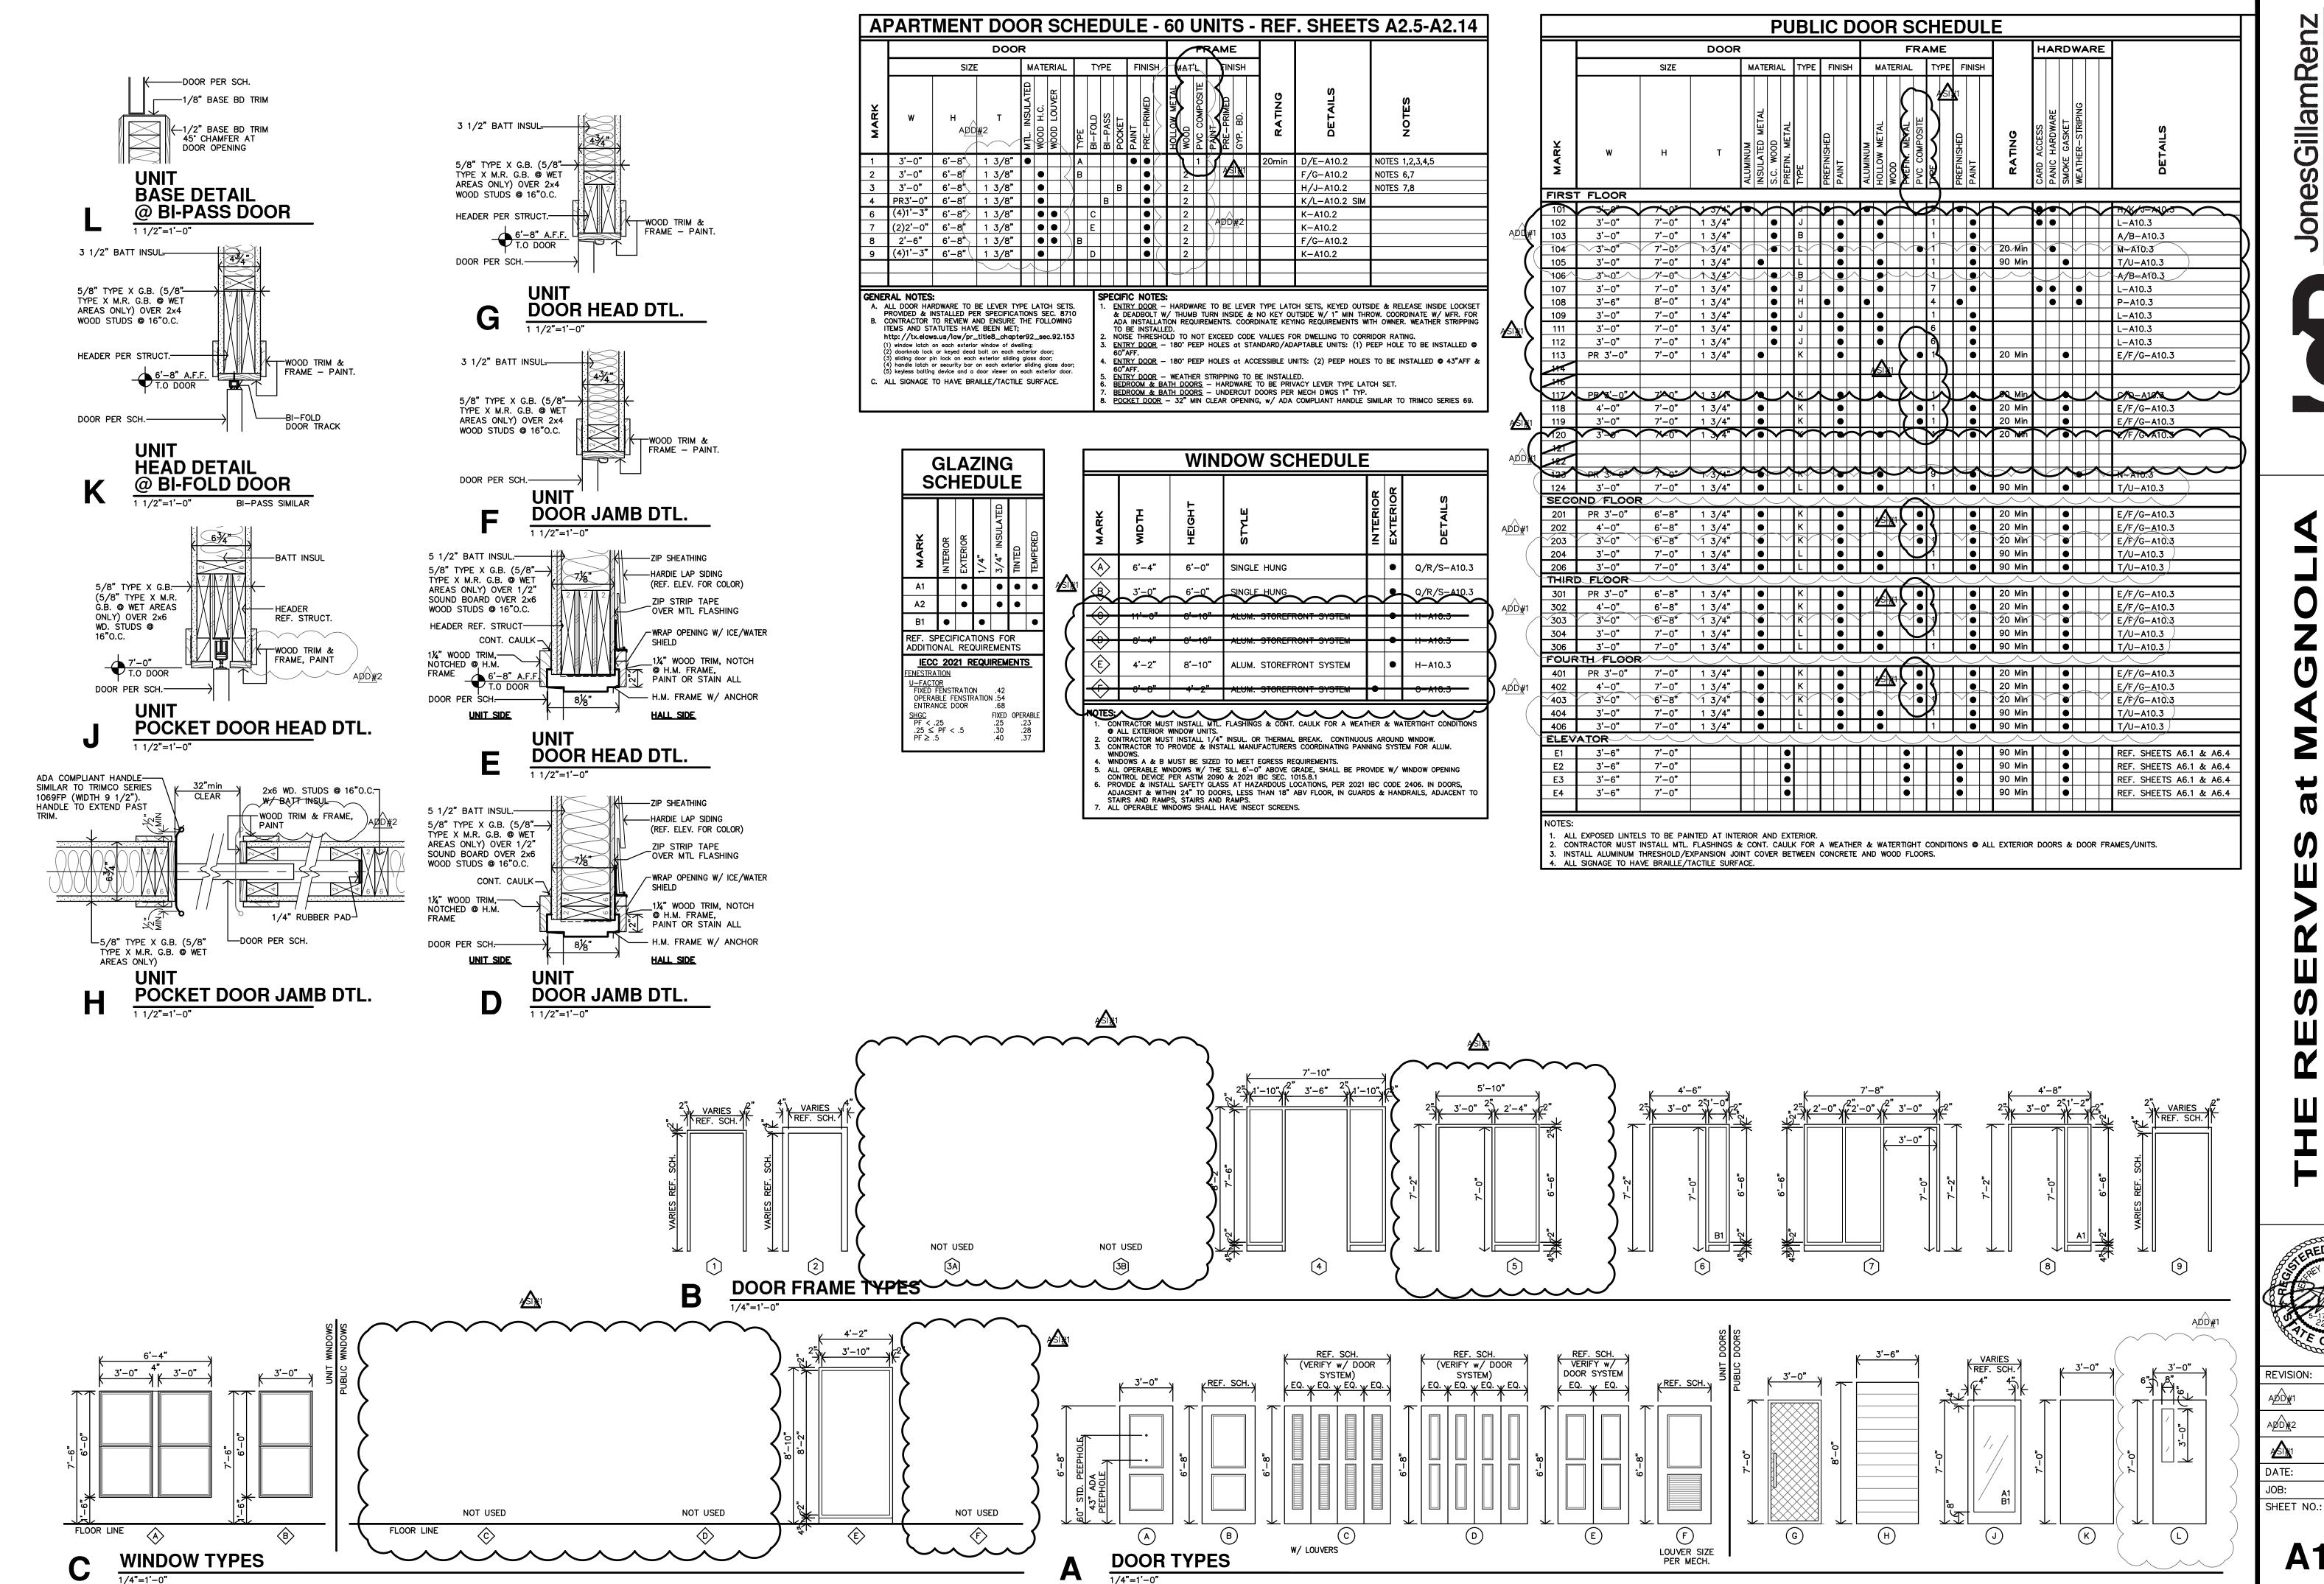A10.2



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ME2.1 8

DOMESTIC WATER PLAN NOTES BY SYMBOL

- 1. ROUTE 1-1/4" UP TO FLOOR ABOVE, SEE 1:P2.6 FOR CONTINUATION. ROUTE BRANCH TO FIRST FLOOR APARTMENT. SEE ENLARGED DOMESTIC WATER PLANS FOR SIZING AND ROUTING IN APARTMENT. PROVIDE SHUT-OFF VALVE AT BASE OF RISER.
- 2. ROUTE 1-1/2" UP TO FLOOR ABOVE, SEE 1:P2.6 FOR CONTINUATION. ROUTE BRANCH TO FIRST FLOOR APARTMENT. SEE ENLARGED DOMESTIC WATER PLANS FOR SIZING AND ROUTING IN APARTMENT. PROVIDE SHUT-OFF VALVE AT BASE OF RISER.
- 3. ROUTE 1-1/4" TO FIRST FLOOR APARTMENT. SEE ENLARGED DOMESTIC WATER PLANS FOR SIZING AND ROUTING IN APARTMENT.
- 4. ROUTE 1-1/2" UP TO FLOOR ABOVE, SEE 1:P2.6 FOR CONTINUATION.
- 5. ROUTE 1-1/4" UP TO FLOOR ABOVE, SEE 1:P2.7 FOR CONTINUATION. ROUTE BRANCH TO SECOND FLOOR APARTMENT. SEE ENLARGED DOMESTIC WATER PLANS FOR SIZING AND ROUTING IN APARTMENT.
- 6. ROUTE 1-1/4" UP TO FOURTH FLOOR APARTMENT ABOVE, SEE 1:P2.8 FOR CONTINUATION. ROUTE BRANCH TO THIRD FLOOR APARTMENT. SEE ENLARGED DOMESTIC WATER PLANS FOR SIZING AND ROUTING IN APARTMENTS.
- 7. ROUTE ALL APARTMENT WATER PIPING BELOW FLOOR.
- 8. PROVIDE PUBLIC LAVATORIES WITH POINT OF USE TEMPERING VALVE.
- 9. ROUTE HOT WATER DOWN IN WALL TO MINIMIZE DISTANCE TO LAVATORIES.
- 10. ROUTE 1" UP TO FOURTH FLOOR APARTMENT ABOVE, SEE 1:P2.8 FOR CONTINUATION. ROUTE BRANCH TO THIRD FLOOR APARTMENTS. SEE ENLARGED DOMESTIC WATER PLANS FOR SIZING AND ROUTING IN APARTMENTS.
- 11. 3/4" DOMESTIC COLD WATER LINE ROUTED IN ATTIC SPACE.

12 3/4" DOMESTIC COLD WATER UP TO ROOF HYDRANT.

13. PROVIDE PIPING INSULATION PER SPECIFICATIONS WHERE PIPING CROSSES BREEZEWAYS. Lucium minimum J

		ALTERNATE MATERIAL/SIZE					
		Cross-linked polyethylene (PEX)	Polypropylene (PP)				
E	1/2"	3/4"	1/2"				
COPPER PIPE SIZE INDICATED	3/4"	1"	1"				
PPER PIPE S INDICATED	1"		1-1/4"				
PIF AT	1-1/4"		1-1/2"				
R I	1-1/2"		2"				
PE	2"		2-1/2"				
.OF	2-1/2"		3"				
)	3"		3-1/2"				

Note: Pipe sizes indicated on drawings are for Type L copper pipe. If alternate materials are used, sizes shall be as indicated above. Where no pipe size is shown, use of indicated material in design pipe size is prohibited. Do not use materials other than those listed.

2-BED(2B) ADAPTABLE 114 P4.2

1 P4.2

PROJECT NUMBER	: 22062					
PROJECT NAME	: The Reserves	at Magno	olia, Denton, TX			
DATE	: 26-Jun-23					
FIXTURE TYPE	QUANTITY	TOTA	AL WATER FIXTURE UNITS			
Bathroom Group (Private FT)	100		360			
Dishwasher (Private)	61	85.4				
Drinking Fountain	1	0.25				
Ice Maker Connection Box	61	15.25				
Kitchen Sink (Private)	61	85.4				
Lavatory (Public)	2	4				
Service Sink	4	12				
Washing Machine(Private, 8lb.)	60	84				
Water Closet (Public, FT)	2		10			
	TOTAL F.U. =		657			
2021 IDC		VELOCITY	TOTAL FT GPM= 152			
2021 IPC		3.3 PSI	MIN. PIPE SIZE $=$ 3			

4 -0


OFFICE 108

1-BED(1B) ADAPTABLE 116

COMMUNITY ROOM 106

1-BED(1B) ADAPTABLE [118]

ICB \$ 3/4" LAV-A

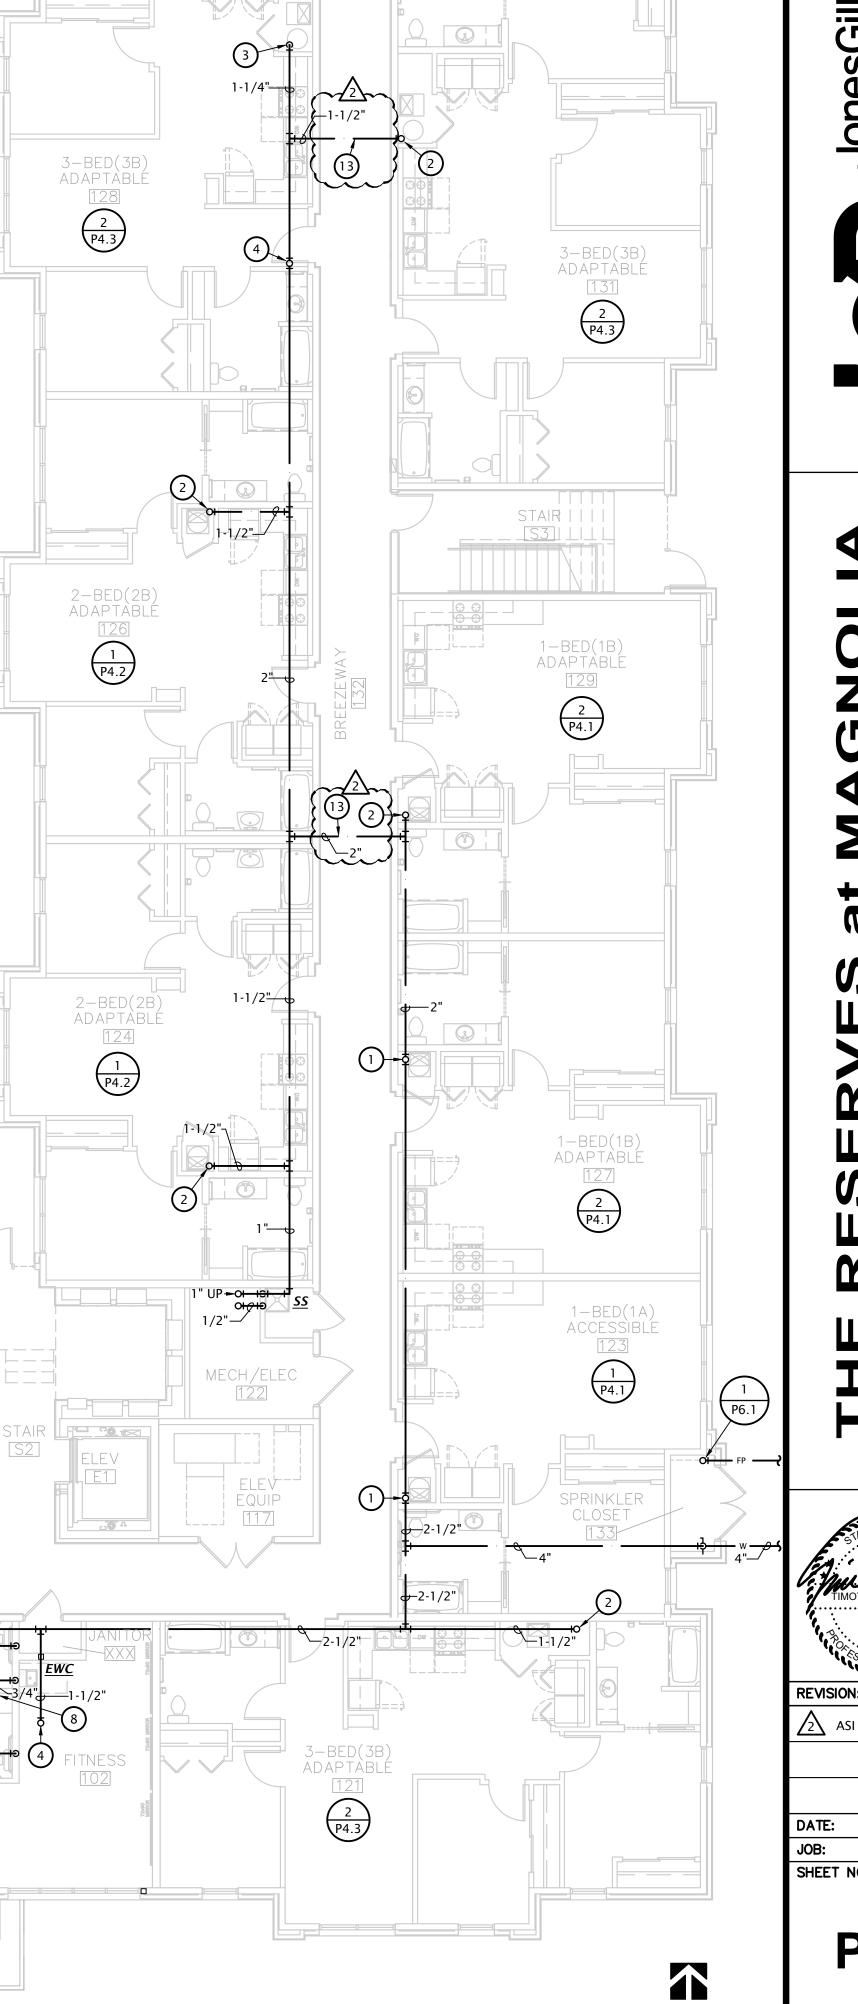

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May 2023

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ASI #1 07-22-2024

06-26-2023 21-3205 SHEET NO.:

P2.5

FIRST FLOOR PLAN -DOMESTIC WATER

1/8" = 1'-0"

- COORDINATE INSTALLATION OF PIPING IN MECHANICAL CLOSET W/ M.C. & E.C. • SEE PLUMBING FIXTURE SCHEDULE ON SHEET P6.1 FOR FIXTURE ROUGH-IN
- INFORMATION. ROUTE PIPING BELOW FLOOR FOR 4TH FLOOR APARTMENTS AND WHERE NOTED ON
- OVERALL PLAN. DO NOT ROUTE PIPING ABOVE CEILING IN UNCONDITIONED ATTIC/ PLENUM SPACES EXPOSED TO EXTERIOR.
- INSULATE ALL HW PIPING WITH MINIMUM R-3 INSULATION PER 2021 IECC R403.5.2.


REQUIREMENTS OF THE 2021 IECC. REFERENCE SPECIFICATIONS FOR COMMISSIONING REQUIREMENTS.

ENLARGED DOMESTIC WATER PLAN NOTES BY SYMBOL

- 1. SEE OVERALL DOMESTIC WATER PLANS FOR SIZING AND CONTINUATION.
- 2. PROVIDE 1-1/4" WATER SERVICE TO ALL TWO AND THREE BEDROOM APARTMENTS. PROVIDE INDIVIDUAL SHUT-OFF VALVE FOR EACH DWELLING UNIT.
- 3. PROVIDE 1" WATER SERVICE TO ONE BEDROOM APARTMENTS. PROVIDE INDIVIDUAL SHUT-OFF VALVE FOR EACH DWELLING UNIT.
- 4. CONNECT 1" CW AND HW TO WATER HEATER.
- PROVIDE FIELD FABRICATED 1" HW AND CW MANIFOLD WITH 1/2" PEX BRANCHES AND ROUTE 1/2"PEX BRANCHES TO EACH FIXTURE. MOUNT MANIFOLDS IN ACCESSIBLE LOCATION FIELD COORDINATE EXACT LOCATION OF MANIFOLD
- WITH G.C. AND OTHER TRADES. PROVIDE ACCESS PANEL IF MOUNTED IN WALL.


 6. ROUTE 1/2" PEX BRANCHES TO MANIFOLD. PROVIDE COPPER STUB-OUTS AT ROUGH-IN FOR EACH FIXTURE.
- 7. PROVIDE 1/2" VALVED BRANCH BELOW SINK AND CONNECT DISHWASHER. ROUTE PIPING ALONG BACK OF CABINETRY, COORDINATE EXACT ROUTING WITH G.C. COORDINATE EXACT REQUIREMENTS WITH DISHWASHER PROVIDED.

PROJECT SHALL COMPLY WITH ALL

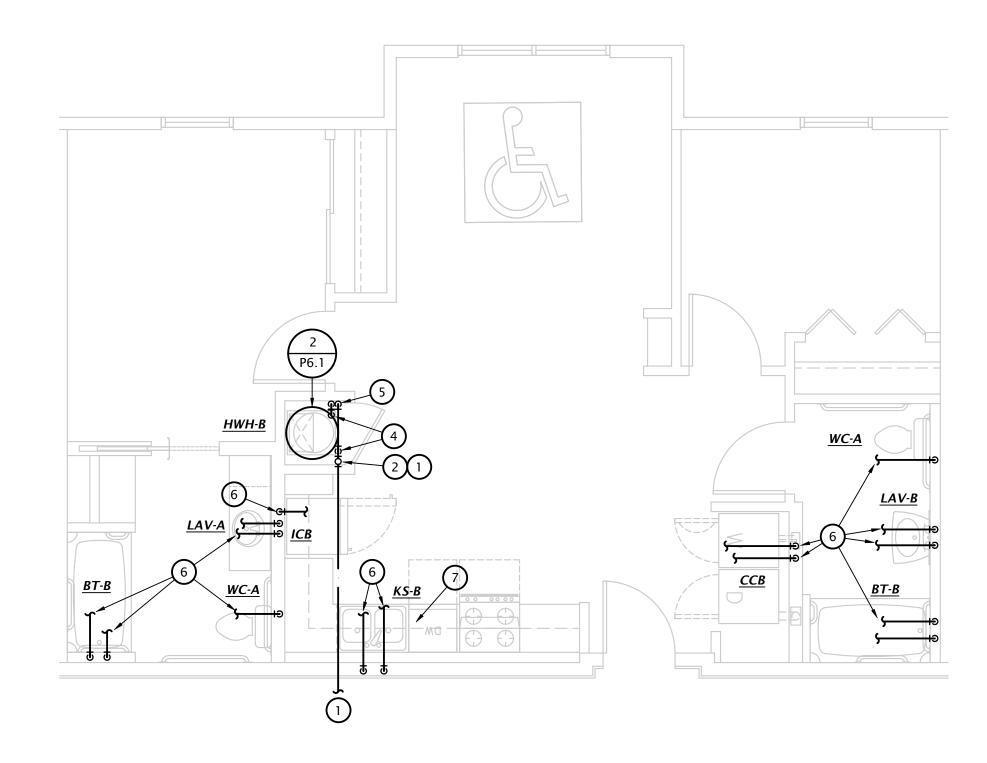


3 2 BEDROOM ACCESSIBLE DOMESTIC WATER PLAN (TYPE A)

1/4" = 1'-0"

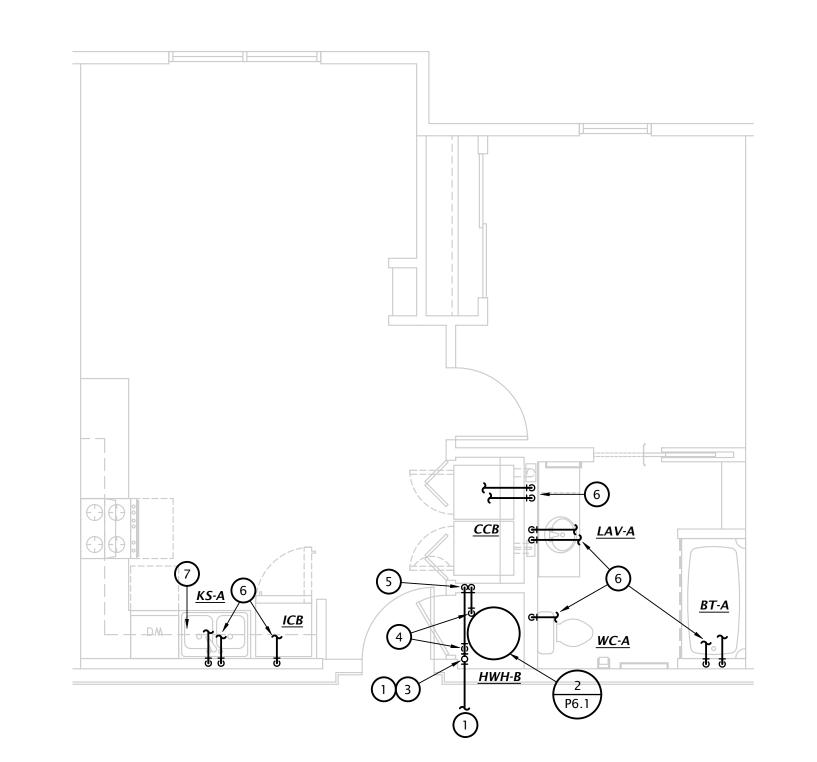

2 1 BEDROOM DOMESTIC WATER PLAN (TYPES B, AND C)

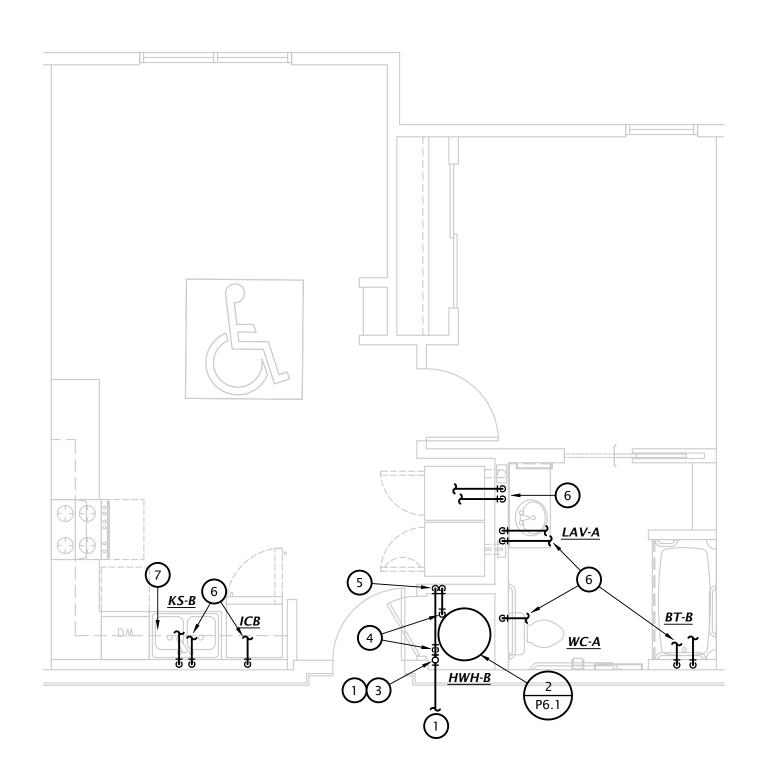


1 BEDROOM ACCESSIBLE DOMESTIC WATER PLAN (TYPE A)

1/4" = 1'-0"

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DATE: 06-26-2023 SHEET NO.:

P4.1

- COORDINATE INSTALLATION OF PIPING IN MECHANICAL CLOSET W/ M.C. & E.C.
- SEE PLUMBING FIXTURE SCHEDULE ON SHEET P6.1 FOR FIXTURE ROUGH-IN
- ROUTE PIPING BELOW FLOOR FOR 4TH FLOOR APARTMENTS AND WHERE NOTED ON OVERALL PLAN. DO NOT ROUTE PIPING ABOVE CEILING IN UNCONDITIONED ATTIC/ PLENUM SPACES EXPOSED TO EXTERIOR.
- INSULATE ALL HW PIPING WITH MINIMUM R-3 INSULATION PER 2021 IECC R403.5.2.

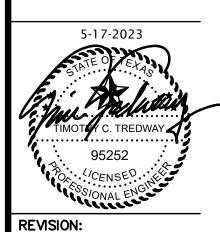
REQUIREMENTS OF THE 2021 IECC. COMMISSIONING REQUIREMENTS.

ENLARGED DOMESTIC WATER PLAN NOTES BY SYMBOL


- 1. SEE OVERALL DOMESTIC WATER PLANS FOR SIZING AND CONTINUATION.
- 2. PROVIDE 1-1/4" WATER SERVICE TO ALL TWO AND THREE BEDROOM APARTMENTS. PROVIDE INDIVIDUAL SHUT-OFF VALVE FOR EACH DWELLING UNIT.
- 3. PROVIDE 1" WATER SERVICE TO ONE BEDROOM APARTMENTS. PROVIDE INDIVIDUAL SHUT-OFF VALVE FOR EACH DWELLING UNIT.
- 4. CONNECT 1" CW AND HW TO WATER HEATER.
- 5. PROVIDE FIELD FABRICATED 1" HW AND CW MANIFOLD WITH 1/2" PEX BRANCHES AND ROUTE 1/2"PEX BRANCHES TO EACH FIXTURE. MOUNT MANIFOLDS IN ACCESSIBLE LOCATION FIELD COORDINATE EXACT LOCATION OF MANIFOLD
- WITH G.C. AND OTHER TRADES. PROVIDE ACCESS PANEL IF MOUNTED IN WALL.

 6. ROUTE 1/2" PEX BRANCHES TO MANIFOLD. PROVIDE COPPER STUB-OUTS AT ROUGH-IN FOR EACH FIXTURE.
- 7. PROVIDE 1/2" VALVED BRANCH BELOW SINK AND CONNECT DISHWASHER. ROUTE PIPING ALONG BACK OF CABINETRY, COORDINATE EXACT ROUTING WITH G.C. COORDINATE EXACT REQUIREMENTS WITH DISHWASHER PROVIDED.

PROJECT SHALL COMPLY WITH ALL REFERENCE SPECIFICATIONS FOR

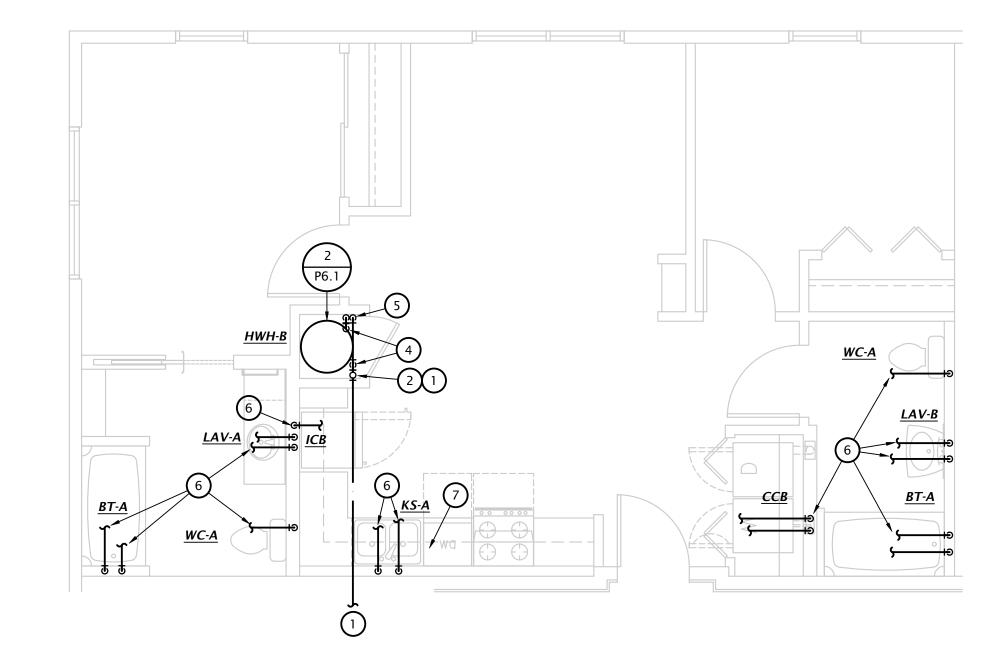


3 <u>2 BEDROOM DOMESTIC WATER PLAN (TYPE E)</u>
1/4" = 1'-0"

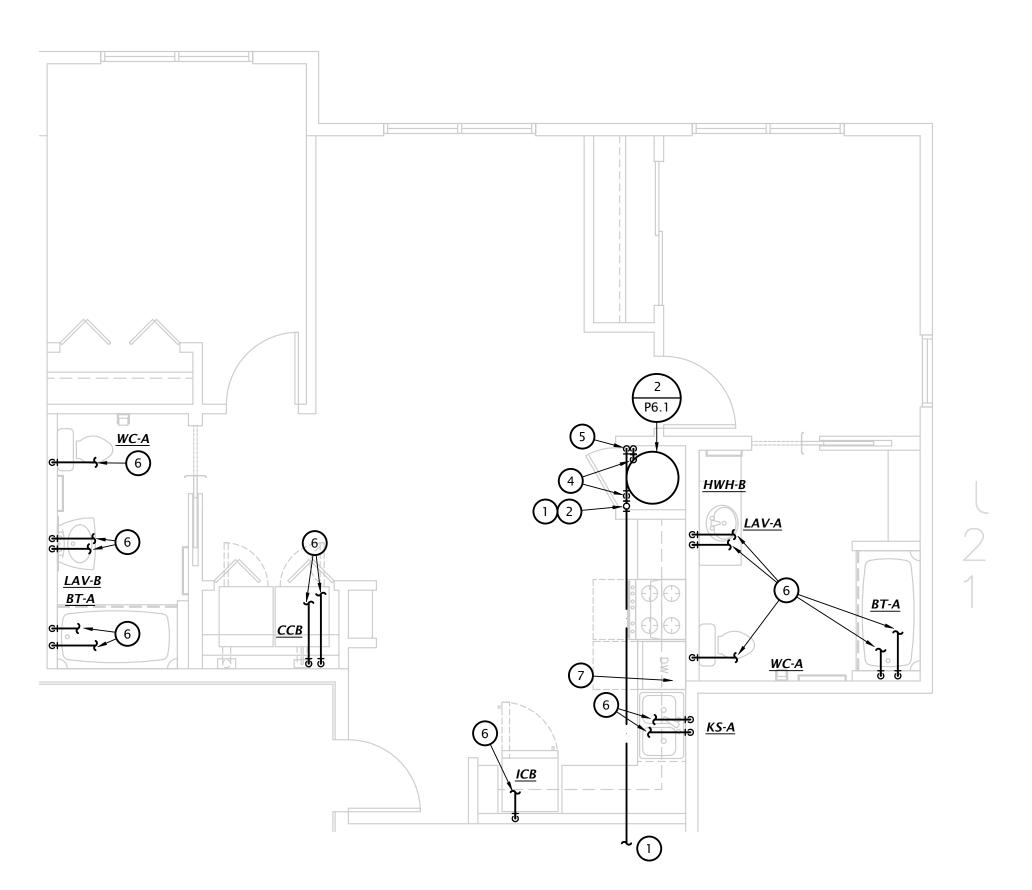

2 BEDROOM DOMESTIC WATER PLAN (TYPE D)

1/4" = 1'-0"

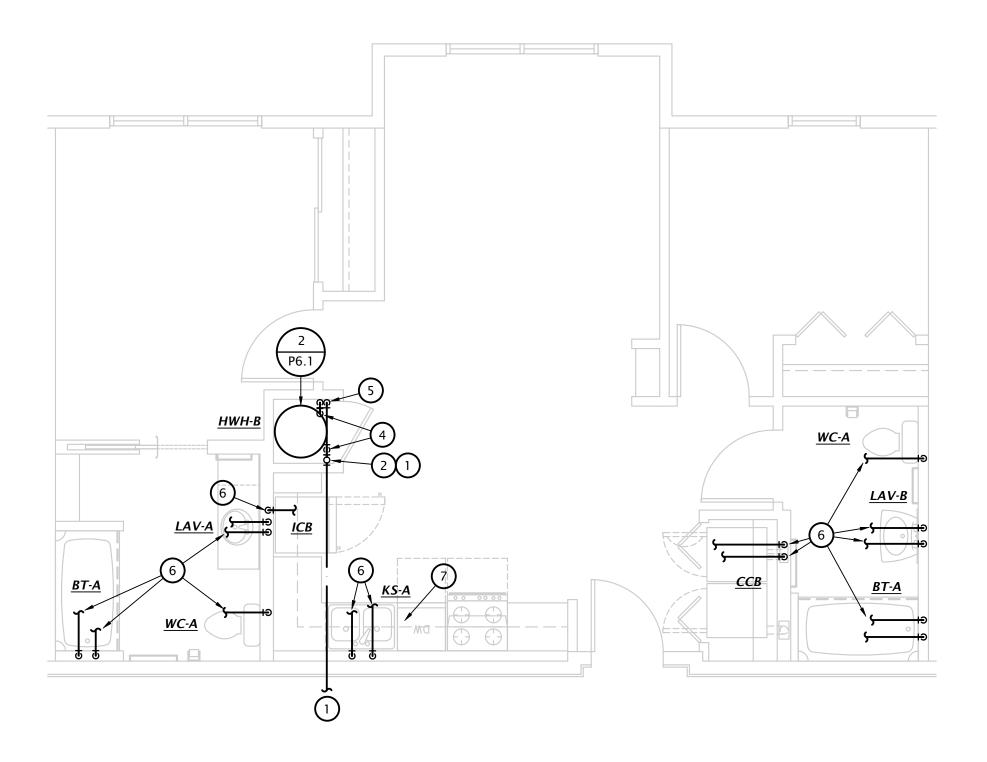

1 2 BEDROOM DOMESTIC WATER PLAN (TYPES B, AND C)

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06-26-2023

DATE: SHEET NO.:

P4.2


- COORDINATE INSTALLATION OF PIPING IN MECHANICAL CLOSET W/ M.C. & E.C.
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- ROUTE PIPING BELOW FLOOR FOR 4TH FLOOR APARTMENTS AND WHERE NOTED ON OVERALL PLAN. DO NOT ROUTE PIPING ABOVE CEILING IN UNCONDITIONED ATTIC/
- PLENUM SPACES EXPOSED TO EXTERIOR. INSULATE ALL HW PIPING WITH MINIMUM R-3 INSULATION PER 2021 IECC R403.5.2.

PROJECT SHALL COMPLY WITH ALL REQUIREMENTS OF THE 2021 IECC. REFERENCE SPECIFICATIONS FOR COMMISSIONING REQUIREMENTS.

ENLARGED DOMESTIC WATER PLAN NOTES BY SYMBOL

- 1. SEE OVERALL DOMESTIC WATER PLANS FOR SIZING AND CONTINUATION.
- 2. PROVIDE 1-1/4" WATER SERVICE TO ALL TWO AND THREE BEDROOM APARTMENTS. PROVIDE INDIVIDUAL SHUT-OFF VALVE FOR EACH DWELLING UNIT.
- 3. PROVIDE 1" WATER SERVICE TO ONE BEDROOM APARTMENTS. PROVIDE INDIVIDUAL SHUT-OFF VALVE FOR EACH DWELLING UNIT.
- 4. CONNECT 1" CW AND HW TO WATER HEATER.
- 5. PROVIDE FIELD FABRICATED 1" HW AND CW MANIFOLD WITH 1/2" PEX BRANCHES AND ROUTE 1/2"PEX BRANCHES TO EACH FIXTURE. MOUNT MANIFOLDS IN ACCESSIBLE LOCATION FIELD COORDINATE EXACT LOCATION OF MANIFOLD
- WITH G.C. AND OTHER TRADES. PROVIDE ACCESS PANEL IF MOUNTED IN WALL.


 6. ROUTE 1/2" PEX BRANCHES TO MANIFOLD. PROVIDE COPPER STUB-OUTS AT ROUGH-IN FOR EACH FIXTURE.
- 7. PROVIDE 1/2" VALVED BRANCH BELOW SINK AND CONNECT DISHWASHER. ROUTE PIPING ALONG BACK OF CABINETRY, COORDINATE EXACT ROUTING WITH G.C. COORDINATE EXACT REQUIREMENTS WITH DISHWASHER PROVIDED.

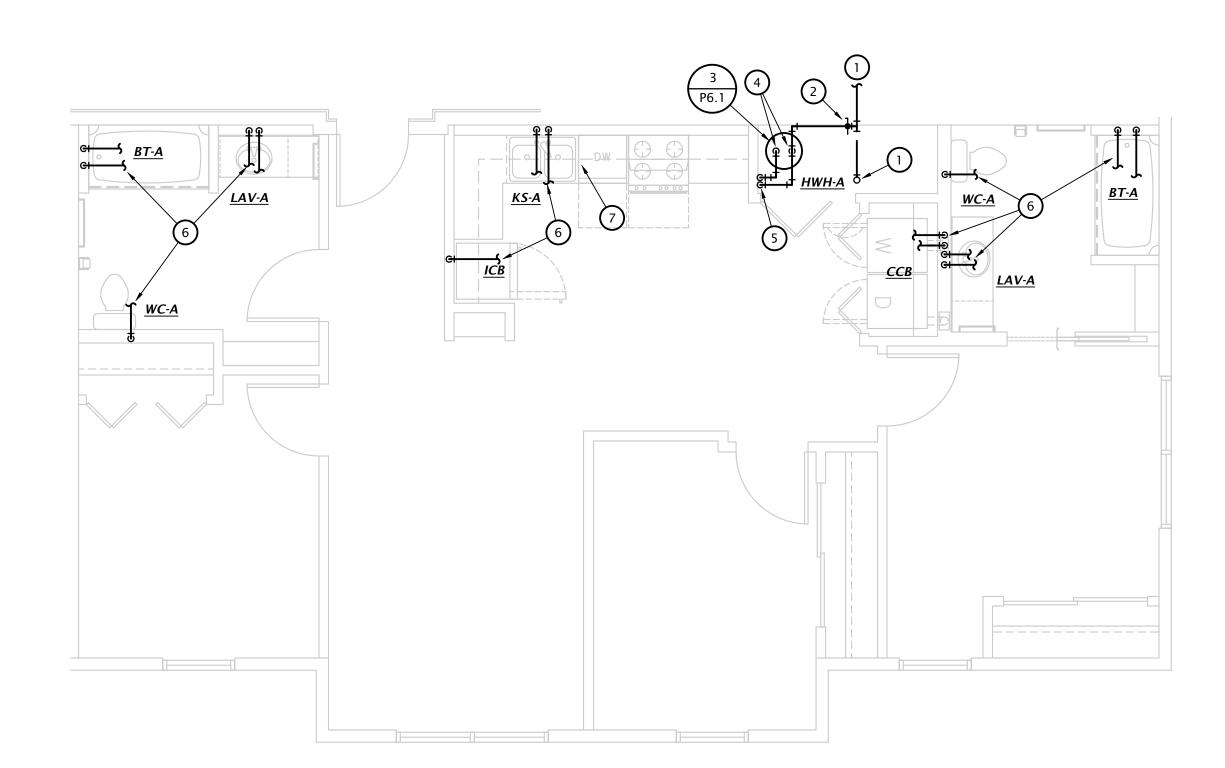

3 BEDROOM DOMESTIC WATER PLAN (TYPE B, AND E)


1/4" = 1'-0"



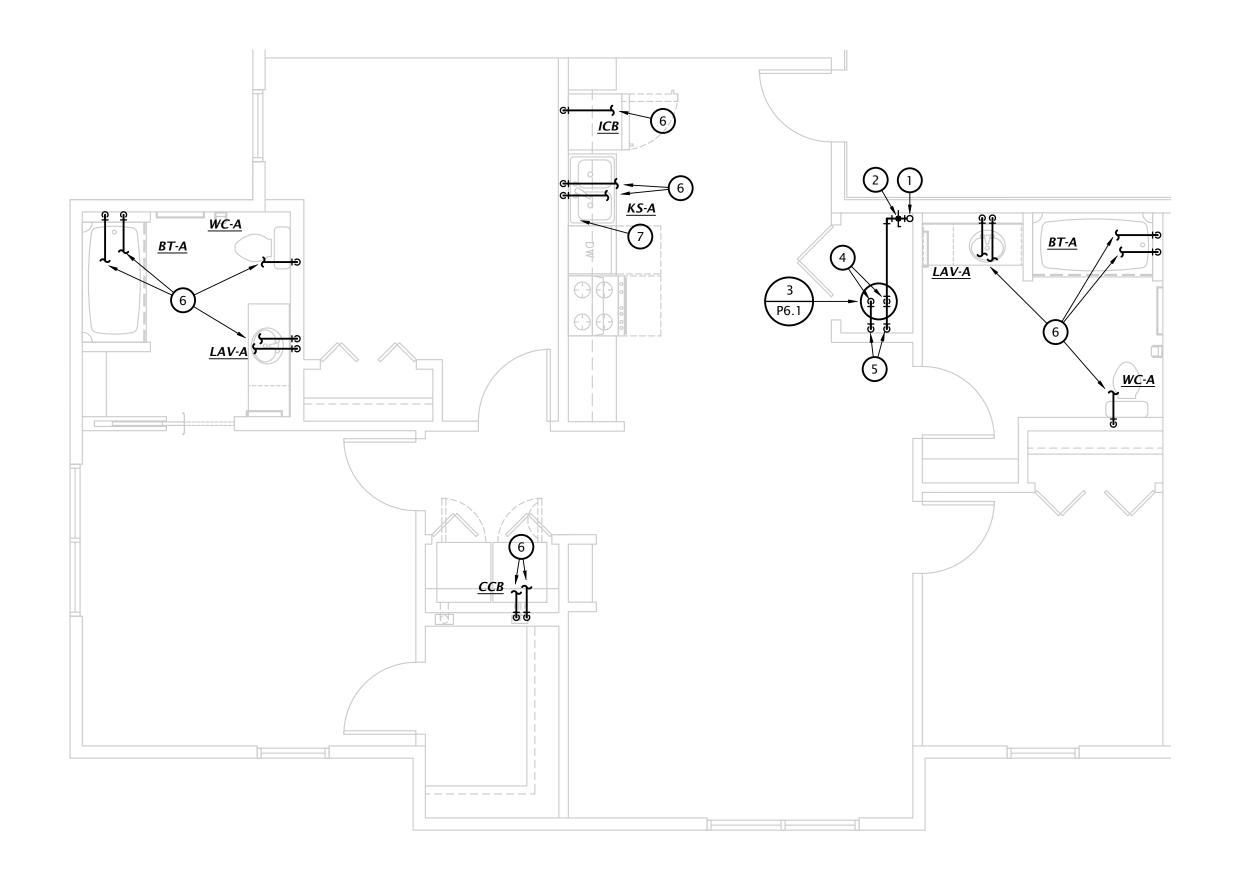

3 BEDROOM DOMESTIC WATER PLAN (TYPE D)

1/4" = 1'-0"

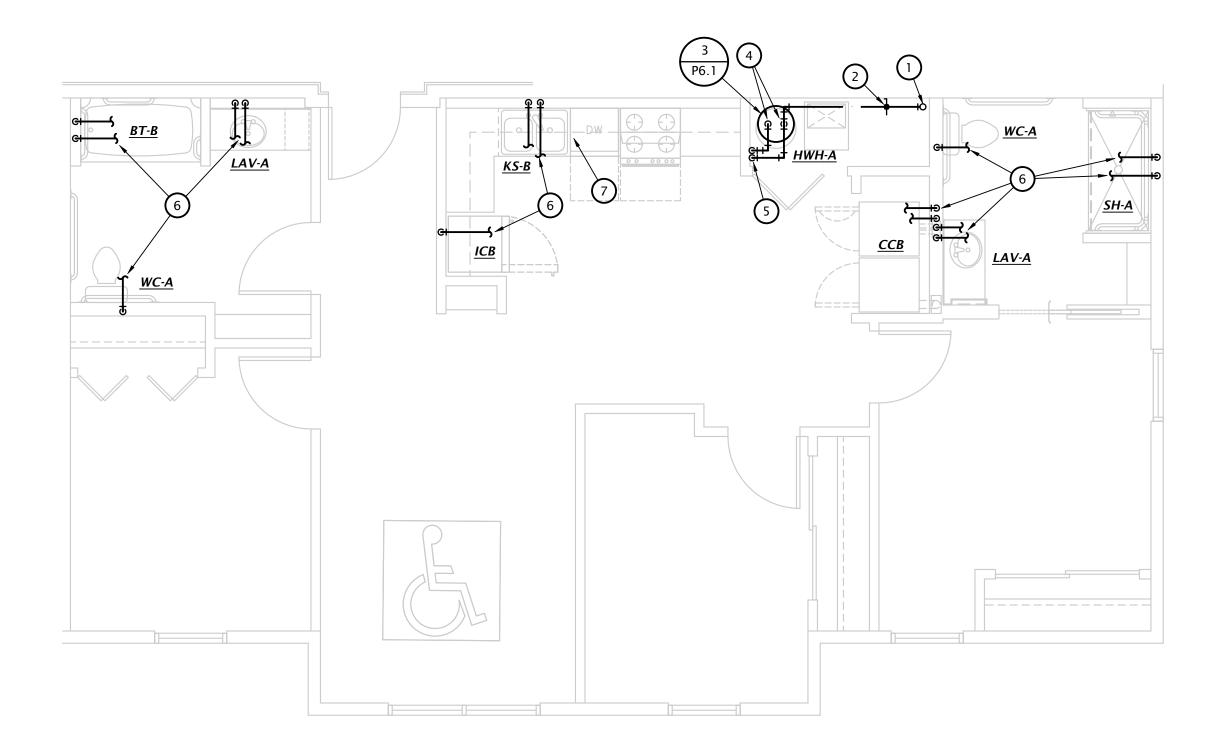

1 3 BEDROOM ACCESSIBLE DOMESTIC WATER PLAN (TYPE A)

06-26-2023 SHEET NO .:

P4.3





REVISION: ASI #1 07-22-2024

06-26-2023 DATE: 21-3205 SHEET NO .:

REFERENCE P4 SHEETS FOR EXACT FIXTURE TYPES

P5.2

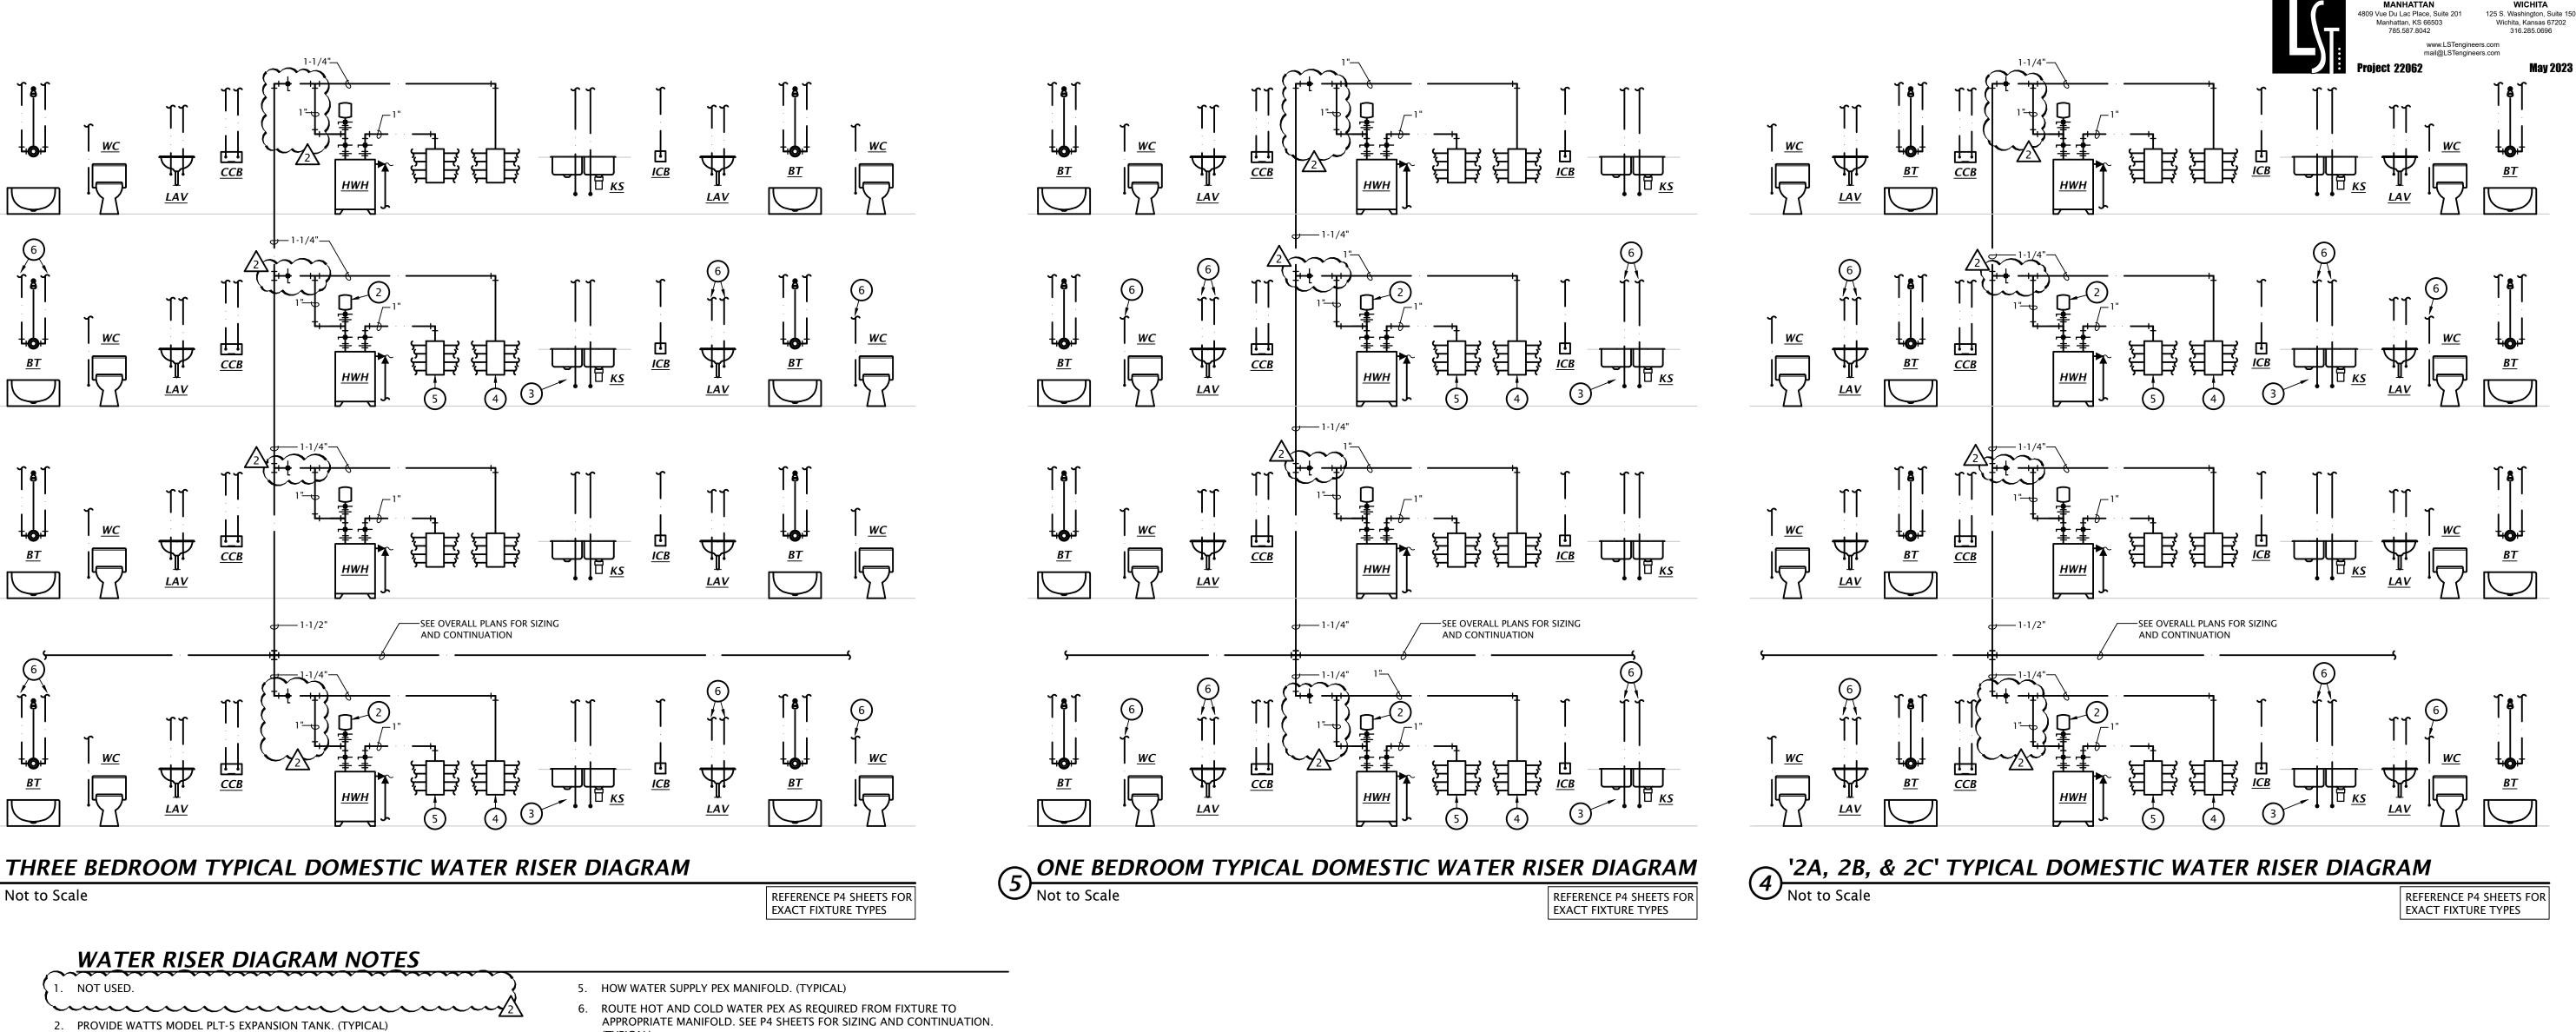

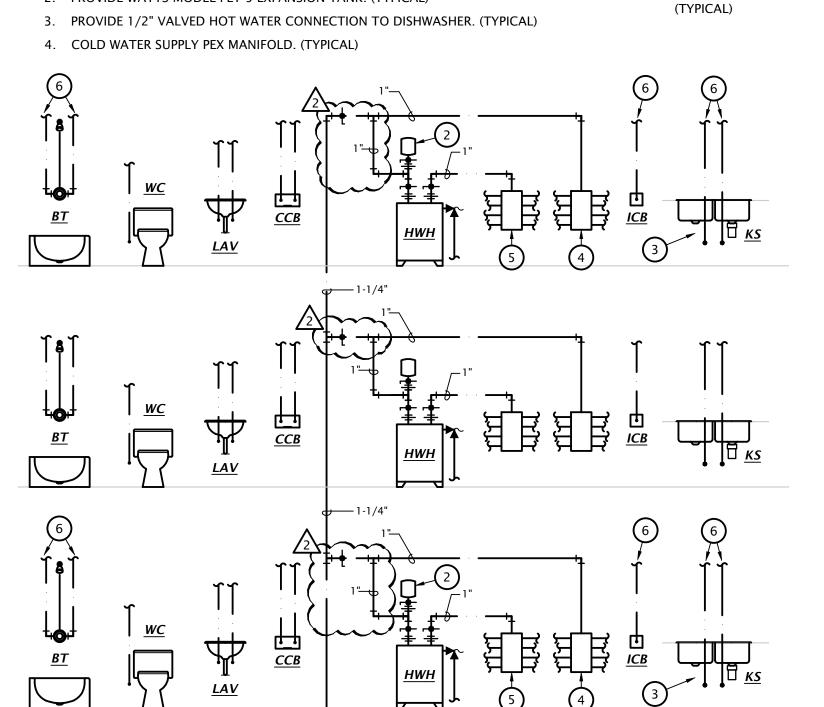


ALT. ONE BEDROOM DOMESTIC WATER RISER DIAGRAM


Not to Scale

REFERENCE P4 SHEETS FOR

SEE OVERALL PLANS FOR SIZING AND CONTINUATION

REFERENCE P4 SHEETS FOR EXACT FIXTURE TYPES

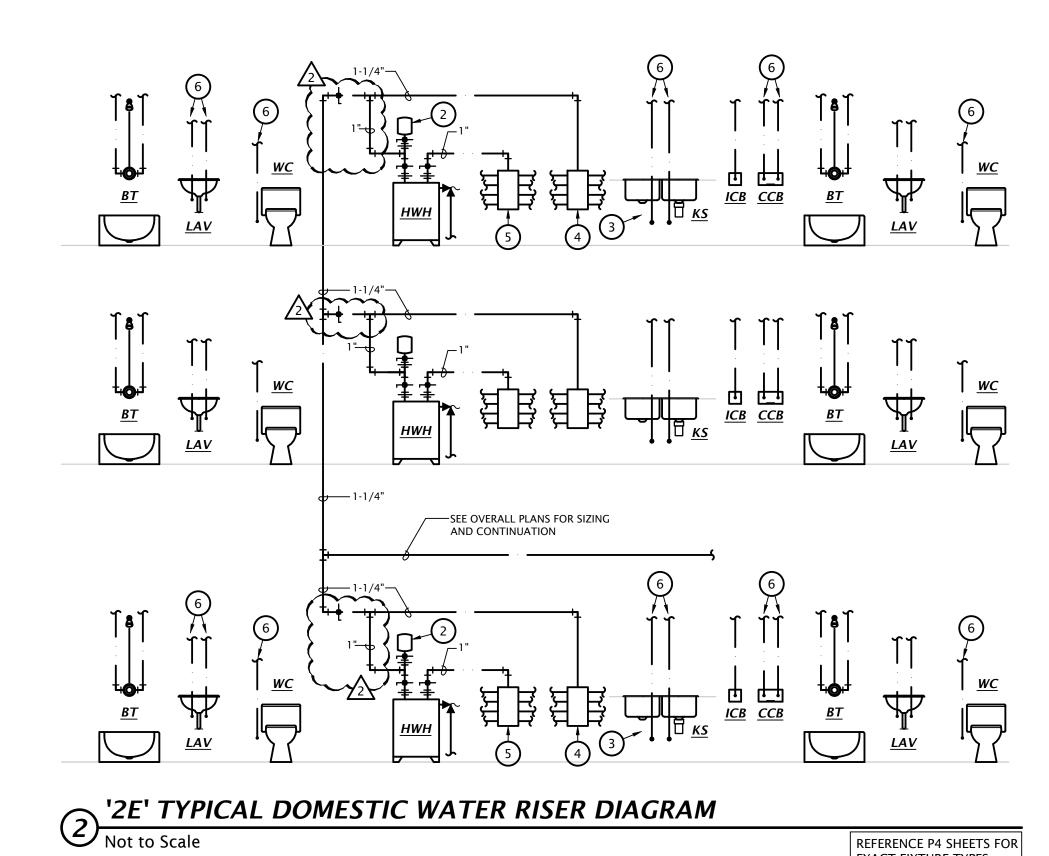

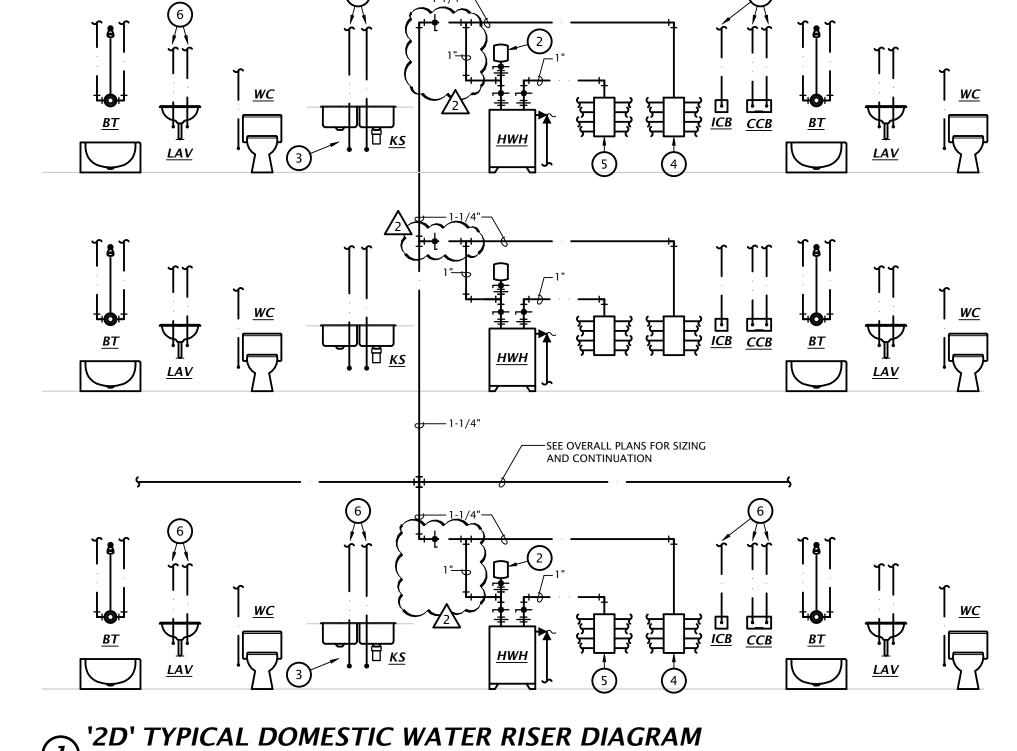

Not to Scale

REFERENCE P4 SHEETS FOR EXACT FIXTURE TYPES

REVISION:

ASI #1 07-22-2024

DATE: 06-26-2023 21–3205 O SHEET NO.:

P5.3

WATER RISER DIAGRAM NOTES

22. PROVIDE WATTS MODEL PLT-5 EXPANSION TANK. (TYPICAL)

3. PROVIDE 1/2" VALVED HOT WATER CONNECTION TO DISHWASHER. (TYPICAL)

5. HOW WATER SUPPLY PEX MANIFOLD. (TYPICAL) 6. ROUTE HOT AND COLD WATER PEX AS REQUIRED FROM FIXTURE TO APPROPRIATE MANIFOLD. SEE P4 SHEETS FOR SIZING AND CONTINUATION.

(TYPICAL)

4. COLD WATER SUPPLY PEX MANIFOLD. (TYPICAL)

SEE OVERALL PLANS FOR SIZING AND CONTINUATION LAV


ALT. THREE BEDROOM DOMESTIC WATER RISER DIAGRAM

Not to Scale

REFERENCE P4 SHEETS FOR EXACT FIXTURE TYPES

		G FIXTURE SCHEDULE				ROUGH-IN SIZES			
MARK	MANUFACTURER	DESCRIPTION	MANUFACTURER	DESCRIPTION	WASTE	VENT	CW	HW	NOTES
WC-A	KOHLER	Model #K-3658-(RA)-0 "Highline Classic" ADA compliant flush tank water closet, white vitreous china, two piece, 12" rough-in, elongated 16-1/2" high bowl, siphon jet flushing action, 1.28 GPF, polished chrome actuator. Coordinate location of trip lever with installation.	KOHLER	#K-4636-0 white, closed front plastic seat with slow closing lid.	4"	2"	1/2"		1
WC-B	KOHLER	Model #K-3658-(RA)-0 "Highline Classic" ADA compliant flush tank water closet, white vitreous china, two piece, 12" rough-in, elongated 16-1/2" high bowl, siphon jet flushing action, 1.28 GPF, polished chrome actuator. Coordinate location of trip lever with installation.	KOHLER	#K-4731-CA-0 white, open front, anti-microbial plastic seat without lid, with check hinge.	4"	2"	1/2"		1
LAV-A	KOHLER	Model 2196-4-0 self-rimming lavatory, white vitreous china, 20"W x 17", faucet holes on 4" centers.	KOHLER	#K-394-4-2 two handle faucet with pop-up drain and nickel finish.	2"	1-1/2"	1/2"	1/2"	1,2,3
LAV-B	KOHLER	Model 2005-0 wall hung lavatory, white vitrous china, 18-1/4"W x 17-1/4", faucet holes on 4" centers.	KOHLER	#K-394-4-2 two handle faucet with pop-up drain and nickel finish.	2"	1-1/2"	1/2"	1/2"	1,2,3
KS-A	KOHLER	Model K-3369-3 two compartment 18 GA stainless steel top-mount sink, 14-1/2"x16-1/2"x8"D inside, fully undercoated, faucet holes as required.	KOHLER INSINKERATOR	#K-780 single handle pull down kitchen sink faucet with chrome finish, single hole installation. Provide basket strainer. Badger 5 $\frac{1}{2}$ HP garbage disposal with	2"	1-1/2"	1/2"	1/2"	1,2,4
KS-B	JUST	Model DL-ADA-2233-A-GR two compartment 18 GA stainless steel sink, self rimming, 14"x16"x5"D inside, fully undercoated, faucet holes as required, and drain hole center rear.	KOHLER IN-SINK-ERATOR	dishwasher waste connection. #K-780 single handle pull down kitchen sink faucet with chrome finish, single hole installation. Provide basket strainer. Badger 5 $\frac{1}{2}$ HP garbage disposal with	2"	1-1/2"	1/2"	1/2"	1,2,4,5
SH-A	AQUARIUS	Model G-6233-BF75 reinforced fiberglass ADA roll-in shower, 60"W x33"D x73-3/4"H, with integral soap/toiletry shelves and grab bars in accordance with ADA requirements, fold-up seat, right or left hand rough-in as required, white finish. Provide with collapsible dam.	KOHLER	#K-304 pressure balancing valve with integral temperature limits and stops, #K-TS10584-4 valve trim, #K-355 wall supply elbow, #K-9514 60" hose, #K-22163-G hand shower, and #K-8524/K-349 slide bar. Entire assembly	2"	1-1/2"	1/2"	1/2"	1
BT-A	AQUARIUS	Model A 6000 TS OT 2P cast acrylic ADA tub/shower, 60"W x33-3/4"D x78"H, with integral soap/toiletry shelves in accordance with ADA requirements right or left hand rough-in as required, white finish. Provide with blocking for grab bars and seat to be added at tenant's request.	KOHLER	shall have nickel finish. Max. 2 GPM. #K-304 pressure balancing valve with integral temperature limits and stops, #K-TS10582-4 valve trim, #K-355 wall supply elbow, #K-9514 60" hose, #K-22163-G hand shower, and #K-8524/K-349 slide bar. Entire assembly shall have nickel finish. Max. 2 GPM.	2"	1-1/2"	1/2"	1/2"	2,4
BT-B	AQUARIUS	Model A 6000 TS OT 2P cast acrylic ADA tub/shower, 60"W x33-3/4"D x78"H, with integral soap/toiletry shelves and grab bars in accordance with ADA requirements, seat at end of tub, right or left hand rough-in as required, white finish.	KOHLER	#K-304 pressure balancing valve with integral temperature limits and stops, #K-TS10582-4 valve trim, #K-355 wall supply elbow, #K-9514 60" hose, #K-22163-G hand shower, and #K-8524/K-349 slide bar. Entire assembly shall have nickel finish. Max. 2 GPM.	2"	1-1/2"	1/2"	1/2"	1,2,4
SS	FIAT	Model MSB-2424 one piece molded stone mop basin, 24" square, stainless steel integral drain body with caulk connection, stainless steel wall guards.	DELTA	Model 28T9 faucet with hose thread outlet, vacuum breaker, pail hook, wall brace, metal lever handles.	3"	1-1/2"	3/4"	3/4"	4
WH	WOODFORD	Model 25 frost proof wall hydrant with anti-siphon	vacuum breaker, ı	metal handle.			3/4"		
RH	WOODFORD	Model RHY2-MS freezeless roof hydrant with vacuudraining. Provide with 1/8" tapping for drain.	m breaker, cast ire	on mounting system, and vent to allow			3/4"		
ССВ	WATER-TITE	SUPPLIED BY OTHERS			2"	2"	1/2"	1/2"	
ICB	OATEY	Model 3848X fire rated ice maker connection box v	with 1/4 turn ball v	alve.			1/2"		
FD	WADE	Model 1102STD5 floor drain with satin nickel bron Trapguard.	ze strainer. Provid	le trap protection device equal to ProSet	2"	1-1/2"			
FS	WADE	Model 9140 floor sink with 8" deep body, enamele openings as requried. Provide trap protection device			3"	1-1/2"			
EWC	MURDOCK	Model A172108F-UG ADA compliant dual height, s push bar actuator, and lead-free cooling system ca			2"	1-1/2"	1/2"		1
RD	WADE	Model 3000 cast iron side outlet body roof drain w	rith flange, flashing	g ring with gravel stop, unde deck clamp and	cast iron c	lome stra	iner.		
OD	WADE	Model 3000 cast iron side outlet body roof drain w	rith flange, flashing	g ring with gravel stop, unde deck clamp and	cast iron o	lome stra	iner.		
DN	ZURN	Model ZF199 black downspout nozzle with threade	ed outlet and flang	e to secure nozzle to wall.					
HWH-A	A.O. SMITH	Model ENT-40, 40 gallon electric water heater, (2) i Minimum 0.92 UEF. Supplied with temperature & p			iPH recove	ry @ 90°F	temp ri	se.	
HWH-B	A.O. SMITH	Model ENJ-40, 40 gallon electric water heater, (2) n Minimum 0.93 UEF. Supplied with temperature & p	on simultaneous 4	500 watts, 208 volts heating elements, 21 G	PH recover	y @ 90°F t	temp ris	e.	
HWH-C	A.O. SMITH	Model EJCS-20, 20 gallon electric water heater, 250 & pressure relief valve and brass drain valve.	00 watts, 208 volts	heating element, 11 GPH recovery @ 90°F ter	mp rise. Su	ipplied wi	th temp	erature	6
HWP	BELL & GOSSETT	Model NBF-33 circulation pump, bronze body, 10 C	GPM @ 10' head, 12	20 VAC. Provide clamp-on aquastat for pump	control.				7
ERAL: Provide fix	ktures with all trim n	ecessary for complete installation.						L	
		owerheads, and kitchen faucets shall have EPA's Wat	terSense label.						
ES:	non to the multi- C	ture and installation to mark assistance.	icane with Dissel We	ios Act. In apartments finance and the Unit		roguiss	onto - C		Oucine A
. Provide De	earborn supplies with	ture and installation to meet requirements of American stops and escutcheon plate, 1-1/4" cast brass or P	VC p-trap.	ies Act. iii apaitiiieiits, fixture and installatio	ni to meet	requirem	ents of	uie rair H	ousing Act
		g below lavatory. Utilize insulation kit equivalent to		oro.					
. Trim shall	be provided with po	lished chrome finish.							



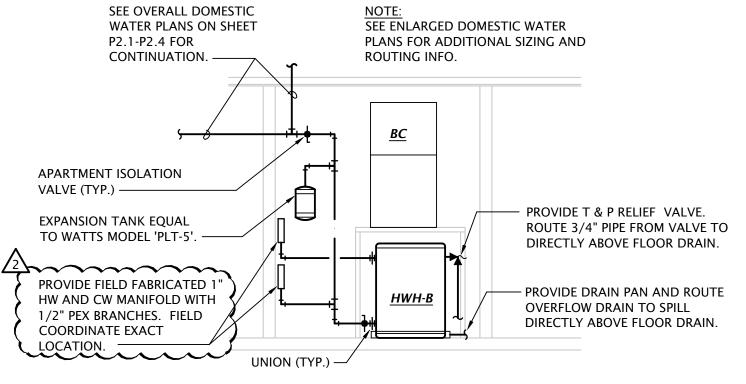

TO AUTOMATIC SPRINKLER SYSTEM WET HEADS.

CHECK VALVE.

∽ ANGLE VALVE

-----2" TEST/DRAIN

PROVIDE 4" LINE TO FIRE

DEPARTMENT CONNECTION.
COORDINATE LOCATION AND
SIZE WITH FIRE DEPARTMENT. –

PROVIDE BALL

DRIP AS REQUIRED.

APARTMENT WATER HEATER PIPING DIAGRAM


TO DRY HEADS

WATER FLOW DETECTOR.─


PRESSURE GAUGE WITH VALVE-

NO SCALE

FROM FIRE SPRINKLER

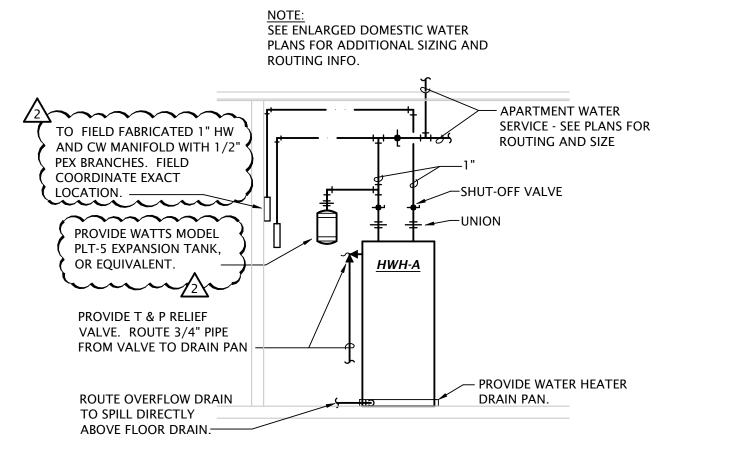

3 APARTMENT WATER HEATER PIPING DIAGRAM
NO SCALE

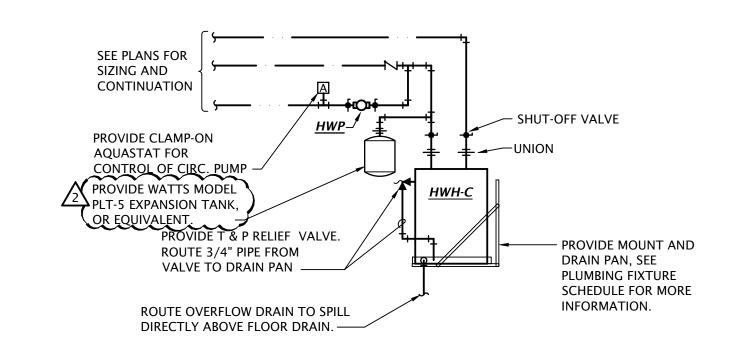

CLUBHOUSE WATER HEATER PIPING DIAGRAM

NO SCALE

CLOSET WALL

VERIFY LOCATION OF
BACKFLOW PREVENTER WITH
CITY AND CIVIL ENGINEER.

GROUND FLOOR

TAMPER SWITCH, TYP.


RACKFLOW PREVENTER, REFERENCE CIVIL

TAMPER SWITCH, TYP.

RACKFLOW PREVENTER, REFERENCE CIVIL

FIRE PROTECTION RISER DIAGRAM

NO SCALE

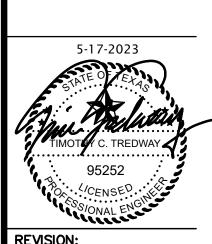

ASI #1 07-22-2024

 DATE:
 06-26-2023

 JOB:
 21-3205

 SHEET NO.:
 □

P6.1

at MAGNOLI

Jones GillamRe

2

	12, 113, , 231, 3						
116, 12	24, 126,		216, 21 3, 414,			, 316,	326, 3
1	18, 127,	218, 2	227, 31	17, 32	4, 416	5, 417,	424
121, 12	23, 219,	221, 2		8, 319 427	9, 323	, 327,	418, 4
			321,	, 421			
NOTES:							
1. Volta	ge drop	has be	en acc	ounte	d for i	n sizes	indica
2. Ensur	re panel	lugs a	re adec	quately	/ sizec	l to ha	ndle up
NOT	ES:			-ii*	hreak	ers sh	all be 6

• .					
а	Lighting & Receptacles	3 VA/SF	28279 SF	84,837	
C2	Required Circuits (220.84 (C)(2))			
	Laundry Circuit	1,500 VA/Circuit	32 Circuit	48,000	
	Kitchen Circuits	1,500 VA/Circuit	64 Circuit	96,000	
СЗ	Nameplate Ratings of Equipme	ent (220.84 (C)(3))			
	Microwave	1,000 VA/Circuit	32 ea	32,000	
a2	Dishwasher	840 VA/Circuit	32 ea	26,880	
a3	Disposal	1175 VA/Circuit	32 ea	37,600	
a4	Refrigerator	1200 VA/Circuit	32 ea	38,400	
b	Electric Range	8,000 VA/Circuit	32 ea	256,000	
С	Electric Clothes Dryer	5,000 VA/Circuit	32 ea	160,000	
C4	Nameplate Ratings of Motors	(220.84 (C)(4))			
	Blower Fan #1	956 VA/Circuit	12 ea	11,472	
	Blower Fan #2	956 VA/Circuit	8 ea	7,648	
	Blower Fan #3	900 VA/Circuit	12 ea	10,800	
C5	Larger of Heating and A/C load	d (220.84 (C)(5))			
	Electric Heat (5 kW)	3,900 VA/Circuit	12 ea	46,800	
	Electric Heat (8 kW)	5,200 VA/Circuit	8 ea	41,600	
	Electric Heat (9.6 kW)	6,900 VA/Circuit	12 ea	82,800	
		Conr	nected Load Total ⁼	980,837	
	С	Welling Unit Demand Load from	m Table 220.84 =	31%	304,059
		Meter Center NEC I	Demand Load (VA) Sub-Total	304,059
			Spare Capacity	10%	30,406
		Total Motor	Contor Domand	Load (\/\)=	224 465

Dwelling Unit Meter Center 'MCA' Load Calculation

Area: 28,279 SF (Dwelling Units Only)

C1 General Loads (220.84 (C)(1))

32 Dwelling Units

Feeder & Service Loads per NEC 220.84 Part IV

Total Meter Center Demand Load (VA) 334,465 Total Meter Center Demand Load (Amperes) @ 208Y/120V-3Ph, 4W 929 **Provide 1000A Meter Center**

Connected Demand Load (VA) Load (VA)

	ge drop has been accounted for in sizes indicated, further up-sizing of feeders is not necessary re panel lugs are adequately sized to handle up-sized feeders.
NO	
•	Meter Center main circuit breakers shall be 65 kAIC fully rated.
	Feeder breakers may be series rated with main breaker for a 65 kAIC rating.
•	All conductor sizes are based on copper, U.N.O.
•	Entire installation shall comply with NEC.
•	Coordinate all responsibilities and requirements with power utility
	company and pay associated fees. Contact Information:
	Denton Municipal Electric
	Daniel Howington
	Line Designer
	(940) 349-7168
	daniel.howington@cityofdenton.com
•	Coordinate final location of meter assemblies with utility company.
	Provide shop drawings of proposed equipment whether as specified or substituted to utility company for approval.
•	All meter center components shall be NEMA 3R.
•	All dimensions based on Square D equipment. It is the contractor's
	responsibility to verify the dimensions of substitute equipment.
•	For each meter, provide a permanent brass, copper or aluminum tag
	identifying the apartment served. Tags shall be securely fastened to
	the meter base and be stamped with 1/8" letters, minimum.

APARTMENT FEEDER SCHEDULE

Feeder Size

COPPER (BASE BID): (3)#3, #6G IN 1-1/4" C OR MC-CABLE ALUMINUM (ALTERNATE BID): (3)#1, #4G IN 1-1/4" C OR SER CABLE COPPER (BASE BID):

(3)#2, #6G IN 1-1/4" C OR MC-CABLE / (3)#1/0, #4G IN 1-1/4" C OR SER CABLE COPPER (BASE BID):

(3)#1, #4G IN 1-1/4" C OR MC-CABLE / (3)#2/0, #2G IN 1-1/2" C OR SER CABLE COPPER (BASE BID):


(3)#1/0, #3G IN 1-1/2" C OR MC-CABLE ALUMINUM (ALTERNATE BID): 2 (3)#3/0, #1G IN 2" C OR SER CABLE

COPPER (BASE BID):

(3)#2/0, #2G IN 1-1/2" C OR MC-CABLE ALUMINUM (ALTERNATE BID):

(3)#4/0, #1G IN 2" C OR SER CABLE


Apartment #

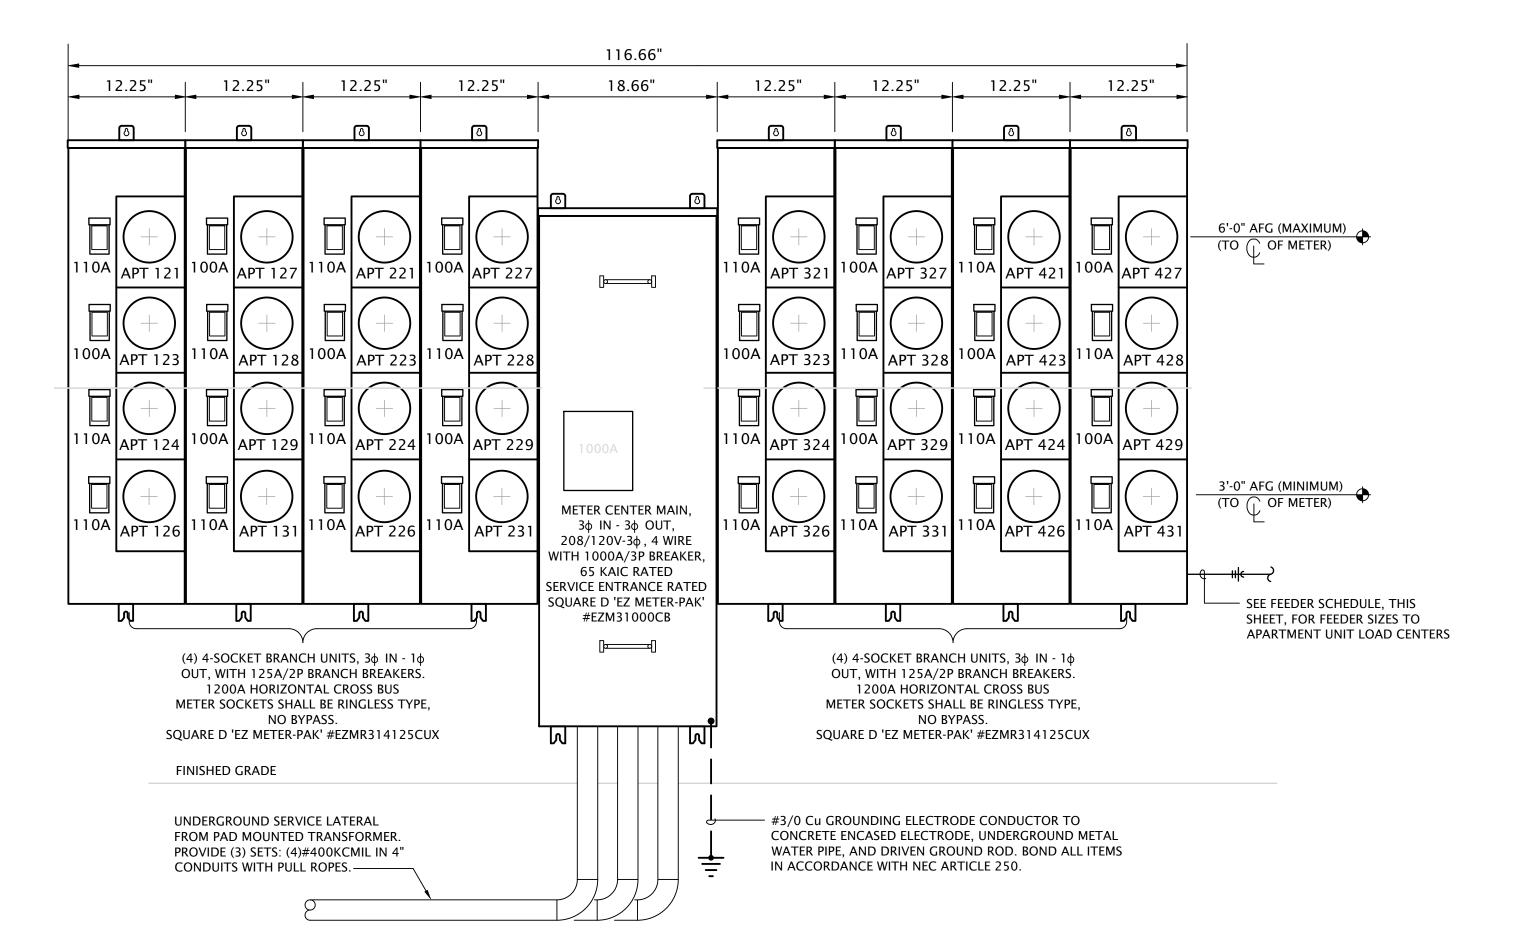

ELECTRICAL RISER DIAGRAM 'MCA'
No Scale



Area:	25,097 SF (Dwelling Units On 28 Dwelling Units	ly)		Connected Load (VA)	
eede	er & Service Loads per NEC 220	.84 Part IV			,
C1	General Loads (220.84 (C)(1))				
а	Lighting & Receptacles	3 VA/SF	25097 SF	75,291	
C2	Required Circuits (220.84 (C)(2))				
	Laundry Circuit	1,500 VA/Circuit	28 Circuit	42,000	
	Kitchen Circuits	1,500 VA/Circuit	56 Circuit	84,000	
СЗ	Nameplate Ratings of Equipment	(220.84 (C)(3))			
	Microwave	1,000 VA/Circuit	28 ea	28,000	
a2	Dishwasher	840 VA/Circuit	28 ea	23,520	
а3	Disposal	1175 VA/Circuit	28 ea	32,900	
	Refrigerator	1200 VA/Circuit	28 ea	33,600	
	Electric Range	8,000 VA/Circuit	28 ea	224,000	
С	Electric Clothes Dryer	5,000 VA/Circuit	28 ea	140,000	
C4	Nameplate Ratings of Motors (22)	0.84 (C)(4))			
	Blower Fan #1	956 VA/Circuit	8 ea	7,648	
	Blower Fan #2	956 VA/Circuit	18 ea	17,208	
	Blower Fan #3	900 VA/Circuit	4 ea	3,600	
C5	Larger of Heating and A/C load (2	20.84 (C)(5))			
	Electric Heat (5 kW)	3,900 VA/Circuit	8 ea	31,200	
	Electric Heat (8 kW)	5,200 VA/Circuit	18 ea	93,600	
	Electric Heat (9.6 kW)	6,900 VA/Circuit	4 ea	27,600	
		Conne	ected Load Total	864,167	•
	Dwe	lling Unit Demand Load from	n Table 220.84 =	33%	285,175
		Meter Center NEC D	emand Load (V	A) Sub-Total	285,175
			Spare Capacity	10%	28,518
		Total Meter (Center Demand	l Load (VA)	313,693
	Total Meter Cer	iter Demand Load (Ampe	res) @ 208Y/120	0V-3Ph. 4W	871

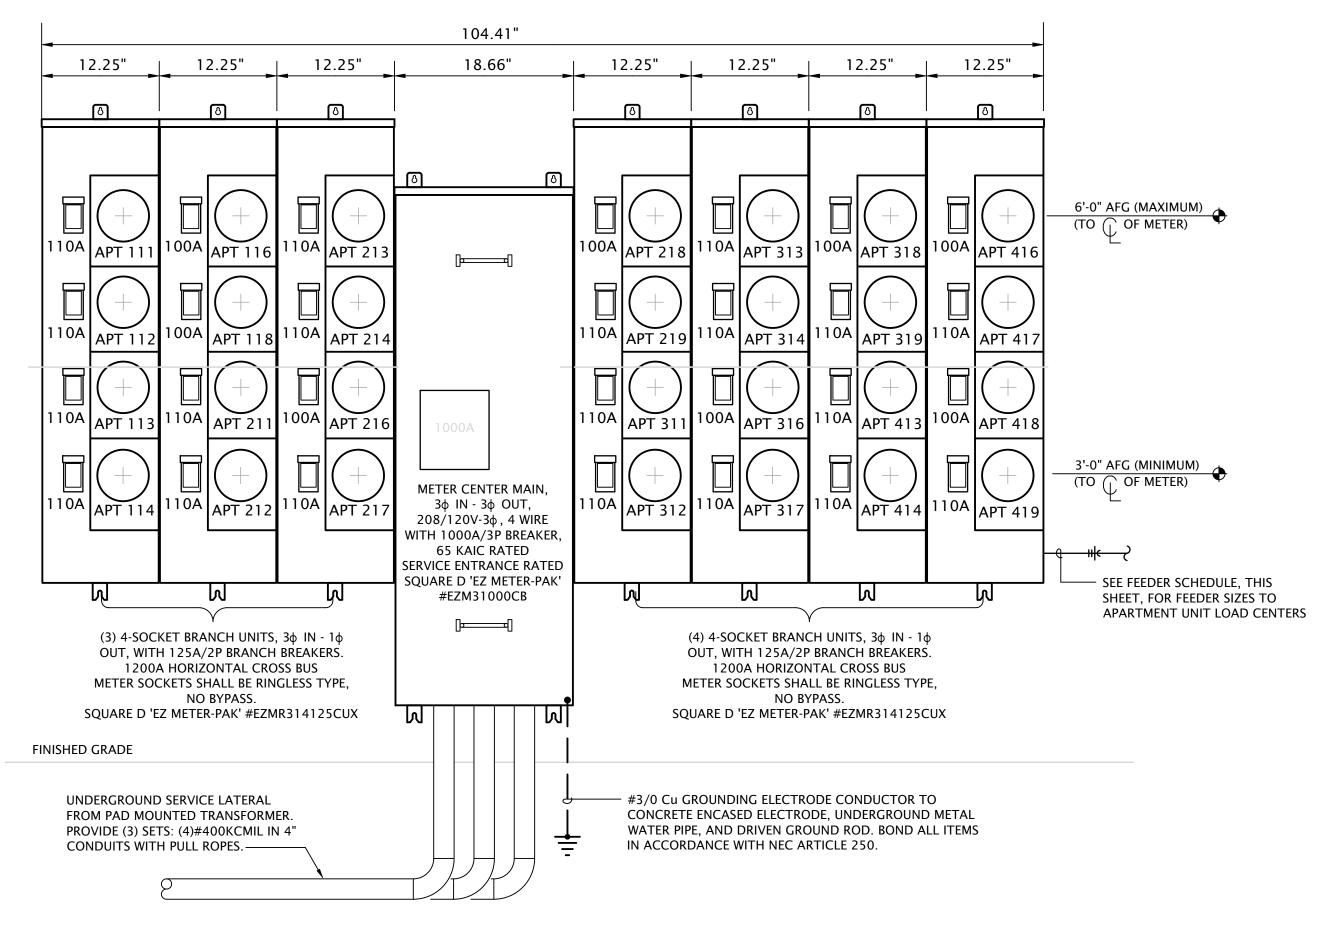

1 ELECTRICAL RISER DIAGRAM 'MCB' No Scale

sGillamR

5-17-2023 95252

REVISION: ASI #1 07-22-2024

DATE: 06-26-2023 21-3205 SHEET NO .:

E6.2