# ROSSVILLE FAMILY DENTAL


443 MAIN ST

22-3211

ROSSVILLE,

**KANSAS** 

# REFERENCE LEGEND

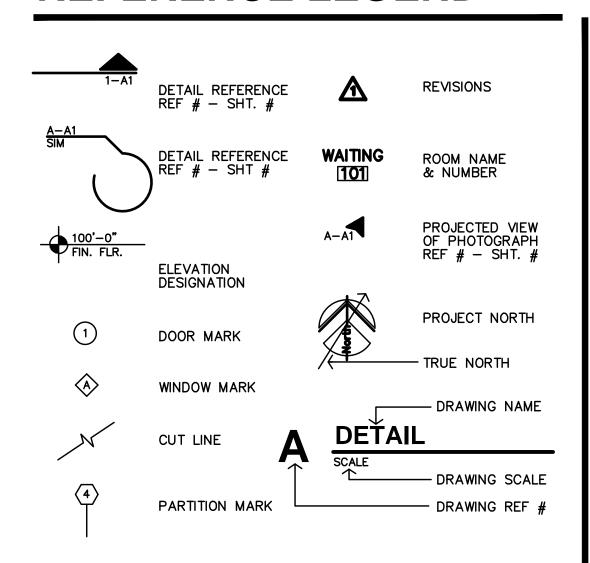

# MATERIAL LEGEND

	BATT INSULATION		PLYWOOD
	BRICK MASONRY	6	ROUGH WOOD
	COMPACTED EARTH		FINISH WOOD
	RIGID INSULATION		METAL STUD
	POURED CONCRETE		GLASS LARGE SCALE
	WALL W/ BRICK VENEER	l][	STRUCTURAL STEEL
(XXXXXXXXX)	METAL STUD WALL		CONC. MASONRY UNIT SECTION
Tempolymological Section	CONCRETE WALL		MTL JOIST
	WOOD STUD WALL	<b></b>	MTL FURRING
(1) / II   I   I   I   I   I   I   I   I	C.M.U. WALL	2···O ( •O )	PRECAST CONC. SLAB









# JonesGillamRenz

730 N. Ninth St. 1881 Main Street, Suite 301 Salina, KS 67401 Kansas City, MO 64108 785.827.0386 jgr@jgrarchitects.com

# **ABBREVIATIONS**

&√@⊌¢#	AND Angle At Centerline Diameter or Round Pound or Number	Cnt Col. Con C.T. CMI Ctr.
Adj. A.F.F. Aggr. Al. Approx. Arch. Asb.	Acoustical Adjustable Above Finished Floor Aggregate Aluminum Approximate Architect or Architectural Asbestos Asphalt Audio Visual	Dbl. Det Dia. Dim. Dr. Ds. Dwr
Bd. m. Bitdg. Blk, g. Bot. Bot. Brg. Brk.	Board Bituminous Building Block Blocking Beam Bottom BY OWNER Bearing Brick	(E.G.J ee g.g.w.) E.G.J ee g.g.w.
Cab. Clg. Clr.	Cabinet Ceiling Clear	E. W Exis Exp

Counter Column Conc. Concrete Ceramic Tile Concrete Masonry Unit Center Double
Detail
Drinking Fountain
Diameter
Dimension
Down
Door
Downspout
Drawing
Drawer Existing
East or Existing
Each
Expansion Joint
Elevation
Electrical
Elevator
Equal

Fire Alarm
Floor Drain
Foundation
Fire Extinguisher
F.E. Cabinet Finish
Floor
Flashing
Flow line
Foot or feet
Footing
Furring
Future Gauge Galvanized Grab Bar Glass Ground Grade Gypsum

Hose Bibb Hollow Core Hardwood Hardware Hollow Metal Horizontal

Janitor Joint Lavatory Locker Light Mas. Max. M.C. Mech. Memb. Met. Mfr. Mh. Masonry Maximum Medicine Cabinet Mechanical Membrane Metal Manufacturer Manhole Minimum Mirror Miscellaneous Masonry Opening Mounted

Hr. Hgt.

I.D. Insul. Int.

Hour Height

Inside Diameter Insulation

N. North
N.I.C. Not In Contract
No. or #Number
Nom. Nominal
N.T.S. Not To Scale P.Lam. Plas. Plywd. Pr. Pt. P.T.D. Ptn. P.T.R.

Obscure On Center Diameter Office Opening Opposite Paint
Plate
Plastic Laminate
Plaster
Plywood
Pair
Point
Paper Towel Dispenser
Partition
Paper Towel Receptacle Quarry Tile Riser Radius Roof Drain Reference

Reinf. Req'd Resil. Rm. R.O. Reinforced Required Resilient South
Splash Block
Solid Core
Schedule
Soap Dispenser
Section
Shower
Sheet
Similar
Sanitary Napkin Disp.
Sanitary Napkin Recep.
Specification
Square
Stainless Steel
Standard
Steel
Storage Texture Towel Bar Tack Board

Tempered
Tongue & Groove
Thick
Top Of Masonry
Top Of Steel
Top Of Pavement
Toilet Paper Dispenser
Television Temp.
T.&G.
Thk.
T.O.M.
T.O.S.
T.P.
T.P.D.
T.V.
T.W.
Typ.
Trd. U.O.N. Ur. Unless Otherwise Noted Urinal V.C.T. V.T. V.B. Vert. Vest. Vyl. Vinyl Composition Tile Vinyl Tile Vapor Barrier Vertical Vestibule W. w/o W.C. Wd. Wp. Wdw. Wsct. Wt. West With Without Wall Covering Wood Waterproof Window Wainscot Weight

# **SHEET INDEX**

# **GENERAL**

CFP CODE FOOTPRINT ADA ADA DIAGRAMS

**ARCHITECTURAL** D1.1 DEMO SITE PLAN D2.1 DEMO FLOOR PLAN

D2.2 PHOTOS D3.1 DEMO ELEVATIONS

# **ARCHITECTURAL**

A1.1 SITE PLAN A2.1 FLOOR PLAN

A2.2 FINISH FLOOR PLAN A3.1 EXTERIOR ELEVATIONS A3.2 EXTERIOR ELEVATIONS

A3.3 BUILDING SECTION A4.1 WALL SECTIONS

A4.2 WALL SECTIONS

A4.3 WALL SECTIONS A5.1 ROOF PLAN

A7.1 REFLECTED CEILING PLAN A8.1 INTERIOR ELEVATIONS

A9.1 INTERIOR ELEVATIONS

A9.4 CASEWORK ELEVATIONS

A9.5 CASEWORK SECTIONS

A10.1 FINISH & DOOR SCHEDULES & DETAILS

# **STRUCTURAL**

SO.1 GENERAL NOTES & DETAILS

S2.1 FOUNDATION PLAN S2.2 FRAMING PLAN

# **MECHANICAL**

ME1.1 M/E DEMO PLAN M1.1 MECHANICAL PLAN

M1.2 WASTE & VENT PLAN

M1.3 DOMESTIC WATER, GAS & COMPRESSED AIR PLAN M6.1 SCHEDULES & DETAILS

# **ELECTRICAL**

E1.1 LIGHTING PLAN E1.2 POWER PLAN

E1.3 SPECIAL SYSTEMS PLAN E6.1 SCHEDULES

# **DENTAL EQUIPMENT**

8 SHEETS

# **ALTERNATES**

ALT 1	REMOVE FIREPLACE COMPLETELY
ALT 2	NEW CONCRETE PARKING
ALT 3	REMOVE EXISTING DRIVE-THRU CANOPY, COLUMNS & ISLAND
ALT 4	REMOVE BUILT UP FREEZE TRIM & INSTALL NEW EFIS TRIM
ALT 5	STERILIZATION CABINETRY AT ROOM 115

# **CONSULTANTS**

# Mechanical & Electrical Engineer;



# **LST Consulting Engineers, PA**

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# Structural Engineer;



4338 Belleview Kansas City, MO 64111 816.531.4144; FAX 816.531.8572 info@bdc-engrs.com

# PROJECT INFORMATION

TYPE OF CONSTRUCTION NEW CONSTRUCTION SPROUT HOUSE LEARNING CENTER FACILITY/OWNER NAME FACILITY/OWNER ADDRESS 1111 WELLS FARGO ROAD LINDSBORG, KS 67456

REASON FOR SUBMITTAL NEW CONSTRUCTION COUNTY McPHERSON FIRE DEPARTMENT CITY OF LINDSBORG WATER SUPPLY CITY OF LINDSBORG CITY OF LINDSBORG BUILDING INSPECTION DEPT AUTHORITY HAVING JURISDICTION CITY OF LINDSBORG

ARCHITECT JONES GILLAM RENZ ARCHITECTS 730 N. NINTH ST.

SALINA, KS 67401 ph: 785-827-0386 fax: 785-827-0392

# CODES/REGULATIONS

2018 INTERNATIONAL BUILDING CODE 2010 ADA STANDARDS for ACCESSIBLE DESIGN 2018 INTERNATIONAL MECHANICAL CODE KANSAS FIRE PREVENTION CODE 2018 INTERNATIONAL PLUMBING CODE

NFPA 13 - AUTOMATIC SPRINKLER SYSTEMS 2017 NATIONAL ELECTRIC CODE NFPA 72 - FIRE ALARM SYSTEMS

> NOTE: WHERE LOCALLY ADOPTED CODE (2015 IBC) AND KSFMO ADOPTED CODE CONFLICT, PLEASE NOTE THAT THE MOST RESTRICTIVE CODE SHALL TAKE PRECEDENT

# **LEGEND**

FIRE EXTINGUISHER

68"/24.4"—EXIT WIDTH (ACTUAL/REQUIRED) EMERGENCY EXIT 122/340 — OCCUPANT LOAD (ACTUAL/ALLOWED)

2018 INTERNATIONAL FIRE CODE

O HOUR CONSTRUCTION FIRE HYDRANT (PROPOSED & EXISTING) EMERGENCY LIGHT EMERGENCY/EXIT LIGHT FIRE ALARM CONTROL PANEL FIRE ALARM ANNUNCIATOR PANEL EXIT LIGHT FAAP

•FE FIRE DEPARTMENT CONNECTION

OCCUPANCY GROUP (AU - ACCESSORY USE) OCCUPANCY USE ROOM SQUARE FOOTAGE/OCCUPANT LOAD FACTOR

OCCUPANT LOAD/REQUIRED NUMBER OF EXITS

TREATMENT 145 | 100

ACTUAL STORIES:

—√FDC

# **CODE INFORMATION**

OCCUPANCY OVERALL: CONSTRUCTION TYPE: DENTAL V-B OCCUPANCY BASE ALLOWABLE AREA: B 9,500 SF ALLOWABLE AREA: (NON-SEPARATED USES. ACTUAL BUILDING AREA: 5,608 SF PER IBC SECTION 508.3) 9,000 SF BASE ALLOWABLE FRONTAGE INCREASE (50%) 4,500 SF SPRINKLER INCREASE ALLOWABLE AREA 13,500 SF

ALLOWABLE STORIES: (PER IBC TABLE 504.4) BASE ALLOWABLE SPRINKLER INCREASE

ALLOWABLE STORIES ACTUAL HEIGHT: 29' ALLOWABLE HEIGHT: (PER IBC TABLE 504.3)

BASE ALLOWABLE SPRINKLER INCREASE ALLOWABLE HEIGHT

FIRE RESISTANCE RATING FOR BUILDING ELEMENTS - V-B

STRUCTURAL FRAME: 0 HR INTERIOR BEARING WALLS: 0 HR INTERIOR NON-BEARING WALLS: 0 HR EXTERIOR BEARING WALLS: 0 HR EXTERIOR NON-BEARING WALLS: 0 HR FLOOR/CEILING: 0 HR CEILING/ROOF: SHAFT ENCLOSURES: 1 HR STAIRS: 0 HR

OCCUPANCY SEPARATIONS: (PER IBC SEC. 508.3) ALLOWABLE AREA & HEIGHT CALCULATIONS ARE BASED ON THE MOST RESTRICTIVE USE. DIFFERENT USES ARE NOT SEPARATED BY FIRE BARRIERS.

ROOF COVERINGS CLASS C OR BETTER

INCIDENTAL SEPARATIONS: (PER IBC TABLE 509)
NONE REQUIRED

SPECIAL CONDITIONS: EXIT & EMERGENCY LIGHTING, PORTABLE FIRE EXTINGUISHERS EGRESS - NO STEPS EXISTING OR PROPOSED AT FRONT EXIT

FIRE ALARM REQUIREMENTS:

**AUTOMATIC FIRE SUPPRESSION SYSTEM:** NOT REQUIRED, NOT PROVIDING

NOT REQUIRED, NOT PROVIDING

**EMERGENCY POWER SOURCE:** EXIT SIGNS, EXIT ILLUMINATION & EMERGENCY LIGHTING IS BY BATTERY BACK-UP HAZARDOUS MATERIALS: (PER IBC TABLE 307.1(1))

NO HAZARDOUS MATERIALS ARE TO BE STORED SMOKE CONTROL: SMOKE PARTITIONS: STANDPIPES: NOT REQUIRED NOT REQUIRED

DRAFTSTOPPING: REQUIRED PER 718.4 ex,. <u>ASSEMBLY</u> SIGNS TO BE MOUNTED IN ASSEMBLY AREAS OF MAXIMUM OCCUPANT LOAD TOTAL OCCUPANT LOAD: 123 OCCUPANTS (CALCULATED)

EXITING: REFERENCE PLAN

OFFICES

MECH/STG

OCCUPANT LOAD FACTORS: (PER TABLE 1004.5 and 1006.3) OCCUPANCY USE LOAD FACTOR MAX.OCC/STRY 1 EXIT MULTI-PURPOSE 15 sf/OCCUPANT WAITING RM 15 sf/OCCUPANT

TREATMENT ROOMS 100 sf/OCCUPANT


100 sf/OCCUPANT

300 sf/OCCUPANT

**Δ** 

GillamRe 1881 Main Street, S

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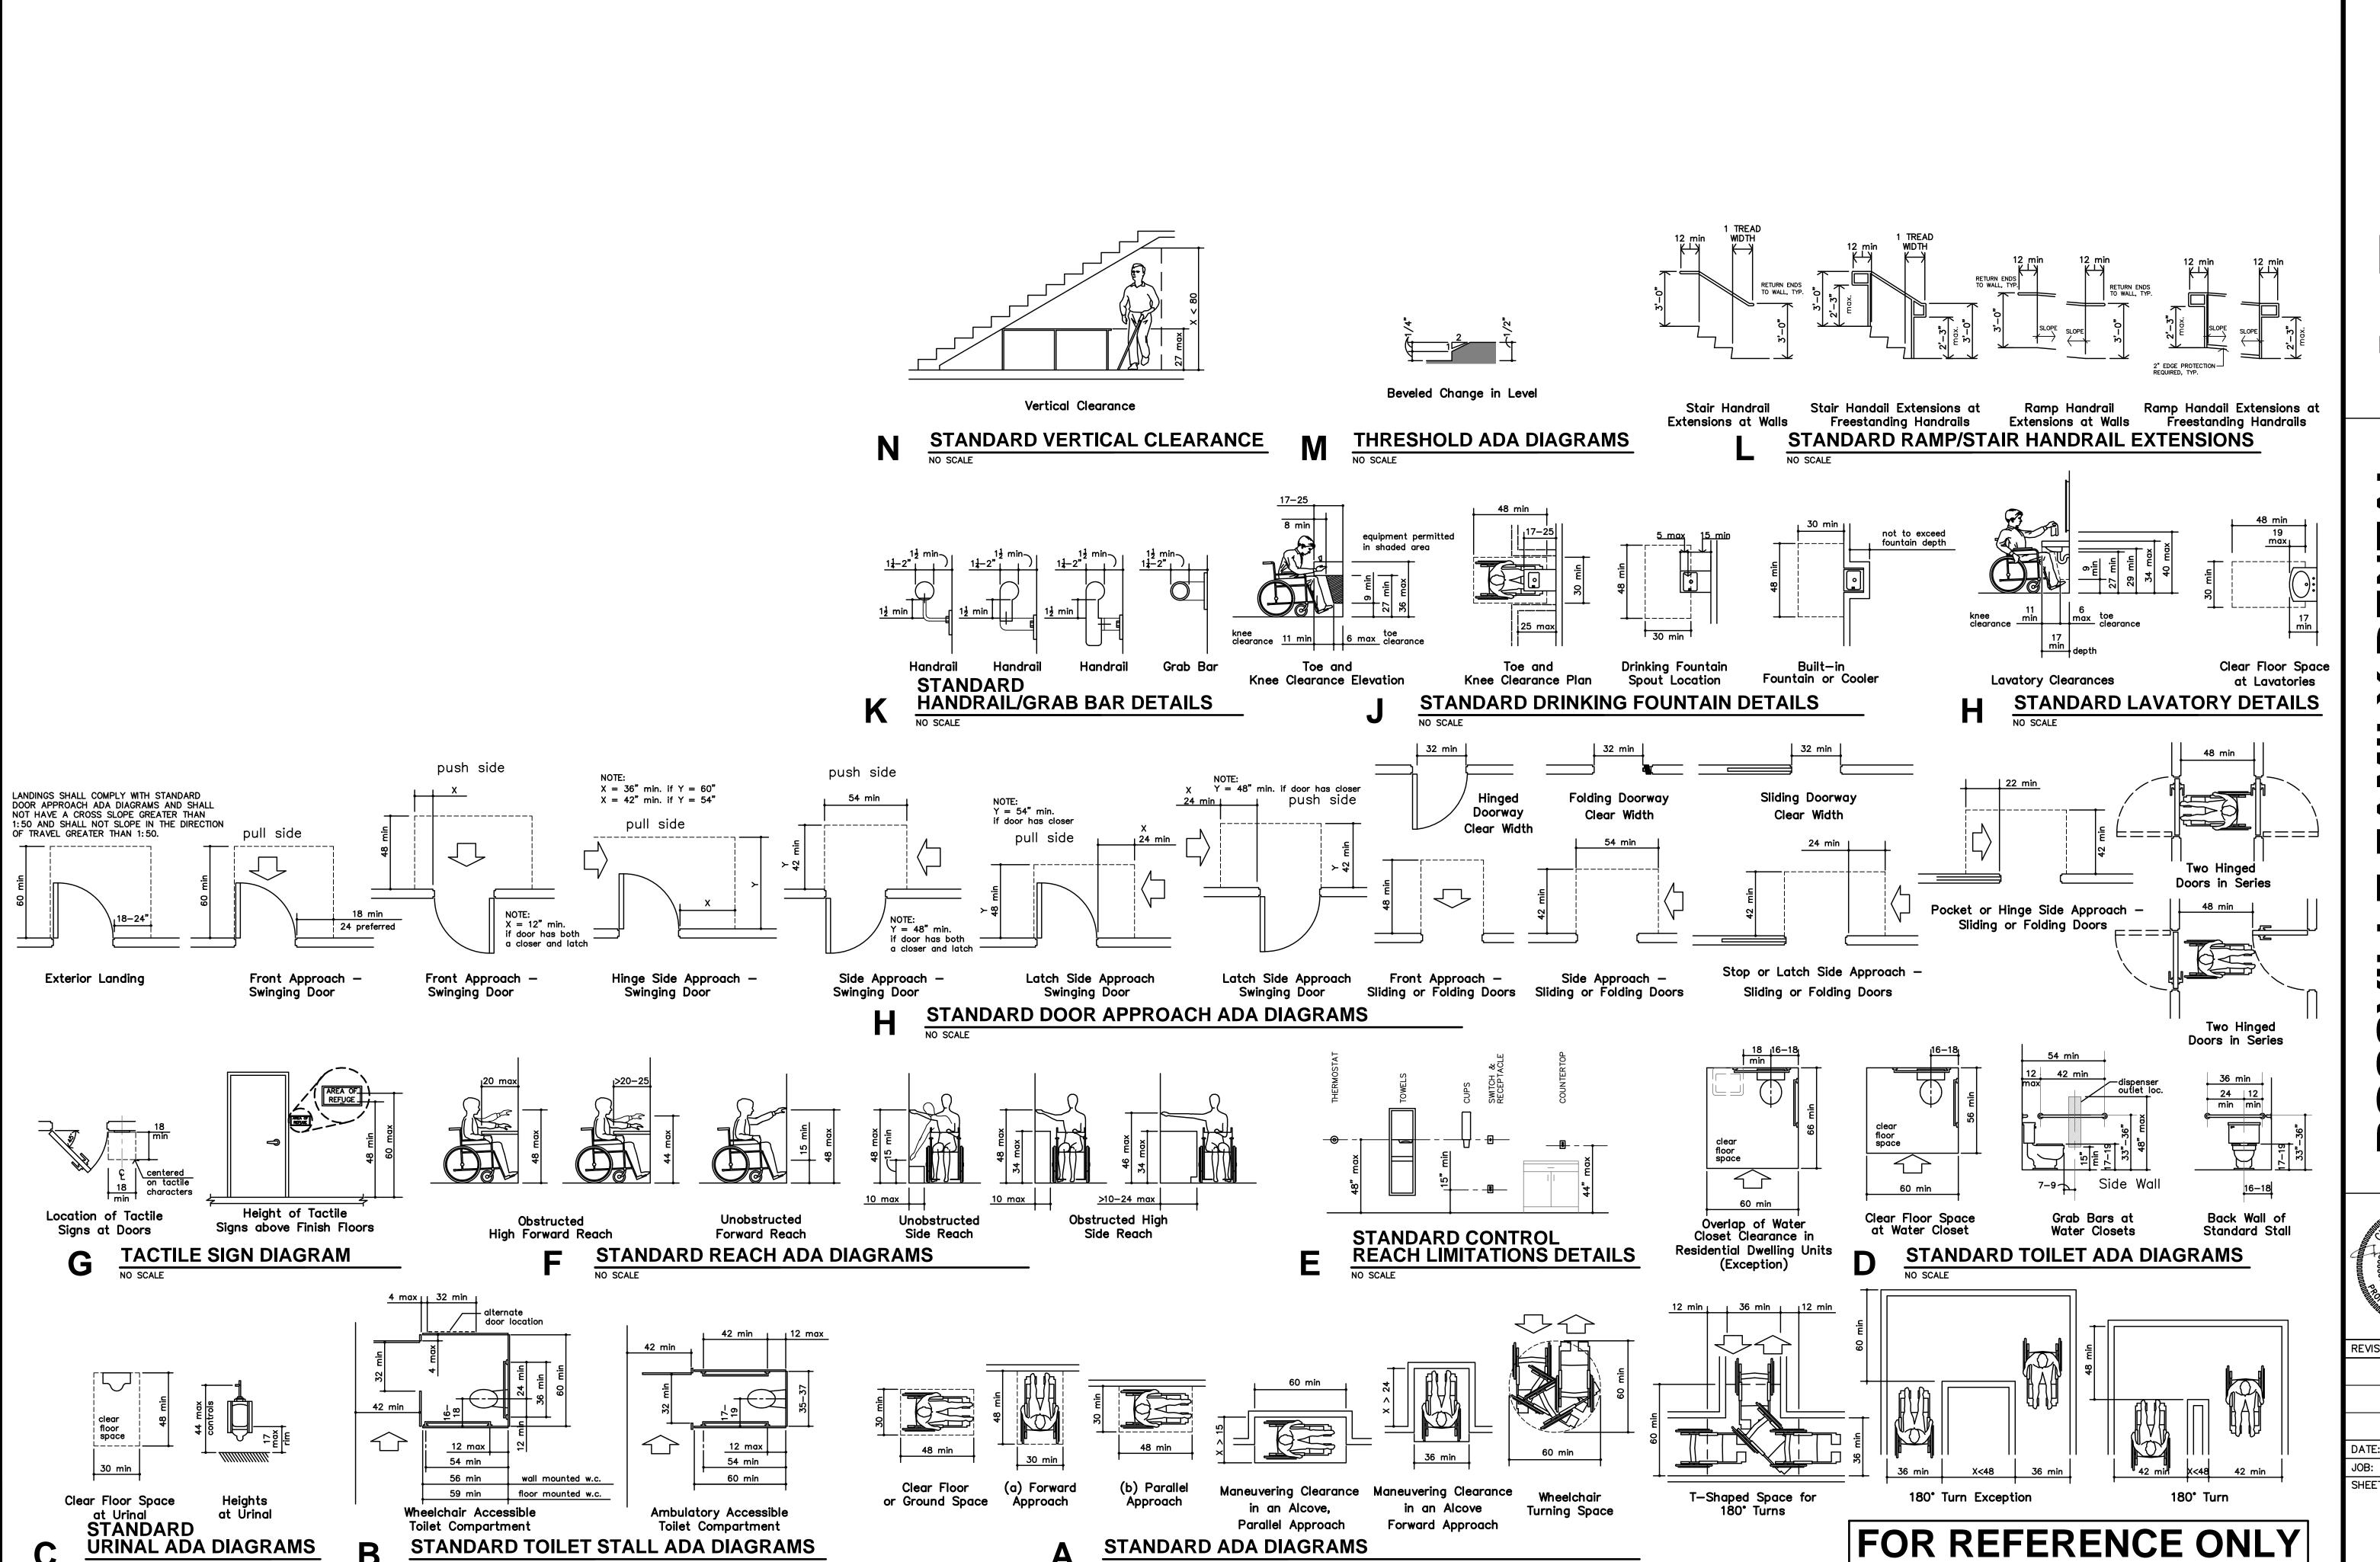

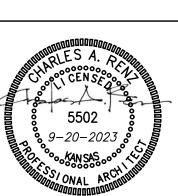
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SHEET NO.:

**CFP** 



**FAI** 

9-20-2023 22-3211 SHEET NO.:

**ADA** 



**PHOTO 5** 



PHOTO 4



**PHOTO 3** 



PHOTO 2



**PHOTO 1** 



**PHOTO 7** 







**PHOTO 8** 



 $\nabla_8$  otohq

- 1. AT ALL EXISTING WALLS BEING PAINTED: PATCH ALL HOLES, DENTS, SCRATCHES, ETC. AND SKIM WALLS PRIOR TO APPLYING NEW PAINT.
  2. WHERE EXISTING BUILDING COMPONENTS ARE TO BE REMOVED: PATCH & REPAIR THE SURFACES TO MATCH EXISTING, UNLESS NOTED OTHERWISE.
  3. REMOVE EXISTING BUILDING COMPONENTS AS INDICATED, IMPLIED OR AS REQUIRED SCHEMATICALLY SHOWN AS DASHED LINES. FIELD VERIFY ALL LOCATIONS.
  4. SHORING OF EXISTING STRUCTURE SHALL BE THE RESPONSIBILITY OF THE GENERAL CONTRACTOR.
  5. IT SHALL BE THE RESPONSIBILITY OF THE GENERAL CONTRACTOR TO COORDINATE

- GENERAL CONTRACTOR.


  5. IT SHALL BE THE RESPONSIBILITY OF THE GENERAL CONTRACTOR TO COORDINATE THE DEMOLITION BY DIFFERING TRADES.


  6. CONTRACTOR COORDINATE LOCATION OF ANY OR ALL EXISTING RECEPTACLES, SWITCHES, DEVICES, ETC. PRIOR TO DEMOLITION, RELOCATED OR ABANDON ACCORDINGLY. REMOVE WIRE TO SOURCE, INSTALL BLANK COVER PLATE AT ABANDONED RECEPTACLES.

  7. ALL MECHANICAL, ELECTRICAL AND PLUMBING WORK SHALL BE PERFORMED BY CONTRACTORS LICENSED FOR TYPE OF WORK. CONTRACTORS SHALL COORDINATE PERMIT REQUIREMENTS IF DEMOLITION SCOPE INVOLVES WORK REQUIRING A PERMIT.
- 8. THE OWNER SHALL HAVE FIRST RIGHT OF REFUSAL FOR ALL REMOVED COMPONENTS. CONTRACTOR SHALL COORDINATE WITH OWNER ALL OTHER ITEMS SHALL BE HAULED FROM SITE AND DISPOSED BY CONTRACTOR.

# <u>SPECIFIC</u>

- 1 SAWCUT & REMOVE EXISTING CONC. CURB FOR NEW PARKING PER ALT. 2
- 2 REMOVE EXISTING FENCE
- REMOVE EXISTING DRIVE-THRU MASONRY COLUMNS, CONCRETE ISLAND & CANOPY PER ALT. 3, REF ORIGINAL DRAWINGS DETAIL 2/A6
- REMOVE EXISTING LANDSCAPE MATERIAL & VEGETATION. PREP FOR NEW SEED, PLANTINGS, ETC.
- 5 SAWCUT & REMOVE EXISTING CURB & PARTIAL DRIVEWAY @ NEW DOOR.

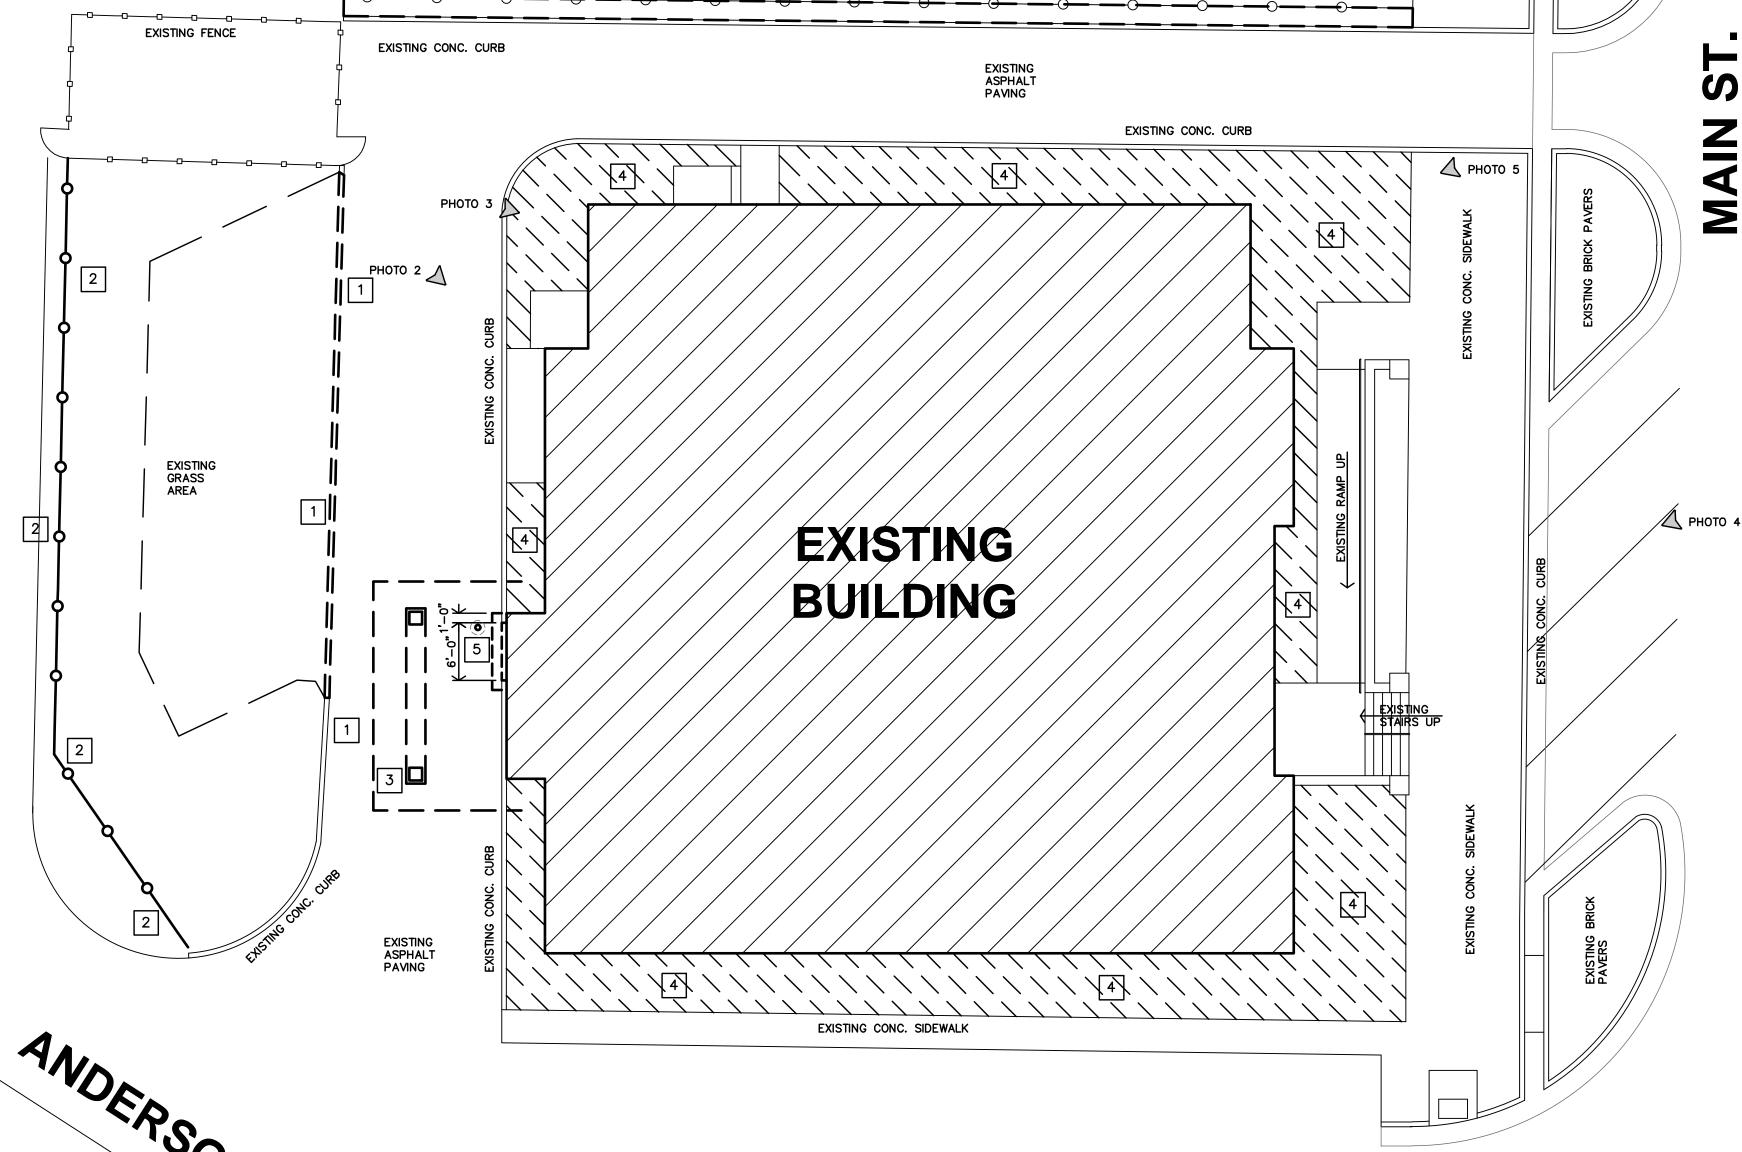

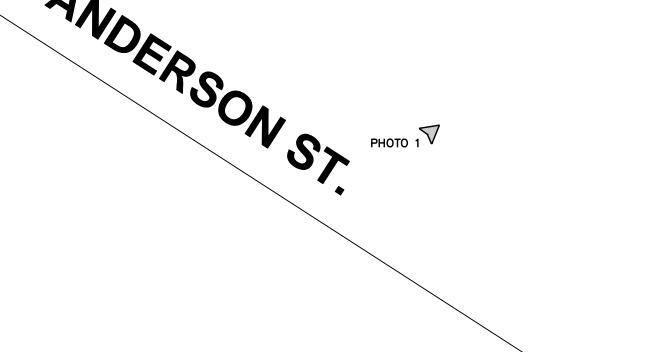

W. PERRY ST.

**DEMOLITION SITE PLAN** 

SHEET NO.:

PHOTOS 6/7

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SHEET NO.:

**D2.2** 






PHOTO 12

PHOTO 11



PHOTO 10



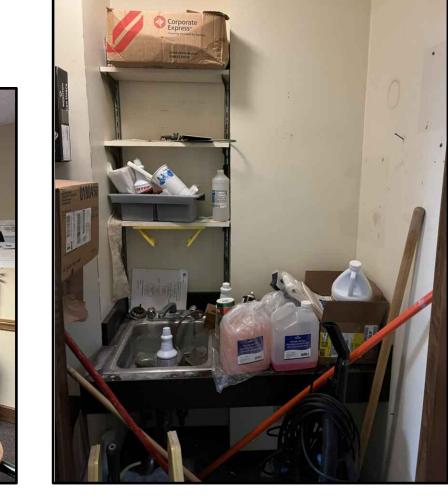





РНОТО 9

PHOTO 8

РНОТО 7

PHOTO 6

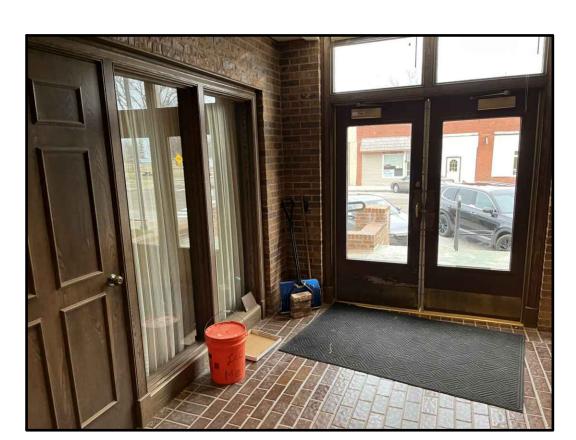


PHOTO 5









PHOTO 2

PHOTO 1

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1. AT ALL EXISTING WALLS BEING PAINTED: PATCH ALL HOLES, DENTS, SCRATCHES, 2. WHERE EXISTING WALLS PRIOR TO APPLYING NEW PAINT.

THE SURFACES TO MATCH EXISTING, UNLESS NOTED OTHERWISE.

REMOVE EXISTING BUILDING COMPONENTS AS INDICATED, IMPLIED OR AS REQUIRED SCHEMATICALLY SHOWN AS DASHED LINES. FIELD VERIFY ALL 4. SHORING OF EXISTING STRUCTURE SHALL BE THE RESPONSIBILITY OF THE GENERAL CONTRACTOR. GENERAL CONTRACTOR.

5. IT SHALL BE THE RESPONSIBILITY OF THE GENERAL CONTRACTOR TO COORDINATE THE DEMOLITION BY DIFFERING TRADES.

6. CONTRACTOR COORDINATE LOCATION OF ANY OR ALL EXISTING RECEPTACLES, SWITCHES, DEVICES, ETC. PRIOR TO DEMOLITION, RELOCATED OR ABANDON ACCORDINGLY. REMOVE WIRE TO SOURCE, INSTALL BLANK COVER PLATE AT ABANDONED RECEPTACLES.

7. ALL MECHANICAL, ELECTRICAL AND PLUMBING WORK SHALL BE PERFORMED BY CONTRACTORS LICENSED FOR TYPE OF WORK. CONTRACTORS SHALL COORDINATE PERMIT REQUIREMENTS IF DEMOLITION SCOPE INVOLVES WORK REQUIRING A PERMIT. 8. THE OWNER SHALL HAVE FIRST RIGHT OF REFUSAL FOR ALL REMOVED COMPONENTS. CONTRACTOR SHALL COORDINATE WITH OWNER ALL OTHER ITEMS SHALL BE HAULED FROM SITE AND DISPOSED BY CONTRACTOR.

9. EXISTING EQUIPMENT TO REMAIN AND BE RELOCATED. REFERENCE FLOOR PLAN FOR DETAILS. <u>SPECIFIC</u> 1 REMOVE EXISTING DOOR & DOOR FRAME 2 REMOVE EXISTING TOILET. REF. MEP 3 REMOVE EXISTING SINK. REF. MEP 4 REMOVE EXISTING CASEWORK & ALL ASSOCIATED FIXTURES 5 REMOVE EXISTING FLOOR FOR NEW PLUMBING TO TIE INTO EXISTING WASTE MAIN LINE 6 SAWCUT & REMOVE EXISTING WALLS 6A EXISTING WALL IS LOAD BEARING TO FLOOR ABOVE. PROVIDE SHORING PRIOR TO ANY WALL DEMOLITION. 7 REMOVE EXISTING WINDOW & WINDOW FRAME 8 REMOVE EXISTING LOCKERS 9 REMOVE EXISTING LIGHT WELL & FIXTURES. REF. MEP [10] REMOVE EXISTING WINDOW & WINDOW FRAME, PREP FOR NEW WINDOW FRAMING 11 REMOVE EXISTING DRINKING FOUNTAIN 12 REMOVE EXISTING VAULT 13 DEMO ALL CASEWORK & ABANDON ELECTRICAL FOR OVERBUILD OF NEW FLOOR 14 REMOVE EXISTING CURTAIN POCKET 15 SAWCUT & REMOVE MASONRY WALL 16 REMOVE URINAL. REF. MEP 17 REMOVE TOILET PARTITIONS. REF. MEP 18 REMOVE VAULT DOOR & FRAME 19 SAWCUT & REMOVE MASONRY WALL FOR NEW OPENING 20 SAWCUT & REMOVE BRICK. FINISH AS REQ'D. 21 REMOVE EXISTING HEARTH 21A ALT. 1 -REMOVE FIREPLACE IN IT'S ENTIRETY

22A ALT. 3 - REMOVE DRIVE-THRU MASONRY COLUMNS, CONCRETE ISLAND, ROOF OVERHANG, PATCH ROOF AS REQ'D.

27 LOAD BEARING WALL (DO NOT DEMO. ADDITIONAL STRUCTURAL DESIGN TO BE PERFORMED)

32 SAWCUT & REMOVE SECTION OF CONCRETE DECK ABOVE. SEE ORIGINAL DRAWINGS DETAIL 7/A7

INDICATES LOAD BEARING WALL (DO NOT DEMO. ADDITIONAL STRUCTURAL

23 REMOVE EXISTING VCT. PREP FOR NEW FINISH.

25 REFERENCE MEIP FOR EQUIPMENT DEMOLITION REQUIREMENTS

26 REMOVE EXISTING RAILING. PATCH FLOOR FOR NEW FINISH

28 ENDWALL BEARING. SHORE STRUCTURE AT REMOVED WALL

30 REMOVE EXISTING TILE FLOORING & PREP FOR NEW FINISH

31 REMOVE EXISTING BRICK PAVER FLOOR


INDICATES SECOND FLOOR LOCATION

DESIGN TO BE PERFORMED)

29 REMOVE EXISTING CARPET FLOORING & PREP FOR NEW FINISH


24 REMOVE SAFETY DEPOSIT BOXES

**DEMOLITION NOTES** 

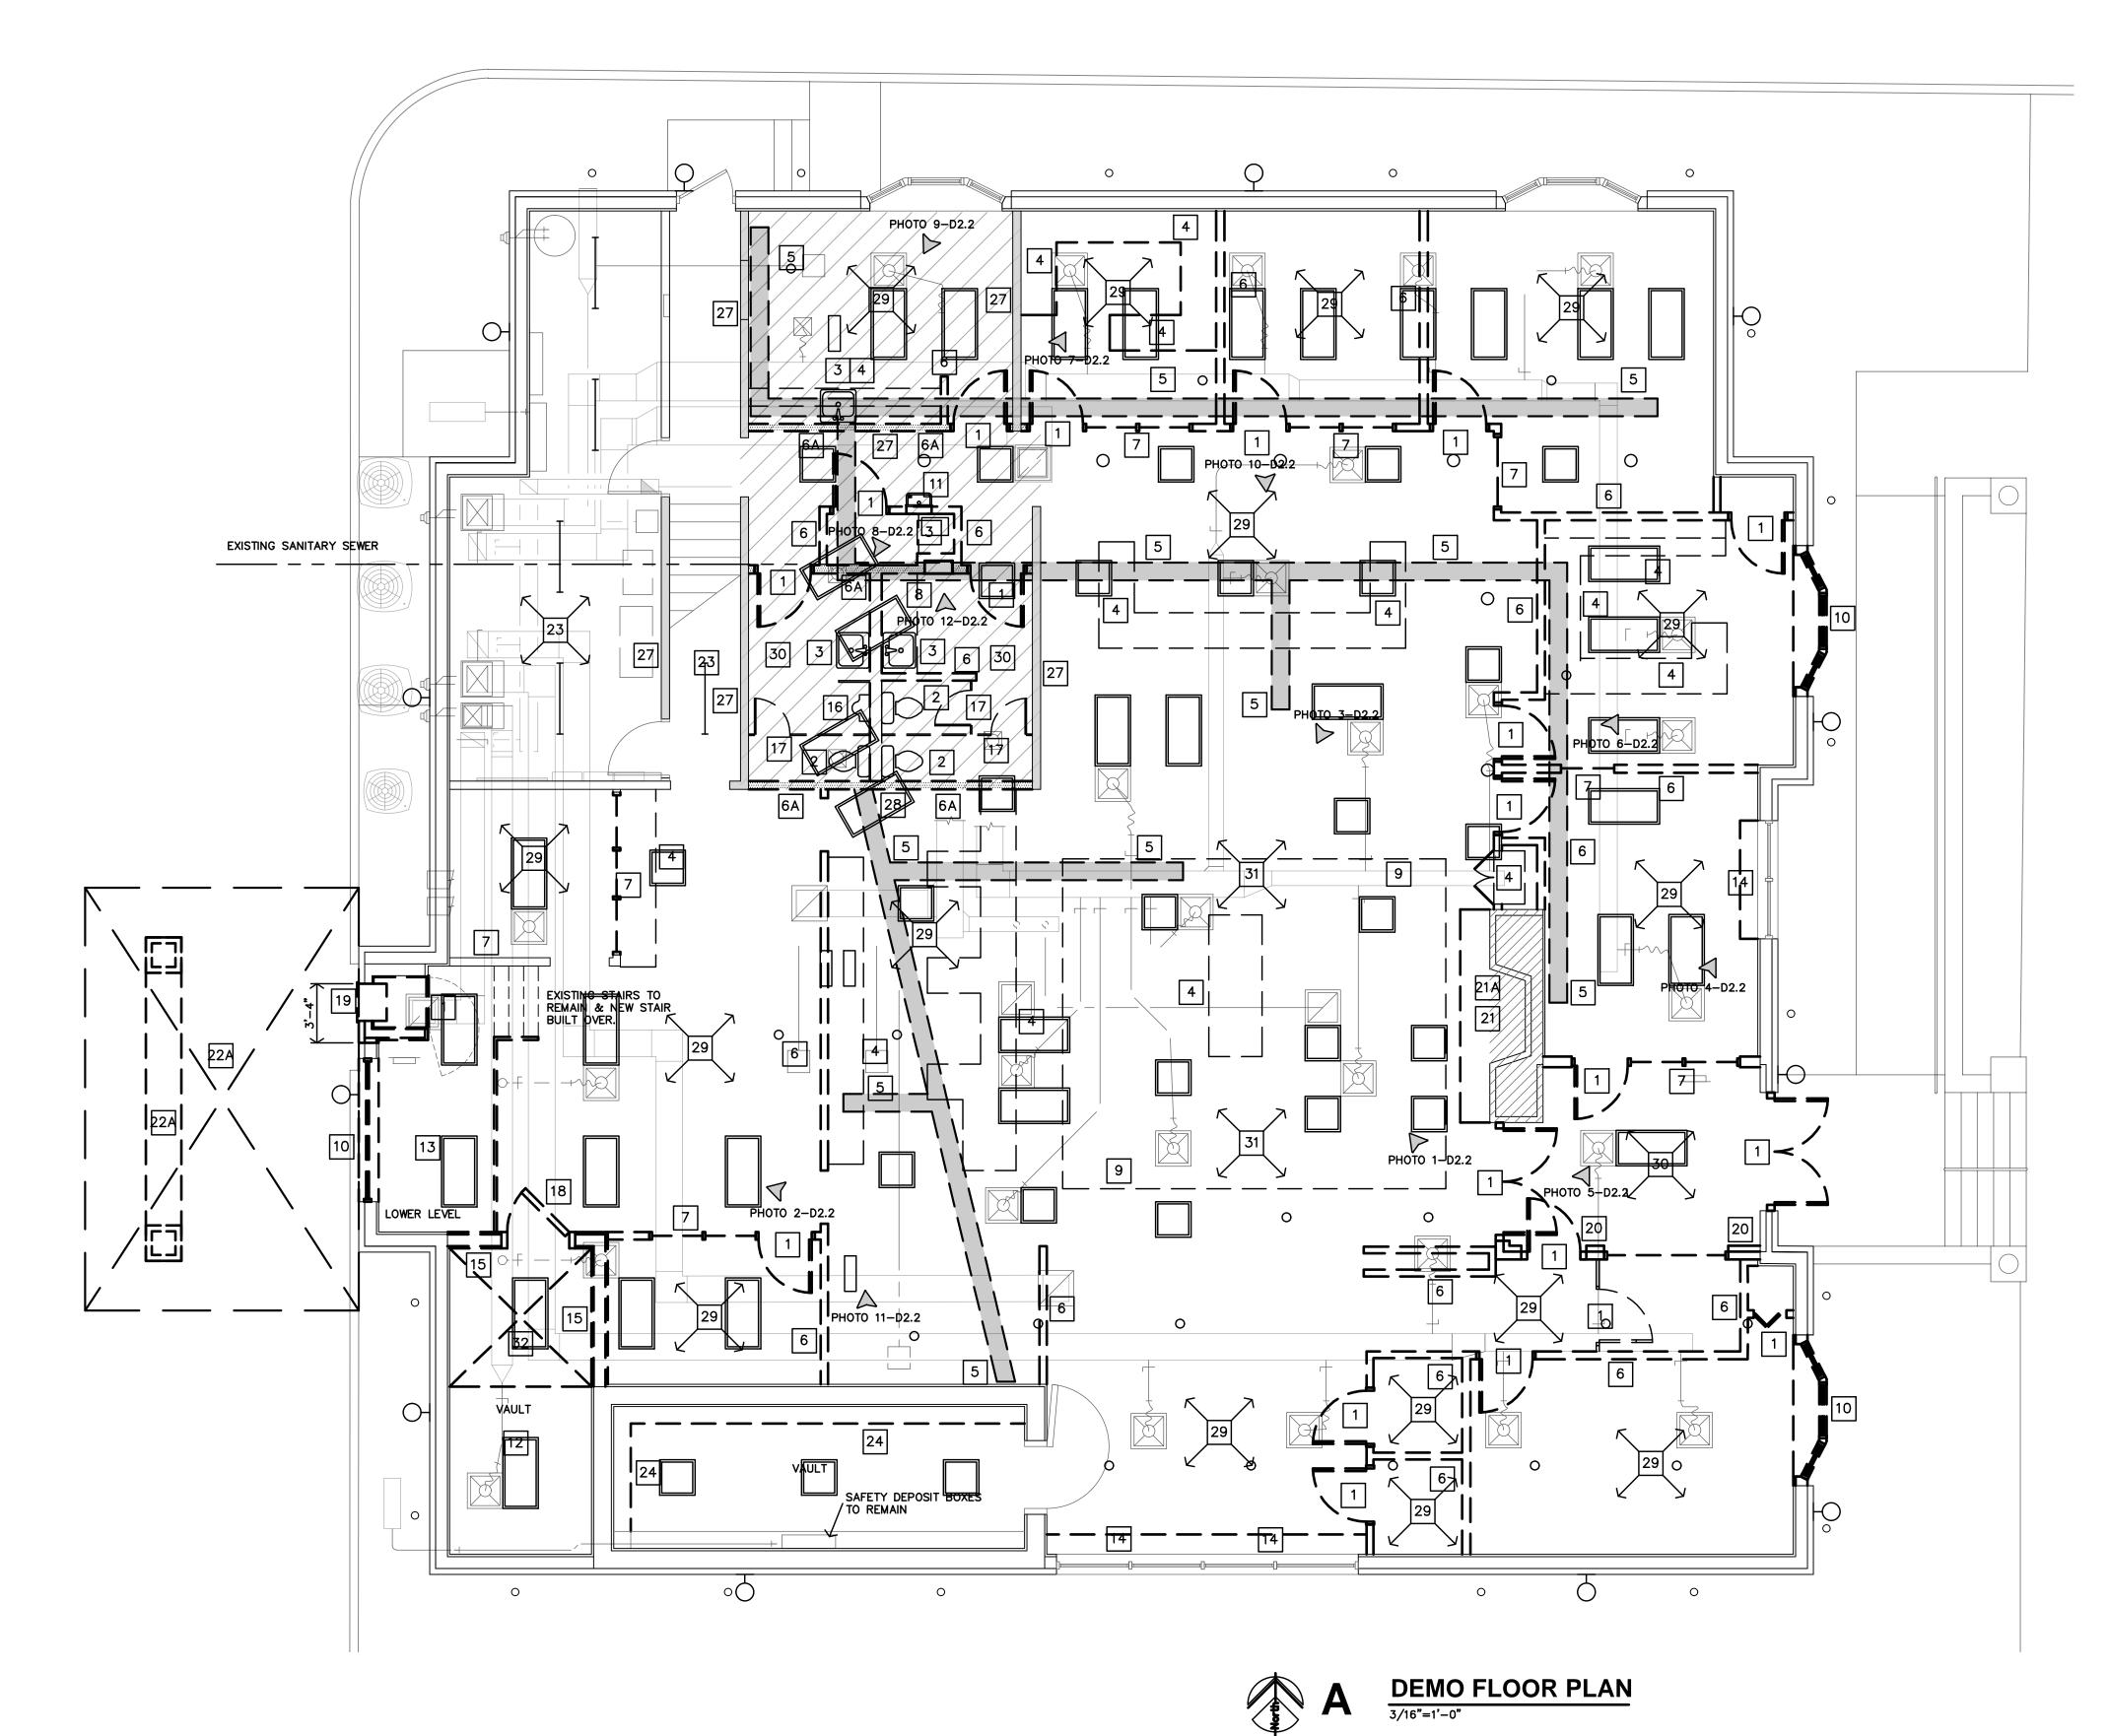


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D3.1

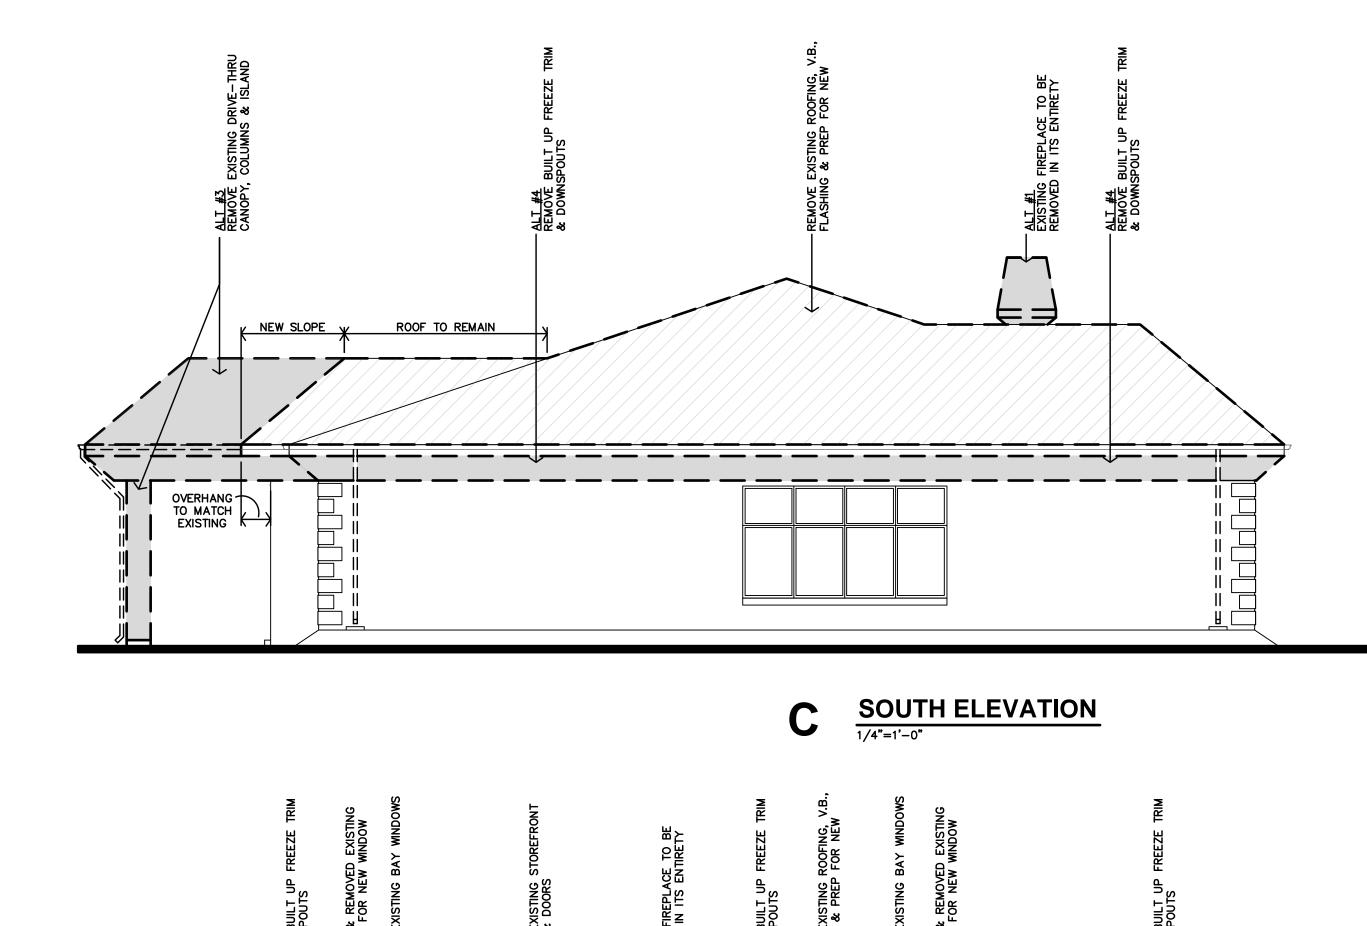


A EAST ELEVATION

1/4"=1'-0"



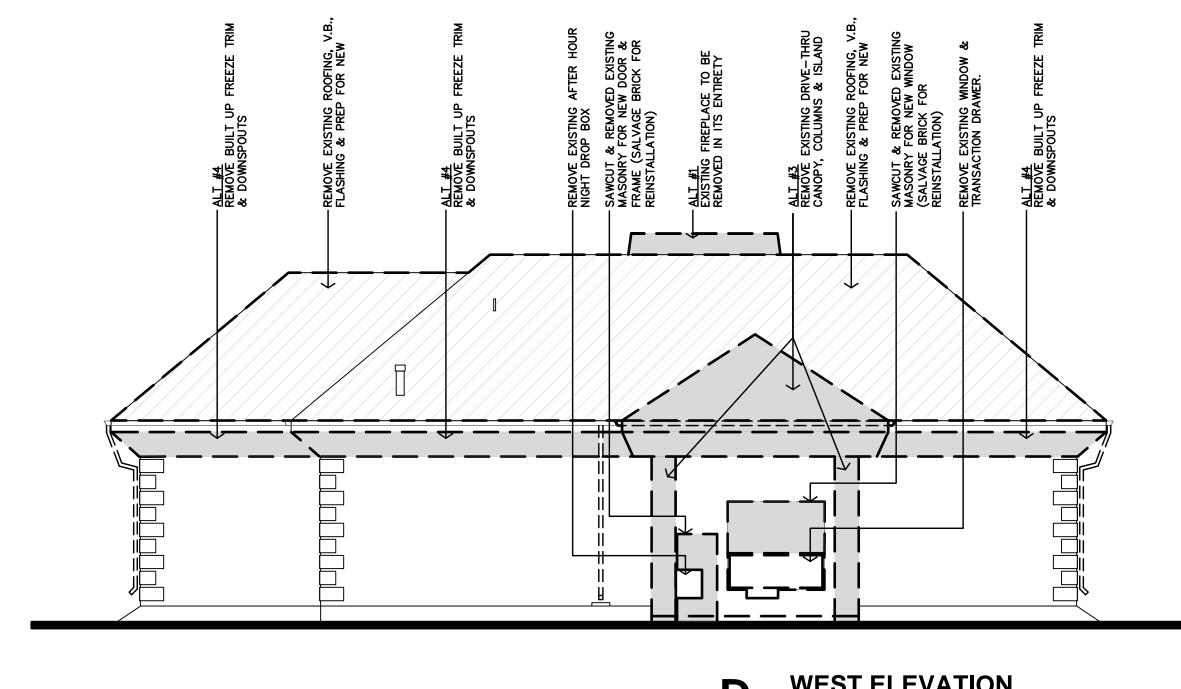

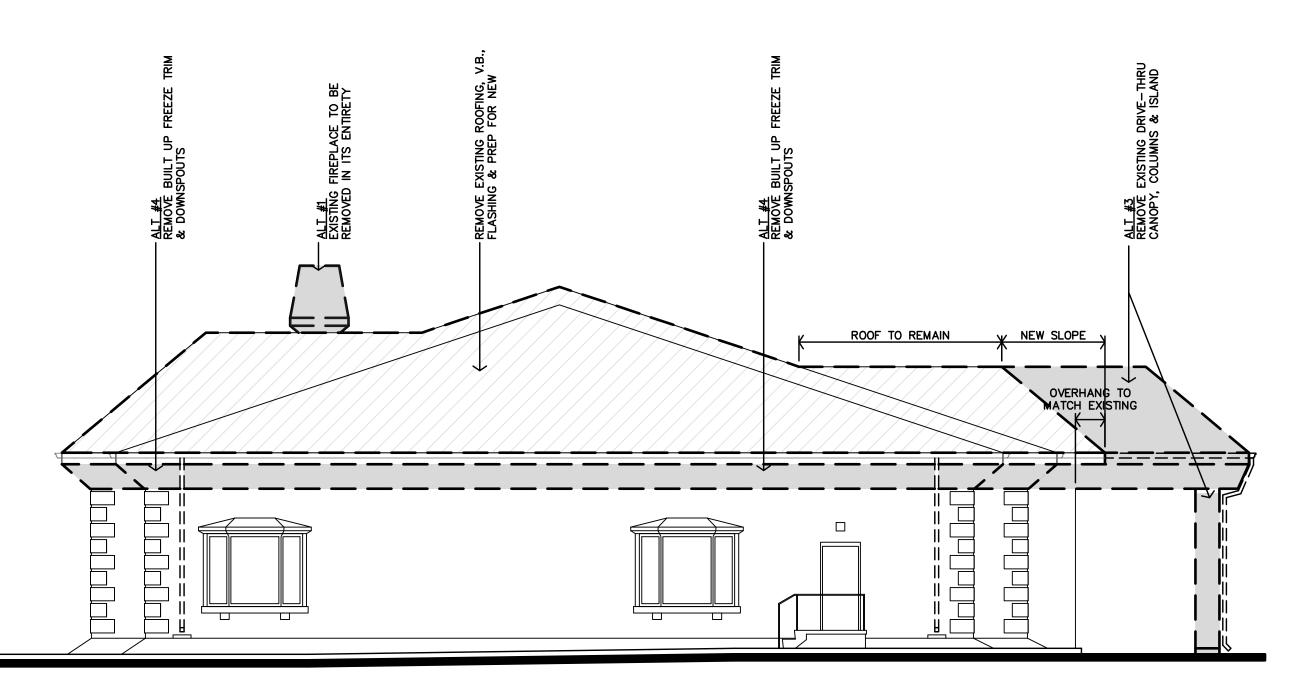


B NORTH ELEVATION

1/4"=1'-0"

**FAI** 

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**A1.1** 

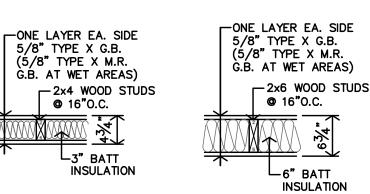


**INTERIOR** 

AS 5" ON PLANS

**PARTITION TYPES** 


-2x6 WOOD STUDS

AS 7" ON PLANS

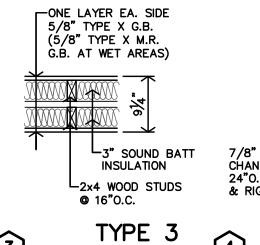

TYPICALLY DIMENSIONED

AS 9¼" ON PLANS

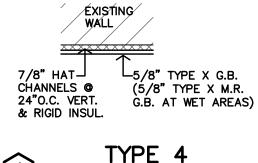

TYPE 4

# **GENERAL NOTES**

CONTRACTOR SHALL FIELD VERIFY ALL DIMENSIONS & CONDITIONS.
IF THERE IS A DISCREPANCY BETWEEN DRAWINGS AND FIELD CONDITIONS NOTIFY ARCHITECT PRIOR TO PROCEEDING WITH WORK SO THAT ANY ISSUES MAY BE CLARIFIED. ALL WORK SHALL BE IN CONFORMANCE W/ APPLICABLE BUILDING CODES & ORDINANCES. ALL NEW CONSTRUCTION SHALL BE IN CONFORMANCE TO ADA REQUIREMENTS. REFERENCE ADA FOR TYPICAL MINIMUM CLEARANCE REQ'D.

install materials and/or finishes as indicated, implied or as required for complete & finished installation.

In all new door hardware shall be lever type latch sets unless noted otherwise. Coordinate W/MFR. For ada installation requirements. Coordinate Keying REQUIREMENTS WITH OWNER.


DOORS ARE TYPICALLY LOCATED WITH HINGE—SIDE JAMB 4" FROM ADJACENT WALL UNLESS NOTED OTHERWISE OR REQUIRED TO MEET LATCH—SIDE CLEARANCE PER ADA.


DIMENSIONS TO NEW INTERIOR WALLS ARE TO THE FACE OF G.B. U.N.O.


FEC — INDICATES LOCATION OF FIRE EXTINGUISHER CABINET. REF SPECS. O. ALL NEW DOOR HARDWARE SHALL BE LEVER TYPE LATCH SETS UNLESS NOTED OTHERWISE. COORDINATE W/ MFR. FOR ADA INSTALLATION REQUIREMENTS. COORDINATE KEYING REQUIREMENTS WITH OWNER.


INDICATES LOAD BEARING WALL. DO NOT DEMO. REFERENCE STRUCTURAL DESIGN. CONTRACTOR TO REVIEW CONDITIONS AND SHORE ARE FOR WORK TO BE PERFORMED.

\* NOTES AREAS WHERE WALLS NEED TO BE PATCHED, REPAIRED & REFINISHED DUE TO THE REMOVAL OF EXISTING WALLS, CASEWORK, FIXTURES, LOCKERS, ETC, (REFERENCE DEMO

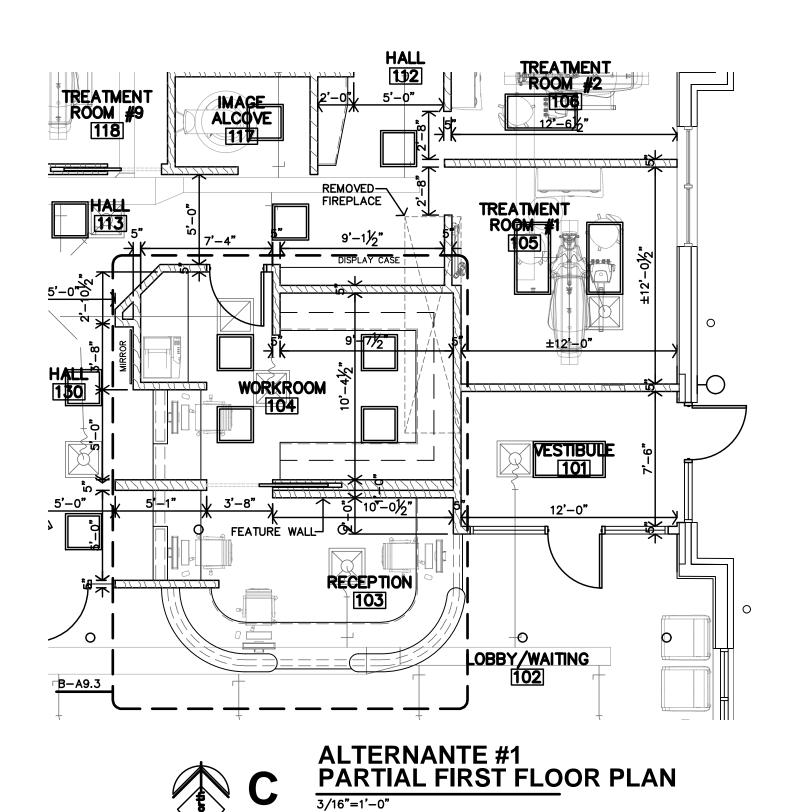

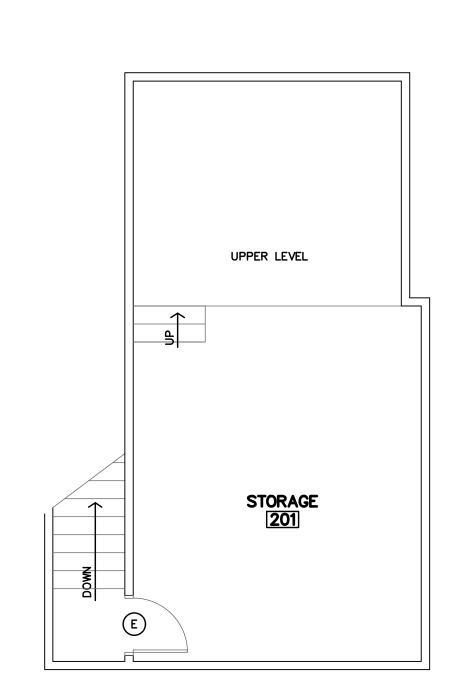


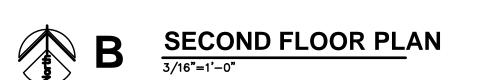

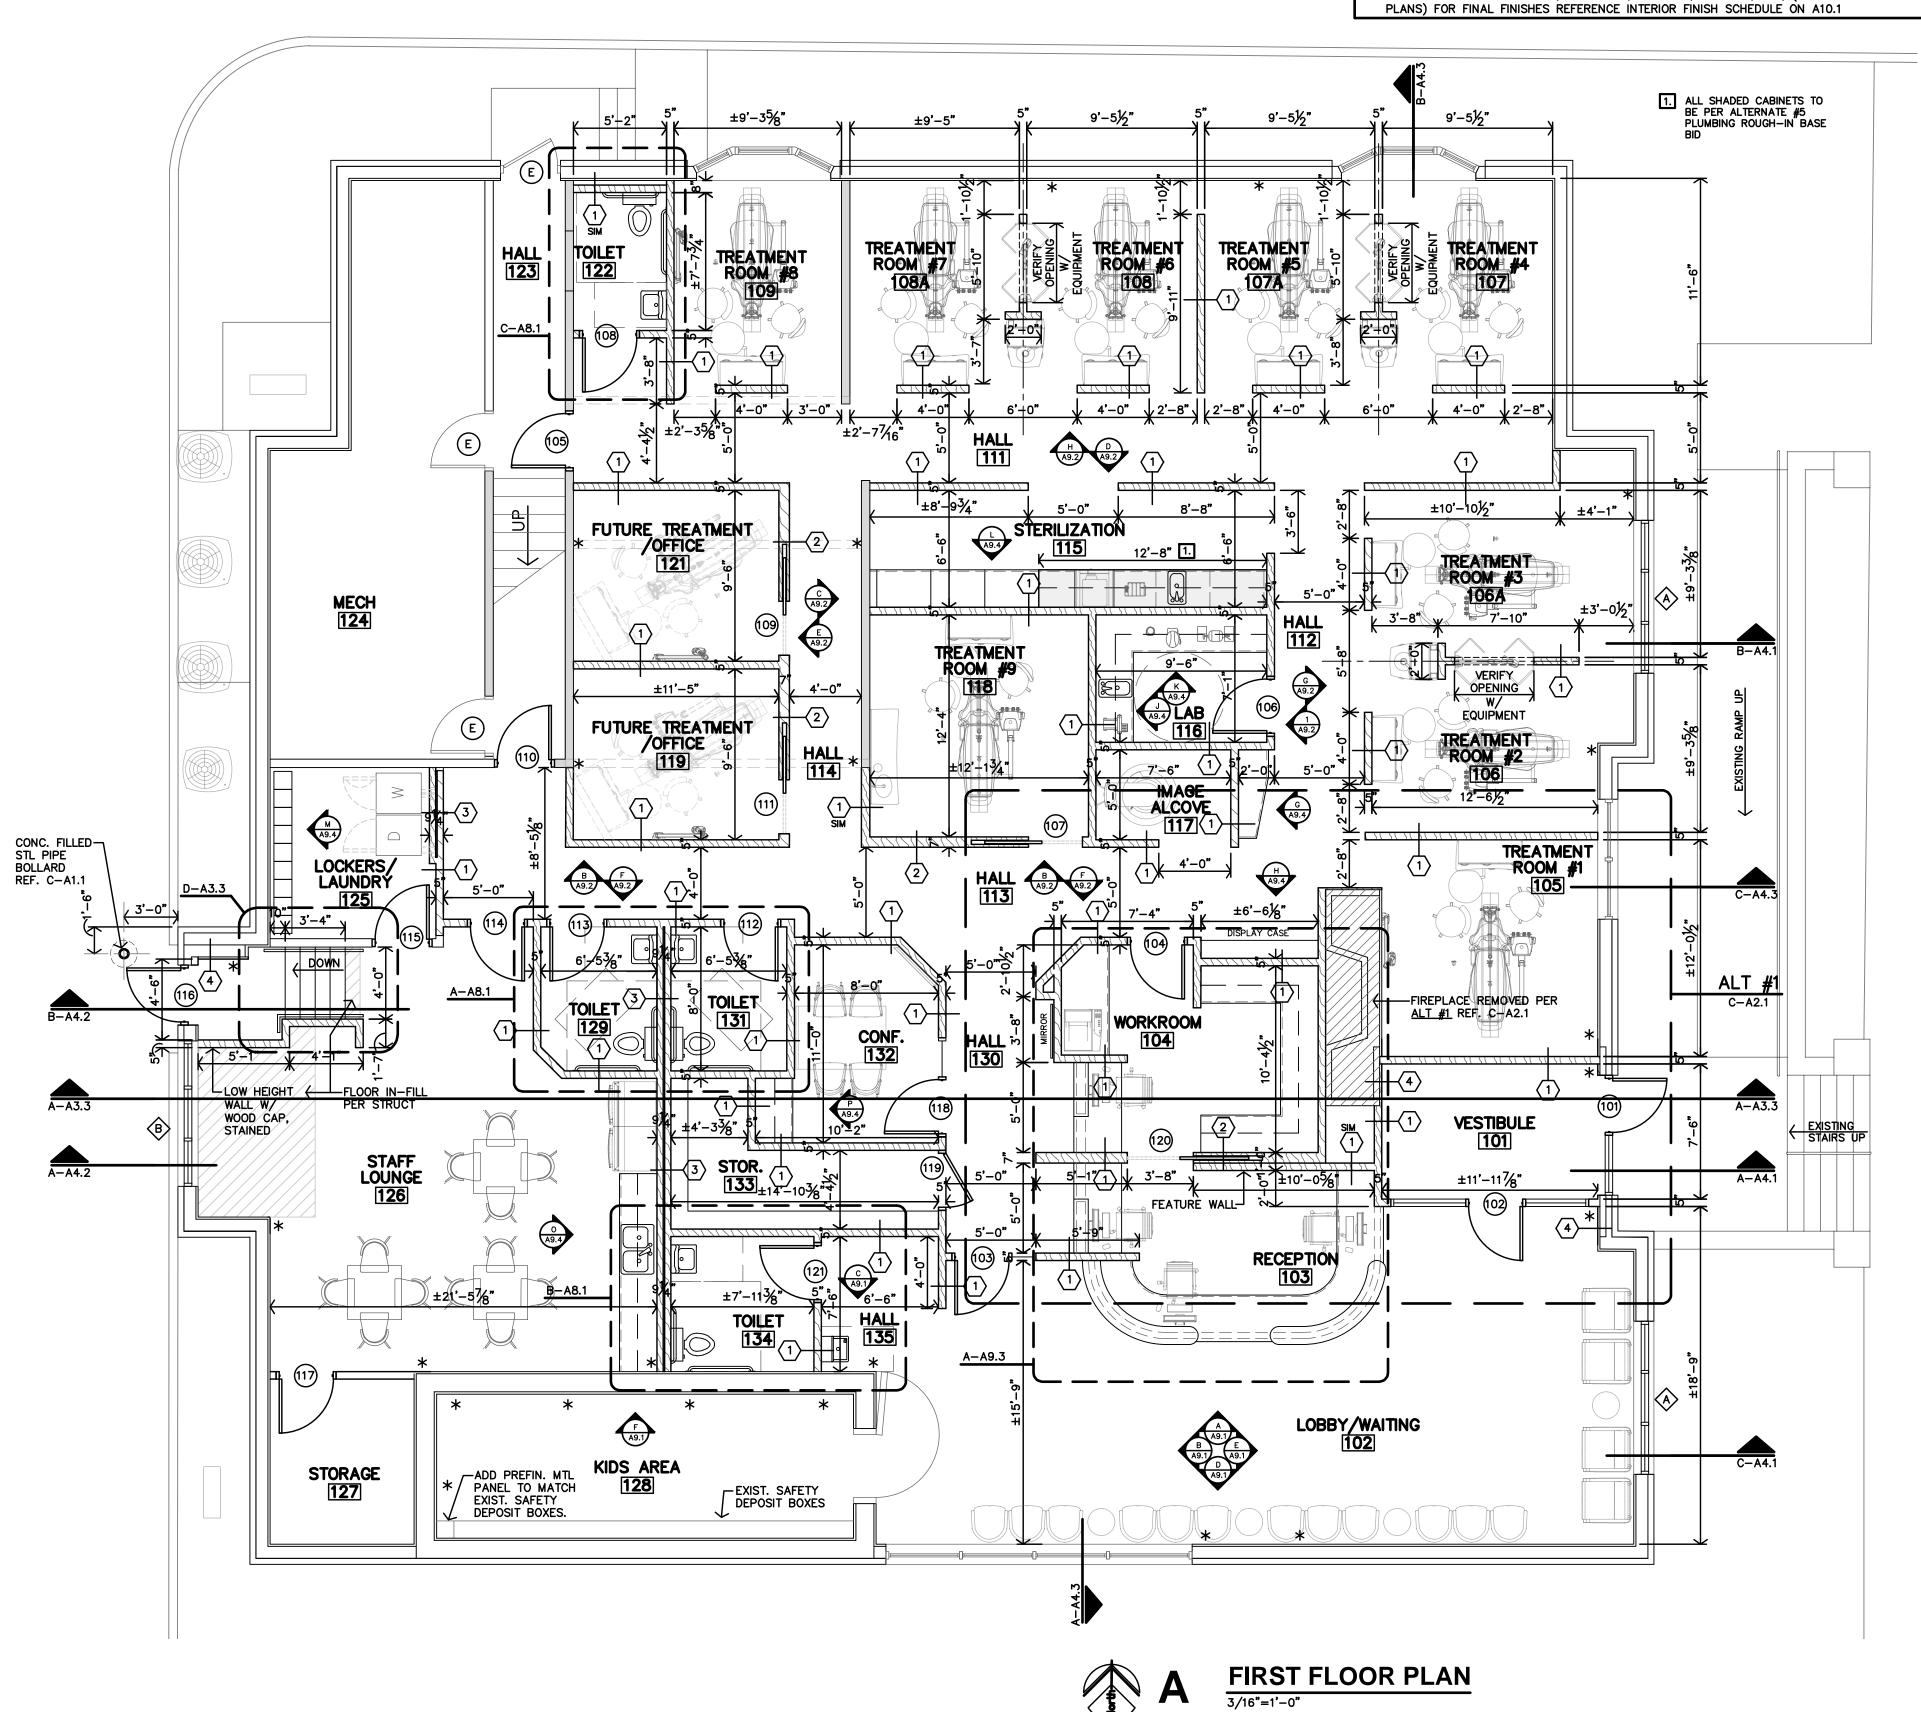

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**A2.1** 

DATE: 9−20−2023 JOB: 22−3211 ⊖

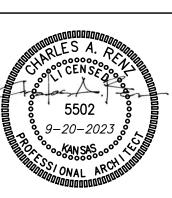A2.2


LUXURY VINYL TILE

CERAMIC TILE

CARPET

WALK-OFF CARPET


SEALED CONCRETE

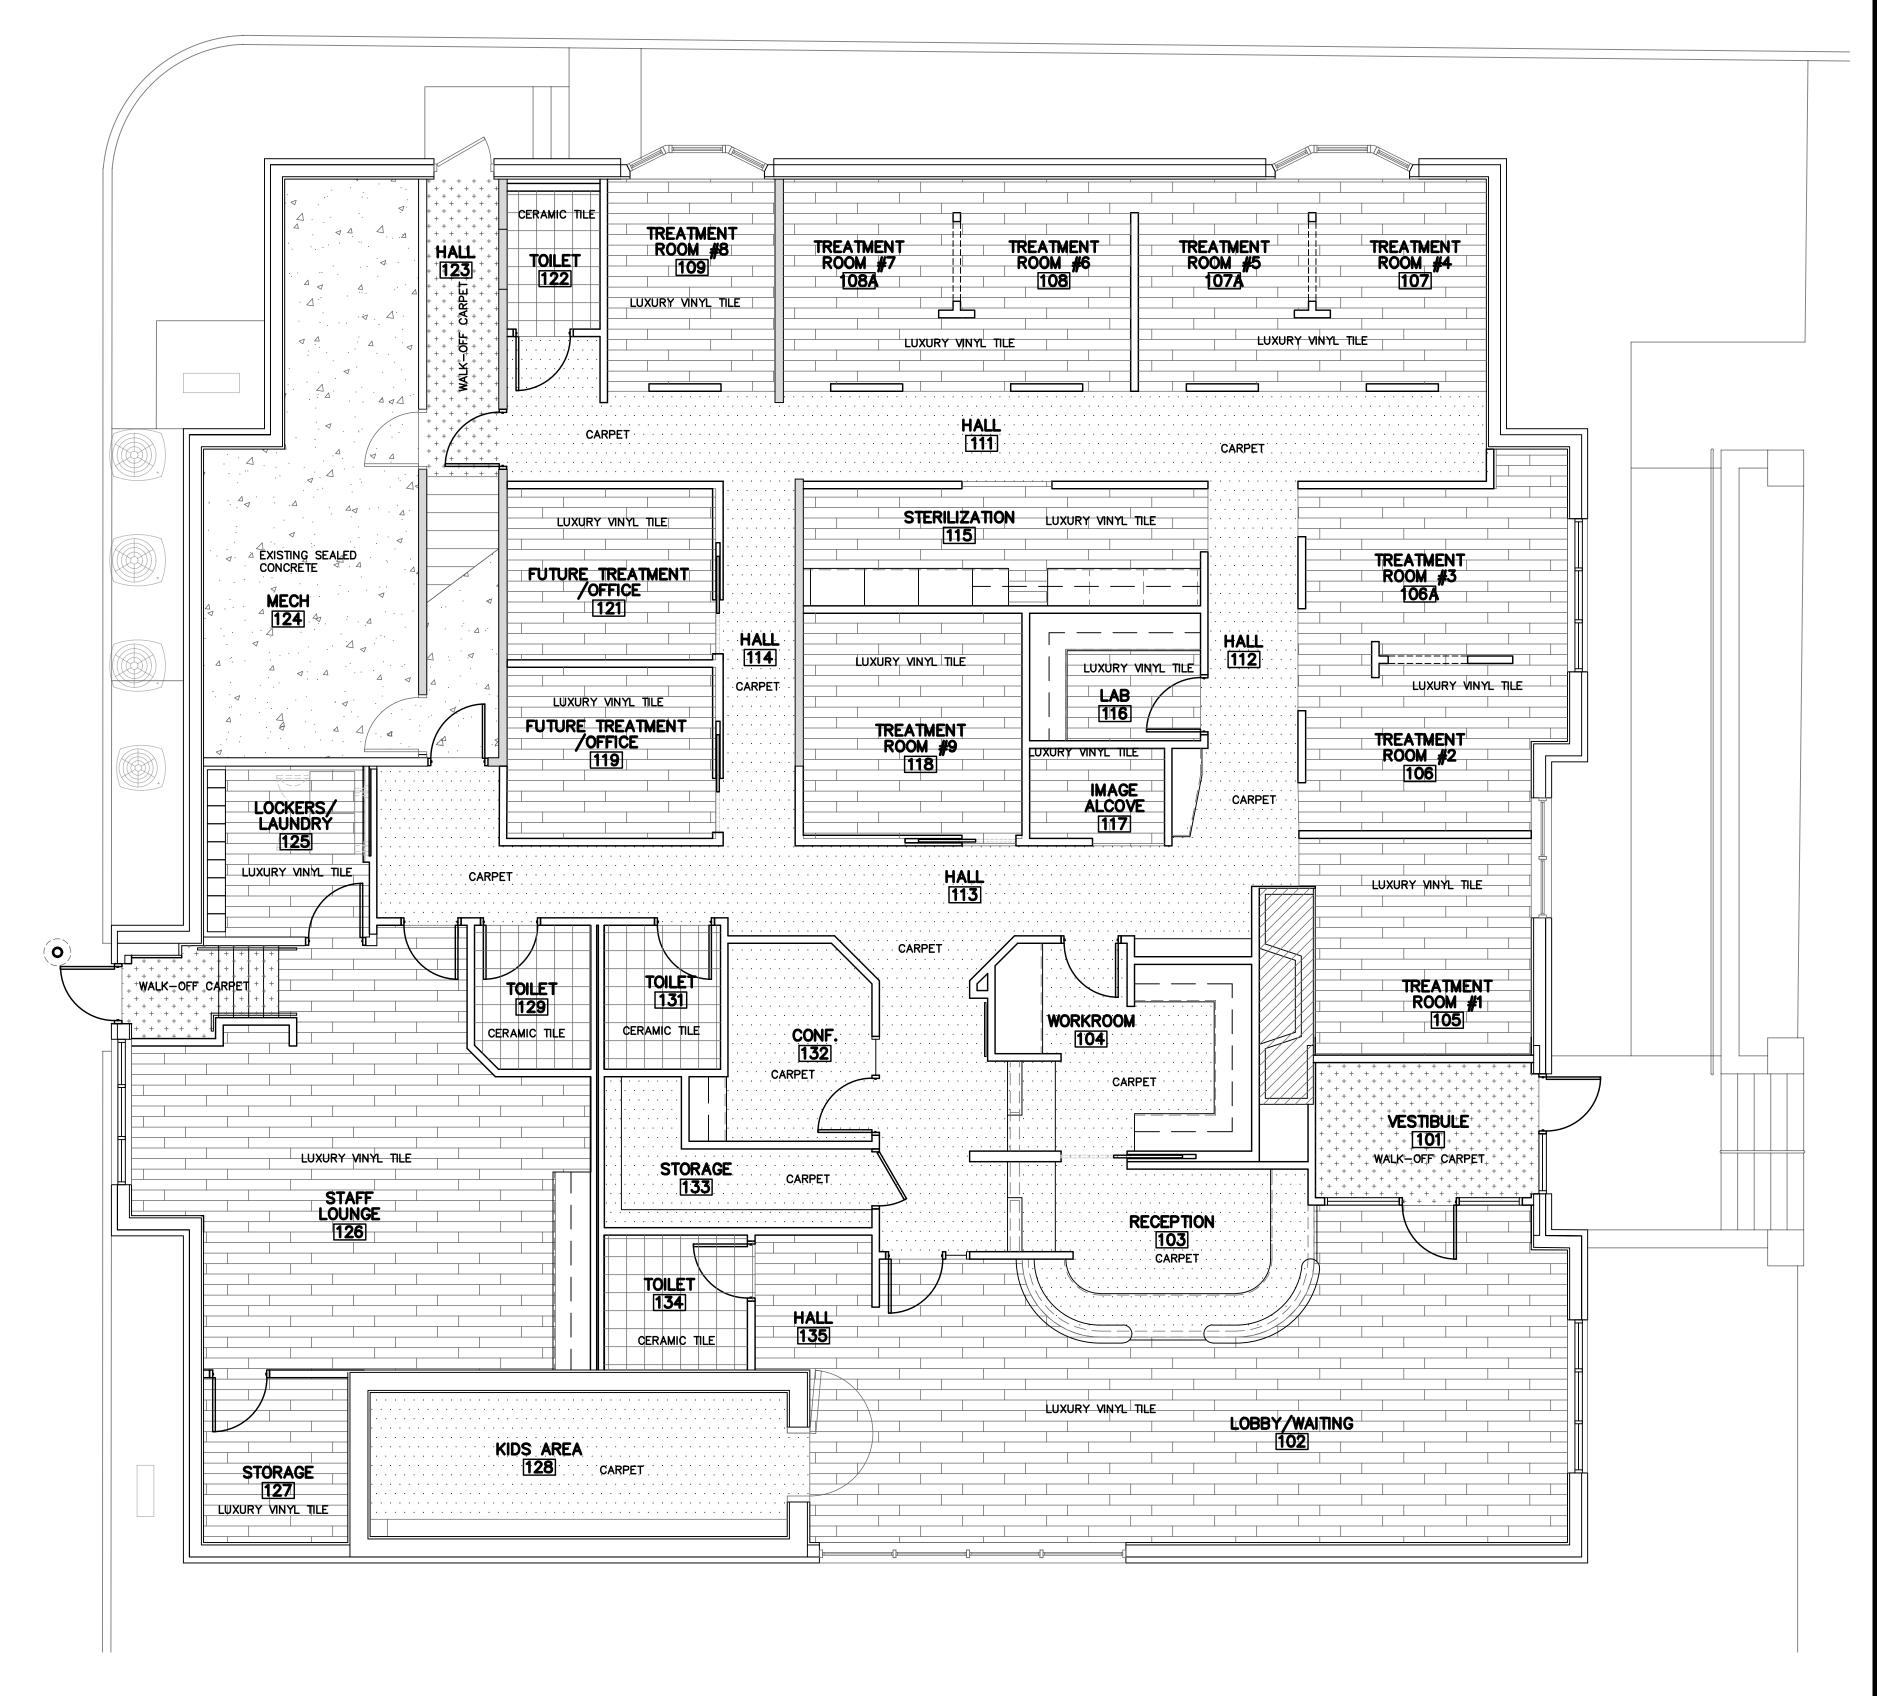




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**A3.1** 




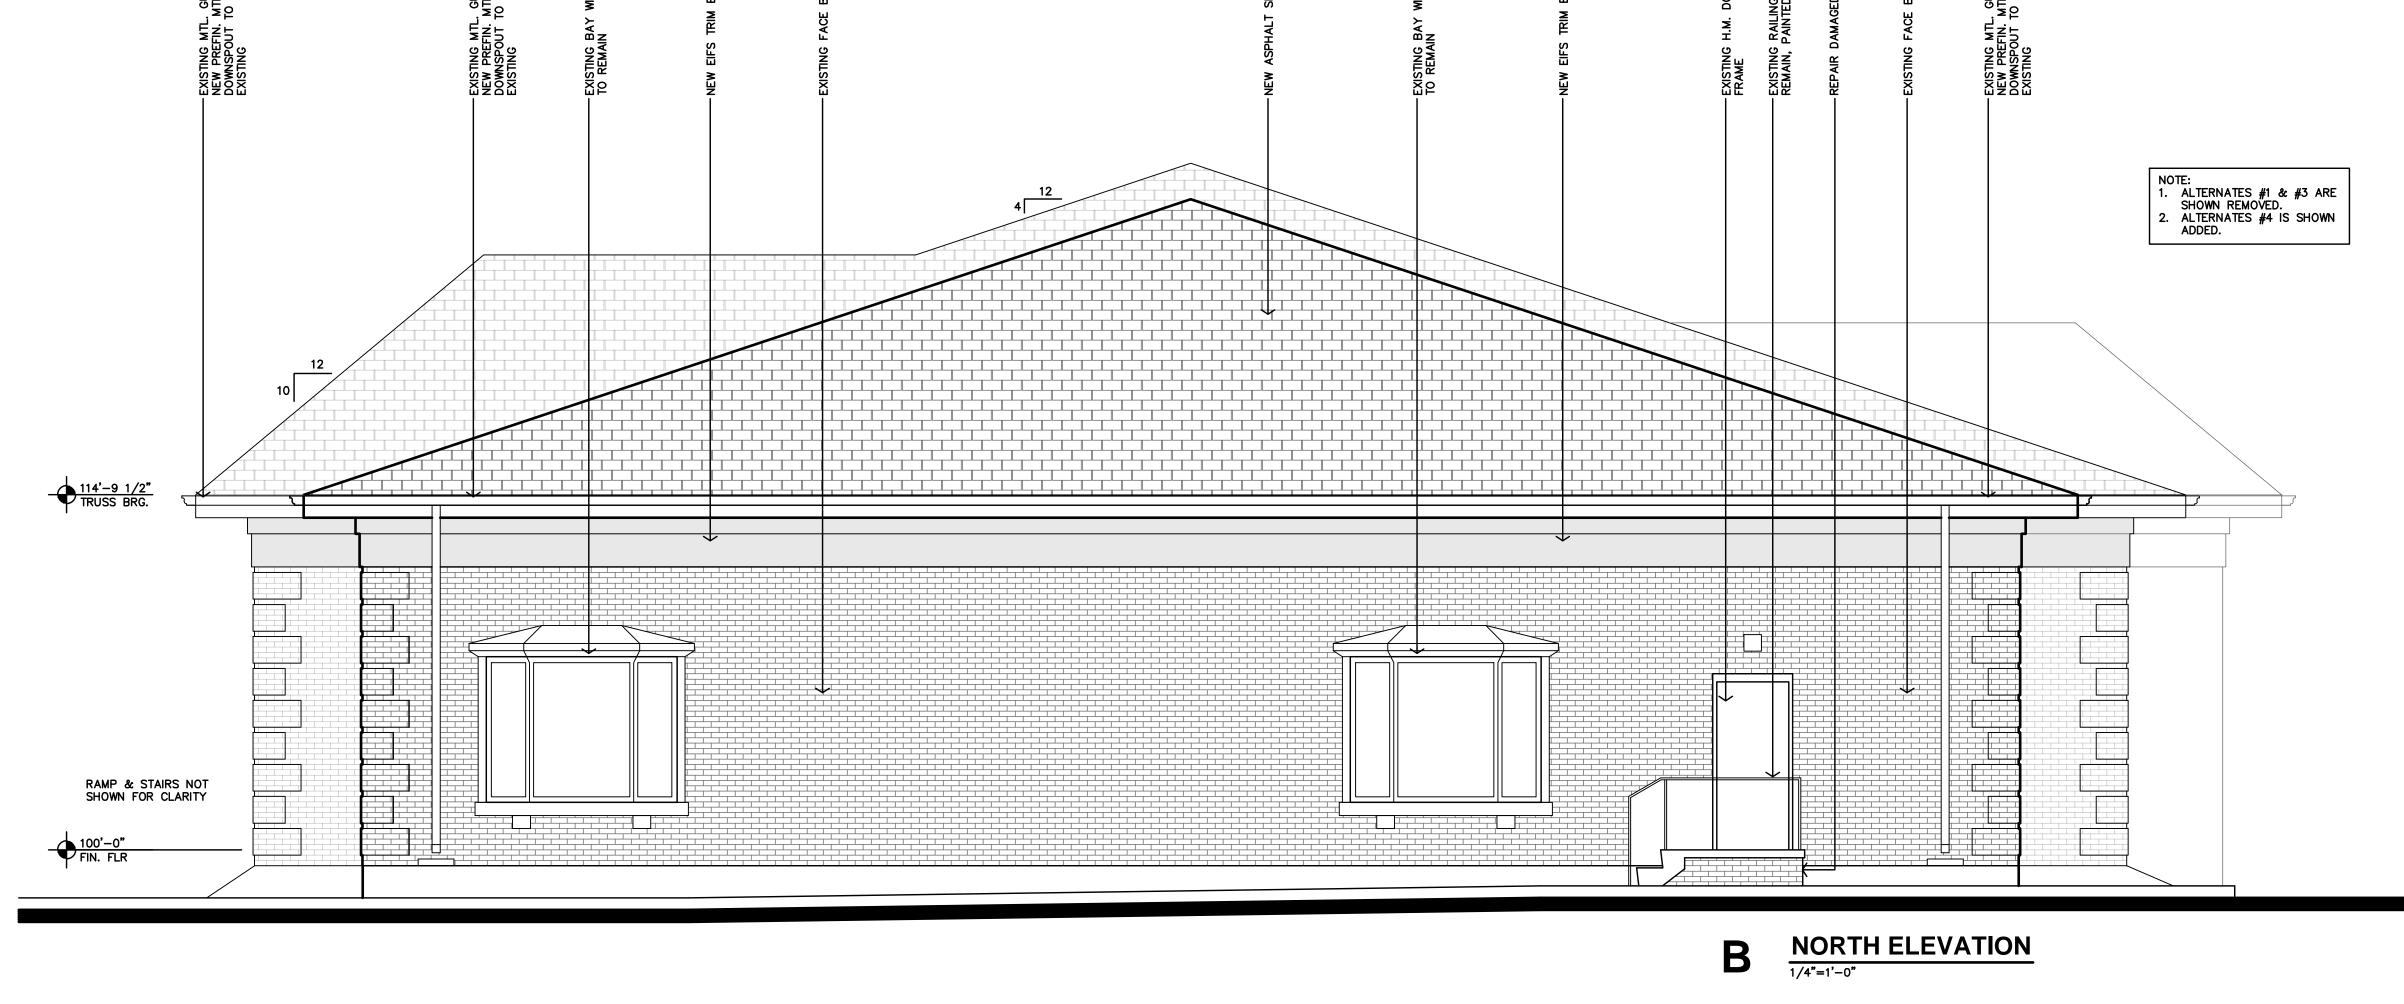

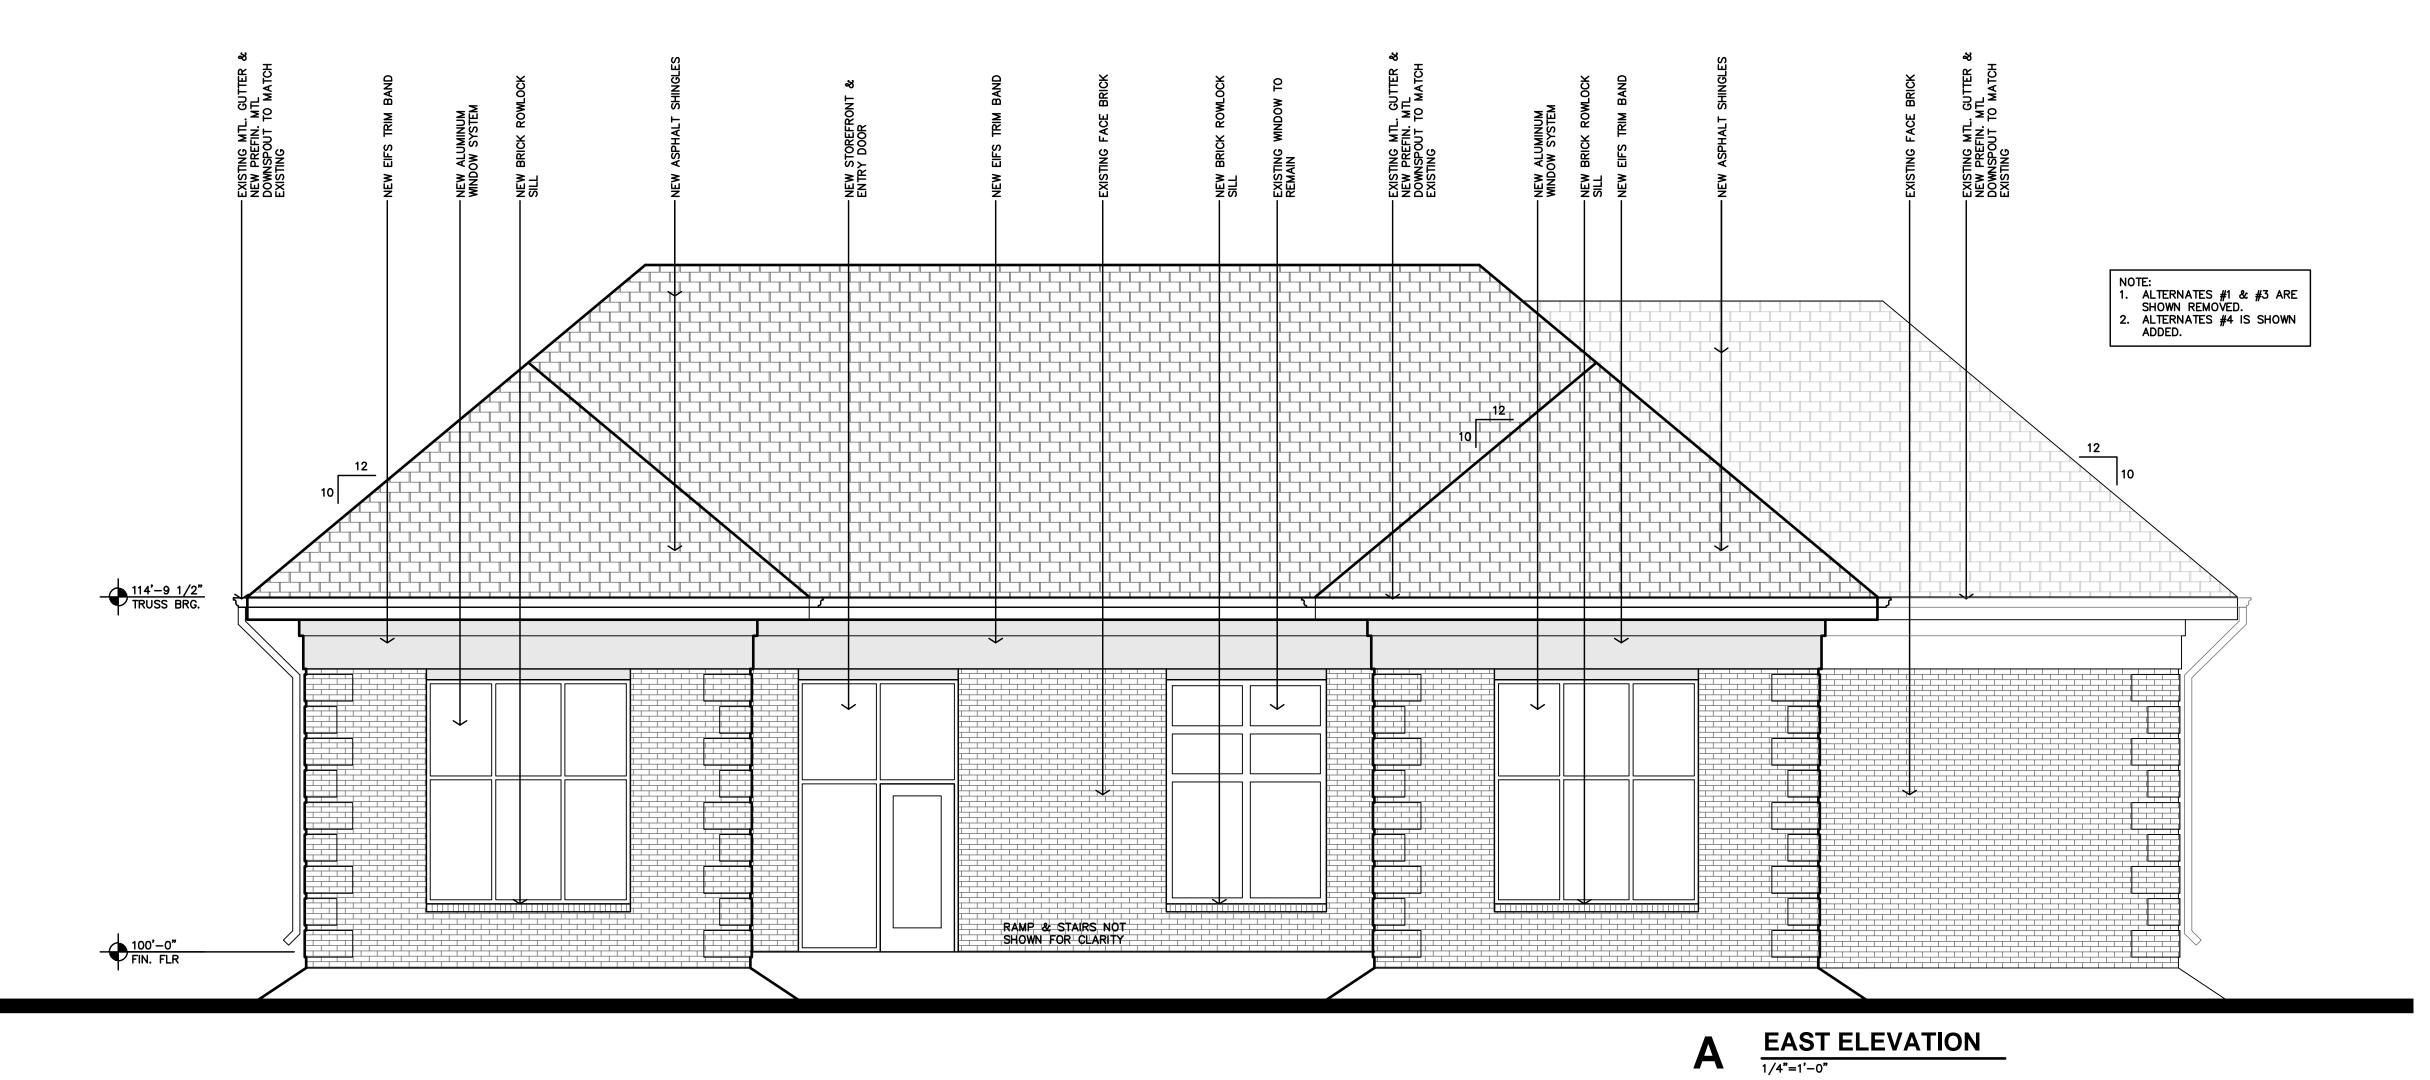
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**A3.2** 



A

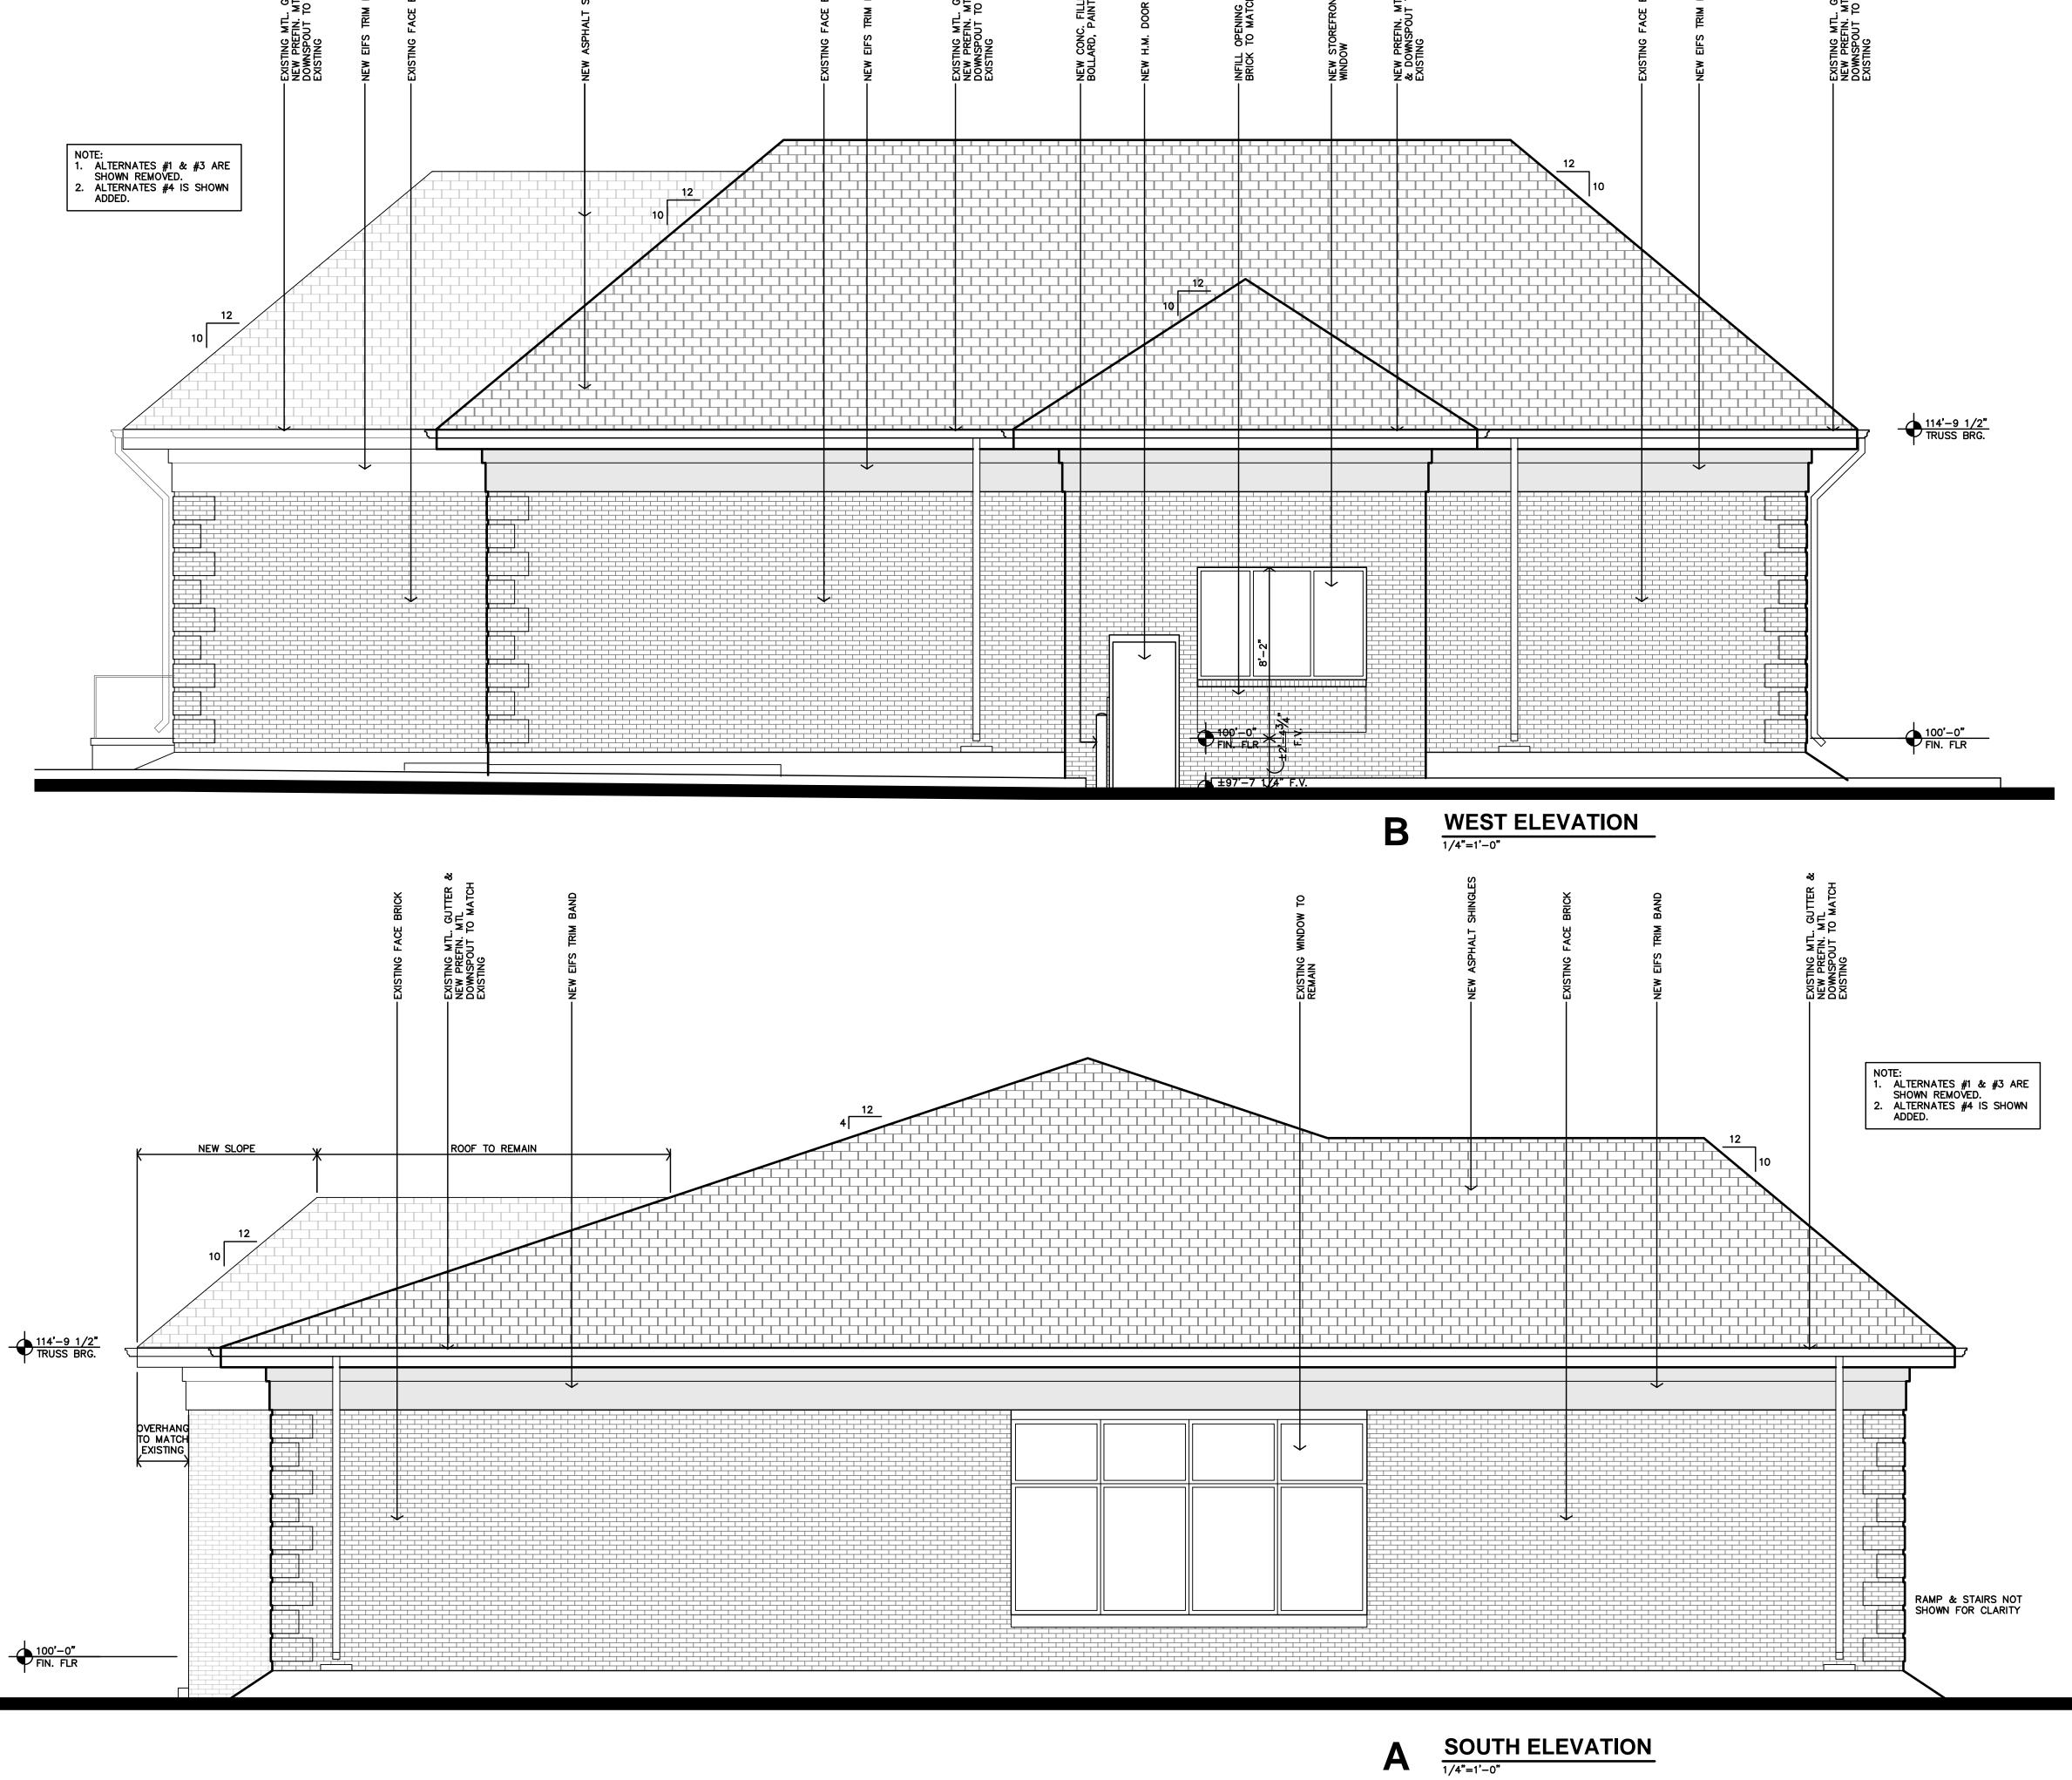

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KANSAS

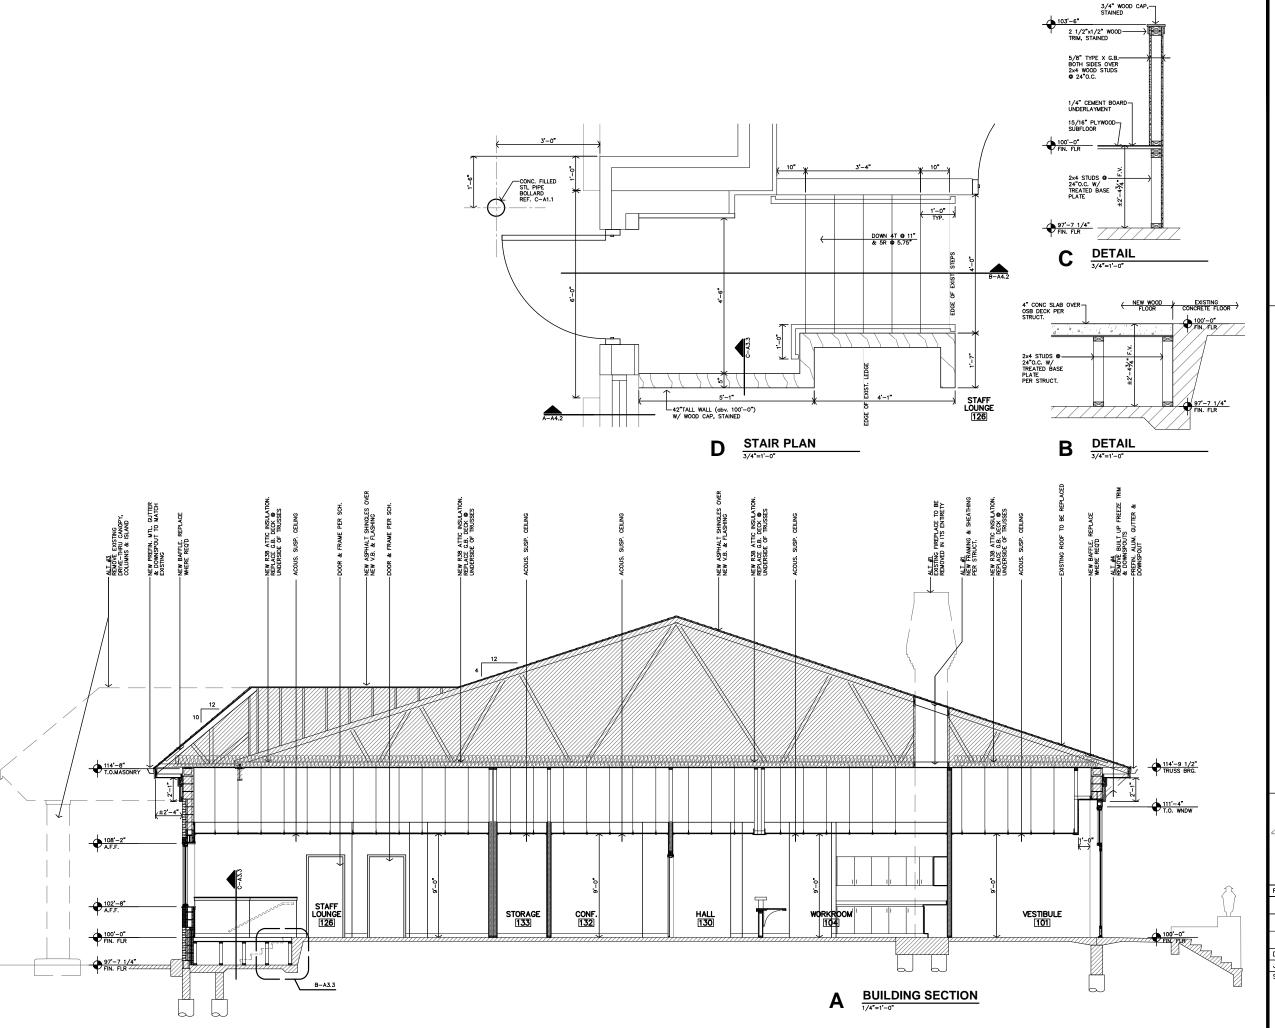FAMILY DENTAL

ROSSVILLE,

ROSSVILLE




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SHEET NO.:

A3.3




GillamRe 1881 Main Street, S

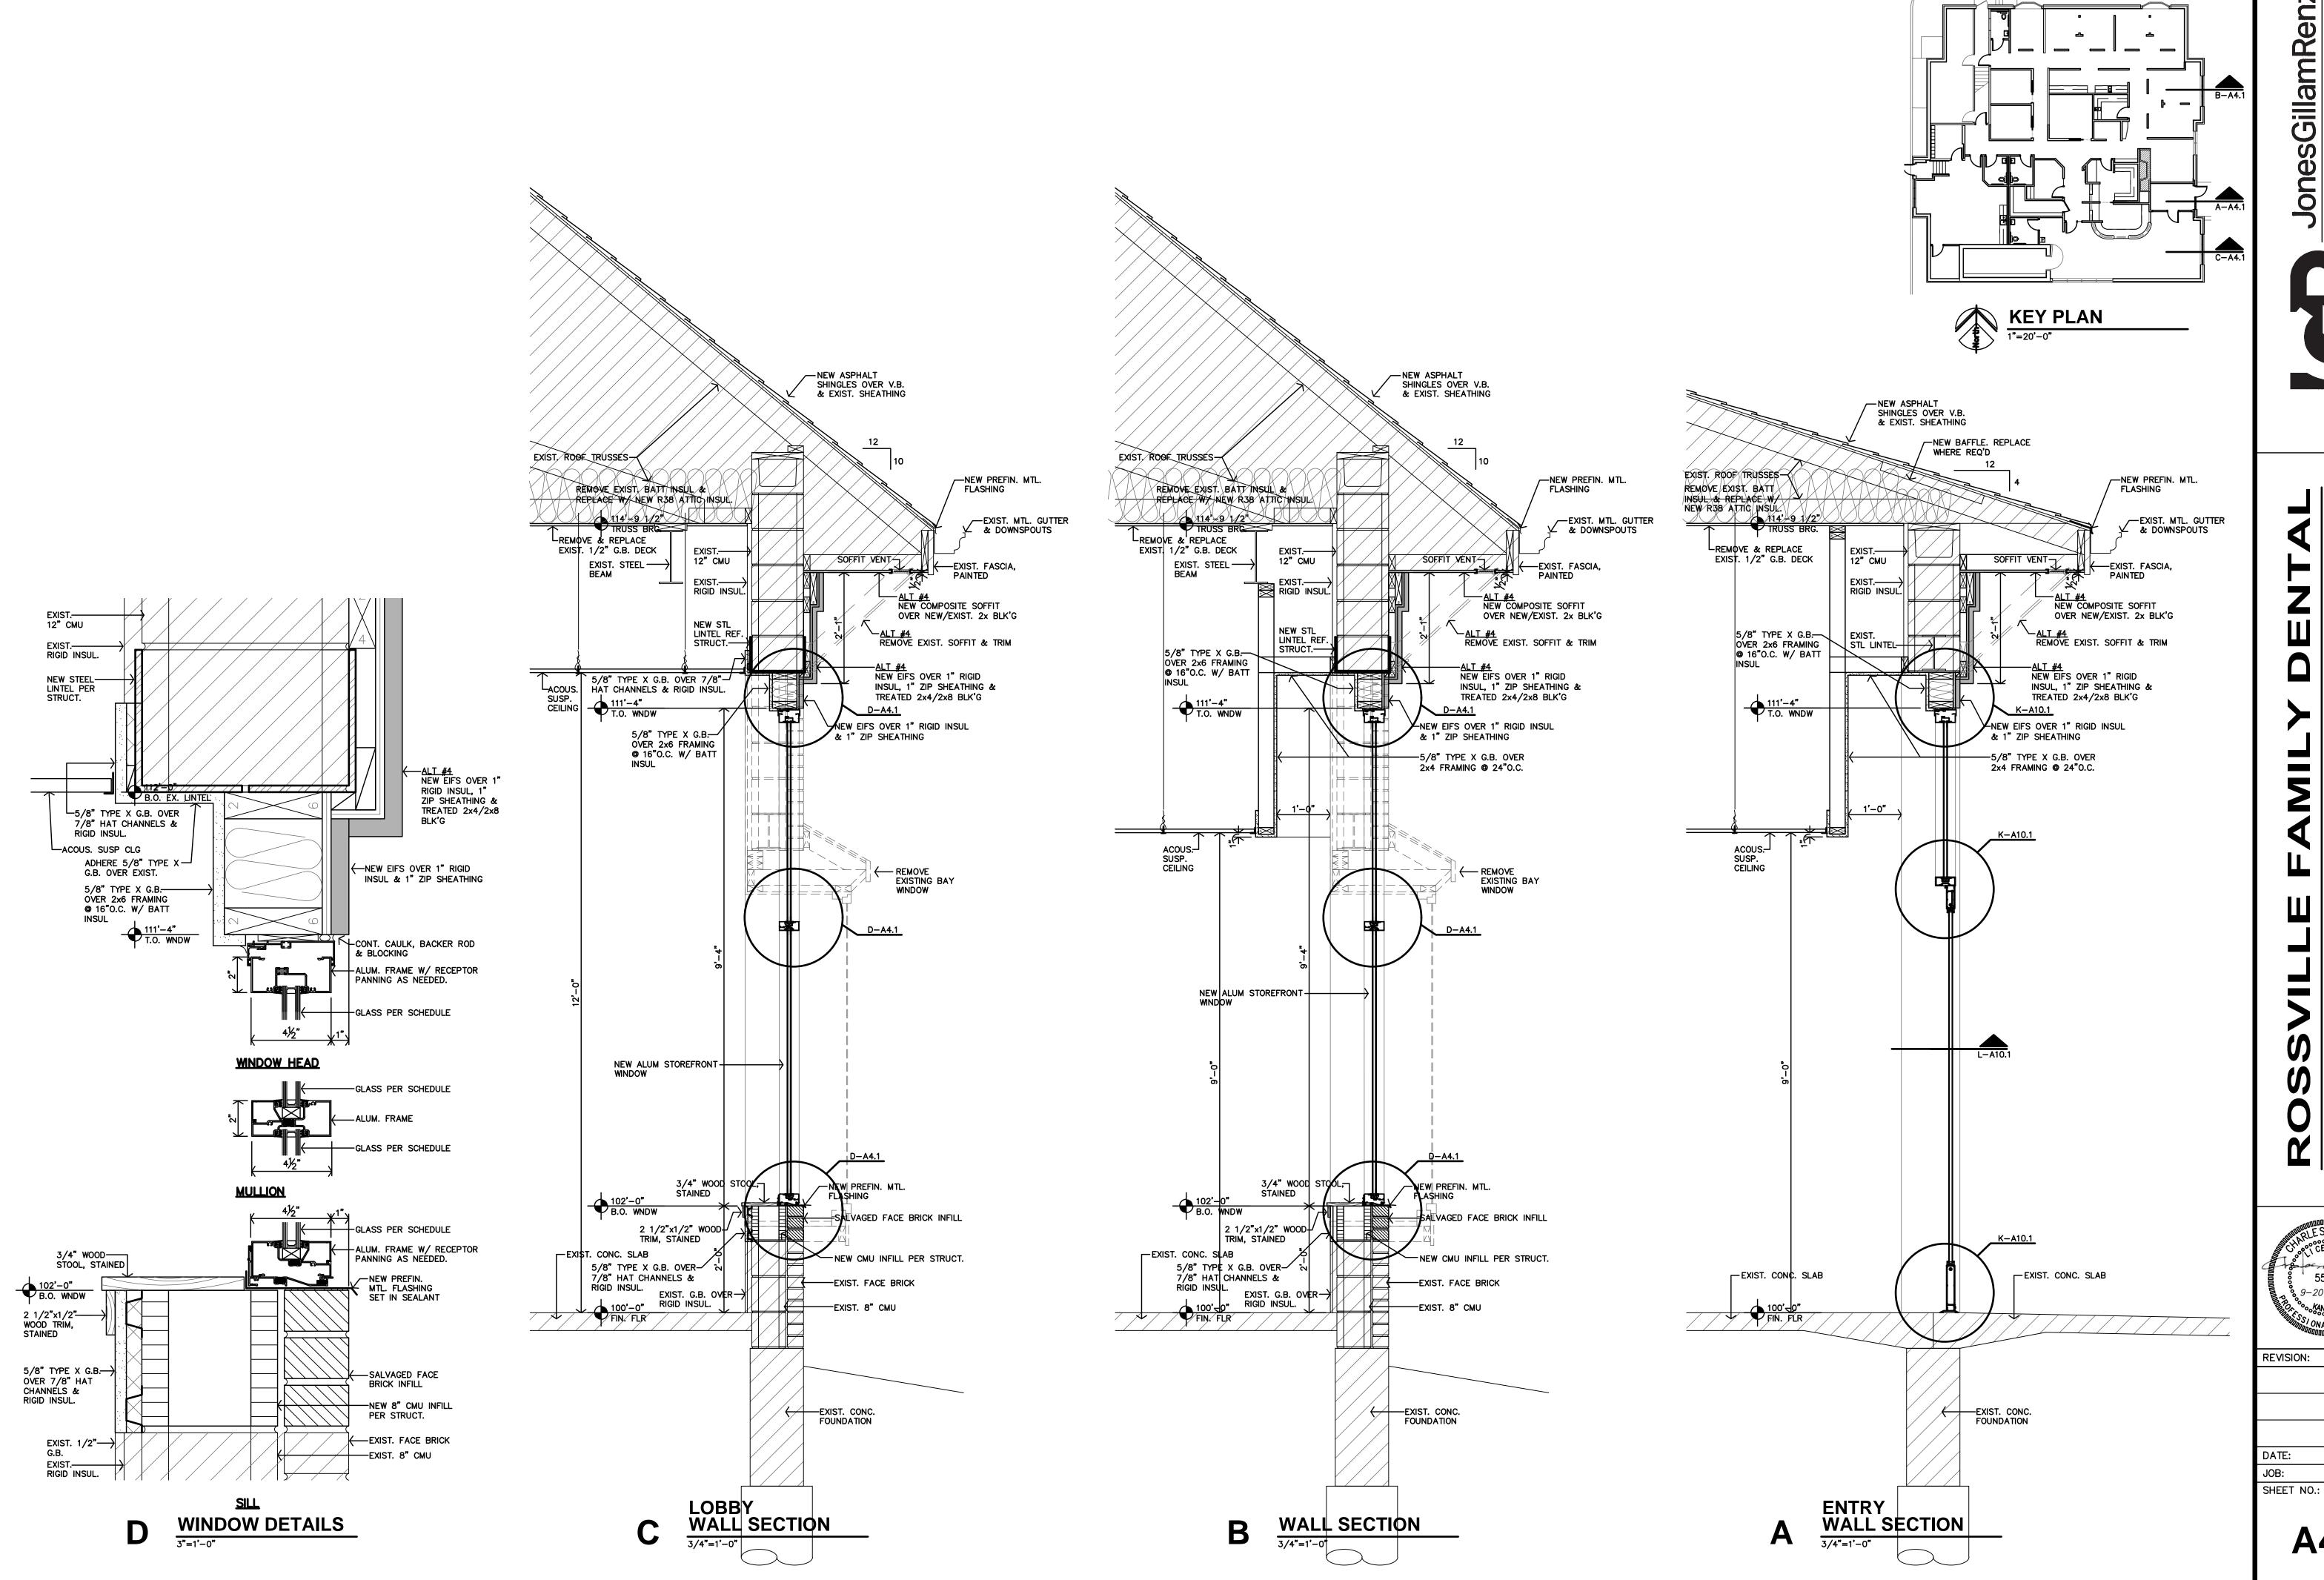
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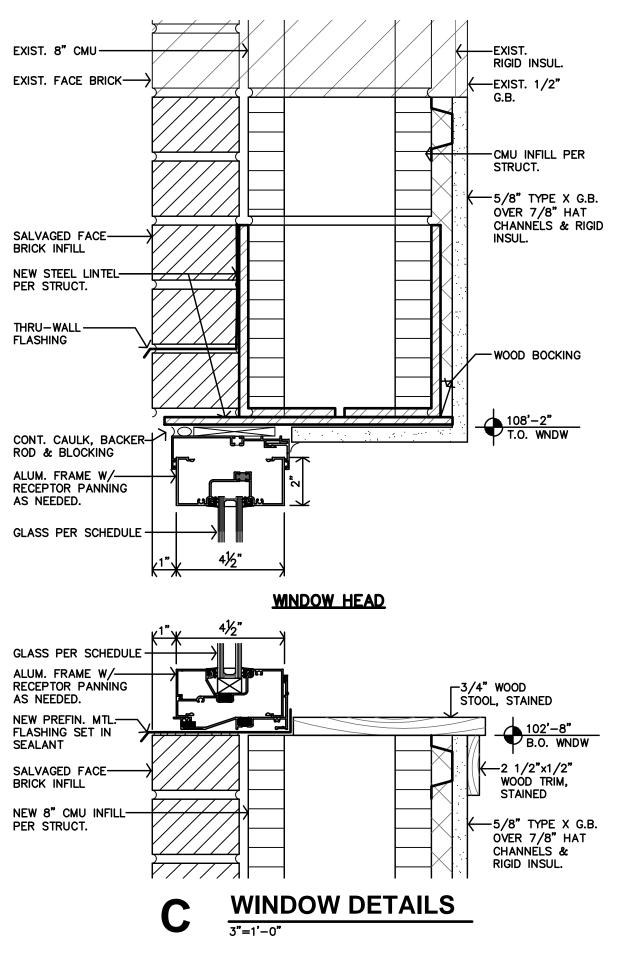
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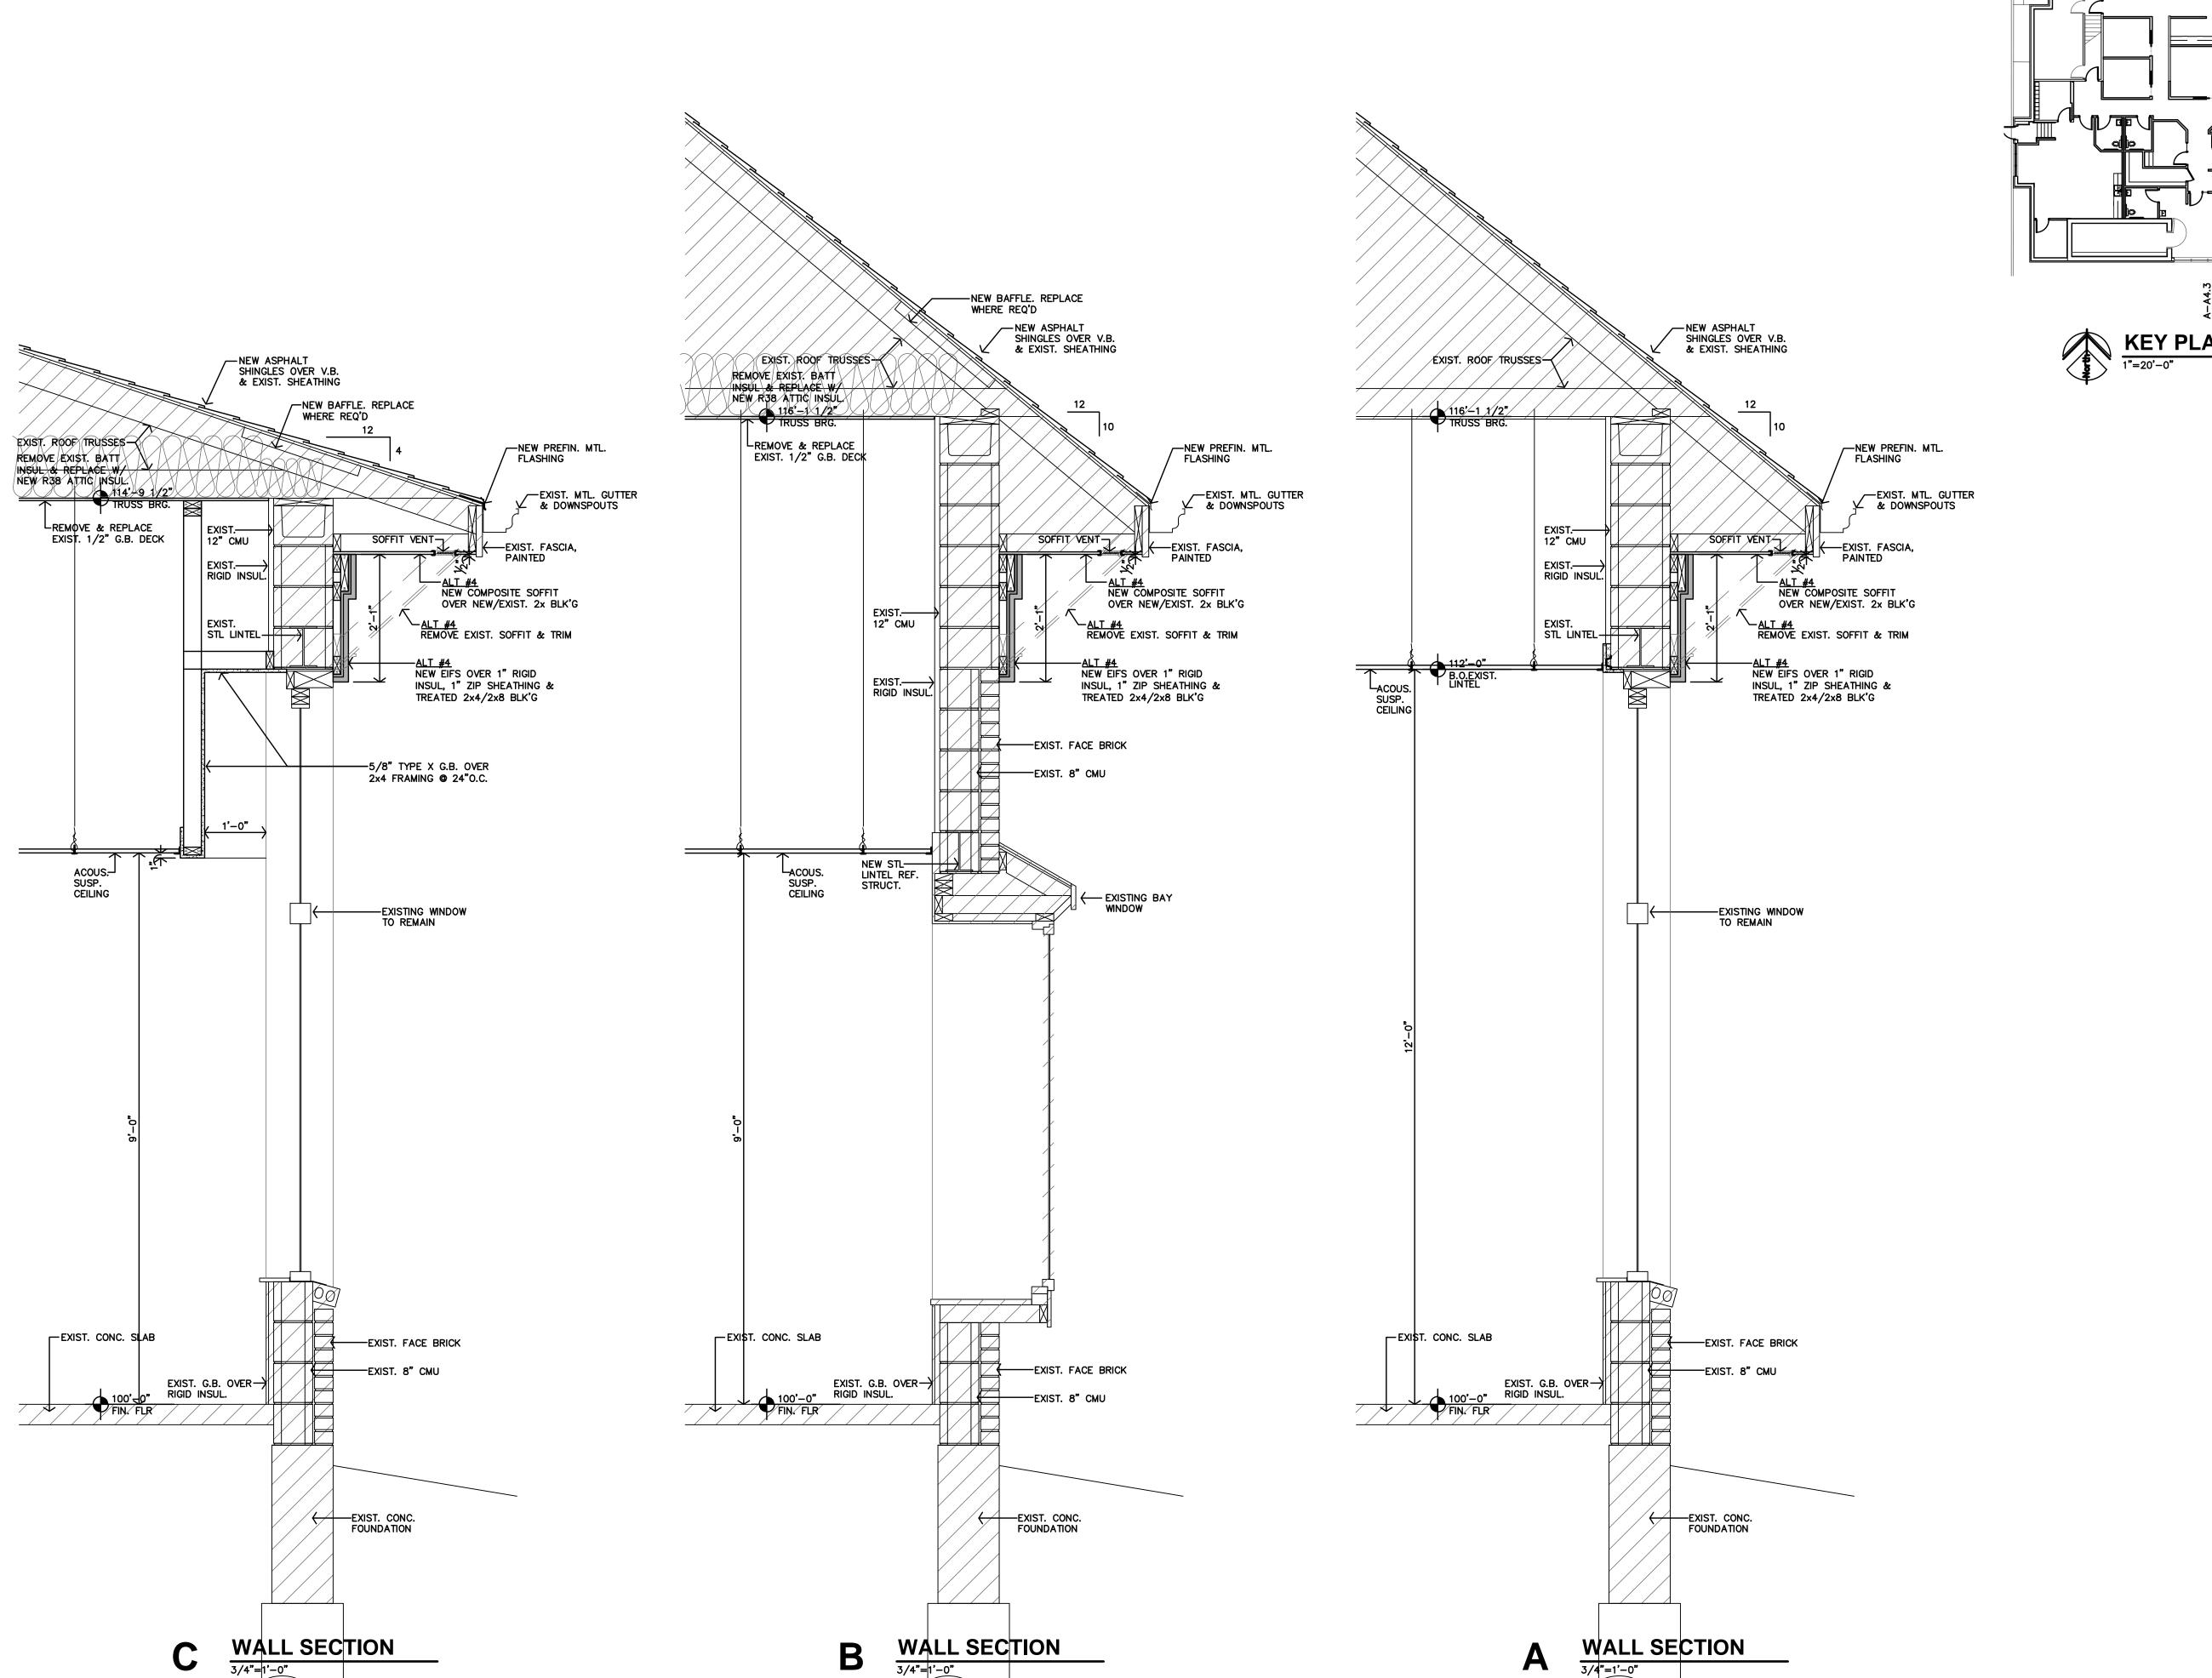
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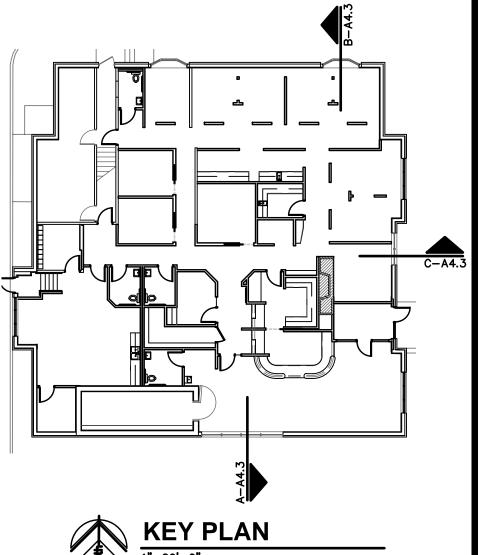
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22-3211





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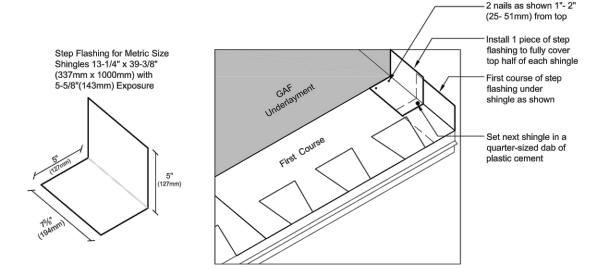
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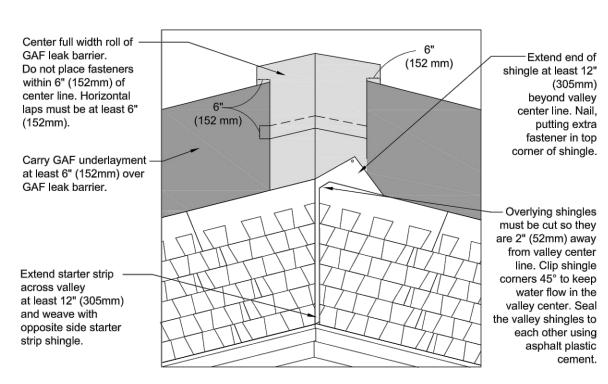
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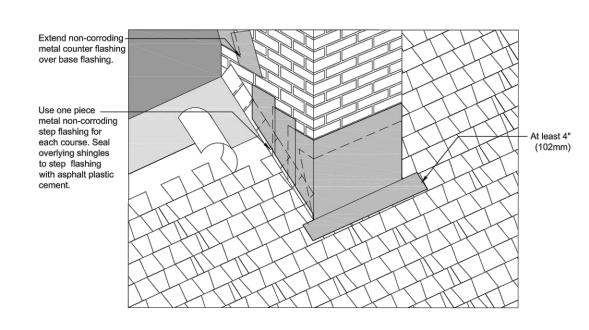
DATE: 9-20-2023 JOB: 22-3211

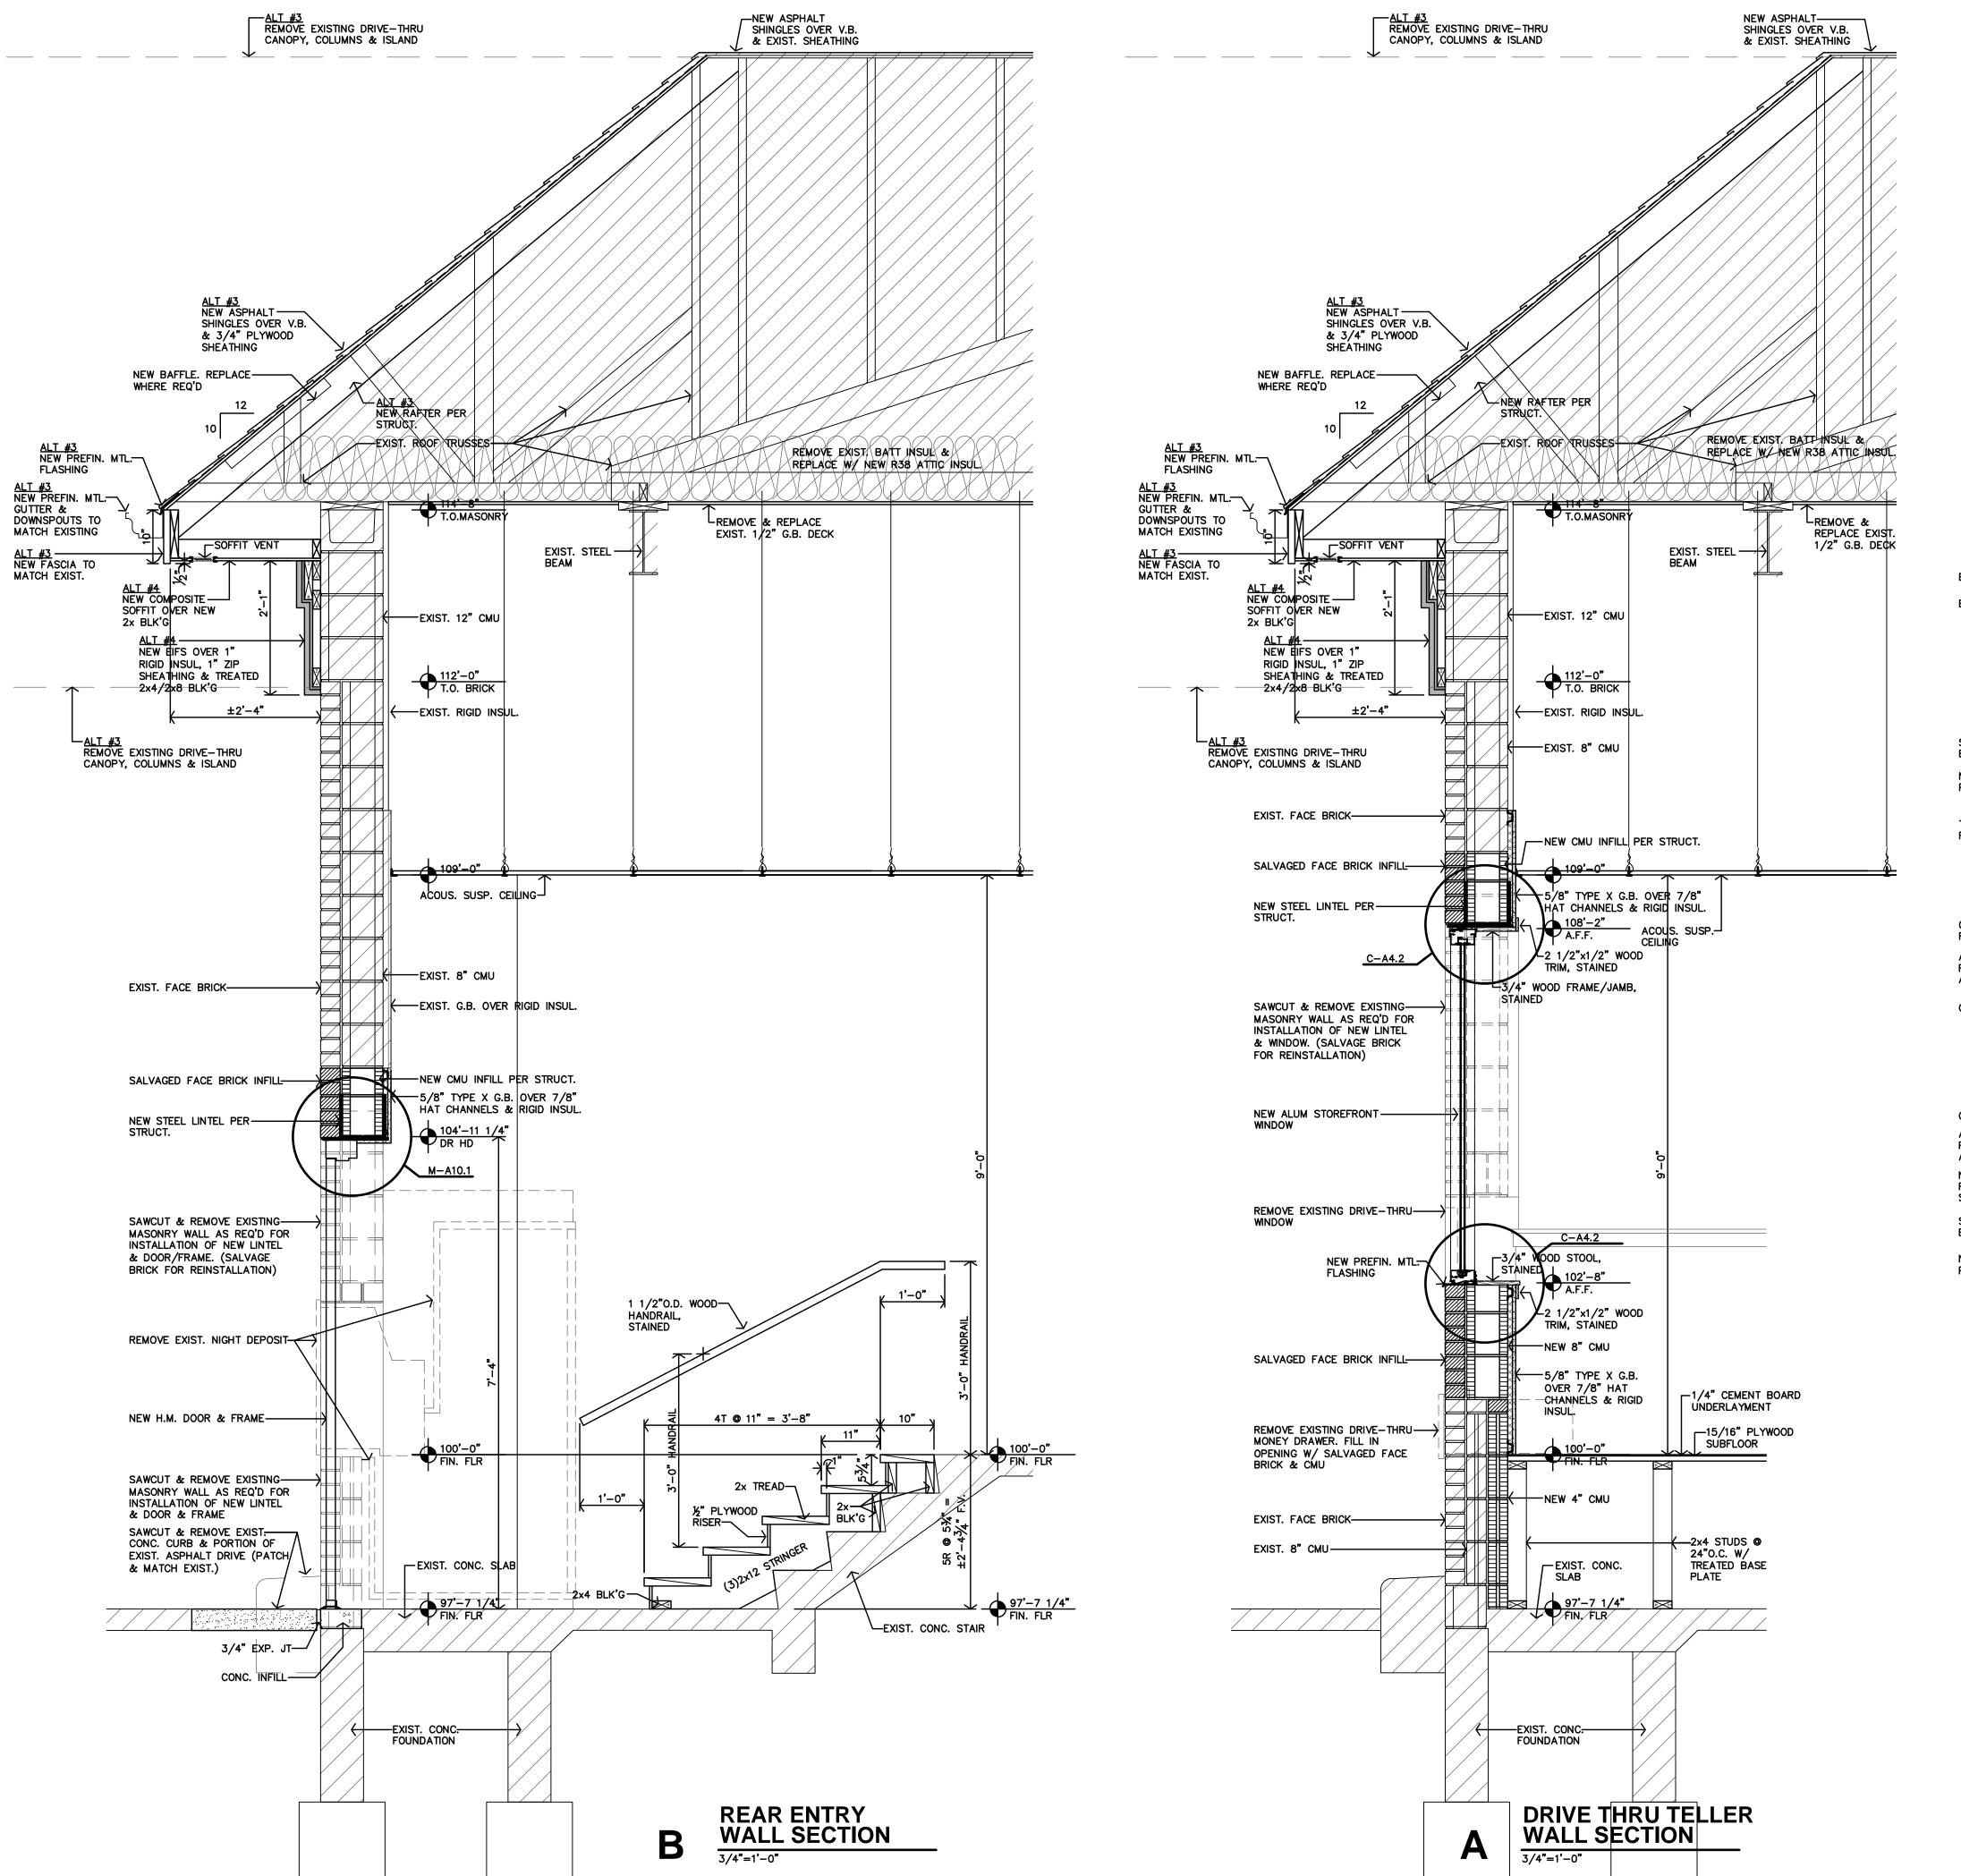
A4.3
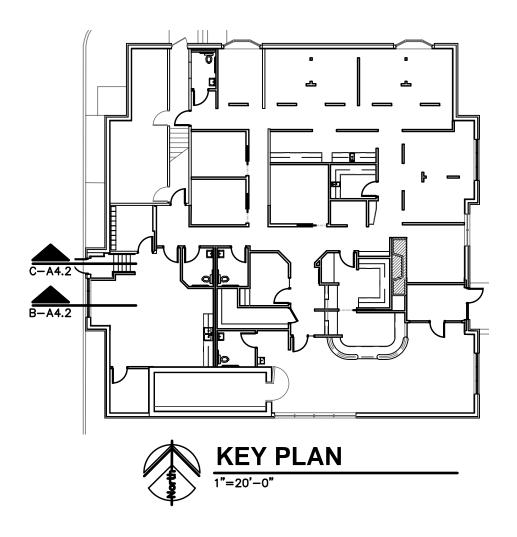
# SHINGLE INSTALLTION







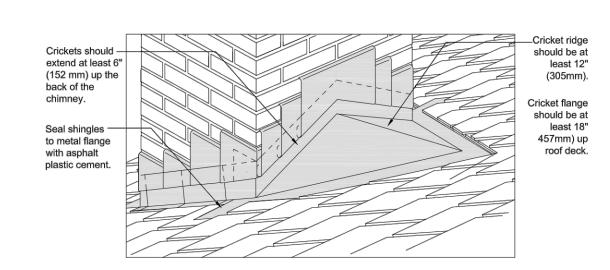

# CHIMNEY CRICKET FLASHING NO SCALE B

# **ROOFING GENERAL NOTES**

CONTRACTOR SHALL FIELD VERIFY ALL DIMENSIONS & CONDITIONS.


MANUFACTURER & INSTALLER SHALL BE RESPONSIBLE FOR TOTAL ROOF SYSTEM INCLUDING TRANSITIONS, FLASHINGS, ETC. TO MAINTAIN WATER TIGHT ROF SYSTEM. SUBMIT MANUFACTURERS AND ROOFING SYSTEMS. SYSTEMS PER THE GENERAL CONDITIONS. MANUFACTURER SHALL WARRANT TOTAL ROOF SYSTEM. REF STRUCTURAL DRAWINGS FOR SHEAR WALL LOCATIONS. PLUMBING VENT STACKS, FLUES, FRESH AIR INTAKES, ETC. NOT SHOW FOR CLARITY. VERIFY LOCATION WITH MECHANICAL & PLUMBING d.s. – INDICATES DOWNSPOUT LOCATIONS.


CONTRACTOR SHALL COORDINATE DOWNSPOUT LOCATIONS & SPLASH PADS. REFERENCE CIVIL DRAWINGS. CONTRACTOR TO PROVIDE & INSTALL BIRD STOP @ RIDGE EAVE & RAKE PER MANUF. REQUIREMENTS & DETAILS. CAULK & SEAL WATERTIGHT ALL JOINTS & TRANSITIONS. 10. ALL METAL MATERIALS (I.E. VALLEYS, FLASHINGS, ETC...) SHALL BE PER MANUFACTURES SPECS OR RECOMMENDATIONS AND PRE-FINISHED GALVANIZED OR ALUM. ZINC ALLOY. ALL FASTENERS MUST BE COMPATIBLE WITH ASSOCIATED METALS/MATERIALS. METALS MUST BE INSTALLED PER SMACNA'S "ARCHITECTURAL SHEET METAL MANUAL." CONTRACTOR TO USE NAILS FOR FASTENING SHINGLES, OR ROOF PANELS AND SYSTEMS. STAPLES ARE NOT ALLOWED. 2. CONTRACTOR MUST COMPLY WITH ALL STATE & LOCAL CODES & 3. CONTRACTOR TO INSTALL ICE & WATER SHIELD @ ALL RIDGE, HIP, VALLEY, SLOPE TRANSITIONS & METAL FLASHING

# **ROOFING DETAIL NOTES**

. REFERENCE TYPICAL MANUFACTURER'S DETAILS ACTUAL CONDITIONS MAY VARY, REFER AND COORDINATE W/ BUILDING DETAILS PROVIDING THE MANUFACTURER'S MOST STRINGENT REQUIREMENTS, RECOMMENDATIONS, NECESSARY TO ACHIEVE COMPLETE WATERTIGHT WARRANTY.

CONTRACTOR SHALL ASSUME THAT AREAS OF EXISTING ROOF DECK WILL REQUIRE REPLACEMENT, CONTRACTOR SHALL INCLUDE ALL LABOR AND MATERIAL FOR REPLACEMENT OF 700 S.F. OF PLYWOOD DECKING AND ASSOCIATED COMPONENTS IN THE BASE BID. ADDITIONAL REPLACEMENT SHALL BE ON A T&M BASIS.

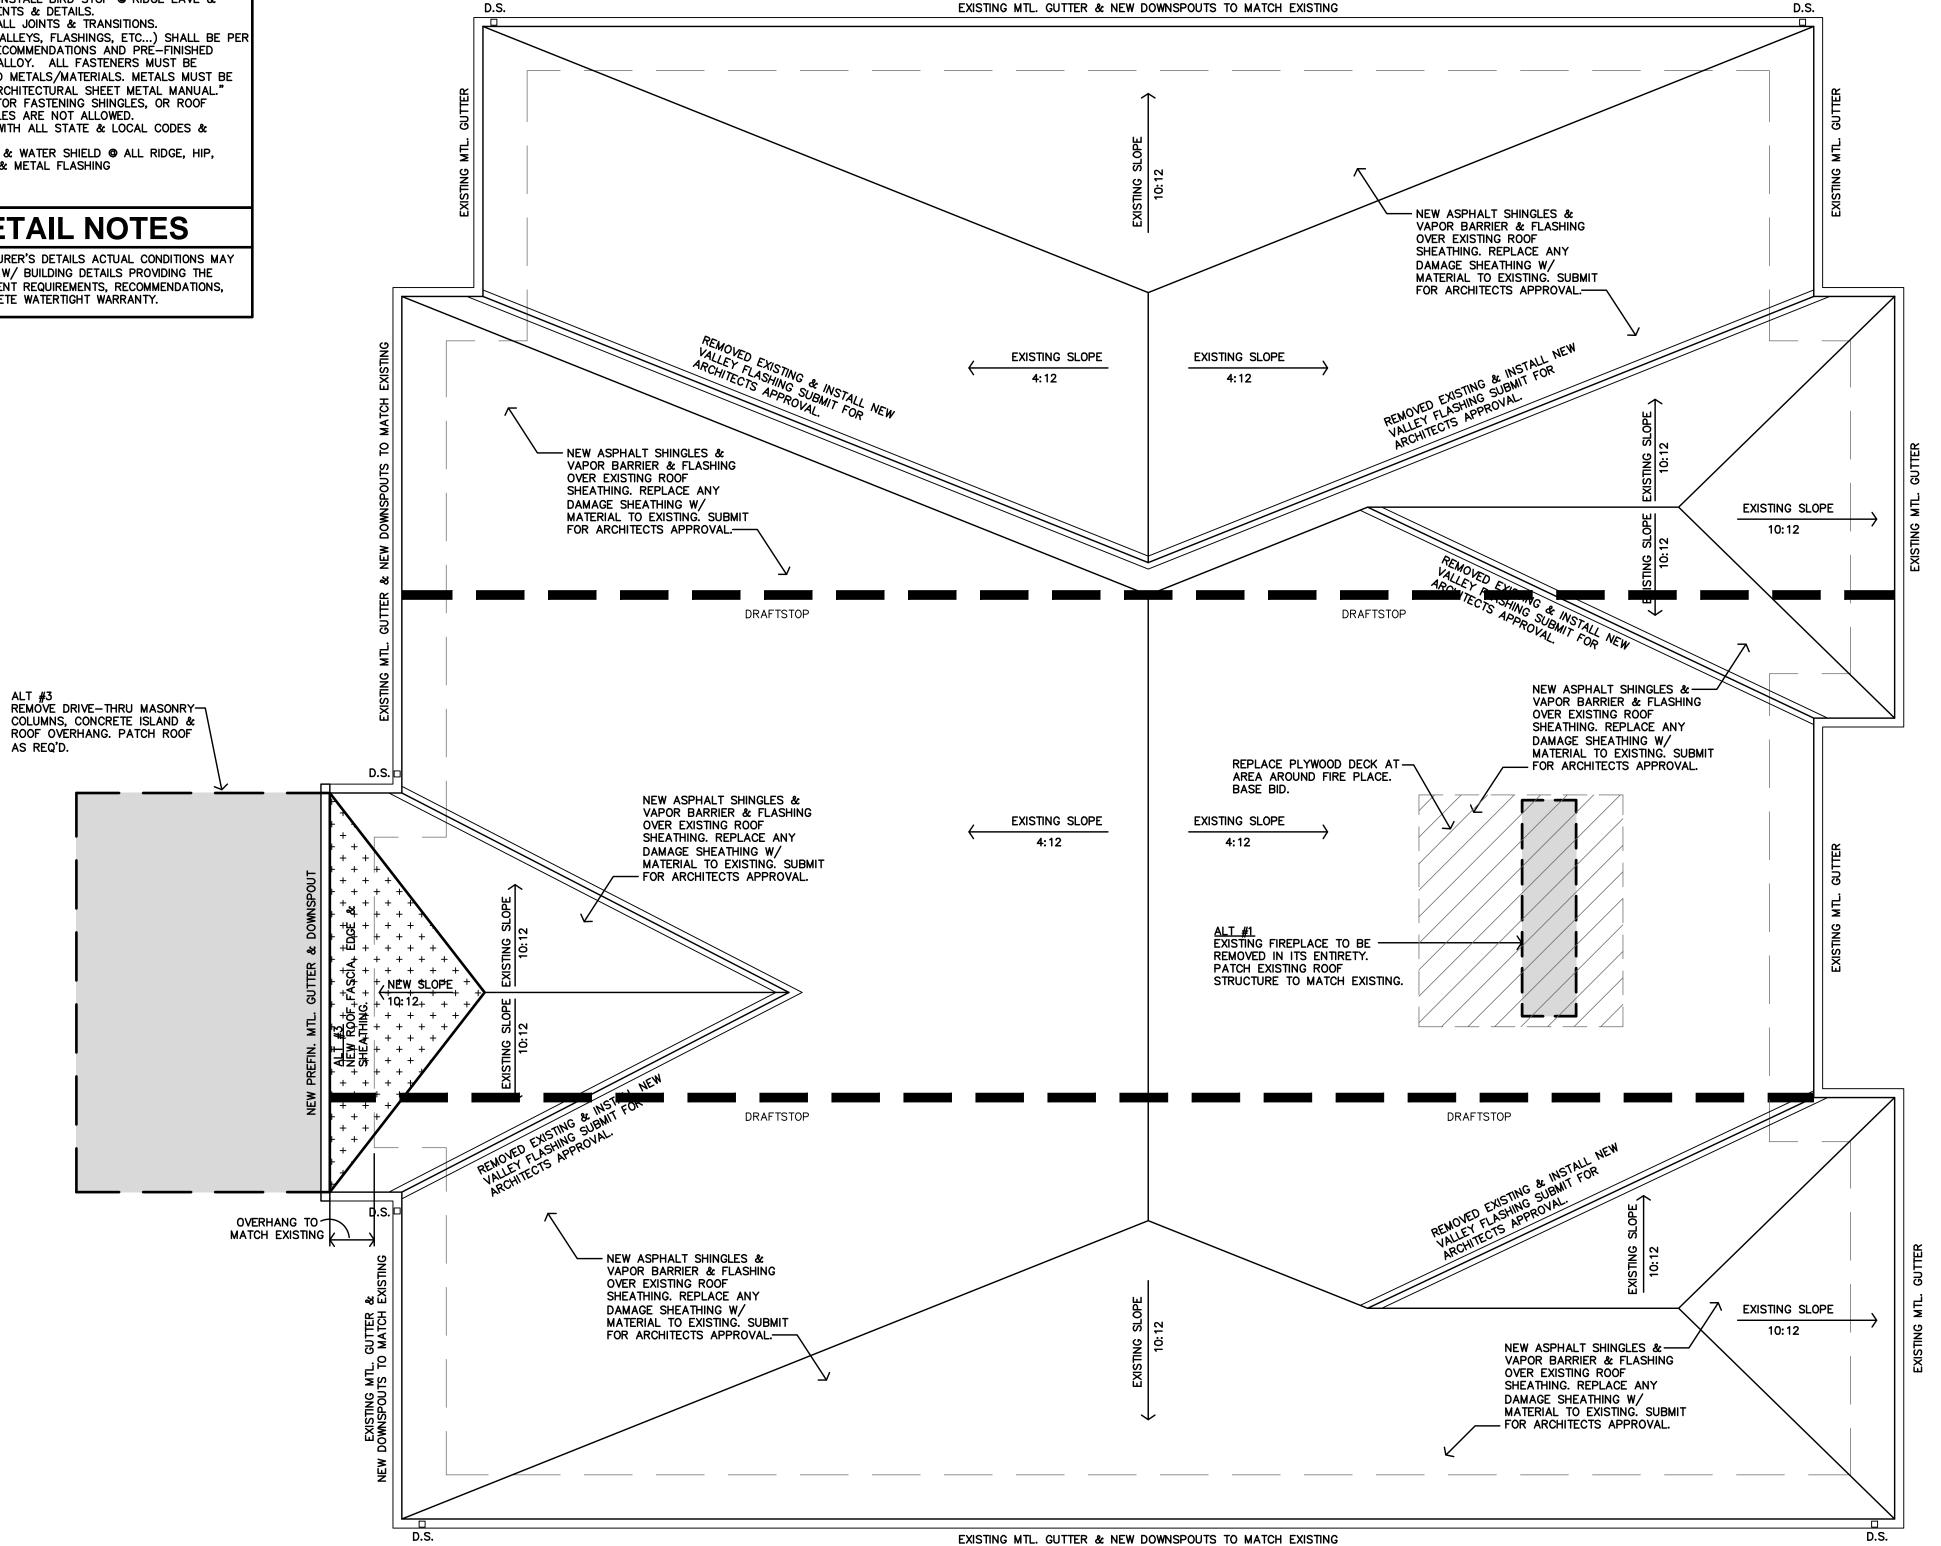


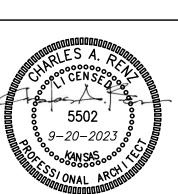

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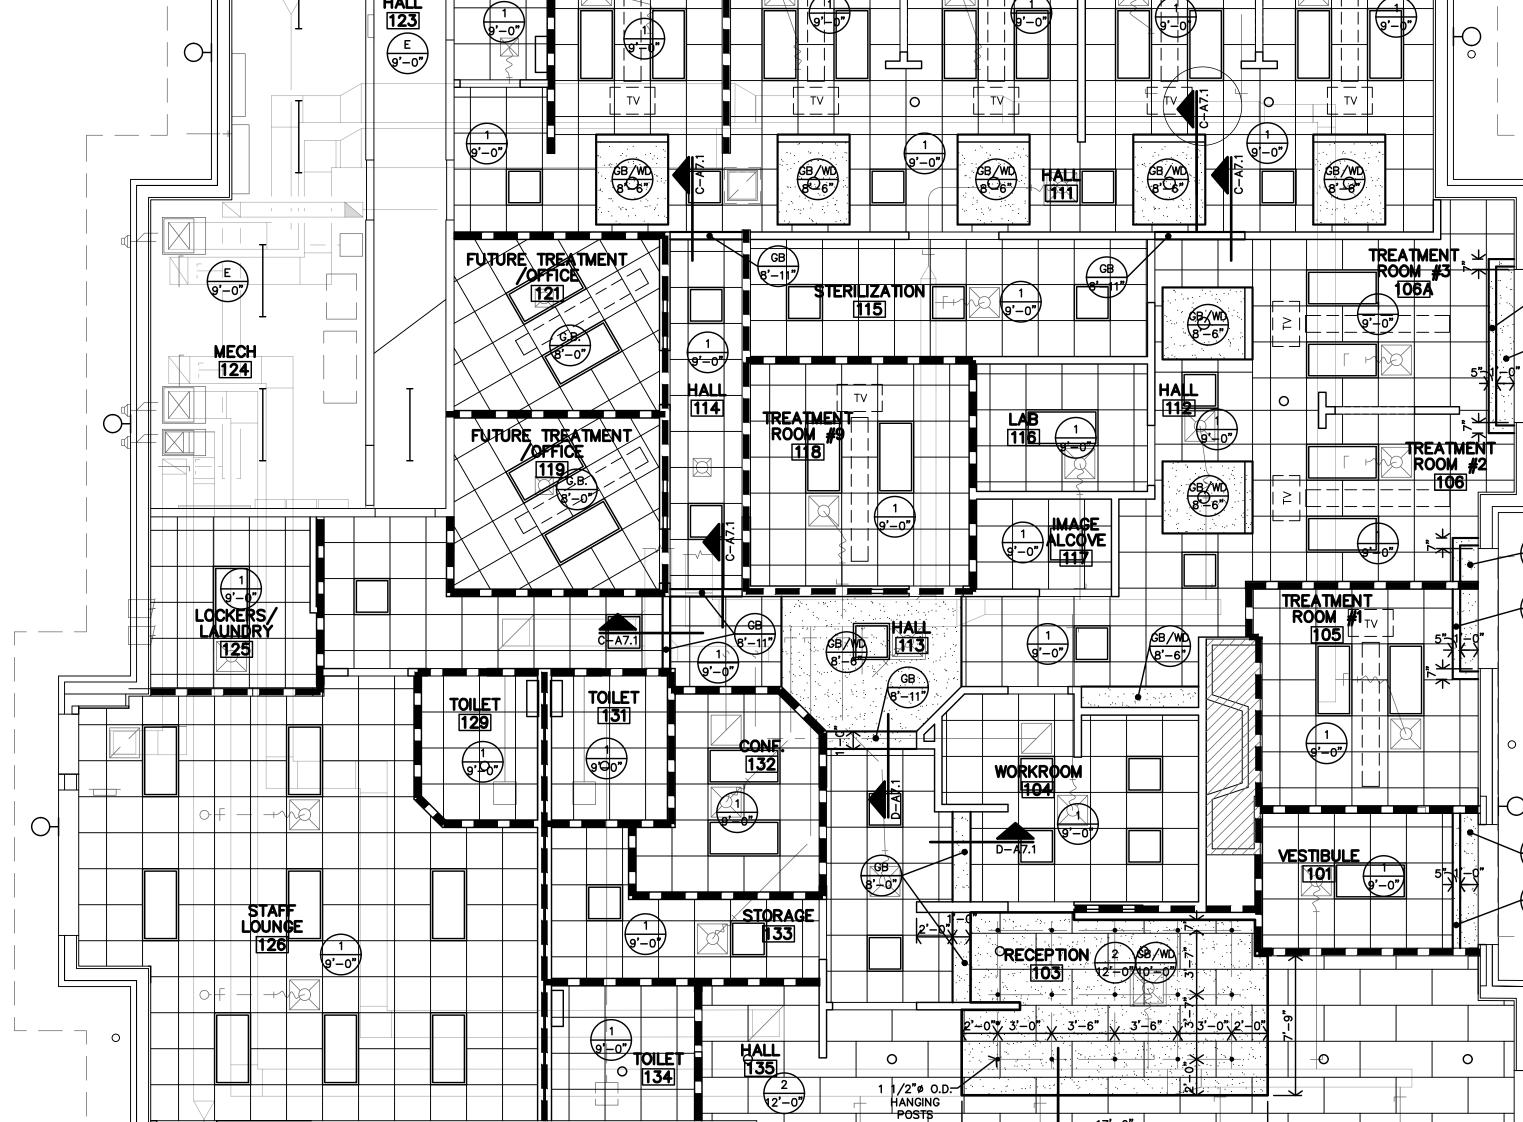
**A5.1** 



**REVISION:** 

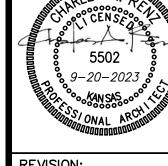9-20-2023 22-3211 SHEET NO.:

**A7.1** 



TREATMENT

ROOM #7

TREATMENT

ROOM #8

TREATMENT

ROOM #6

TREATMENT ROOM #4

ROOM #5

17'-0"

CENTER ON RECEPTION DESK BELOW


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REFLECTED CEILING PLAN
3/16"=1'-0"

0

KIDS AREA

LOBBY/WAITING

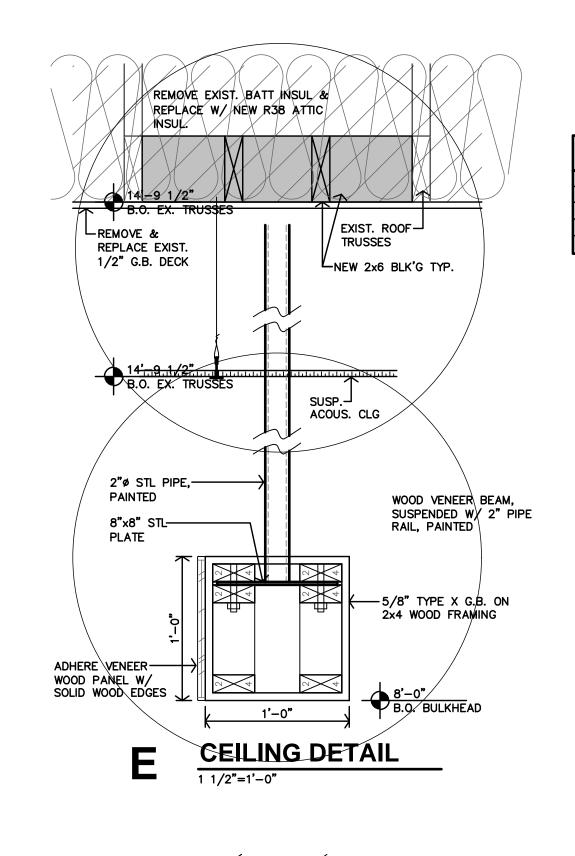

→ 45° BRACING © 48" Q.C.- ALT. DIRECTIONS

—— 5/8" TYPE "X" G.B. OVER 4" STUDS @ 16" Q.C.

G.B. CEILING ON STUDS

© 16" O.C.

→ 45° BRACING • 48" • C.- ALT. DIRECTIONS

— 5/8" TYPE "X" G.B.
OVER 4" STUDS

G.B. CEILING ON STUDS

16" O.C.


**CEILING DETAIL** 


CEILING DETAIL


1 1/2"=1'-0"


EXTEND FRAMING TO-UNDERSIDE OF STRUCT.

EXTEND FRAMING TO ;

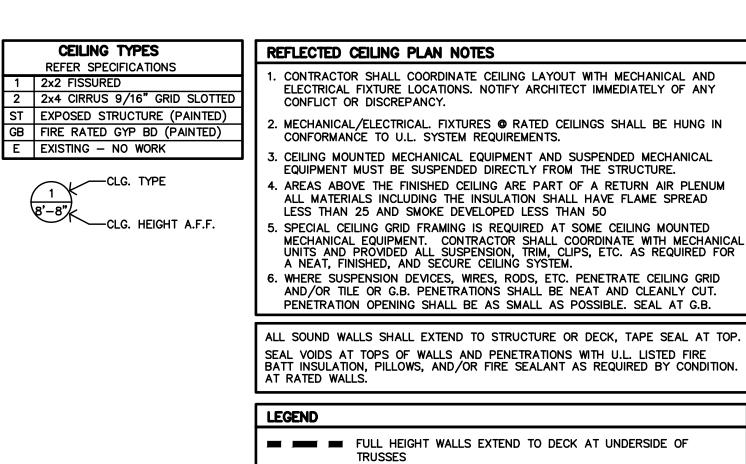

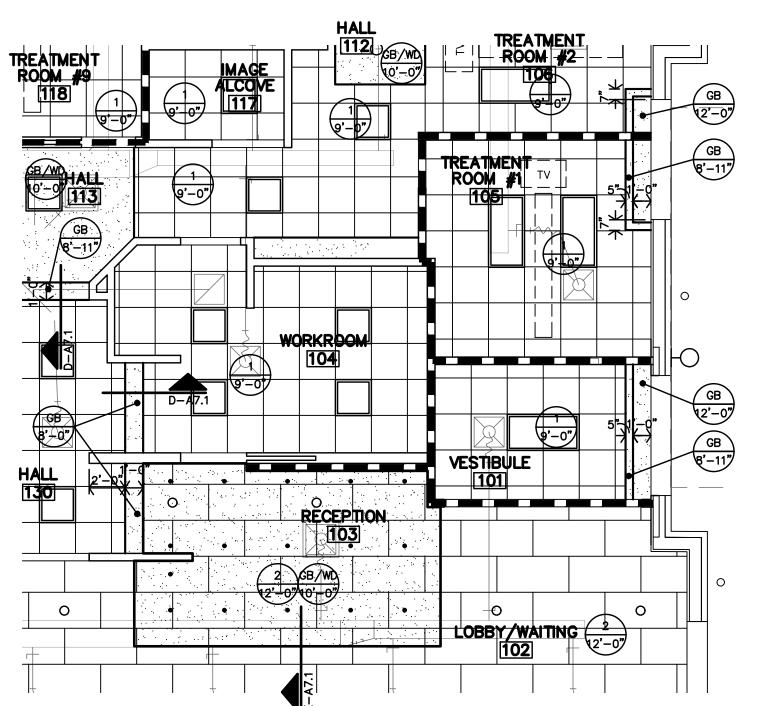

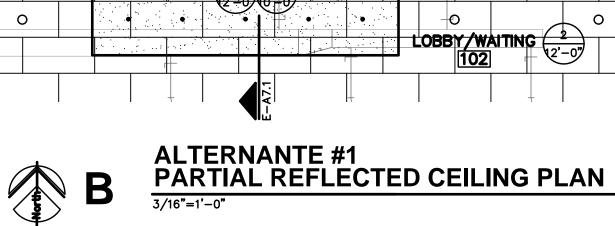


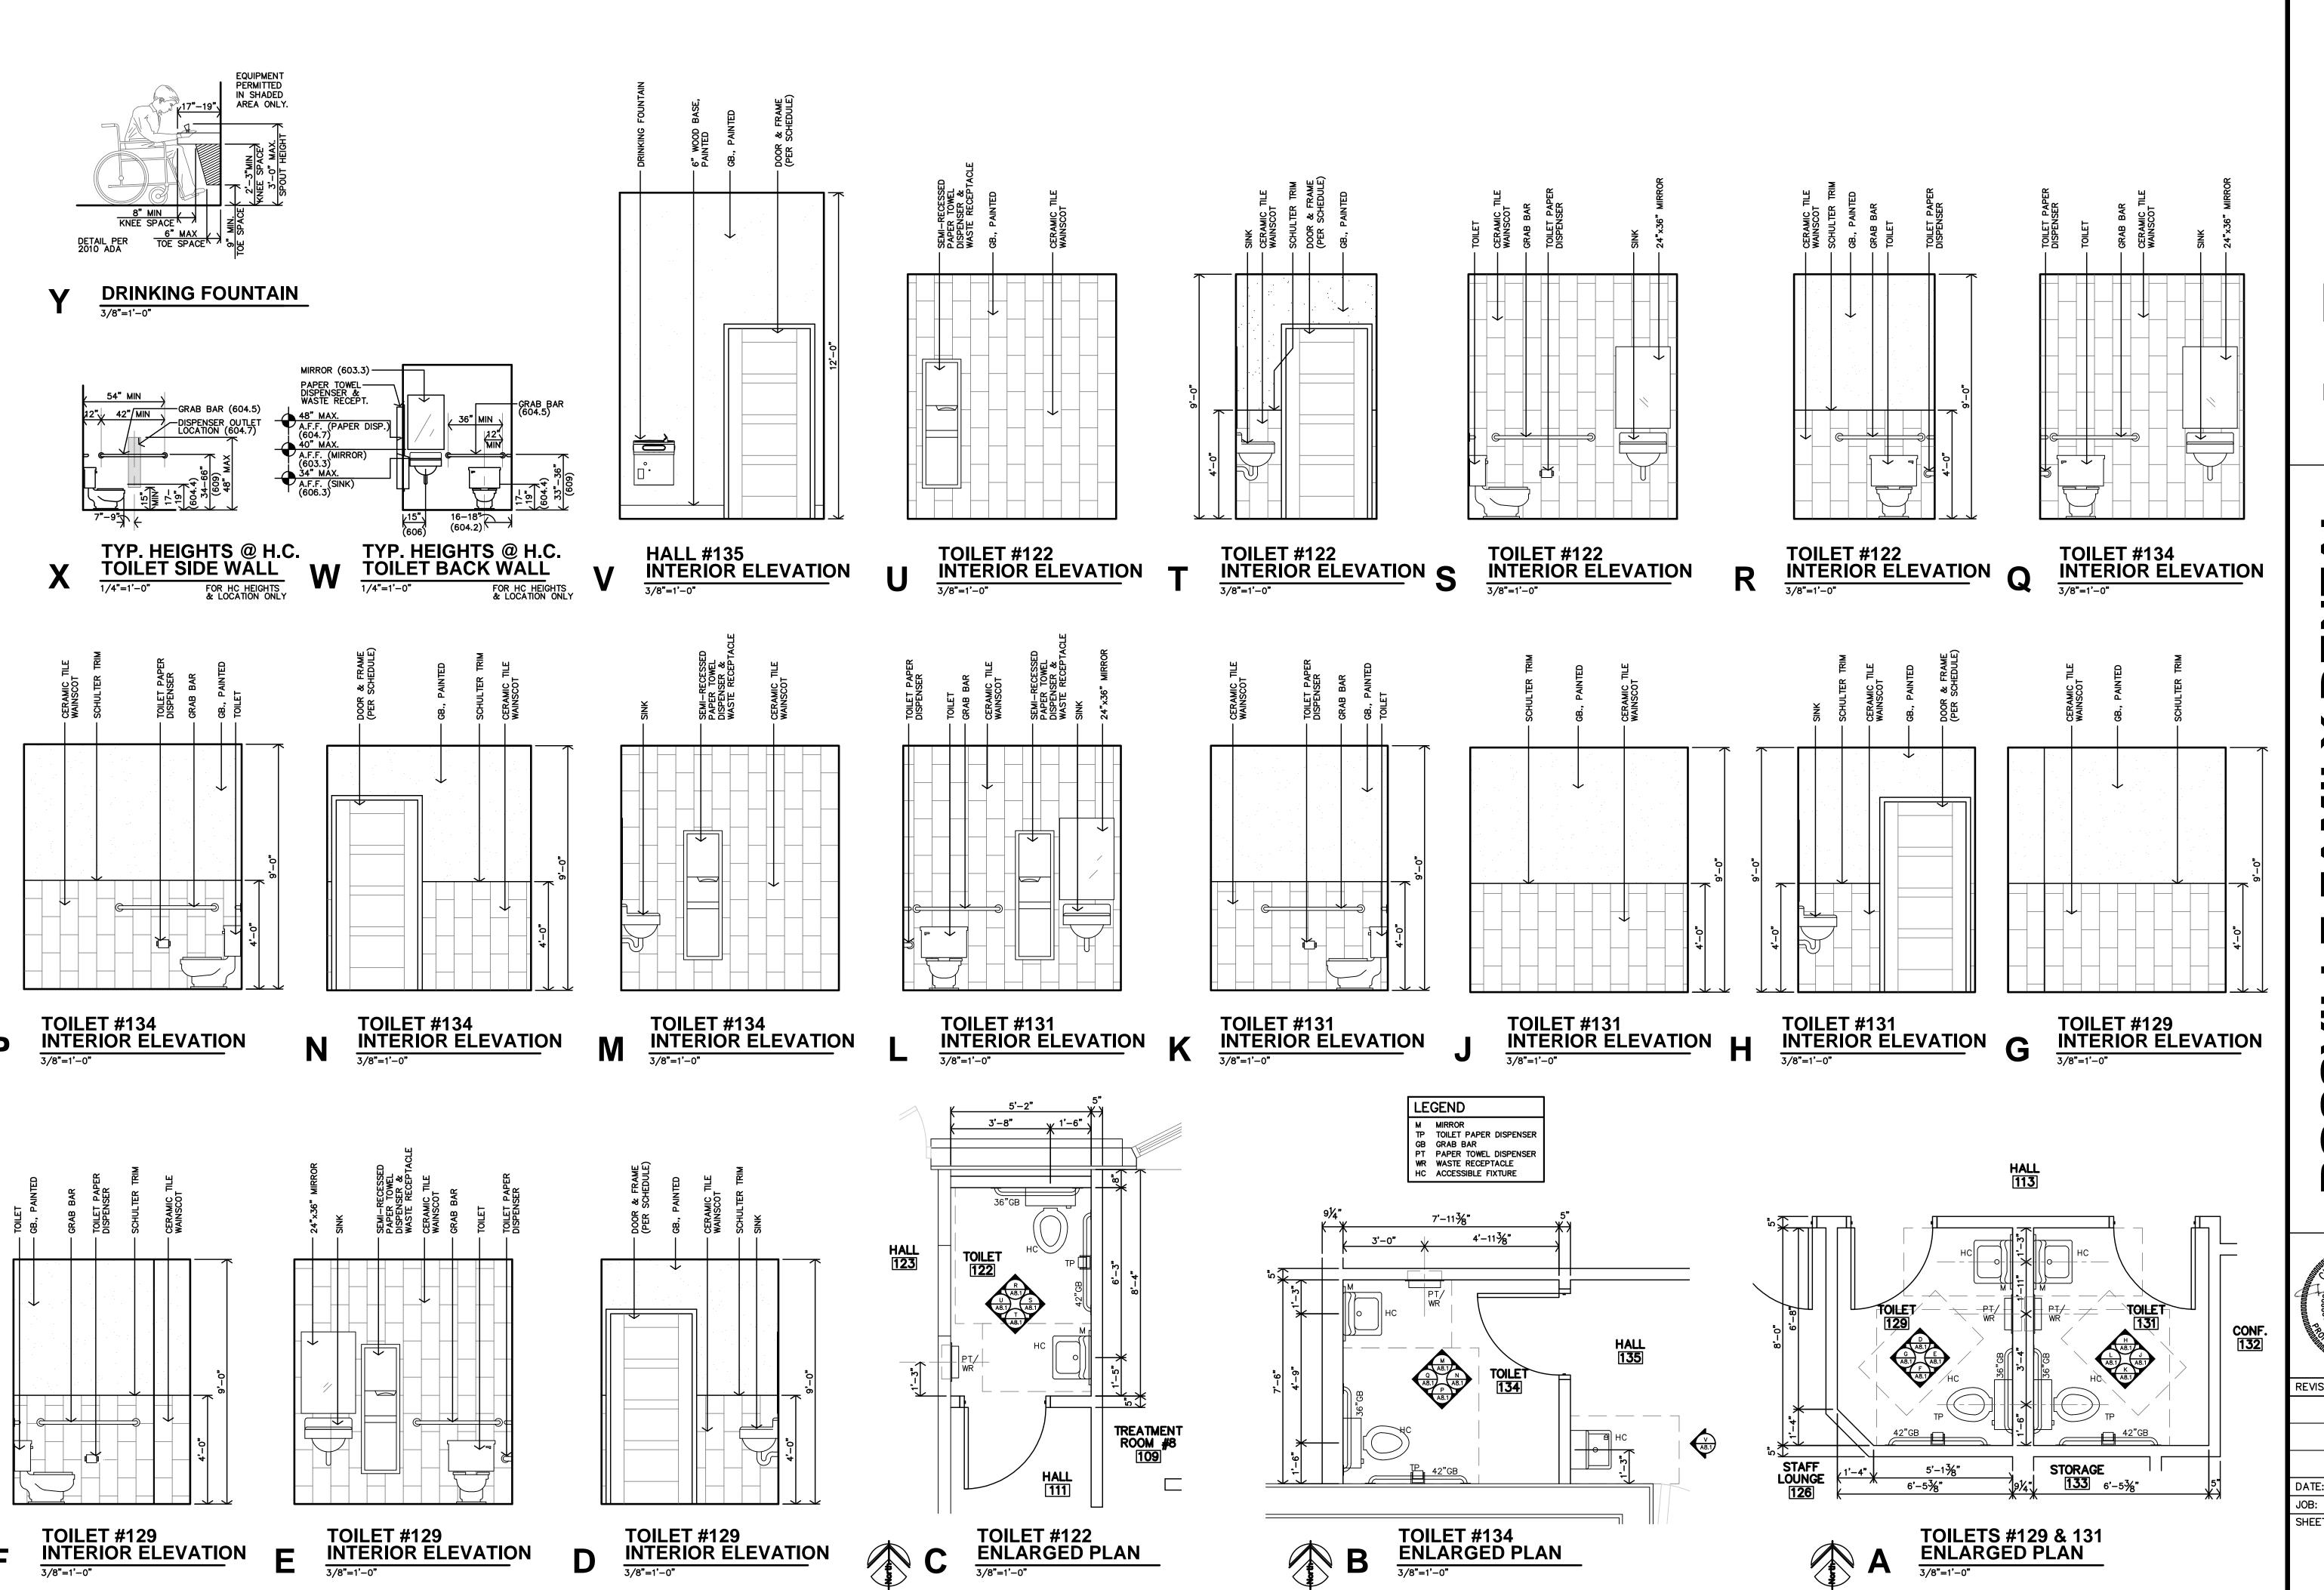

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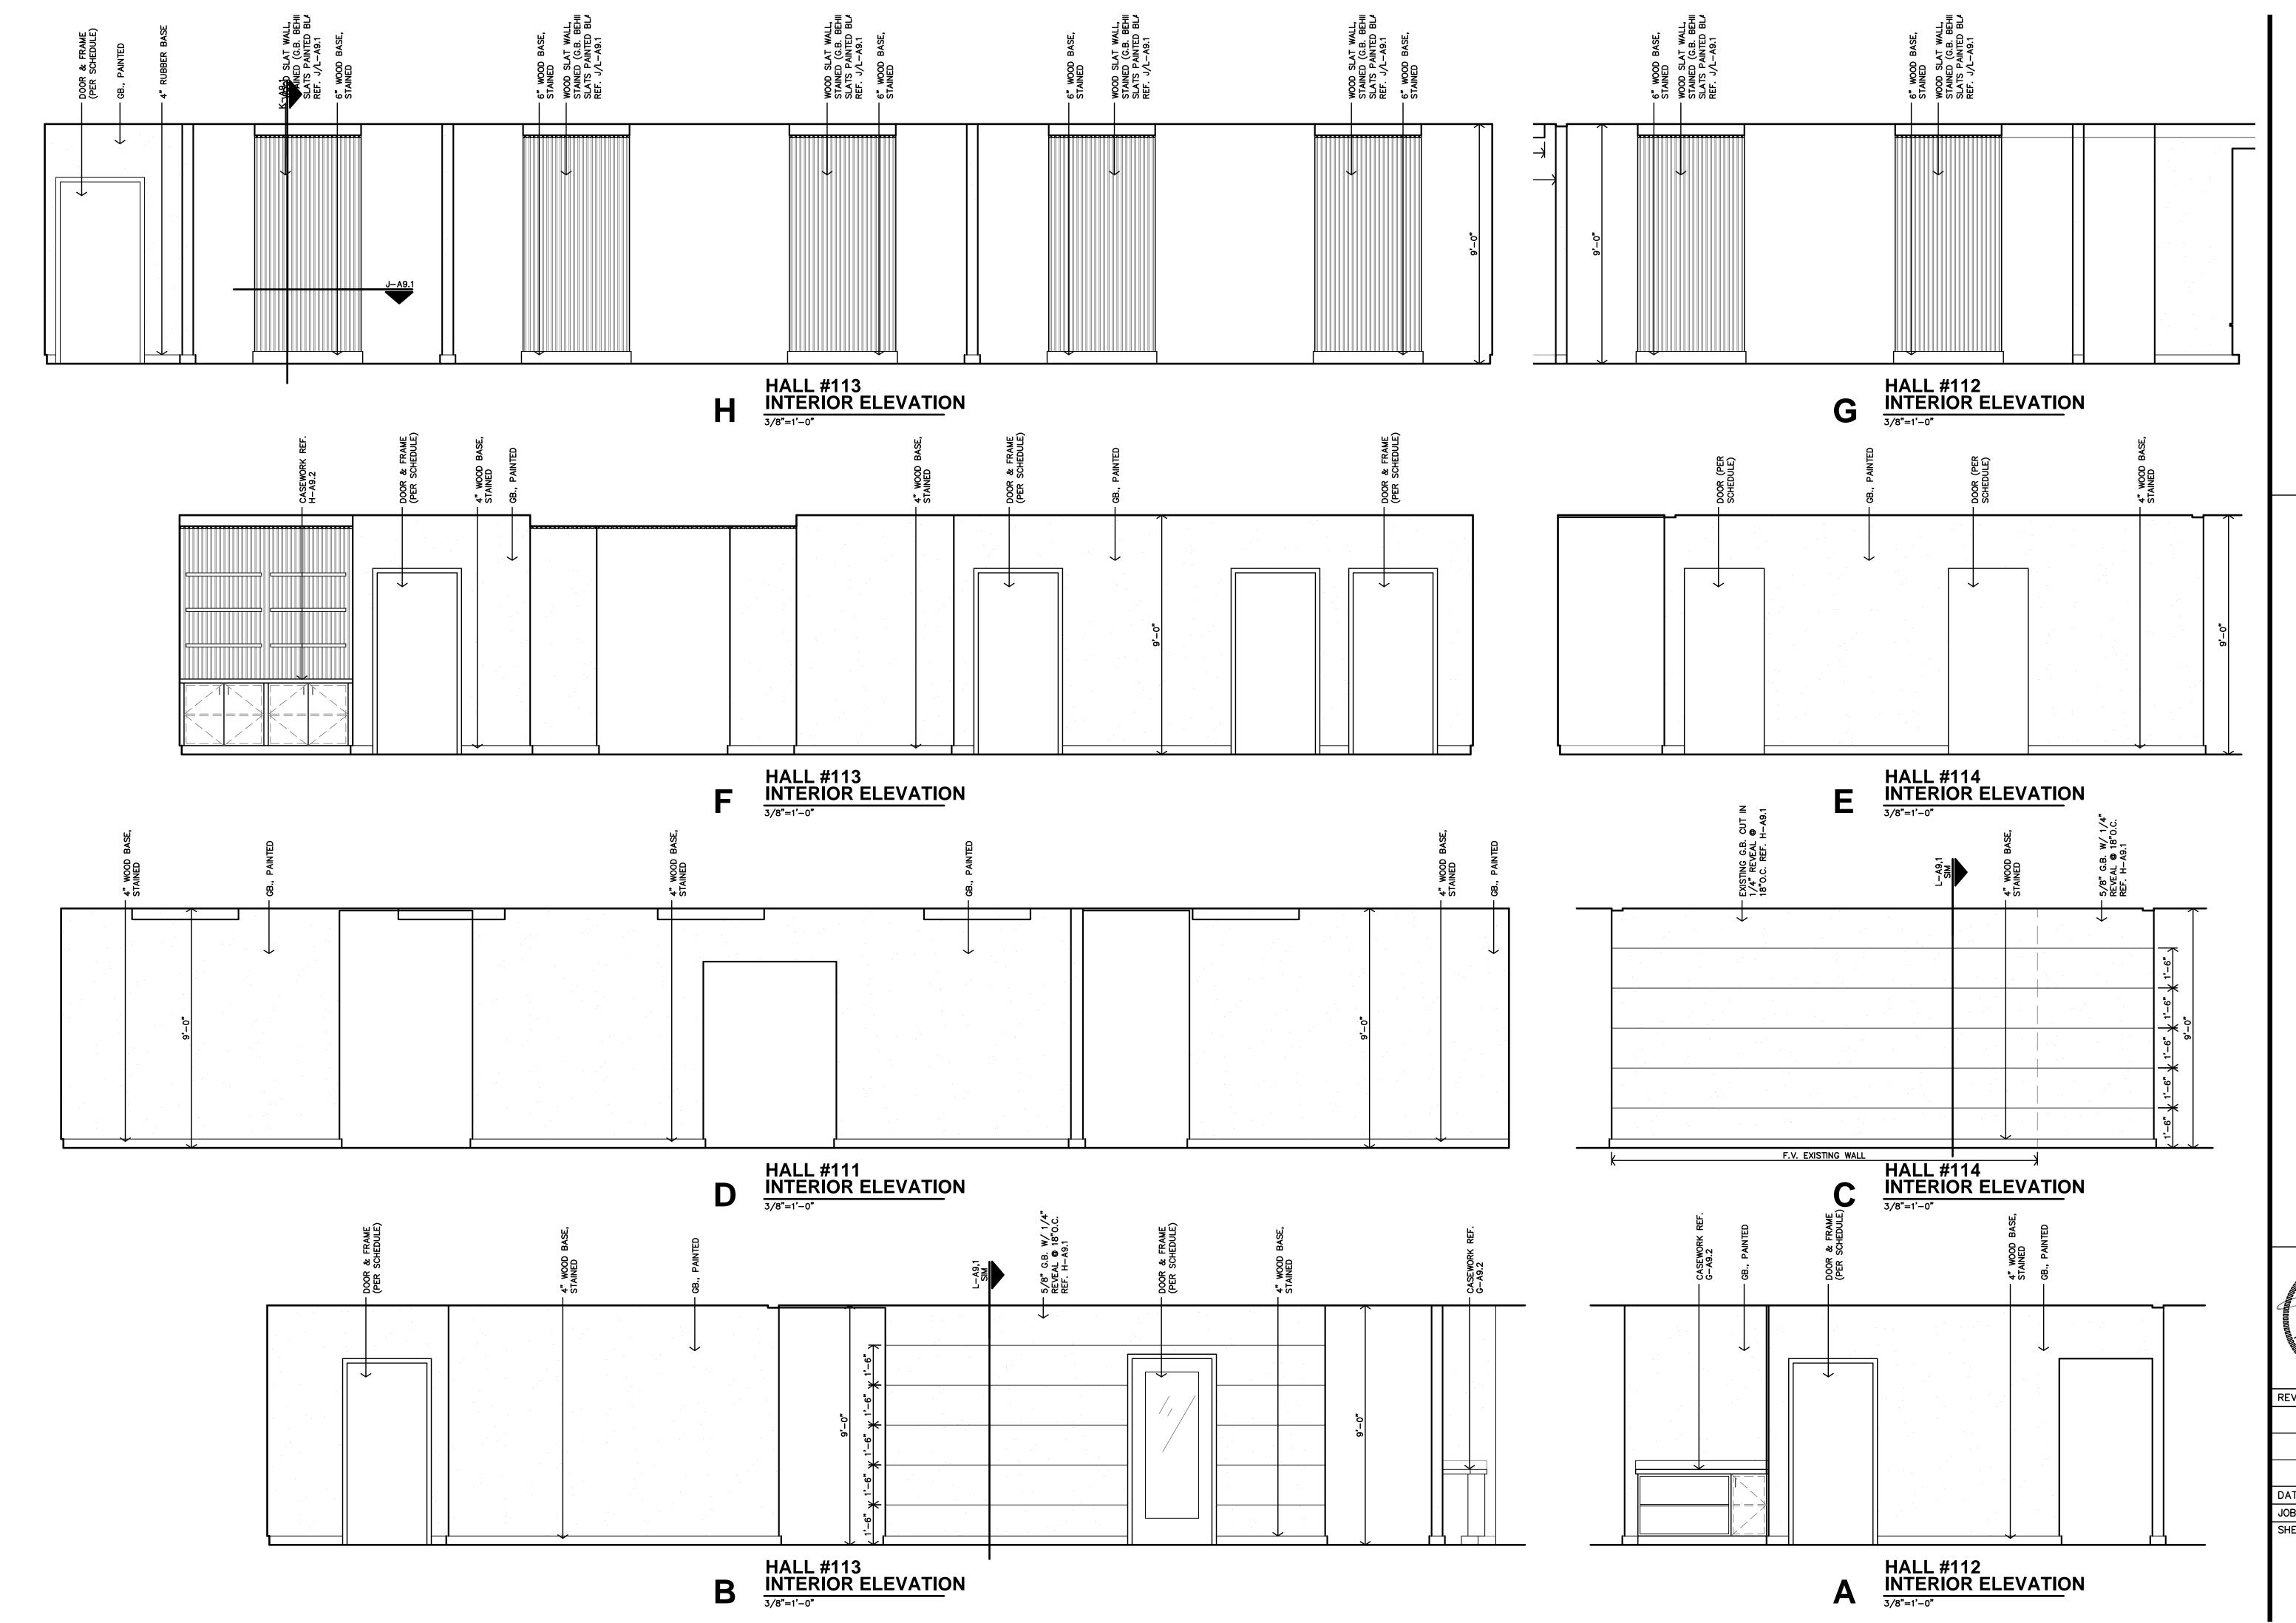
**A8.1** 



Jones Gillam Renz
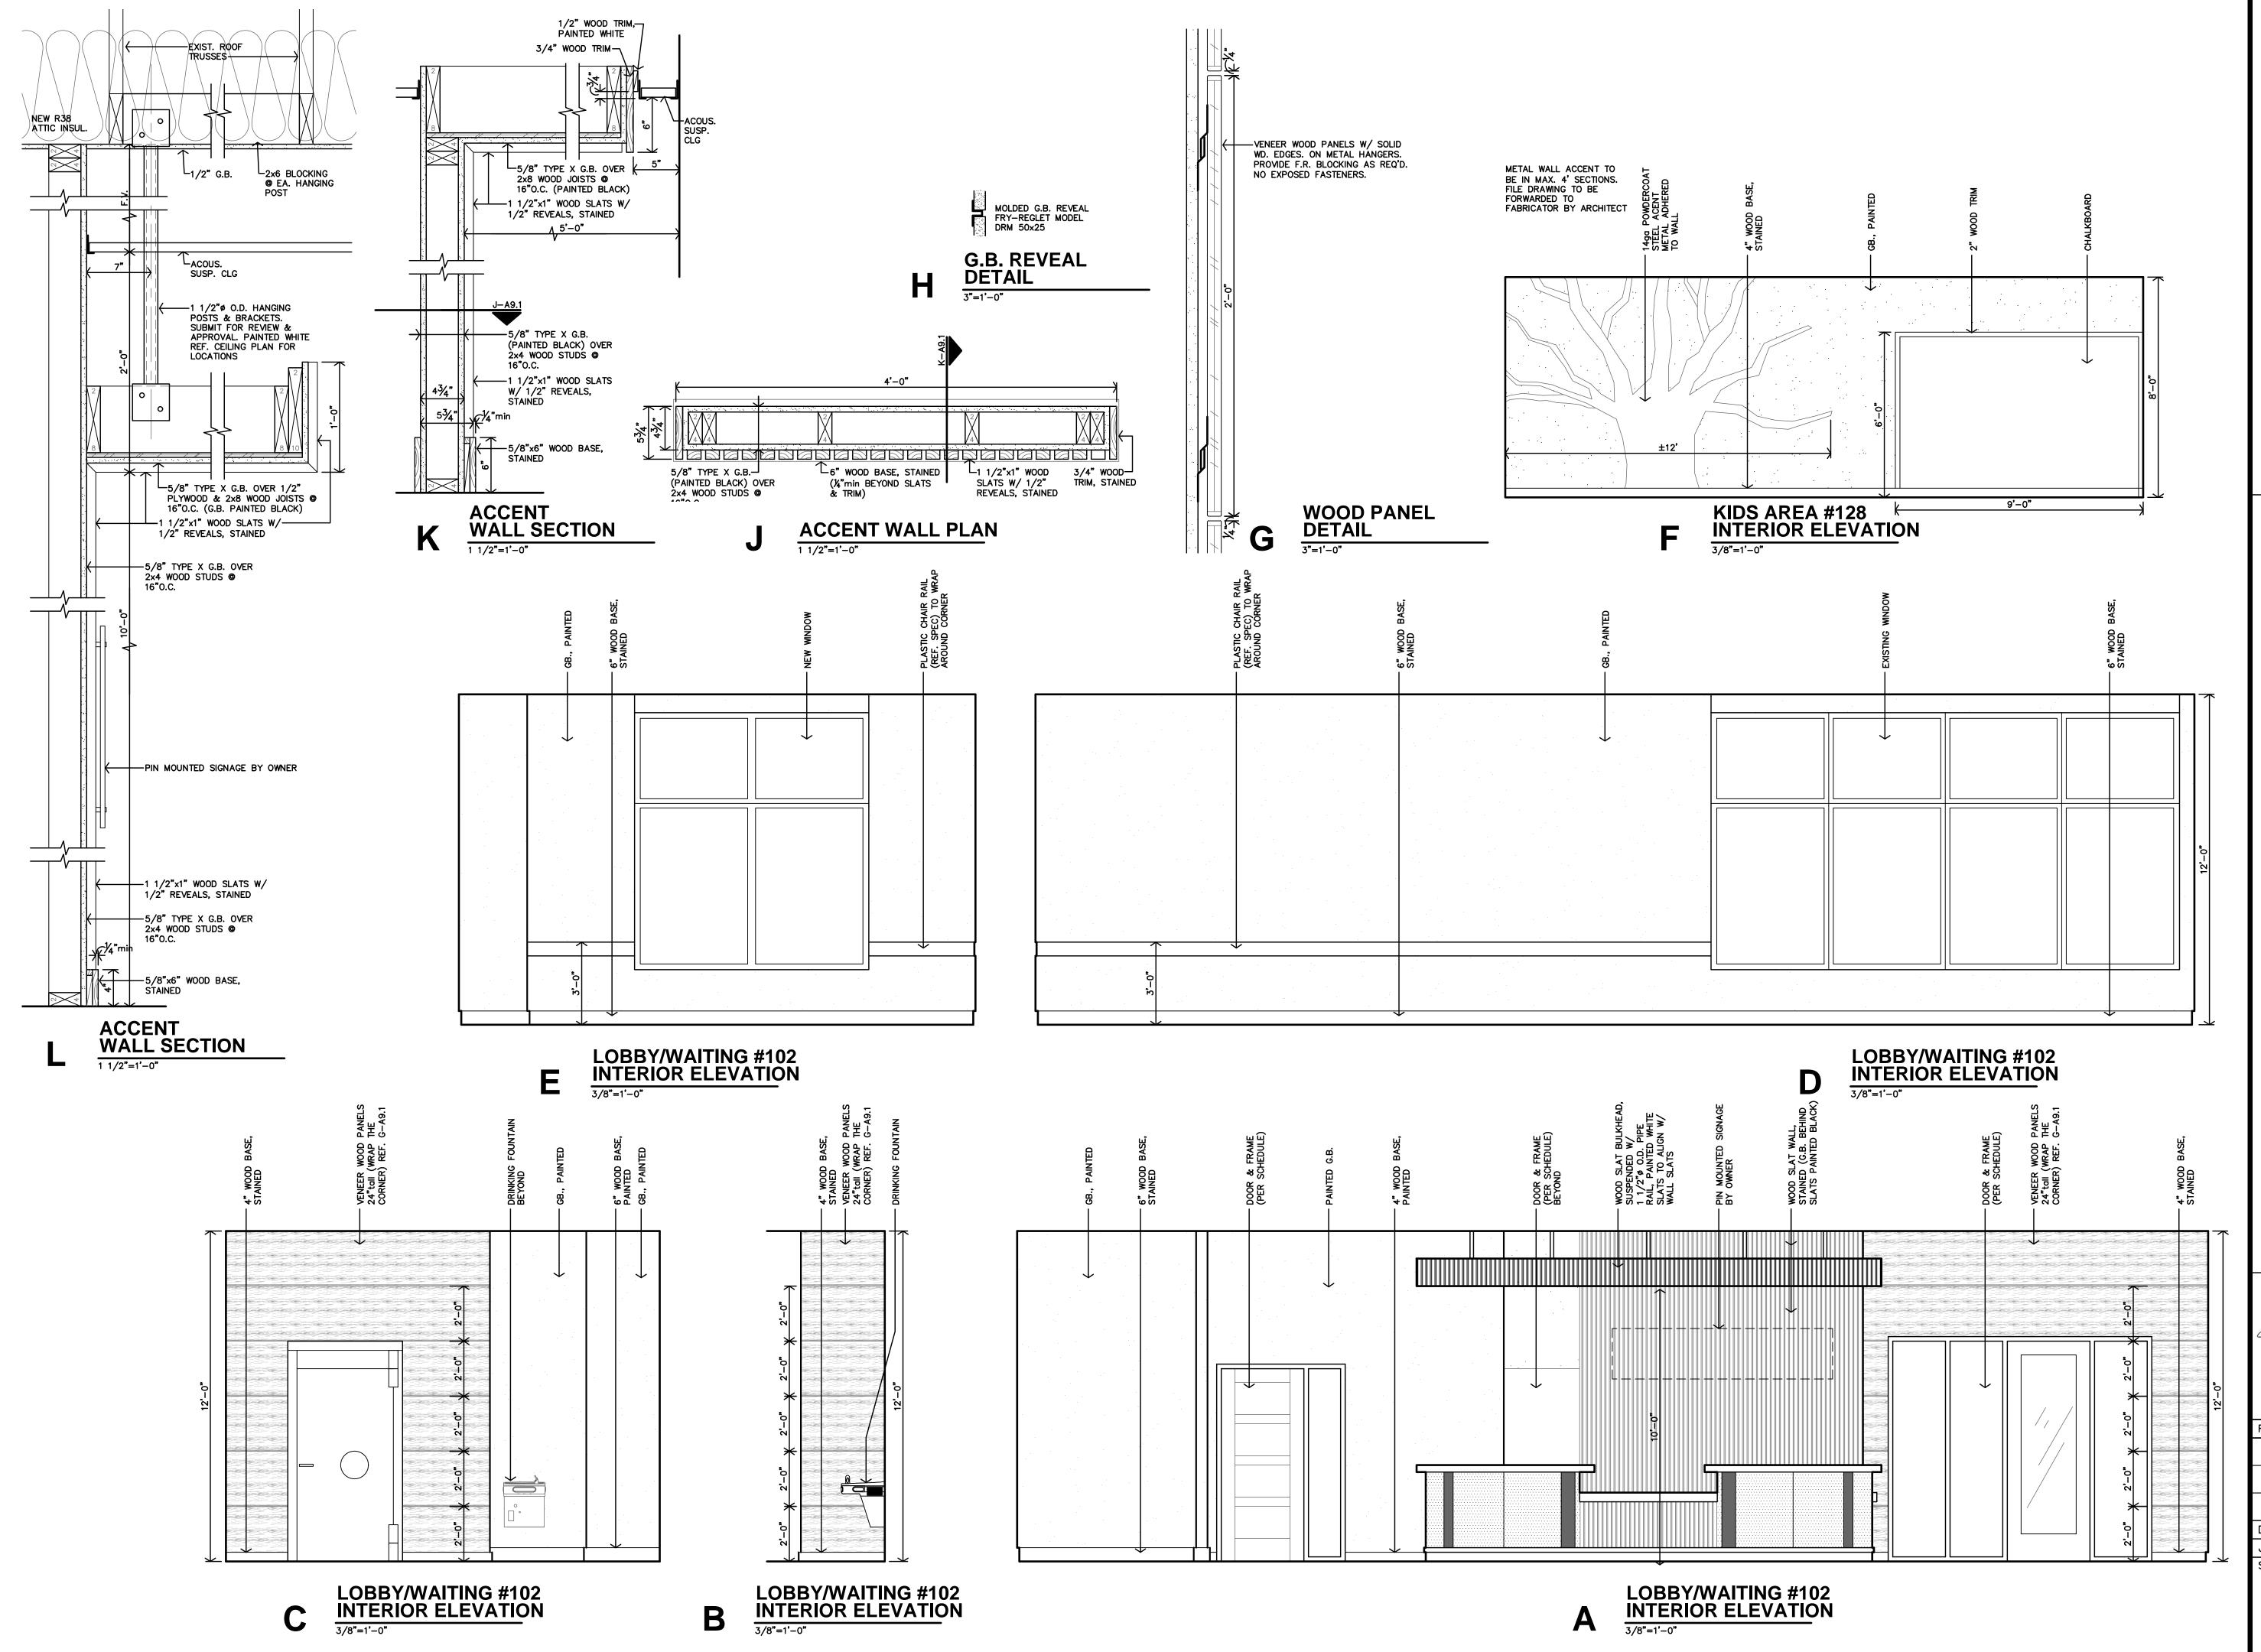
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Jon 730 N. Ninth Salina, KS 67 785.827.038

MAIN ST

SVILLE.

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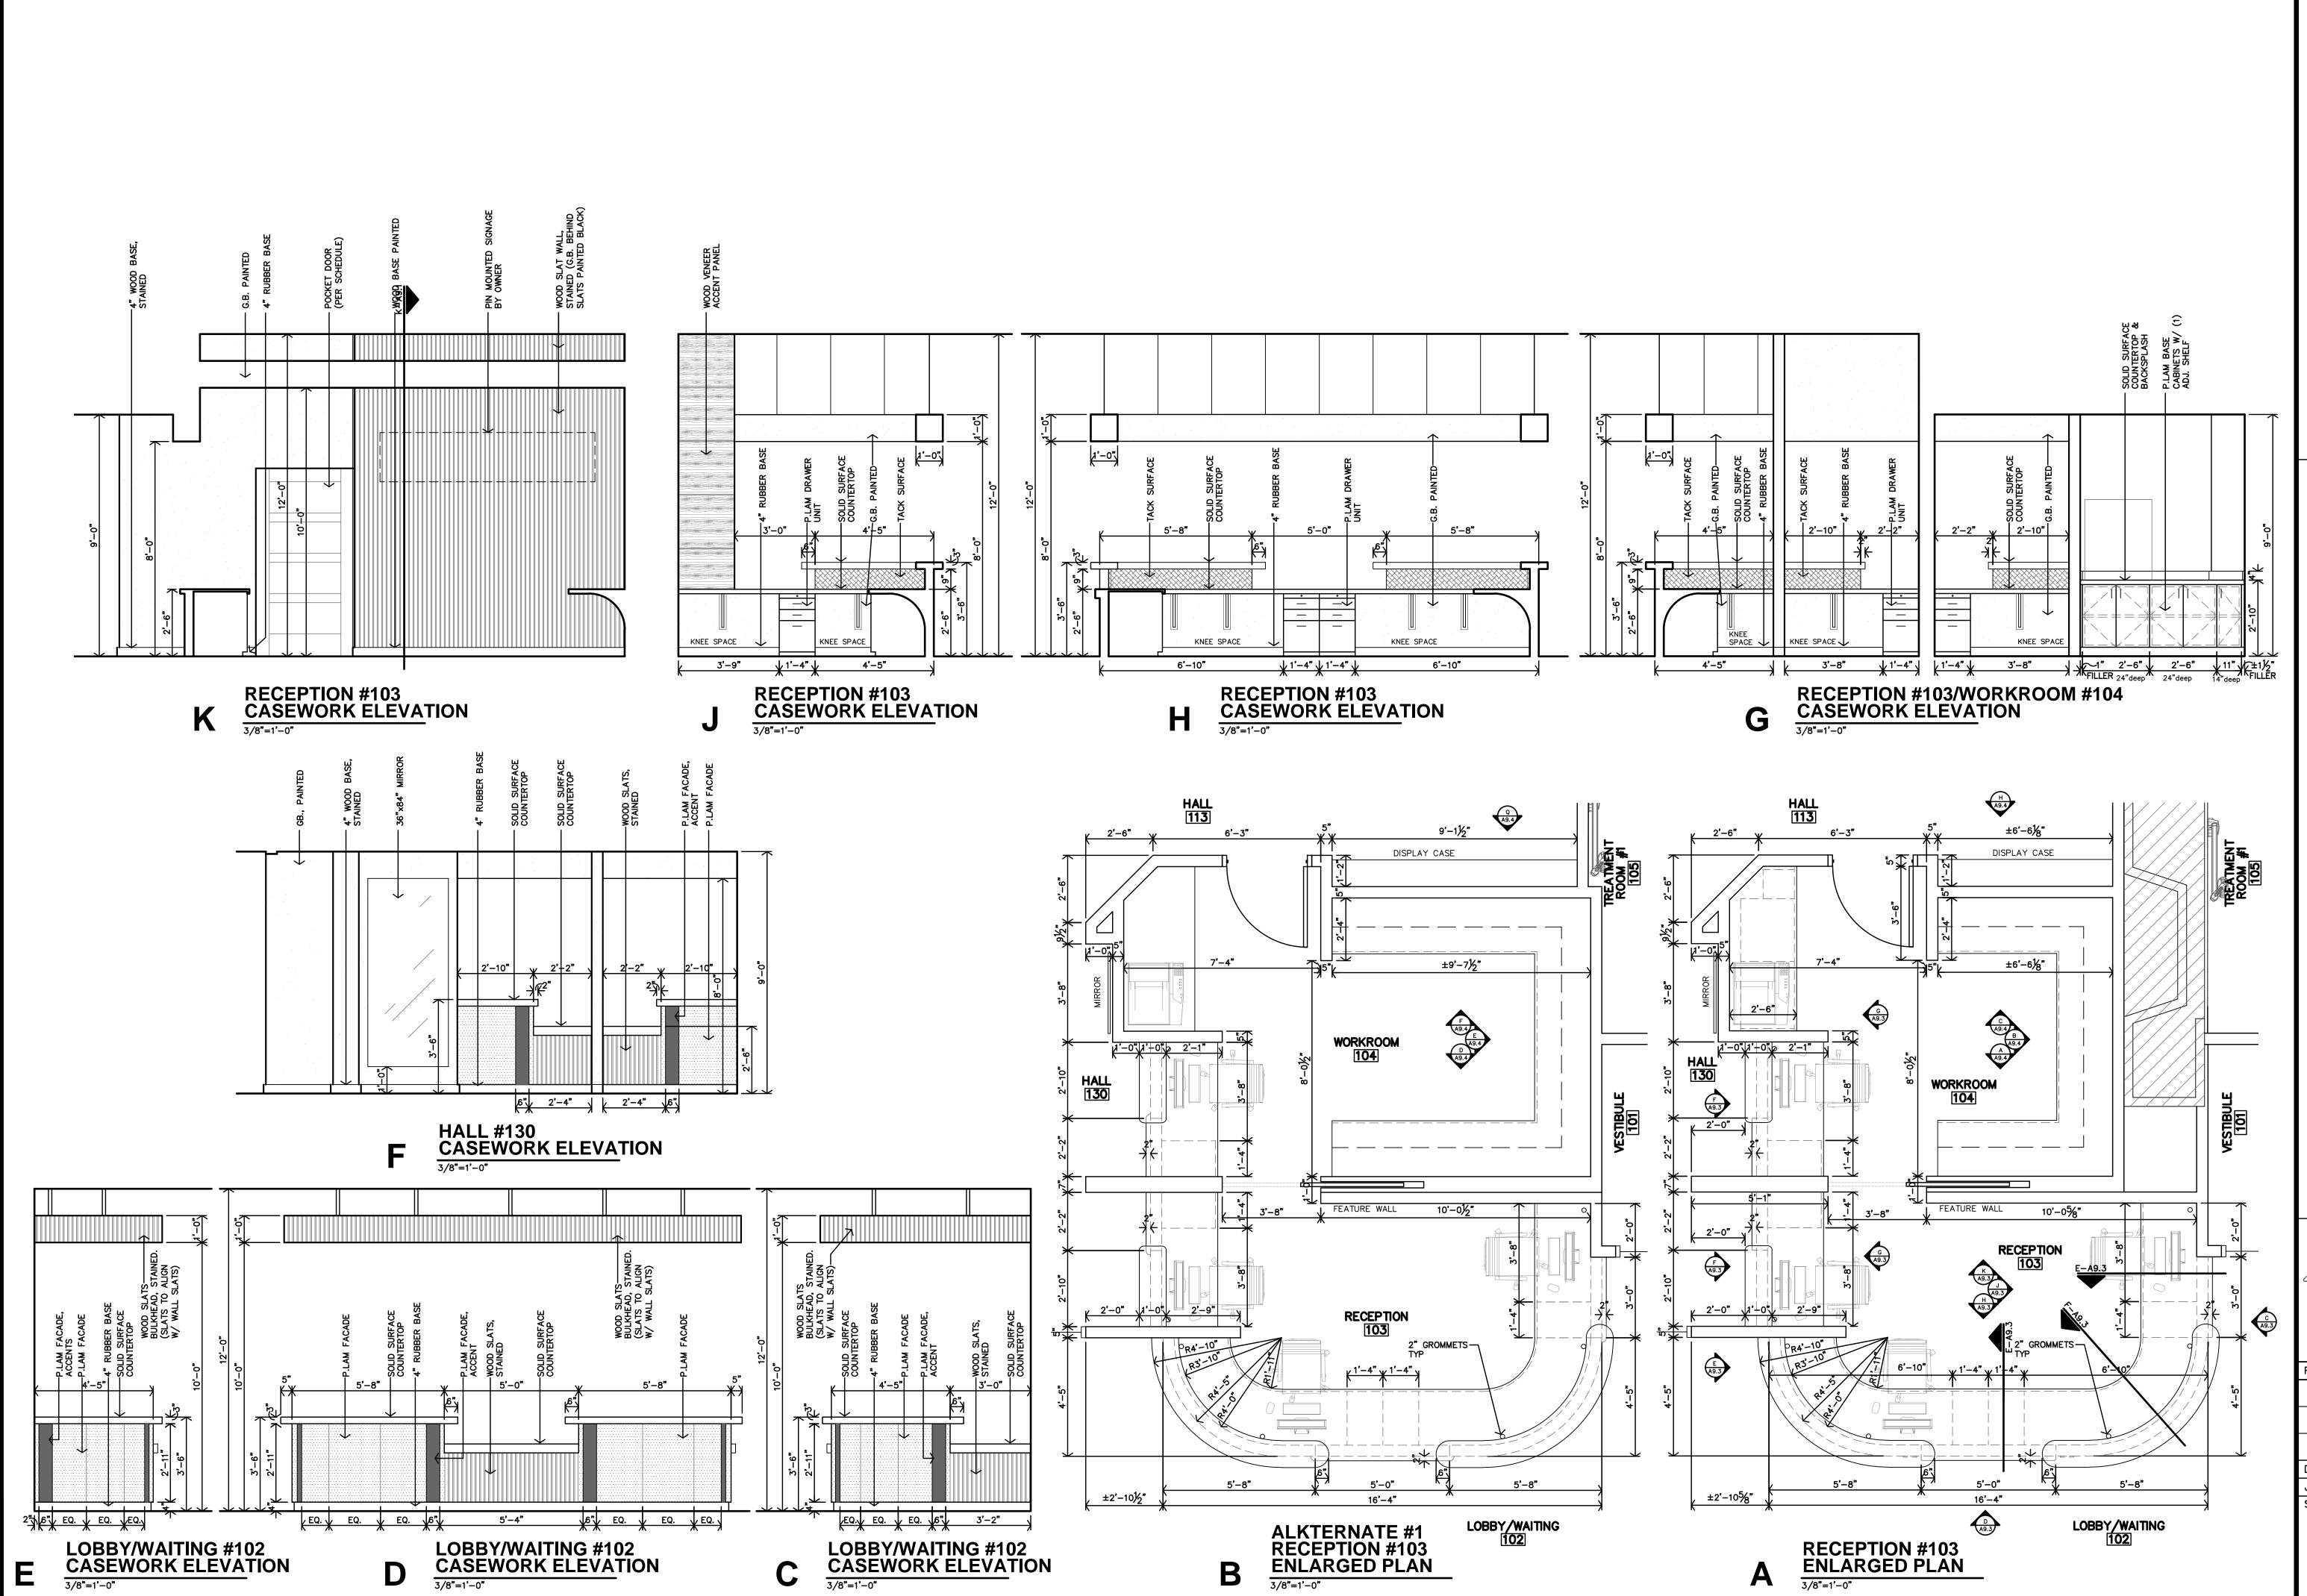
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DATE: 9-20-2023


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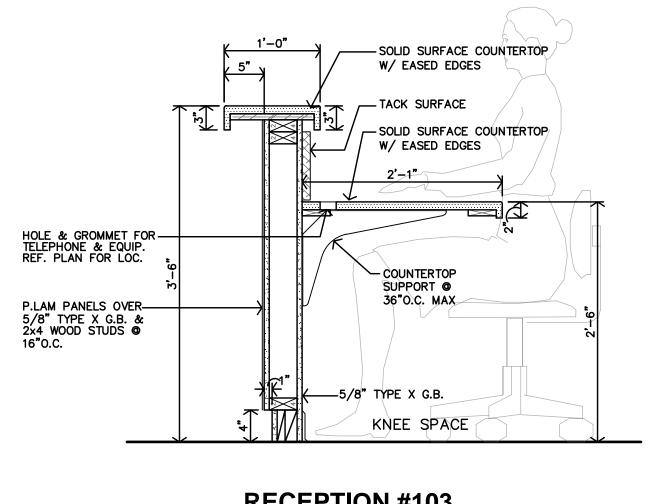
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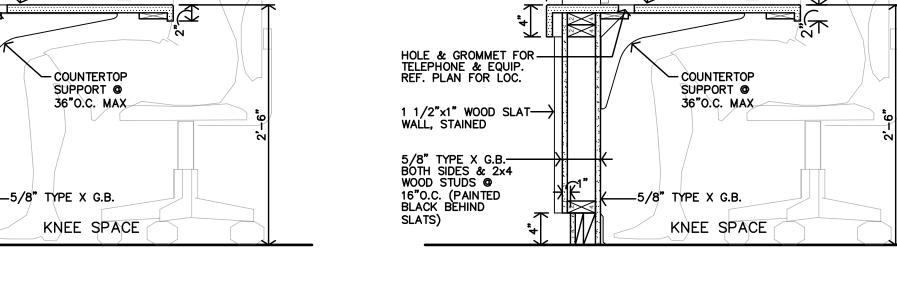
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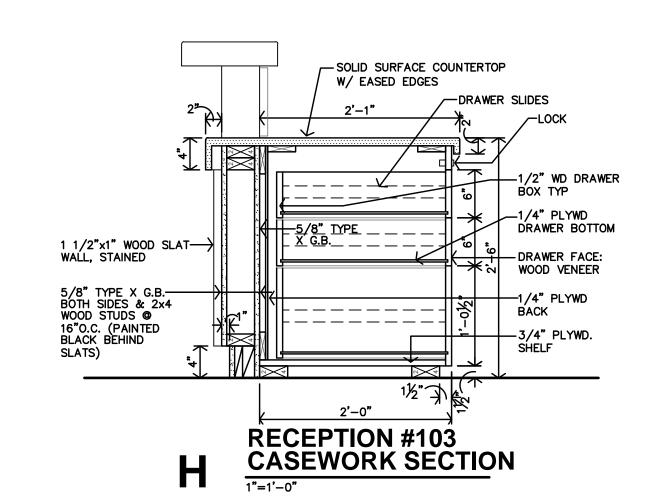
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**A9.5** 


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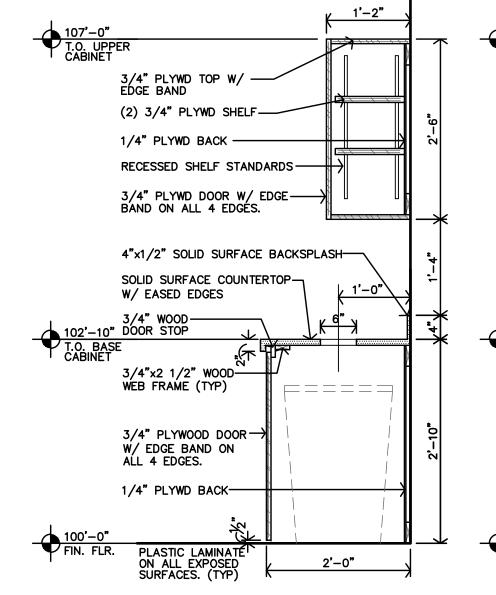







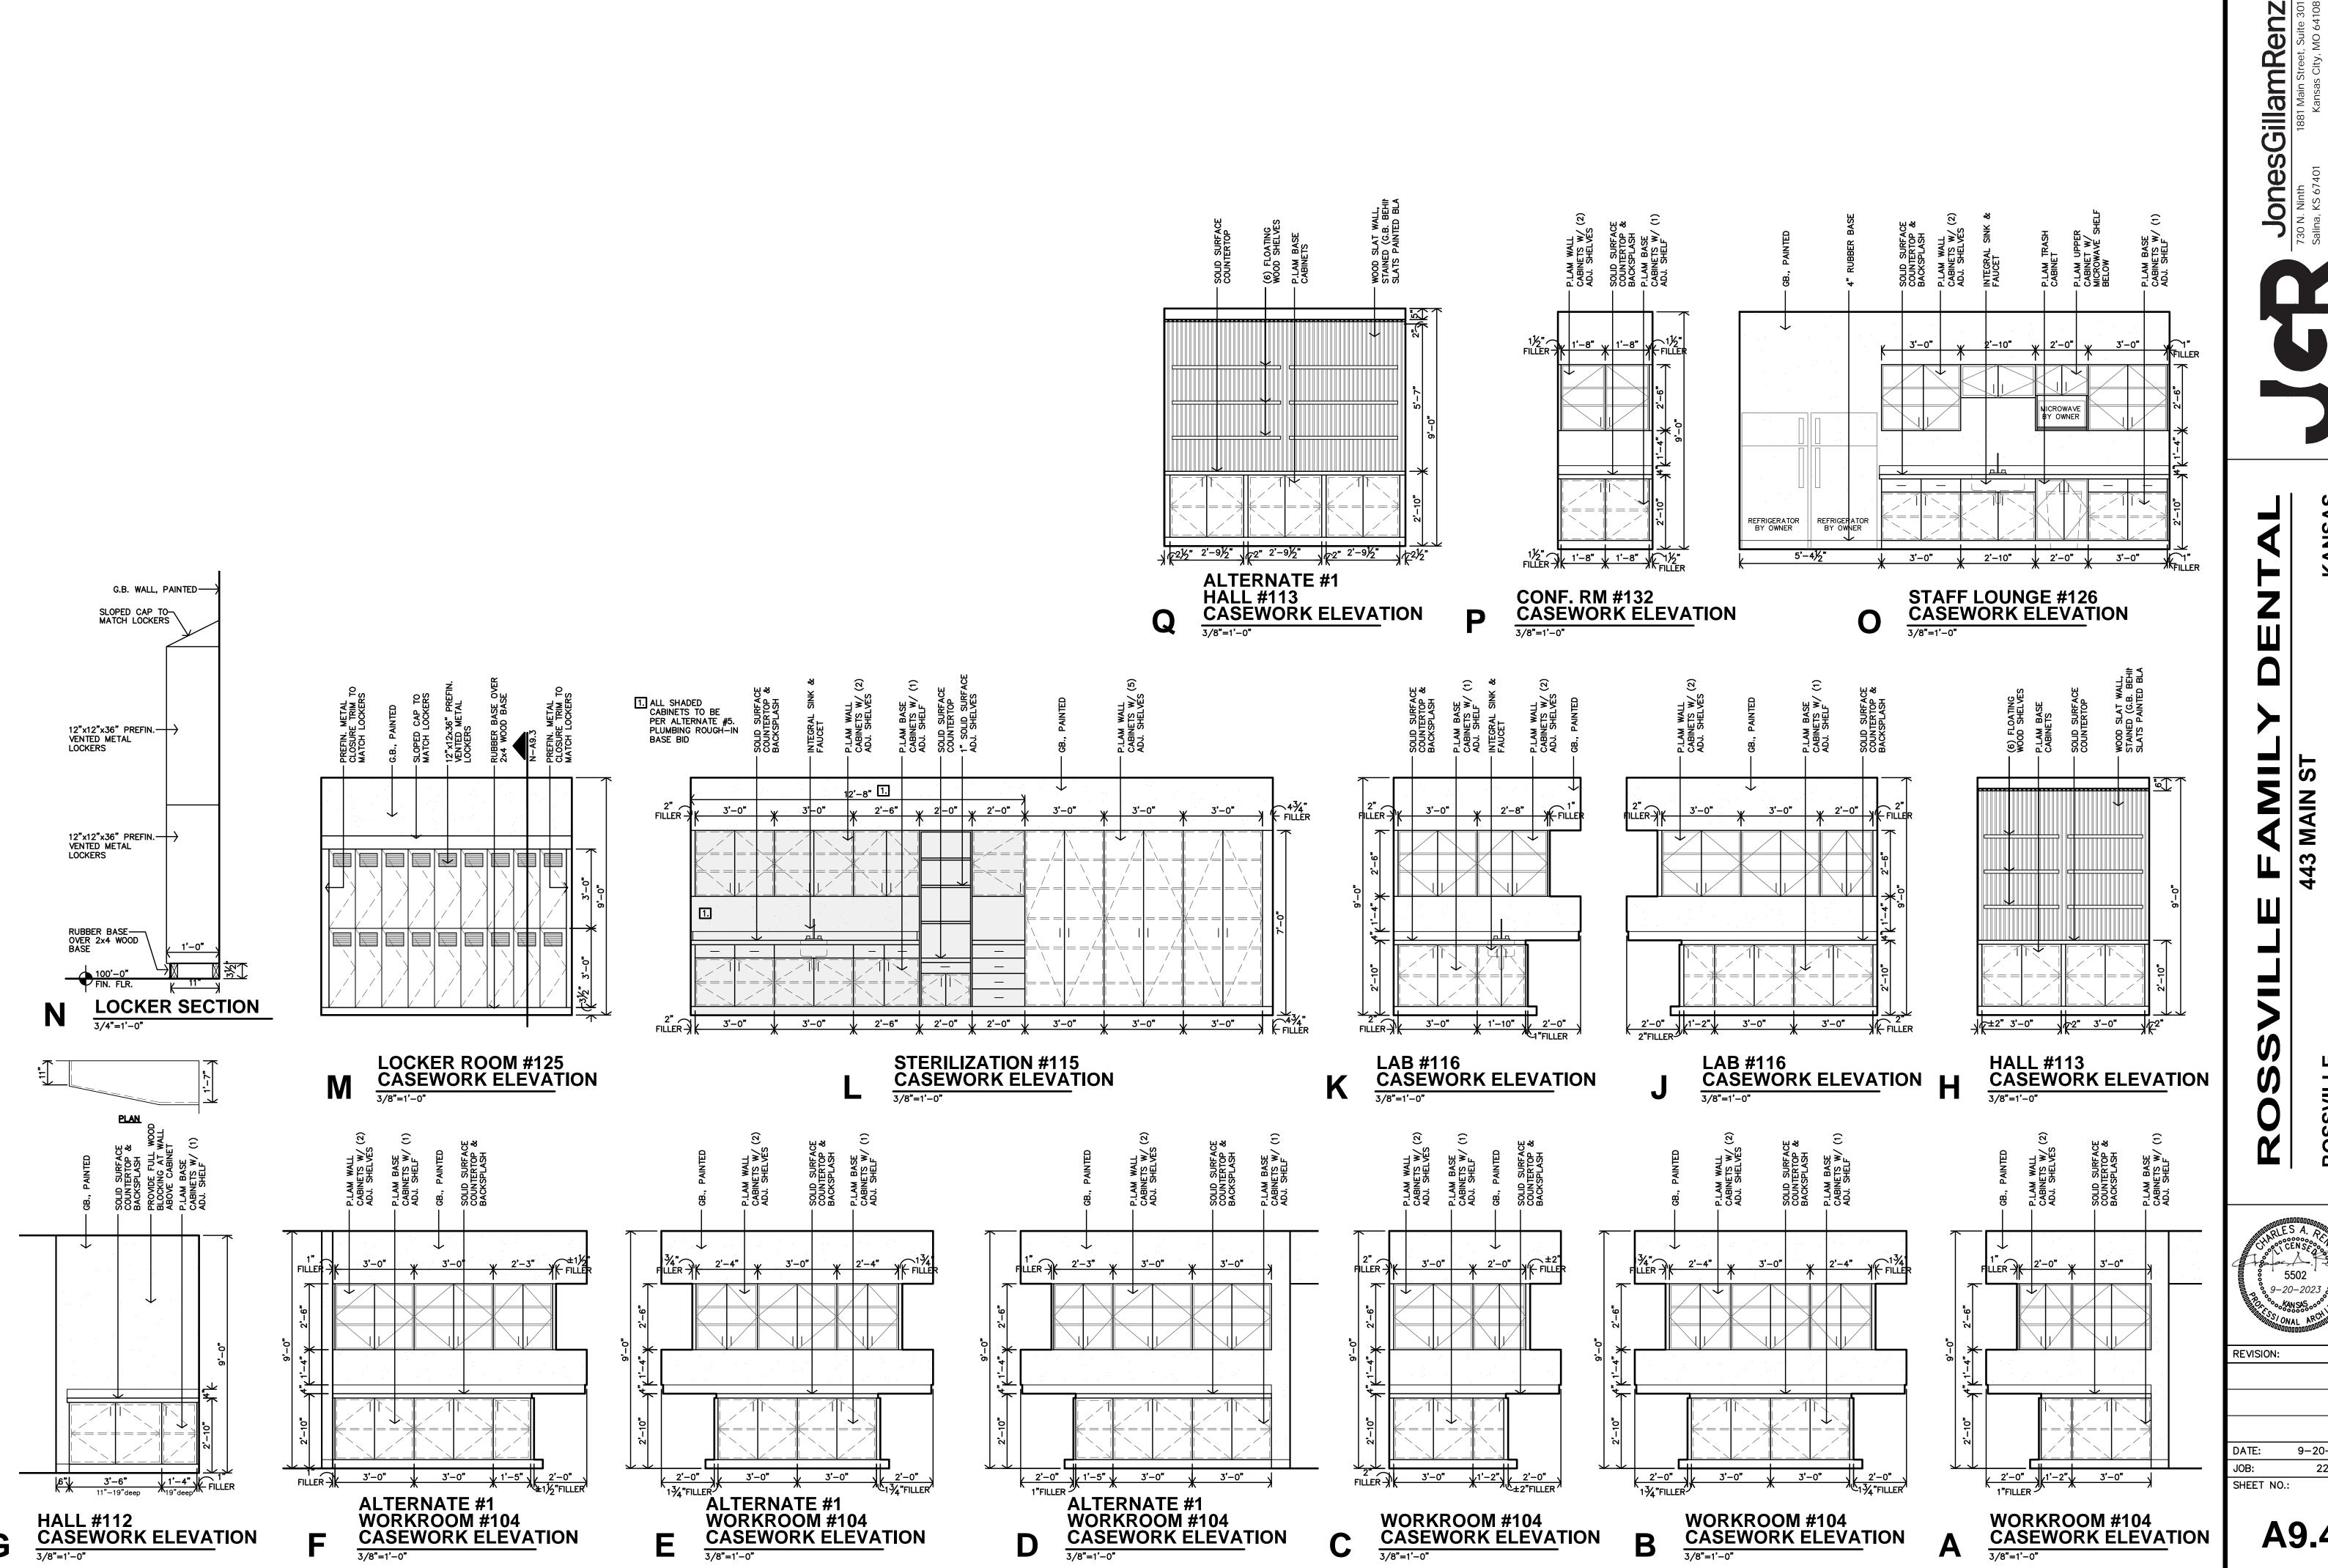

107'-0" T.O. UPPER CABINET  3/4" PLYWD TOP W/ EDGE BAND  (2) 3/4" PLYWD SHELF		10 T.
1/4" PLYWD BACK  RECESSED SHELF STANDARDS  3/4" PLYWD DOOR W/ EDGE  BAND ON ALL 4 EDGES.	Z'-6"	
4"x1/2" SOLID SURFACE BACKSPLASH  SOLID SURFACE COUNTERTOP  W/ EASED EDGES	1,-4"	
3/4" WOOD  102'-10" DOOR STOP  T.O. BASE CABINET  3/4"x2 1/2" WOOD  WEB FRAME (TYP)	<del> </del>	- 10 T. C
3/4" PLYWOOD DOOR—) W/ EDGE BAND ON ALL 4 EDGES.	2'-10"	

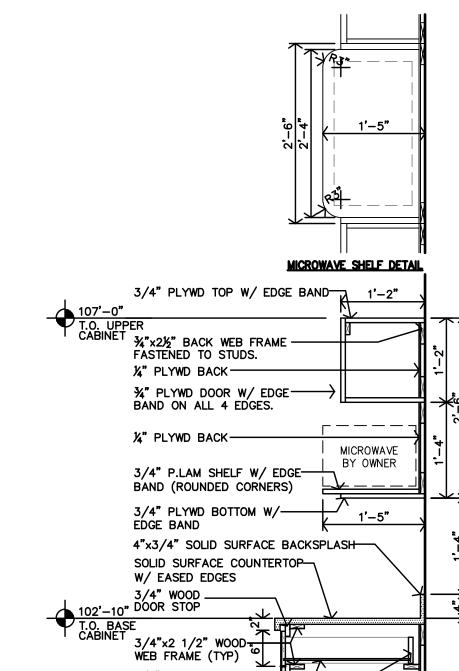


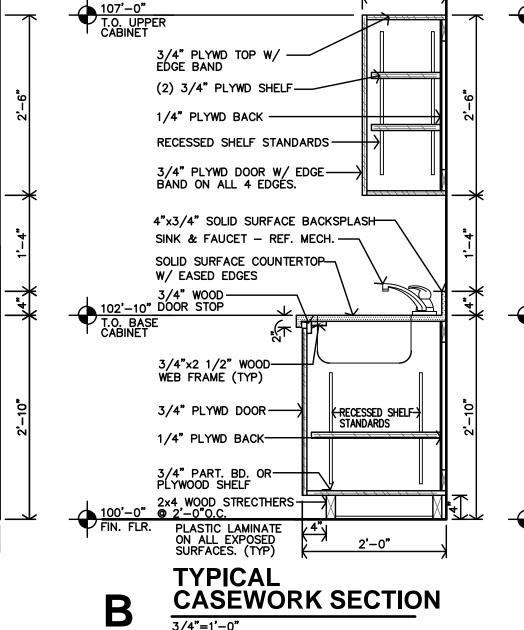


-SOLID SURFACE COUNTERTOP

W/ EASED EDGES

RECEPTION #103 CASEWORK SECTION

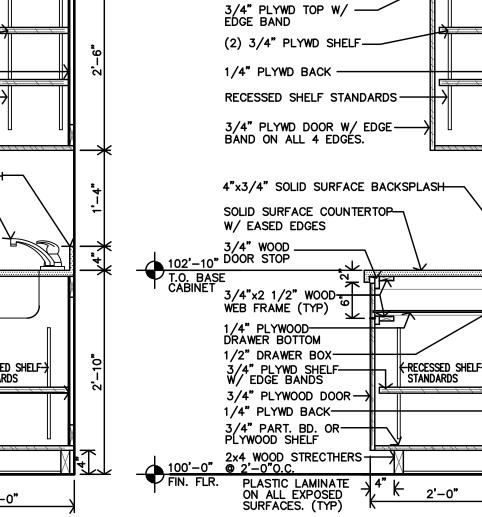

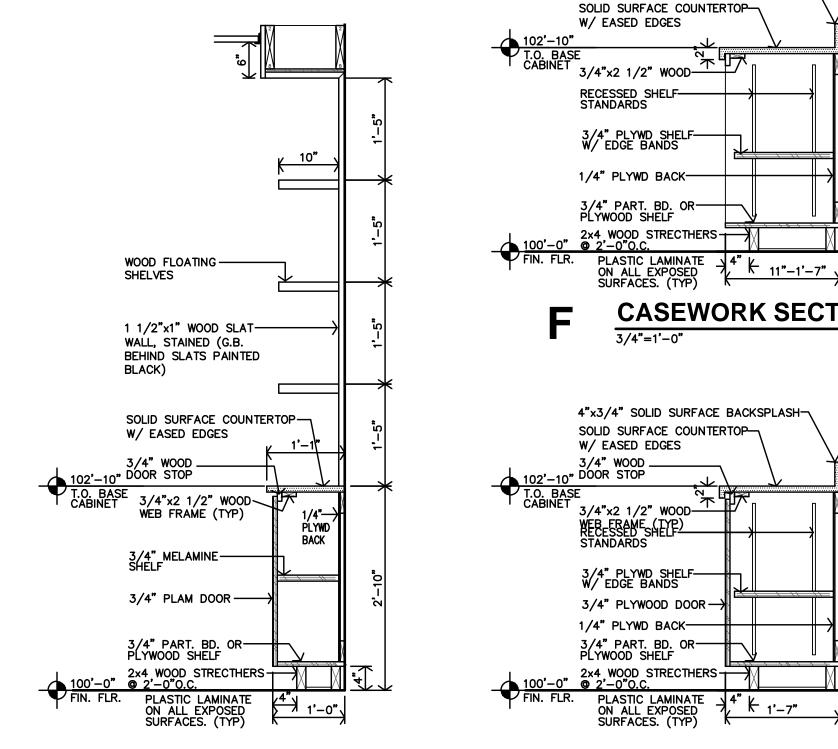

**CASEWORK SECTION** 

G

**CASEWORK SECTION** 

4"x3/4" SOLID SURFACE BACKSPLASH

**CASEWORK SECTION** 

100'-0" © 2'-0"0.C.

FIN. FLR. PLASTIC LAMINATE
ON ALL EXPOSED
SURFACES. (TYP)

1/4" PLYWOOD——DRAWER BOTTOM

1/2" DRAWER BOX——— 3/4" PLYWD SHELF—— W/ EDGE BANDS

3/4" PLYWOOD DOOR —

3/4" PART. BD. OR—— PLYWOOD SHELF

2x4 WOOD STRECTHERS

© 2'-0"O.C.


1/4" PLYWD BACK---

**CASEWORK SECTION** 

**CASEWORK SECTION** 


**CASEWORK SECTION** 

**TYPICAL CASEWORK SECTION** 

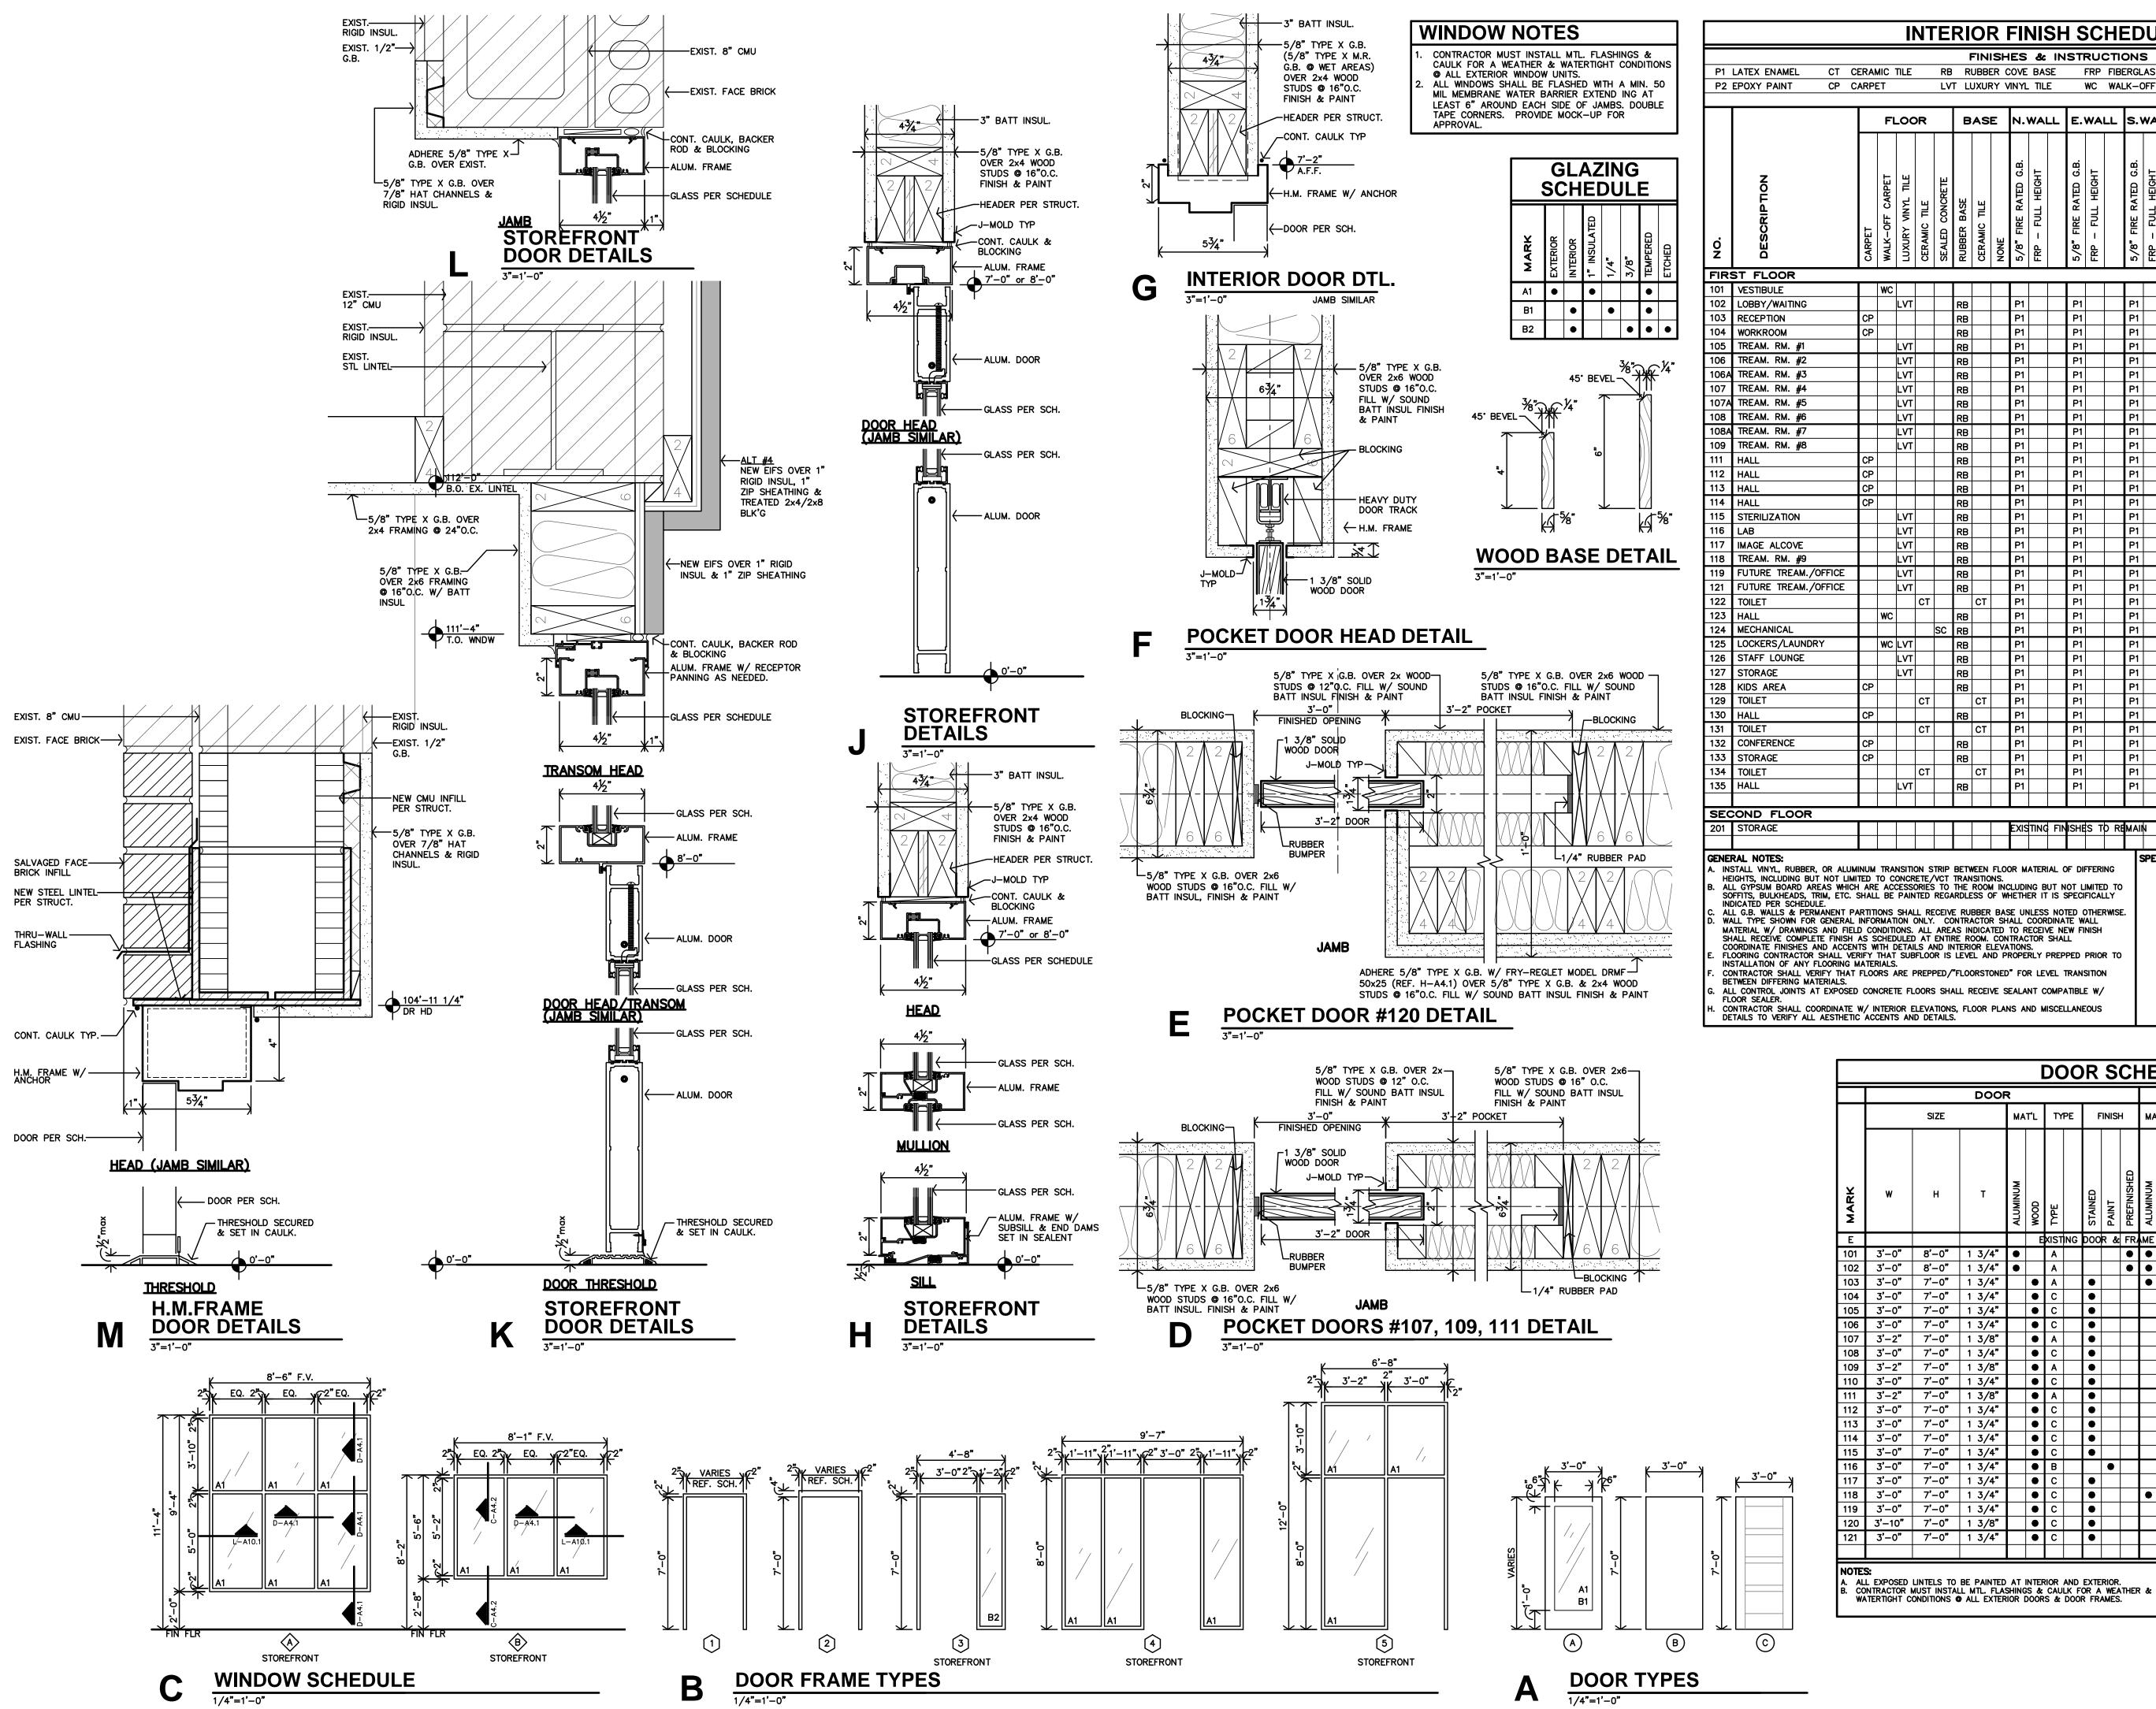

			Fl	_00	OR .		В	AS	E	Ν.	WA	LL	E.	WAI	LL	s.	WAL	L V	v. w	/ALL	. CI	EILII	NG	
ON	DESCRIPTION	CARPET	WALK-OFF CARPET	LUXURY VINYL TILE	CERAMIC TILE	SEALED CONCRETE	Rubber Base	CERAMIC TILE	NONE	5/8" FIRE RATED G.B.	FRP - FULL HEIGHT		5/8" FIRE RATED G.B.	FRP - FULL HEIGHT		5/8" FIRE RATED G.B.	FRP - FULL HEIGHT		-	FRP - FULL HEIGHT	2x2 SUSPENDED	2x4 SUSPENDED		REMARKS
_	ST FLOOR		1								ı I									· · · · · ·		1		
101 102	VESTIBULE LOBBY/WAITING	$\vdash$	WC	LVT			RB			P1			P1			P1		+,	21		•			
	RECEPTION	СР		LVI			RB			P1			P1			P1		_	21		+			
104	WORKROOM	СР					RB			P1			P1			P1		_	21		•			
105	TREAM. RM. #1			LVT			RB			P1			P1			P1		_	21		•			
106 106A	TREAM. RM. #2 TREAM. RM. #3	$\vdash$		LVT LVT	_		RB			P1 P1			P1 P1			P1 P1		_	21 21		•	1		
106A	TREAM. RM. #3	$\vdash$		LVI			RB RB			P1			P1 P1			P1		_	21 21		-			
	TREAM. RM. #5	T		LVT			RB			P1			P1			P1		_	21		•			
108	TREAM. RM. #6			LVT			RB			P1			P1			P1		<u> </u>	21		•			
108A	TREAM. RM. #7	$\perp$		LVT			RB			P1			P1			P1	$\prod$	_	21		•			
109 111	TREAM. RM. #8	CP		LVT			RB			P1 P1			P1 P1			P1 P1		_	P1		•			
	HALL	CP					RB RB			P1			P1			P1		_	21 21		+			
113		CP					RB			P1			P1			P1		_	21		•			
114	HALL	СР					RB			P1			P1			P1			21		•			
115	STERILIZATION			LVT			RB			P1			P1			P1		_	21		•			
116	LAB	-		LVT			RB			P1			P1			P1		_	21		<b> •</b>		-	
117 118	TREAM. RM. #9	$\vdash$		LVT LVT			RB RB			P1 P1			P1 P1			P1 P1		_	21 21		•			
	FUTURE TREAM./OFFICE	$\vdash$		LVT			RB			P1			P1			P1		_	21		+			
121	FUTURE TREAM./OFFICE			LVT			RB			P1			P1			P1			21		•			
122	TOILET				СТ			СТ		P1			P1			P1		_	21		•			
	HALL MECHANICAL	╀	WC			SC	RB			P1 P1			P1 P1			P1 P1		_	21 21		•			
125	LOCKERS/LAUNDRY	$\vdash$	WC	LVT		30	RB RB			P1			P1			P1		-	21		+-			
	STAFF LOUNGE			LVT	-		RB			P1			P1			P1		_	21		•			
127	STORAGE			LVT			RB			P1			P1			P1			21		•			
128	KIDS AREA	CP					RB			P1			P1			P1		-	21		•		<u> </u>	
129 130	TOILET	CP	1		СТ		RB	СТ		P1 P1			P1 P1			P1 P1		_	21 21		•	+	1	
131	TOILET	15			СТ		LKR	СТ		P1			P1			P1	$\vdash$	_	21		╬			<del>                                     </del>
132	CONFERENCE	СР			<u> </u>		RB	<u> </u>		P1			P1			P1		_	21		•			
133	STORAGE	СР					RB			P1			P1			P1		_	21		•			
134	TOILET	_			СТ		<u> </u>	СТ		P1			P1	<b>-</b>		P1		_	21		•			
135	HALL	$\vdash$		LVT	-		RB			P1			P1			P1		+	21		╀			<del>                                     </del>
SEC	OND FLOOR																							
201	STORAGE									EXIS	TINC	FIN	ISHE	S T	) RE	MAI	N	$\bot$	Ţ		$\bot$			
<u> </u>	AL NOTES									<u> </u>						<del>L ,</del>								
A. INS HEI B. ALL SOF IND C. ALL D. WA MA SH COO E. FLC	PAL NOTES: TALL VINYL, RUBBER, OR ALUNGHTS, INCLUDING BUT NOT LIMBLE OF THE STATE OF ALUNGHTS, INCLUDING BUT NOT LIMBLE OF THE SCHEDULE.  GEB. WALLS & PERMANENT POLL TYPE SHOWN FOR GENERAL TERIAL W/DRAWINGS AND FIELD OF THE STATE OF THE SHORT OF THE SHORT OF THE STALL VERIFY THAT THAT THE STALL VERIFY THAT THAT THE SHALL VERIFY THAT THE SHALL VERIFY THAT	ITED H ARI SHAL ARTIT INFO LD CC AS S ITS W ERIFY MATEI	TO C E AC L BE IONS RMAT DNDITI SCHEE VITH I THAT RIALS	ONCR CESSO PAIN SHAI TON (IONS.) DULED DETAI SUB	RETE/ORIES ITED LL REONLY ALL O AT LS A BFLOO	VCT S TO REGA ECEIVA . CO AREA ENTII ND IN OR IS	TRAM THE ARDLE E RU ONTRA AS IN RE R NTERI LEVI	ROOI ROOI BBER ACTO NDICA OOM. IOR E	ONS. M INCOF WI R BAS R SH ATED CON LLEVA	ELUDII HETHI SE UN ALL TO R TRAC TION: ROPE	NG B ER 17 ILESS COOR ECEIV TOR S. RLY	BUT N F IS S S NO RDINA VE NE SHAL	OT L SPECI TE W EW FI L	IMITEI FICAL OTHEF ALL INISH	D TO LY RWISE	·.	<b>SPECIF</b>	·IC N	OIE	.S:				

						<u>DC</u>	<u>)C</u>	<u>R</u>	S	<u>Cl</u>	<u> 1</u> E	D	<u>UL</u>	<u>.E</u>				
			DOOF	₹								1	FR/	ME	Ε			
		SIZE		МА	T'L	TY	PΕ	f	INIS	1	МА	T'L	TY	PE	FIN	IISH		
MARK	w	н	т	ALUMINUM	WOOD	TYPE		STAINED	PAINT	PREFINISHED	ALUMINUM	HOLLOW MTL	ТҮРЕ		PAINT	PREFINISHED	DETAIL	REMARKS
Ε					E	XIST	NG	DOC	R &	FR/	ME	то	REM.	AIN				
101	3'-0"	8'-0"	1 3/4"	•		Α				•	•		5			•	K/L-A10.1	
102	3'-0"	8'-0"	1 3/4"	•		Α				•	•		4			•	H/J-A10.1	
103	3'-0"	7'-0"	1 3/4"		•	Α		•			•		3			•	H/J-A10.1	
104	3'-0"	7'-0"	1 3/4"		•	С		•				•	1		•		G-A10.1	
105	3'-0"	7'-0"	1 3/4"		•	С		•				•	1		•		G-A10.1	
106	3'-0"	7'-0"	1 3/4"		•	С		•				•	1		•		G-A10.1	
107	3'-2"	7'-0"	1 3/8"		•	Α		•									D/F-A10.1	3'-0" OPN
108	3'-0"	7'-0"	1 3/4"		•	С		•				•	1		•		G-A10.1	
109	3'-2"	7'-0"	1 3/8"		•	Α		•									D/F-A10.1	3'-0" OPN
110	3'-0"	7'-0"	1 3/4"		•	С		•				•	1		•		G-A10.1 SIM	
111	3'-2"	7'-0"	1 3/8"		•	Α		•									D/F-A10.1	3'-0" OPN
112	3'-0"	7'-0"	1 3/4"		•	С		•				•	1		•		G-A10.1	
113	3'-0"	7'-0"	1 3/4"		•	С		•				•	1		•		G-A10.1	
114	3'-0"	7'-0"	1 3/4"		•	С		•				•	1		•		G-A10.1	
115	3'-0"	7'-0"	1 3/4"		•	С		•				•	1		•		G-A10.1 SIM	
116	3'-0"	7'-0"	1 3/4"		•	В			•			•	1		•		M-A10.1	
117	3'-0"	7'-0"	1 3/4"		•	С		•				•	1		•		G-A10.1	
118	3'-0"	7'-0"	1 3/4"		•	С		•			•		1			•	H/J-A10.1	
119	3'-0"	7'-0"	1 3/4"		•	С		•				•	1		•		G-A10.1	
120	3'-10"	7'-0"	1 3/8"		•	С		•									E/F-A10.1	3'-8" OPN
121	3'-0"	7'-0"	1 3/4"			С		•					1		•		G-A10.1	

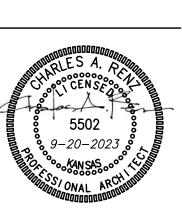

GillamRen

9-20-2023 22 - 3211SHEET NO .:

A10.1

## GENERAL NOTES - STRUCTURAL

## 1. General Information:

- A. The contractor shall verify dimensions and conditions before construction and notify the engineer of any discrepancies, inconsistencies, or difficulties affecting the work before proceeding.
- B. The contractor shall coordinate all disciplines, verifying size and location of all openings, whether shown on structural drawings or not, as called for on architectural, mechanical, or electrical drawings. In the case of work in an existing building the contractor shall scan existing structure to locate all rebar in the area of the new core/opening using ground penetrating radar and notify the engineer of record for review prior to coring/cutting. Conflicts, inconsistencies, or other difficulties affecting structural work shall be called to the architect or engineer's attention for direction before proceeding
- C. All design and construction work for this project shall conform to the requirements of the 2018 International Building Code, as amended by the City of Rossville, Kansas.
- D. These drawings are for this specific project and no other use is authorized.

# 2. Structural Design Load Criteria:

- A. Floor Live= 100psf
   (An allowance of 15psf has been made for partitions as a uniformly distributed live load where the live load stated above is 80psf or less)
   B. Roof Live= 20psf
- C. Snow= Pg= 20psf, Pf=14psf,Is = 1.0 Ce=1.0, Ct=1.0, Drift per ASCE/SEI 7-16

# 3. Concrete:

- A. All concrete for interior flat work shall develop minimum ultimate compressive design strength of 4000 psi in 28 days, but not less than 525 pounds of cement shall be used per cubic yard of concrete regardless of strengths obtained, not over 5.75 gallons of water per 100 pounds of cement and not over 4 inches of slump.
- B. The preceding minimum mix requirements may have water-reducing admixtures conforming to ASTM C494 added to the mix at manufacturer's dosage rates for improved workability.
- C. The preceding minimum mix requirements may have up to 15% maximum of the cement content replaced with an approved ASTM C618 Class C fly ash, provided the total minimum cementitious content is not reduced.

  D. All interior concrete slabs on grade shall be placed.
- D. All interior concrete slabs on grade shall be placed over 15 mil, Class A Vapor Barrier per ASTM E1745 with less than O.Ol perms, tested after mandatory conditioning. All joints shall be lapped and sealed per manufacturer's recommendations. All penetrations, as well as damaged vapor barrier material shall also be sealed per manufacturer's recommendation prior to concrete placement. Install barrier per manufacturer recommended details at all discontinuous edges (at interior columns, exterior edge of slab, etc.) to ensure terms of warranty are followed. The vapor barrier shall be placed over free-draining granular material as prescribed by the project soils report.
- E. No aluminum items shall be embedded in any concrete.

# 4. Reinforcing Steel:

A. All reinforcing steel shall conform to the requirements of ASTM A615 or A706 grade 60 steel. Welded plain wire fabric shall be supplied in sheets and conform to the requirements of ASTM A1064.

# 5. Structural Steel:

- A. All miscellaneous steel shall be ASTM A36 grade steel. Fabrication and erection shall be in accordance with AISC 303-05 "Code of Standard Practice for Steel Buildings and Bridges" in the I3th Edition of the AISC Steel Construction Manual.
- B. All welding shall conform to the recommendations of the AWS.
- C. All exterior steel and connections, and brick relief angles shall be hot-dip galvanized.

# 6. Post-Installed Anchors:

- A. Post-installed anchors shall be used only where specified on the drawings unless approved in writing by the engineer of record. See drawings for anchor diameter, spacing and embedment. Performance values of the anchors shall be obtained for specified products using appropriate design procedures and/or standards as required by the governing building code. Anchors installed in concrete shall have an ICC-ES Evaluation Service Report. Special inspection is required for all post-installed anchors. The general contractor shall coordinate an on-site meeting with the post-installed anchor manufacturer field representative and subcontractor performing the anchor installation to educate the construction team on the anchor installation quidelines and requirements. The contractor shall send ā record copy of the meeting meetings to the design
- B. Mechanical anchors used in cracked and uncracked concrete shall have been tested and qualified for use in accordance with ACI 355.2 and ICC-ES ACI93. All anchors shall be installed per the anchor manufacturer's written instructions.
- C. Adhesive anchors used in cracked and uncracked concrete shall have been tested and qualified for use in accordance with ICC-ES AC308. All anchors shall be installed per the anchor manufacturer's written instructions.
- D. Mechanical anchors used in solid grouted masonry shall have been tested and qualified for use in accordance with ICC-ES ACOI. All anchors shall be installed per the anchor manufacturer's written instructions.
- E. Adhesive anchors used in solid grouted masonry shall have been tested and qualified for use in accordance with ICC-ES AC58. All anchors shall be installed per the anchor manufacturer's written instructions.
- F. Anchors used in hollow concrete masonry shall have been tested and qualified in accordance with ICC-ES ACIO6 or ICC-ES AC58 as appropriate. All anchors shall be installed per the anchor manufacturer's written instructions with appropriate screen tubes used for adhesives.

# 7. Timber and Wood Framing:

- A. Quality and construction of wood framing members and their fasteners for load supporting purposes not otherwise indicated on the drawings shall be in accordance with the 2018 International Building Code.
- B. All studs and top and bottom plates shall be Douglas Fir No. 2 grade visually graded lumber, with an allowable fiber stress in bending of 900 psi minimum and an elastic modulus of 1,600,000psi unless noted otherwise. All joist, truss members, and headers to be No. grade (min. unless noted otherwise. All lumber for exterior decks and balconies shall be treated Southern Yellow Pine No. 2 grade.
- C. Service condition dry with moisture content at or below 19% in service.
- D. Laminated veneer lumber (LVL) shall have an allowable flexural stress (F<sub>b</sub>) of 2,600 psi (reduced by size factor) and an elastic modulus (E) of 2,000,000 psi.

# 8. Shop Drawing Review:


- A. Bob D. Campbell and Company, Inc. will review the General Contractor's (GC) shop drawings and related submittals (as indicated below) with respect to the ability of the detailed work, when complete, to be a properly functioning integral element of the overall structural system designed by Bob D. Campbell and Company, Inc. Deferred submittals shall be submitted to the architect of record for review who shall forward to the building official for review and approval. Design calculations for deferred submittals shall be submitted at the same time as the shop drawings for review. Design calculations shall be prepared and sealed by a Professional Engineer licensed in the state of the project. The deferred submittal items shall not be installed until the deferred submittal documents have been approved by the building official.
- B. Prior to submittal of a shop drawing or any related material to Bob D. Campbell and Company, Inc., the GC shall:
- Review each submission for conformance with the means, methods, techniques, sequences and operations of construction and safety precautions and programs incidental thereto, all of which are the sole responsibility of the GC.
- 2) Review and approve each submission.
- 3) Stamp each submission as approved.
  C. Bob D. Campbell and Company, Inc. shall assume that no submission comprises a variation unless the GC advises Bob D. Campbell and Company, Inc. with written documentation.
- D. Shop drawings and related material (if any) required are indicated below. Should Bob D. Campbell and Company, Inc. require more than ten (10) working days to perform the review, Bob D. Campbell and Company, Inc. shall so notify the GC.
  - 1) Concrete mix designs and material certificates including admixtures and compounds applied to the concrete after placement.
  - Reinforcing steel shop drawings including erection drawings and bending details. Bar list will not be reviewed for correct quantities.
- 3) Structural steel shop drawings including erection drawings and piece details. Include miscellaneous framing specified on the structural drawings, but do not submit framing specified on non-structural drawings for Bob D. Campbell and Company, Inc.
- E. Bob D. Campbell and Company, Inc. shall review shop drawings and related materials with comments provided that each submission has met the above requirements. Bob D. Campbell and Company, Inc. shall return without comment unrequired material or submissions without GC approval stamp.


# 9. Statement of Structural Special Inspection:

A. Special inspections are not required for this project.

# 10. Copyright and Disclaimer:


- A. All drawings in the structural set (5-series drawings) are the copyrighted work of Bob D. Campbell and company, Inc. These drawings may not be photographed, traced, or copies in any manner without the written permission of Bob D. Campbell and Company, Inc. Exception: Original drawings may be printed for distribution to the owner, architect, and general contractor for coordination, bidding, and construction. Subcontractors may not reproduce these drawings for any purpose or in any manner.
- B. I, Christopher A. Beverlin, P.E., registered engineer and a representative of Bob D. Campbell and Company, Inc., do hereby accept professional responsibility as required by the professional registration laws of this state for the structural design drawings consisting of S-series drawings. I hereby disclaim responsibility for all other drawings in the construction document package, they being the responsibility of other design professionals whose seals and signed statements may appear elsewhere in the construction document package.

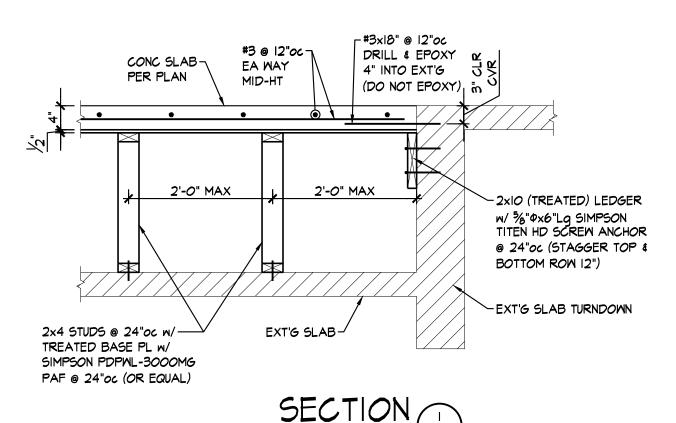


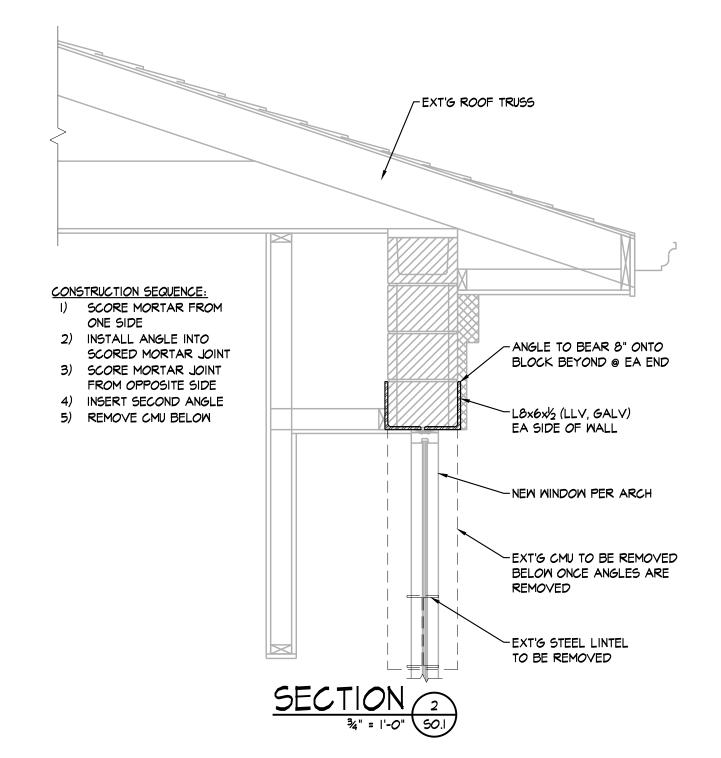

# CONSTRUCTION SEQUENCE:

- I) SCORE MORTAR FROM INTERIOR SIDE
- 2) INSTALL ANGLE AT INTERIOR ANGLE3) SCORE MORTAR JOINT FOR TEMP ANGLE & INSTALL
- 4) REMOVE BRICK BELOW TEMP ANGLE
- 5) SCORE MORTAR FOR EXTERIOR SIDE6) INSTALL ANGLE AT EXTERIOR SIDE
- 7) WELD ON BOTTOM PLATE & THRU-BOLT
- 8) REINSTALL BRICK

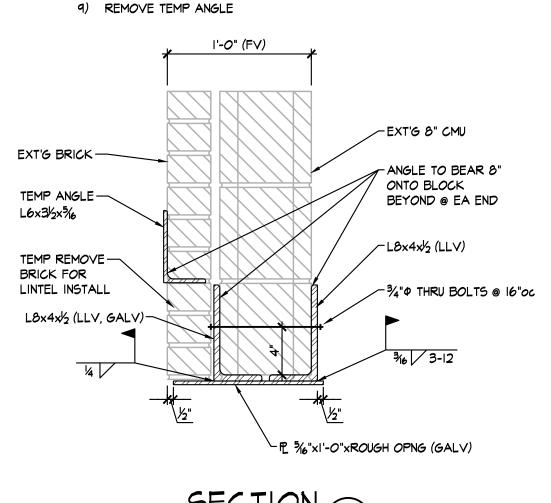

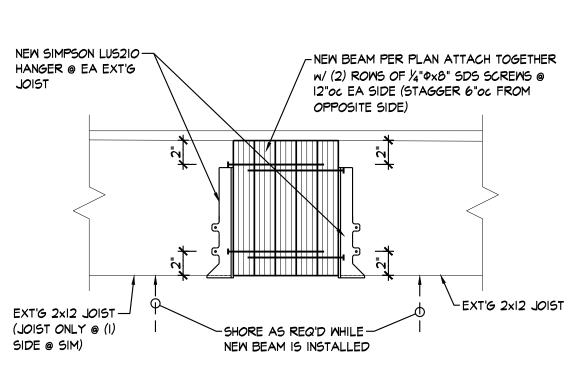

SECTION (4)

PRELIMINARY
PRELIMINARY
ORAWING
CONSTRUCTION
CONSTRUCTION
REVISION:

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signer:

730 P.O. Selin

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ROSSVILLE

DATE: 8-26-2022 JOB: 22-3211

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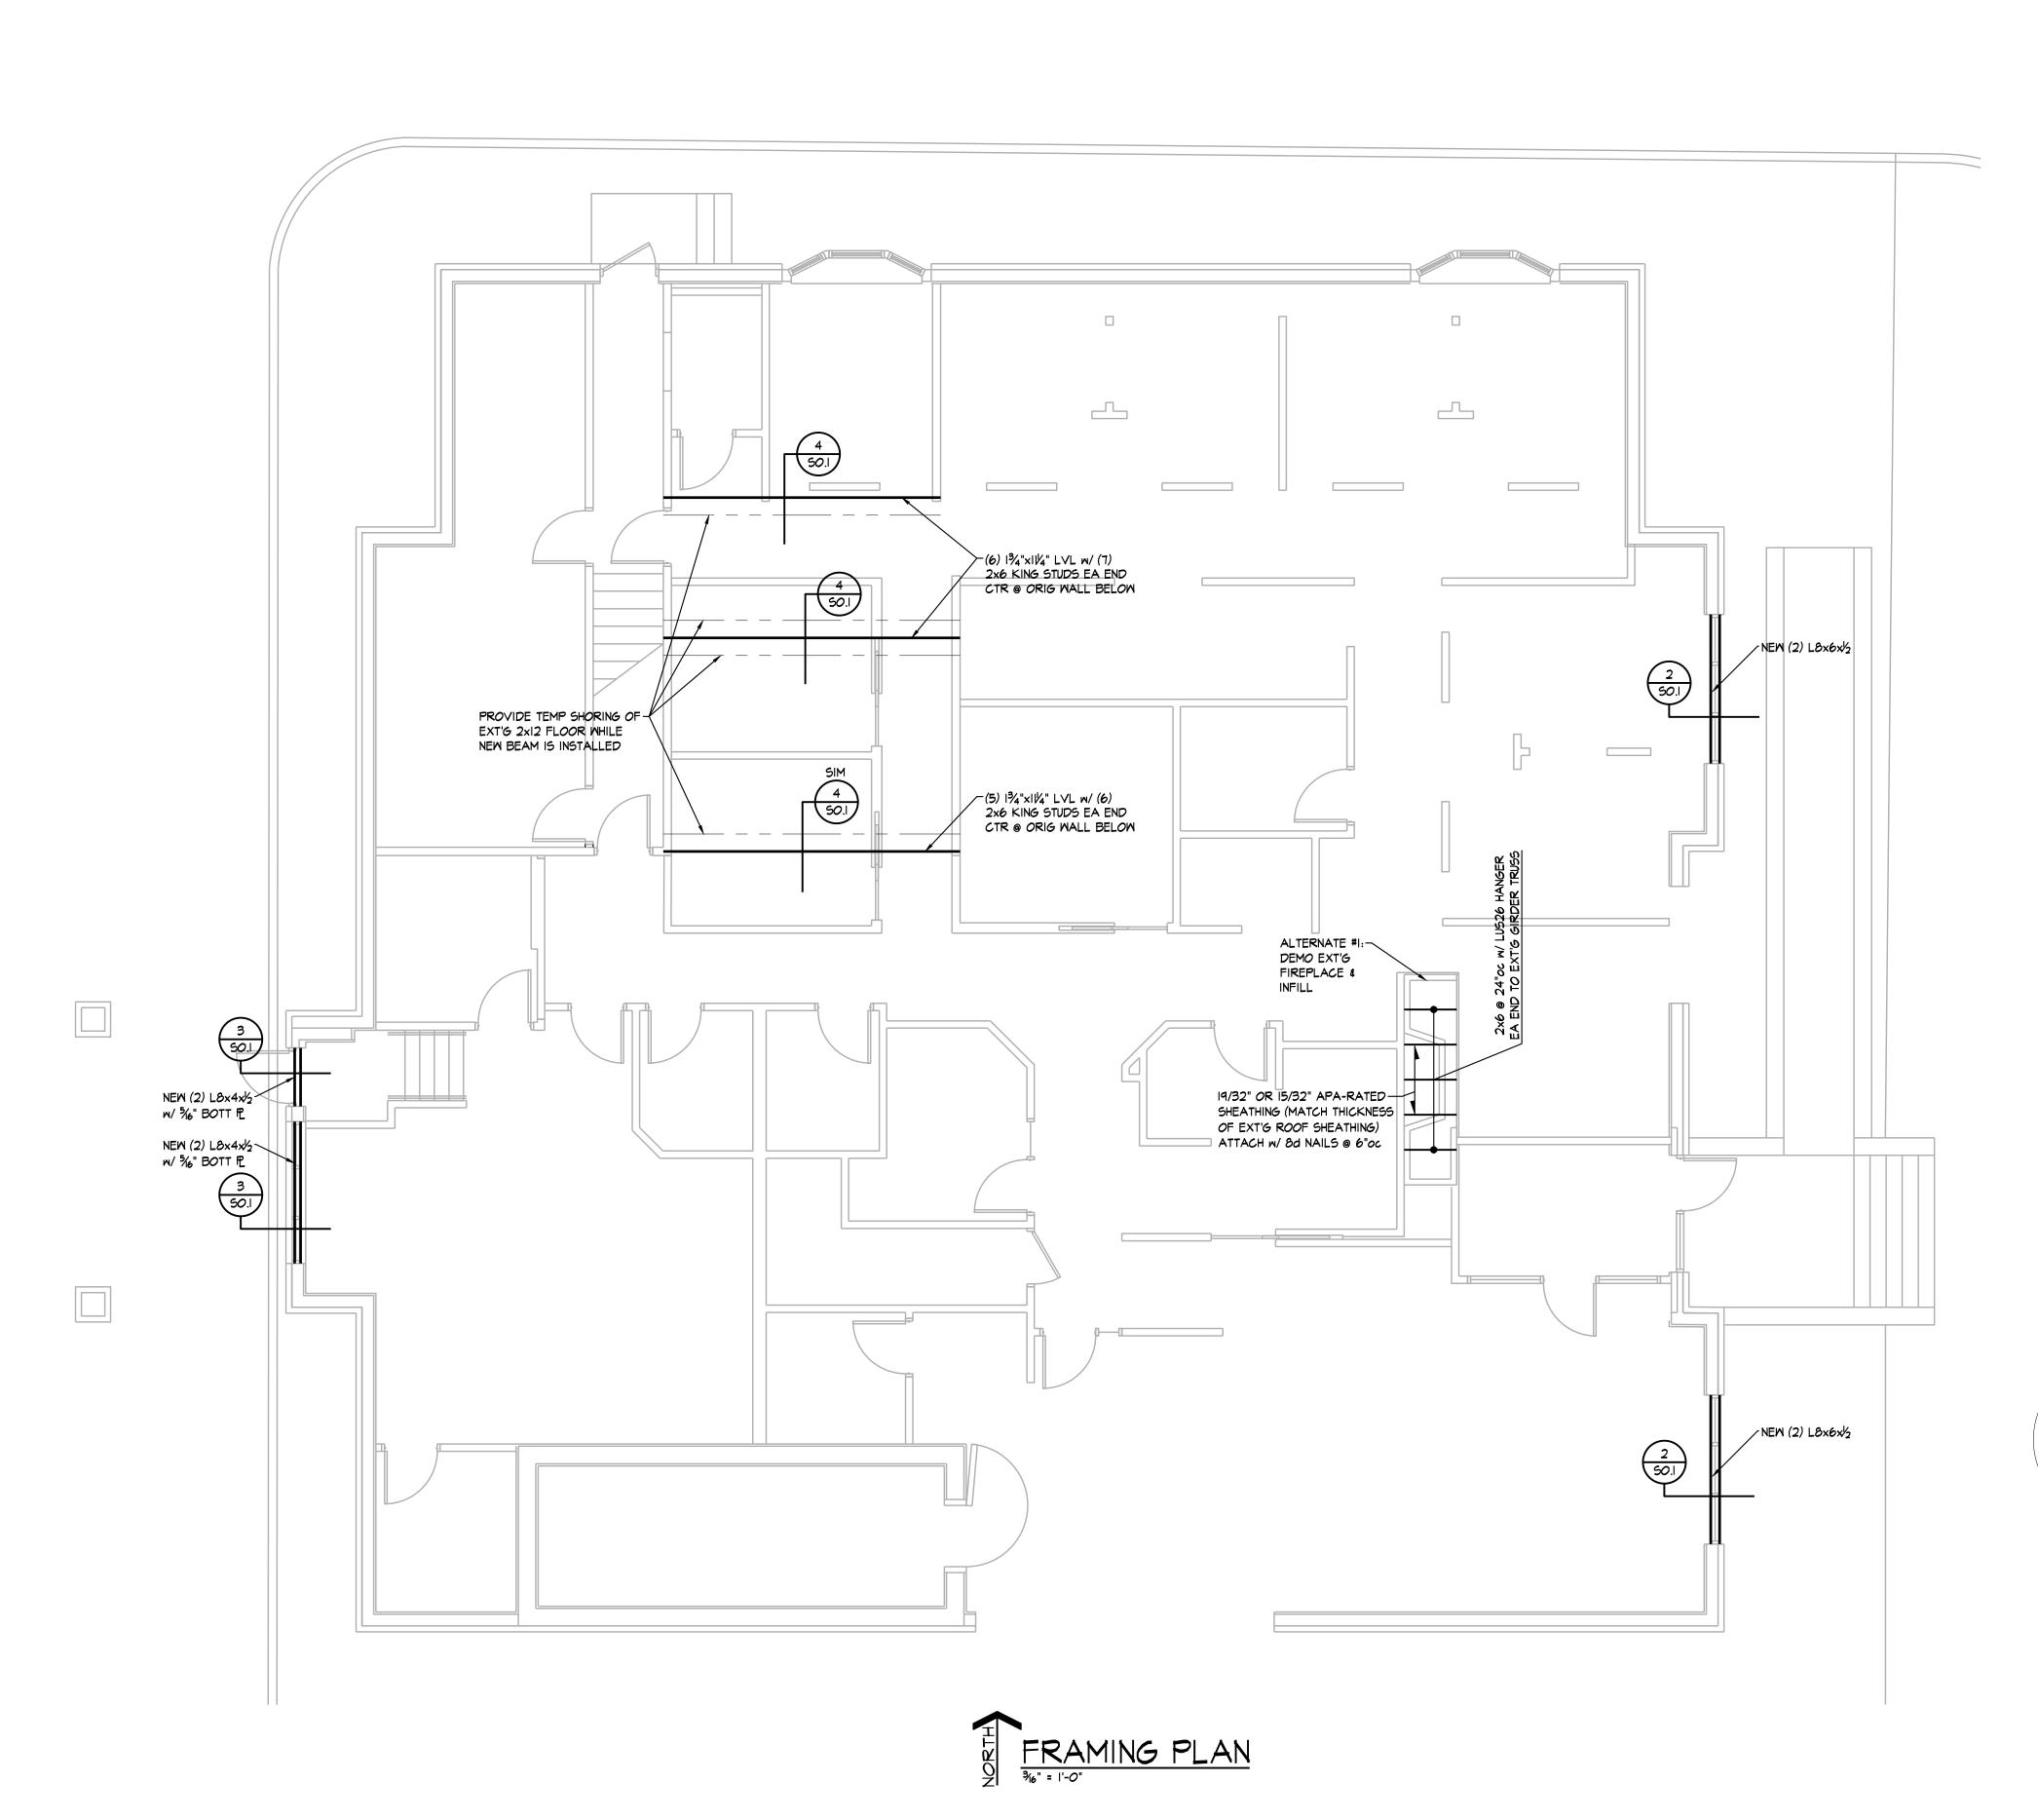
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REVISION:

DATE: 8-26-2022 22-3211 SHEET:



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PRELIMINARY PRELIMING PRAYING CONSTRUCTION CONSTRUCTION

REVISION:

DATE: 8-26-2022 JOB: 22-3211

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SHEET:

2. ALL PIPING TAKEN OUT OF SERVICE SHALL BE REMOVED. WHERE PIPING TO BE REMOVED IS CONNECTED TO EXISTING PIPING TO REMAIN, PIPING SHALL BE REMOVED BACK TO MAIN AND CAPPED, UNLESS INDICATED OTHERWISE.

3. WHERE PIPING TAKEN OUT OF SERVICE IS LOCATED BELOW SLAB AND IS UNABLE TO BE REMOVED, CAP BELOW SLAB.

4. ALL DUCTWORK TAKEN OUT OF SERVICE SHALL BE REMOVED.

5. ALL MECHANICAL EQUIPMENT TAKEN OUT OF SERVICE SHALL BE REMOVED.

6. COORDINATE CUTTING, PATCHING OF EXISTING WALLS, CEILINGS, ROOF AND FLOORS AFFECTED BY MECHANICAL DEMOLITION WITH G.C.

# GENERAL ELECTRICAL DEMOLITION NOTES

1. REMOVE ALL NM, BX, MC, AC AND OTHER CABLE SYSTEMS AND WIRING FOR ALL ABANDONED CIRCUITS.

2. REMOVE ALL ABANDONED CONDUITS ABOVE LAY-IN CEILINGS, EXPOSED CONDUITS, FLEXIBLE CONDUITS, SURFACE RACEWAY, SURFACE MOUNTED OUTLET/JUNCTION BOXES AND EQUIPMENT UNLESS NOTED OTHERWISE.

3. WHERE ABANDONED FEEDERS AND BRANCH CIRCUITS ARE CONCEALED WITHIN WALLS, FLOORS AND HARD CEILINGS THAT ARE TO REMAIN, REMOVE ALL WIRING AND CAP

4. WHERE ABANDONED OUTLET AND JUNCTION BOXES ARE RECESSED FLUSH IN WALLS, FLOORS AND HARD CEILINGS THAT ARE TO REMAIN, REMOVE ALL WIRING AND WIRING DEVICES AND PROVIDE BLANK STAINLESS STEEL COVERPLATES FOR BOXES 6"x6" AND SMALLER. REMOVE BOXES LARGER THAN 6"x6" AND PATCH SURFACE TO MATCH EXISTING. COORDINATE WITH ARCHITECT FOR FINAL DIRECTION.

5. ALL EQUIPMENT, FIXTURES, RACEWAY, WIRING AND DEVICES WHICH ARE REMOVED SHALL BE REMOVED FROM THE JOB SITE BY THIS CONTRACTOR, UNLESS DIRECTED OTHERWISE BY THE ARCHITECT OR OWNER'S REPRESENTATIVE. CONFORM TO ALL LAWS AND ORDINANCES IN EFFECT CONCERNING THE PROPER DISPOSAL OF LUMINAIRES AND LAMPS.

6. COORDINATE THE REMOVAL OF MECHANICAL AND PLUMBING EQUIPMENT WITH THE MECHANICAL AND PLUMBING CONTRACTORS. ELECTRICAL CONTRACTOR SHALL DISCONNECT AND REMOVE ELECTRICAL POWER AND CONTROL CIRCUITS FOR EQUIPMENT BEING REMOVED. REMOVE ALL ELECTRICAL EQUIPMENT ASSOCIATED WITH DEMOLISHED MECHANICAL AND PLUMBING EQUIPMENT (DISCONNECT SWITCHES, MOTOR STARTERS, RELAYS, ETC).

7. <u>SCOPE OF DEMOLITION IS APPROXIMATE</u>. INFORMATION CONVEYED ON THIS DRAWING IS BASED ON EXISTING BUILDING DRAWINGS AND CASUAL FIELD OBSERVATIONS. THE CONTRACTOR SHALL BE RESPONSIBLE FOR FILED DETERMINING EXACT SCOPE OF DEMOLITION AND COORDINATION WITH THE ARCHITECT AND OWNER.

# GENERAL ELECTRICAL DEMOLITION NOTES

- 1. REMOVE ALL NM, BX, MC, AC AND OTHER CABLE SYSTEMS AND WIRING FOR ALL ABANDONED CIRCUITS.
- REMOVE ALL ABANDONED CONDUITS ABOVE LAY-IN CEILINGS, EXPOSED CONDUITS, FLEXIBLE CONDUITS, SURFACE RACEWAY, SURFACE MOUNTED OUTLET/JUNCTION BOXES AND EQUIPMENT UNLESS NOTED OTHERWISE.
- 3. WHERE ABANDONED FEEDERS AND BRANCH CIRCUITS ARE CONCEALED WITHIN WALLS, FLOORS AND HARD CEILINGS THAT ARE TO REMAIN, REMOVE ALL WIRING AND CAP
- WHERE ABANDONED OUTLET AND JUNCTION BOXES ARE RECESSED FLUSH IN WALLS. FLOORS AND HARD CEILINGS THAT ARE TO REMAIN, REMOVE ALL WIRING AND WIRING DEVICES AND PROVIDE BLANK STAINLESS STEEL COVERPLATES FOR BOXES 6"x6" AND SMALLER. REMOVE BOXES LARGER THAN 6"x6" AND PATCH SURFACE TO MATCH EXISTING. COORDINATE WITH ARCHITECT FOR FINAL DIRECTION.
- 5. ALL EQUIPMENT, FIXTURES, RACEWAY, WIRING AND DEVICES WHICH ARE REMOVED SHALL BE REMOVED FROM THE JOB SITE BY THIS CONTRACTOR, UNLESS DIRECTED OTHERWISE BY THE ARCHITECT OR OWNER'S REPRESENTATIVE. CONFORM TO ALL LAWS AND ORDINANCES IN EFFECT CONCERNING THE PROPER DISPOSAL OF LUMINAIRES AND LAMPS.
- COORDINATE THE REMOVAL OF MECHANICAL AND PLUMBING EQUIPMENT WITH THE MECHANICAL AND PLUMBING CONTRACTORS. ELECTRICAL CONTRACTOR SHALL DISCONNECT AND REMOVE ELECTRICAL POWER AND CONTROL CIRCUITS FOR EQUIPMENT BEING REMOVED. REMOVE ALL ELECTRICAL EQUIPMENT ASSOCIATED WITH DEMOLISHED MECHANICAL AND PLUMBING EQUIPMENT (DISCONNECT SWITCHES, MOTOR STARTERS RELAYS, ETC).

EXISTING POWER UTILITY C:T CABINET

& METER TO REMAIN ──☐

# (#) M/E DEMOLTION PLAN NOTES BY SYMBOL


- REMOVE LIGHT FIXTURE AND ASSOCIATED CIRCUITRY
- REMOVE RECEPTACLE AND ASSOCIATED CIRCUITRY.
- 3. REMOVE LIGHT SWITCH AND ASSOCIATED CIRCUITRY.
- 4. REMOVE TELECOM/SECURITY OUTLET AND ASSOCIATED CABLING.
- 5. REMOVE DISCONNECT SWITCH AND ASSOCIATED CIRCUITRY.
- 6. REMOVE AUDIO SYSTEM SPEAKER AND ASSOCIATED CABLING.
- 7. REMOVE AUDIO SYSTEM VOLUME CONTROL STATION AND ASSOCIATED CABLING.
- 8. REMOVE CEILING FAN AND ASSOCIATED CIRCUITRY. 9. REMOVE PANELBOARD AND ASSOCIATED FEEDER AND BRANCH CIRCUITS.
- 10. REMOVE EXISTING PLUMBING FIXTURE AND ALL ASSOCIATED INSTALLATION.
- 11. REMOVE EXISTING HOT WATER HEATER, EXISTING HOT WATER PIPING AND ALL ASSOCIATED MECHANICAL INSTALLATION.
- 12. REMOVE EXISTING FLUE PIPING AND TERMINATION AT ROOF. COORDINATE PATCHING OF ROOF WITH ARCHITECT AND G.C.
- 13. REMOVE EXISTING FURNACE AND ALL ASSOCIATED MECHANICAL AND ELECTRICAL INSTALLATION.

14. REMOVE EXISTING CONDENSING UNIT AND ALL ASSOCIATED MECHANICAL AND

- ELECTRICAL INSTALLATION.
- 15. REMOVE ALL EXISTING AIR DEVICES AND SUPPLY AND RETURN DUCTWORK AND ASSOCIATED INSTALLATION.

- 16. REMOVE EXISTING EXHAUST FAN AND ASSOCIATED MECHANICAL AND ELECTRICAL INSTALLATION.
- 17. EXISTING EXHAUST DUCT AND RELIEF LOUVER TO REMAIN FOR RE-USE. SEE NEW WORK PLANS FOR ADDITIONAL INFO.
- 18. REMOVE EXISTING ELECTRIC BASEBOARD HEATER AND ALL ASSOCIATED MECHANICAL AND ELECTRICAL INSTALLATION.
- 19. REMOVE EXISTING RADIANT CEILING HEATER AND ALL ASSOCIATED MECHANICAL AND ELECTRICAL INSTALLATION.
- 20. REMOVE ALL EXISTING DOMESTIC WATER PIPING AND ASSOCIATED INSTALLATION.
- SEE NEW WORK PLANS FOR INFO ON NEW WATER SERVICE.
- 21. EXISTING GAS METER AND REGULATOR TO REMAIN. REMOVE ALL GAS PIPING TAKEN OUT OF SERVICE BACK TO EXISTING METER AND REGULATOR.
- 22. EXISTING 4" DRAIN TO REMAIN. FIELD VERIFY EXACT SIZE AND LOCATION. SCOPE EXISTING DRAIN WITH CAMERA TO DETERMINE CONDITION PRIOR TO RE-USE.
- 23. REMOVE GAS PIPING TO FIRE PLACE TAKEN OUT OF SERVICE AND ABANDONED IN PLACE. CAP FLUE WEATHERTIGHT AT ROOF COORDINATE WITH ARCHITECT AND
- 24. ALTERNATE 1: REMOVE GAS PIPING, FLUE PIPING AND ALL ASSOCIATED MECHANICAL INSTALLATION FOR FIRE PLACE TO BE REMOVED. COORDINATE WITH ARCHITECT AND G.C.
- 25. REMOVE EXISTING INTAKE LOUVER, COORDINATE PATCHING OF WALL WITH



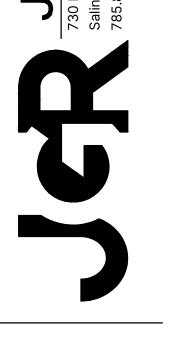

REVISION:

DATE: 9-20-2023 22-3211 SHEET NO .:

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WALL SWITCH TO REMAIN

MECHANICAL DEMO SYMBOLS

HVAC EQUIPMENT TO BE DEMOLISHED

---- DUCTWORK TO BE DEMOLISHED

---- PIPING TO BE DEMOLISHED

DUCTWORK TO REMAIN

-- D -- CONDENSATE PIPING TO BE DEMOLISHED


THERMOSTAT TO BE DEMOLISHED

SQUARE SUPPLY DIFFUSER TO BE DEMOLISHED

SQUARE RETURN DIFFUSER TO BE DEMOLISHED


- WALL SWITCH TO BE REMOVED
- EXISTING DUPLEX RECEPTACLE TO REMAIN
- DUPLEX RECEPTACLE TO BE REMOVED EXISTING TELECOM OUTLET TO REMAIN
- TELECOM OUTLET TO BE REMOVED
- PA SPEAKER TO BE REMOVED
- FIRE ALARM SYSTEM NOTIFICATION HORN/STROBE
- FIRE ALARM SYSTEM SMOKE DETECTOR

# +-----+-----| |------

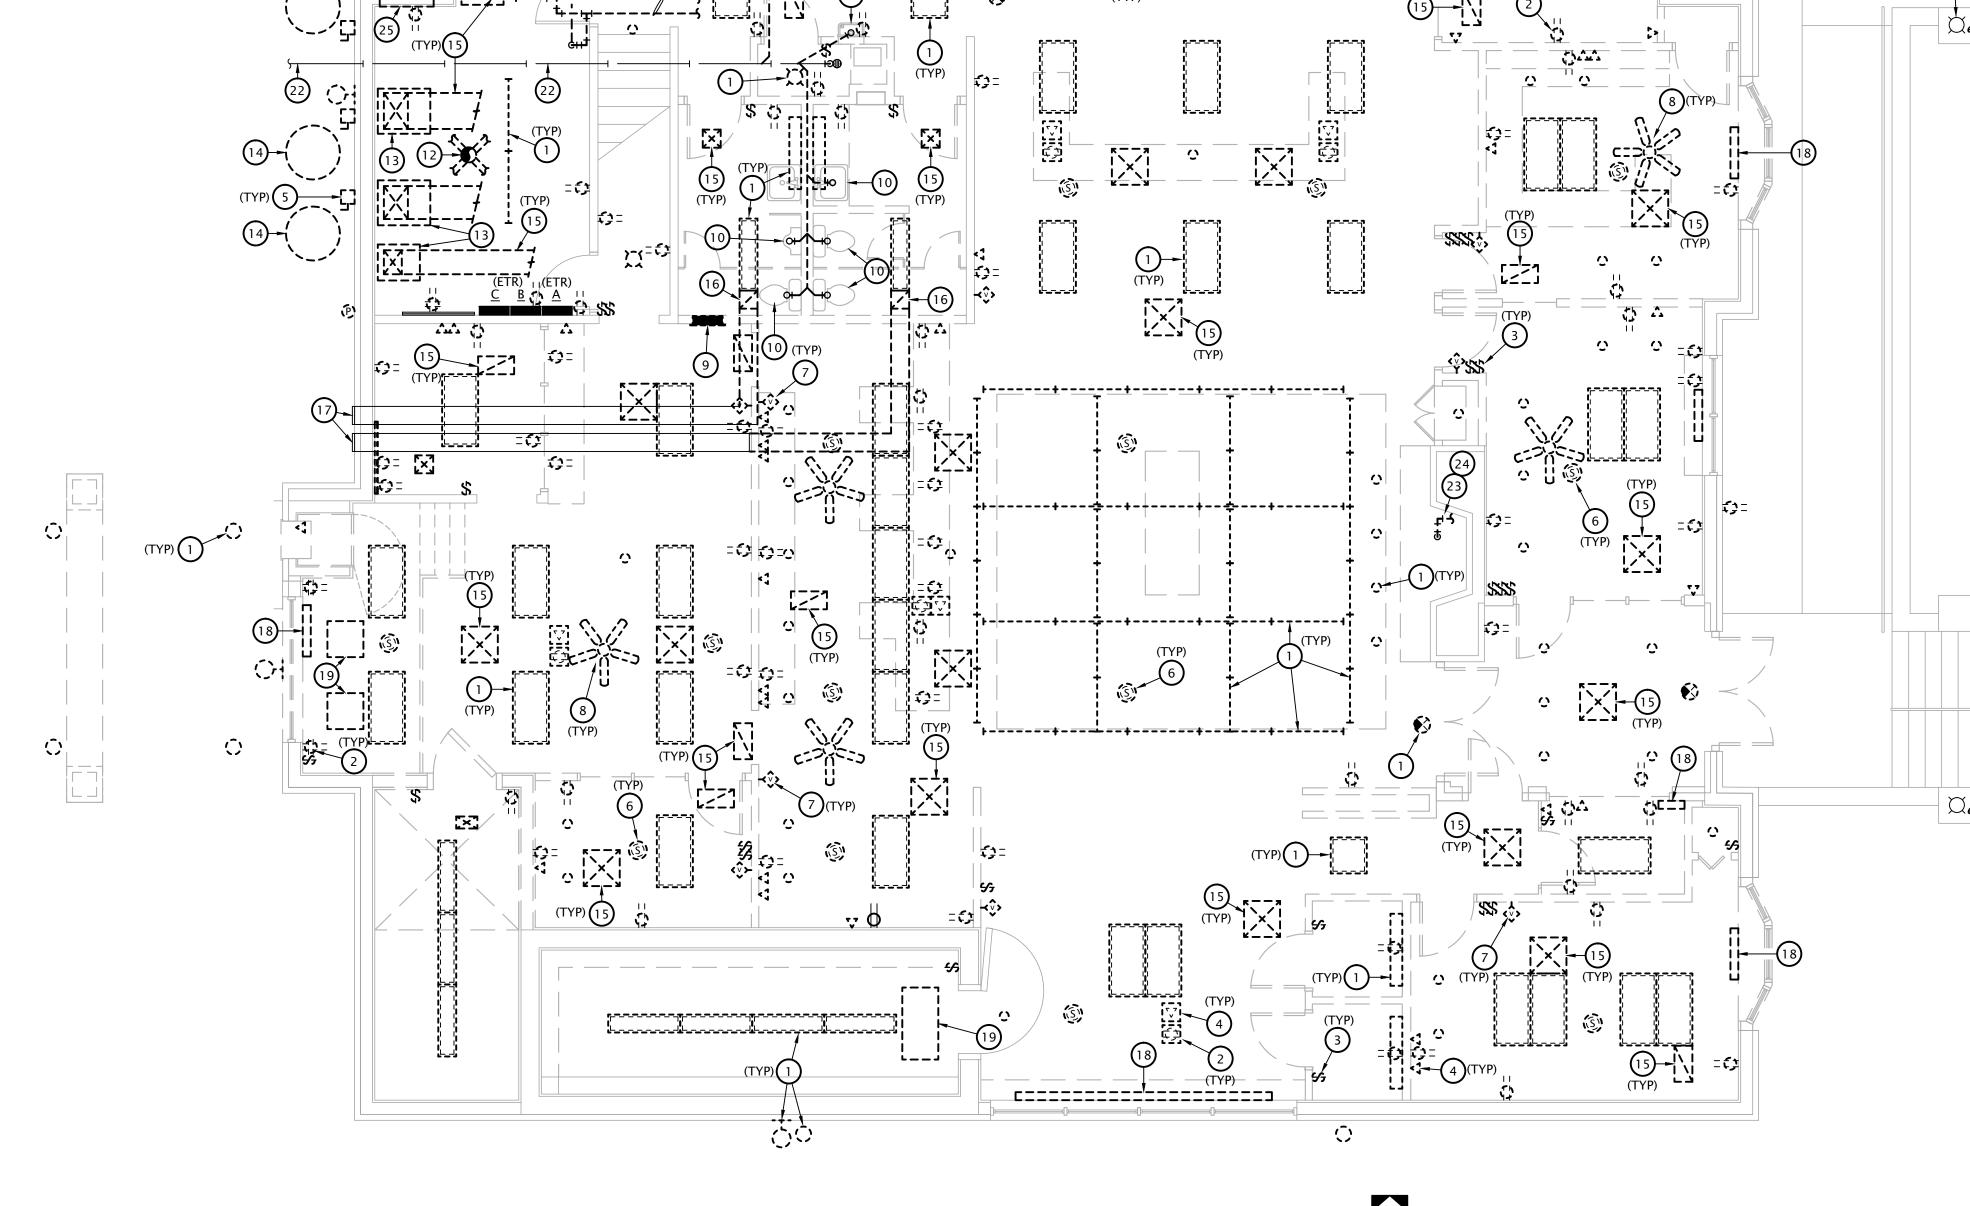


# **MECHANICAL SYMBOLS**

MLCII	ANICAL STMBOLS		
1	THERMOSTAT	o <del>-</del>	PIPE TURNING UP
T	TEMPERATURE SENSOR	G <del>I -</del>	PIPE TURNING DOWN
$\oplus$	HUMIDISTAT	<del> </del>	90° ELBOW
8	CONTROL CABLE, VERIFY TYPE WITH EQUIPMENT MANUFACTURER	<b>x</b> +	45° ELBOW
$\boxtimes$	SQUARE SUPPLY DIFFUSER - TYPE AND AIRFLOW INDICATED	<del>'†'</del> +o+	TEE UP
	SQUARE RETURN GRILLE - TYPE INDICATED	<del>-131-</del>	TEE DOWN
□→	WALL DIFFUSER	<u> </u>	SANITARY DRAIN BELOW GRADE
XX X	GRILLE/DIFFUSER TAG  TOP: DEVICE TAG (SEE SCHEDULE)		SANITARY DRAIN ABOVE GRADE
[XX]	MIDDLE: NECK SIZE BOTTOM: AIRFLOW		SANITARY VENT
_	MANUAL BALANCING DAMPER	·	DOMESTIC COLD WATER
	RECTANGULAR RETURN OR RELIEF AIR DUCT UP	<del></del> · ·	DOMESTIC HOT WATER RESIDE
	RECTANGULAR RETURN OR RELIEF AIR DUCT UP	w	DOMESTIC HOT WATER RECIRC  WATER SERVICE PIPING
	RECTANGULAR SUPPLY AIR DUCT UP	—— G ——	NATURAL GAS
×	RECTANGULAR SUPPLY AIR DUCT DOWN	—— A ——	COMPRESSED AIR
	RECTANGULAR RETURN OR EXHAUST AIR DUCT DOWN	v	VACUUM LINE
	ROUND DUCT UP	ф	UNION
0	ROUND DUCT DOWN	Ť	BALL VALVE
~~	FLEXIBLE DUCTWORK - MAX 5'	Ā	GAS COCK
	RIGID DUCT RUNOUT	® ₩	NATURAL GAS REGULATOR CONNECT TO EXISTING
	90° ELBOW WITH TURNING VANES		

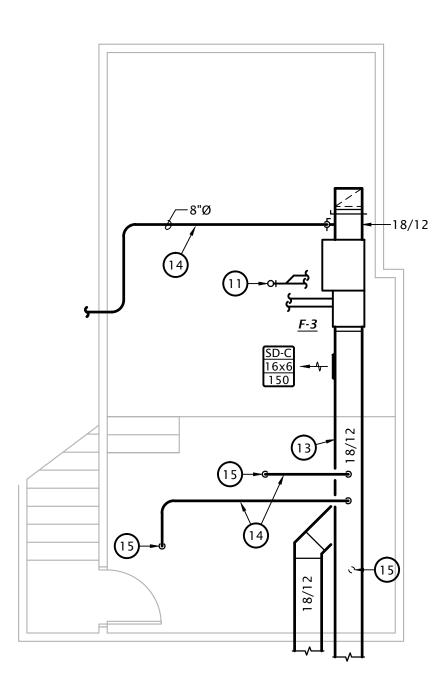



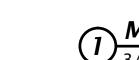

# 10. ROUTE WATER HEATER PVC VENT/INTAKE PIPING FROM UNIT TO MANUFACTURER'S

- ROOF TERMINATION KIT

**# MECHANICAL PLAN NOTES BY SYMBOL** 

1. MOUNT CONDENSING UNIT/HEAT PUMP ON EXISTING CONCRETE PAD. WHERE EXISTING

EVAPORATOR COIL. PENETRATE EXTERIOR WALL 18" AFF. UTILIZE MANUFACTURED

CONCRETE PAD IS NOT ADEQUATE PROVIDE 3-1/2" CONCRETE PAD. PAD SHALL

EXTEND 6" BEYOND BASE OF UNIT IN ALL DIRECTIONS. COORDINATE WITH G.C.

2. ROUTE REFRIGERANT PIPING BETWEEN CONDENSING UNIT AND CORRESPONDING

3. ROUTE FURNACE PVC VENT/INTAKE PIPING FROM FURNACE TO MANUFACTURER'S

4. CONNECT 8" OUTDOOR AIR DUCT TO RETURN AIR DUCT. PROVIDE BALANCING

5. CONNECT 6" OUTDOOR AIR DUCT TO RETURN AIR DUCT. PROVIDE BALANCING

6. ROUTE REFRIGERANT PIPING BETWEEN CONDENSING UNIT AND CORRESPONDING

7. TRANSITION DUCT TO TO FIT BETWEEN 2ND FLOOR AND FIRST FLOOR CEILING.

INDOOR UNIT. PENETRATE EXTERIOR WALL 18" AFF. UTILIZE MANUFACTURED WALL

8. EXTEND 6"Ø EXHAUST DUCTS TO AND CONNECT TO EXISTING EXHAUST DUCT/LOUVER.

9. EXISTING EXHAUST DUCT AND LOUVER TO BE RE-USED. FIELD VERIFY EXISTING DUCT

HAS WORKING BACKDRAFT DAMPER, PROVIDE NEW IF NEEDED. REMOVE EXISTING PORTIONS OF EXHAUST DUCT NO LONGER IN SERVICE. CAP AND SEAL EXISTING DUCT

WALL PENETRATION EQUAL TO AIREX 'TITAN OUTLET'.

CONCENTRIC WALL TERMINATION KIT.

DAMPER, SEE M6.1 FOR MORE INFORMATION.

DAMPER, SEE M6.1 FOR MORE INFORMATION.

PENETRATION EQUAL TO AIREX 'TITAN OUTLET'.

FIELD VERIFY EXACT LOCATION OF EXISTING.

- FIELD COORDINATE EXACT LOCATION WITH OTHER TRADES AND EXISTING
- ELECTRICAL SPACE ABOVE PANELS.
- 17. ALTERNATE #4: PROVIDE NEW 18"Wx12"H EXHAUST LOUVER EQUAL TO GREENHECK MODEL ESD-435 WITH BIRDSCREEN AT WALL IN NEW TRIM BAND. MODIFY EXISTING EXHAUST DUCTWORK AS REQUIRED TO TRANSITION TO NEW LOUVER. FIELD VERIFY EXACT REQUIREMENTS AND COORDINATE WITH G.C. COORDINATE EXACT COLOR
- 17. ALTERNATE #4: PROVIDE NEW 12"Wx12"H EXHAUST LOUVER EQUAL TO GREENHECK MODEL ESD-435 WITH BIRDSCREEN AT WALL IN NEW TRIM BAND. MODIFY EXISTING EXHAUST DUCTWORK AS REQUIRED TO TRANSITION TO NEW LOUVER. FIELD VERIFY EXACT REQUIREMENTS AND COORDINATE WITH G.C. COORDINATE EXACT COLOR









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9-20-2023 DATE: 22-3211 SHEET NO.:

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2. CONNECT TO EXISTING 4" SANITARY DRAIN. FIELD VERIFY EXACT SIZE AND LOCATION OF EXISTING PIPING. SCOPE EXISTING PIPING WITH CAMERA TO VERIFY CONDITION.

3. ROUTE VACUUM PIPING TO UTILITY CENTER. PROVIDE 5/8" RISER TERMINATED 2" A.F.F. COORDINATE EXACT ROUGH-IN LOCATION AND INSTALLATION REQUIREMENTS WITH DENTAL EQUIPMENT SUPPLIER. COORDINATE FLOOR CUTTING AND PATCHING WITH G.C.

4. VACUUM LINE UP TO VACUUM PUMP. CONNECT TO VACUUM PUMP AND COORDINATE EXACT REQUIREMENTS WITH DENTAL EQUIPMENT SUPPLIER.

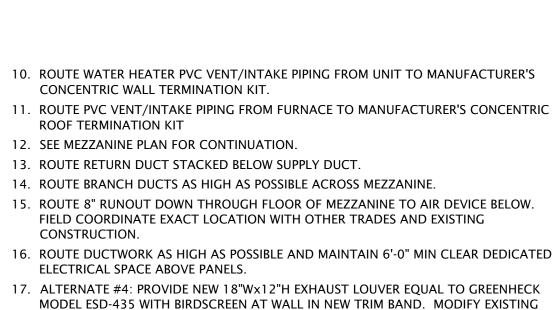5. ROUTE VACUUM PIPING BELOW GRADE. SLOPE PIPING AT MIN SLOPE OF 1/4" PER 10 FT TOWARDS VACUUM PUMP. COORDINATE EXACT INSTALLATION REQUIREMENTS WITH DENTAL EQUIPMENT SUPPLIER. COORDINATE CUTTING AND PATCHING OF EXISTING SLAB WITH ARCH AND G.C.

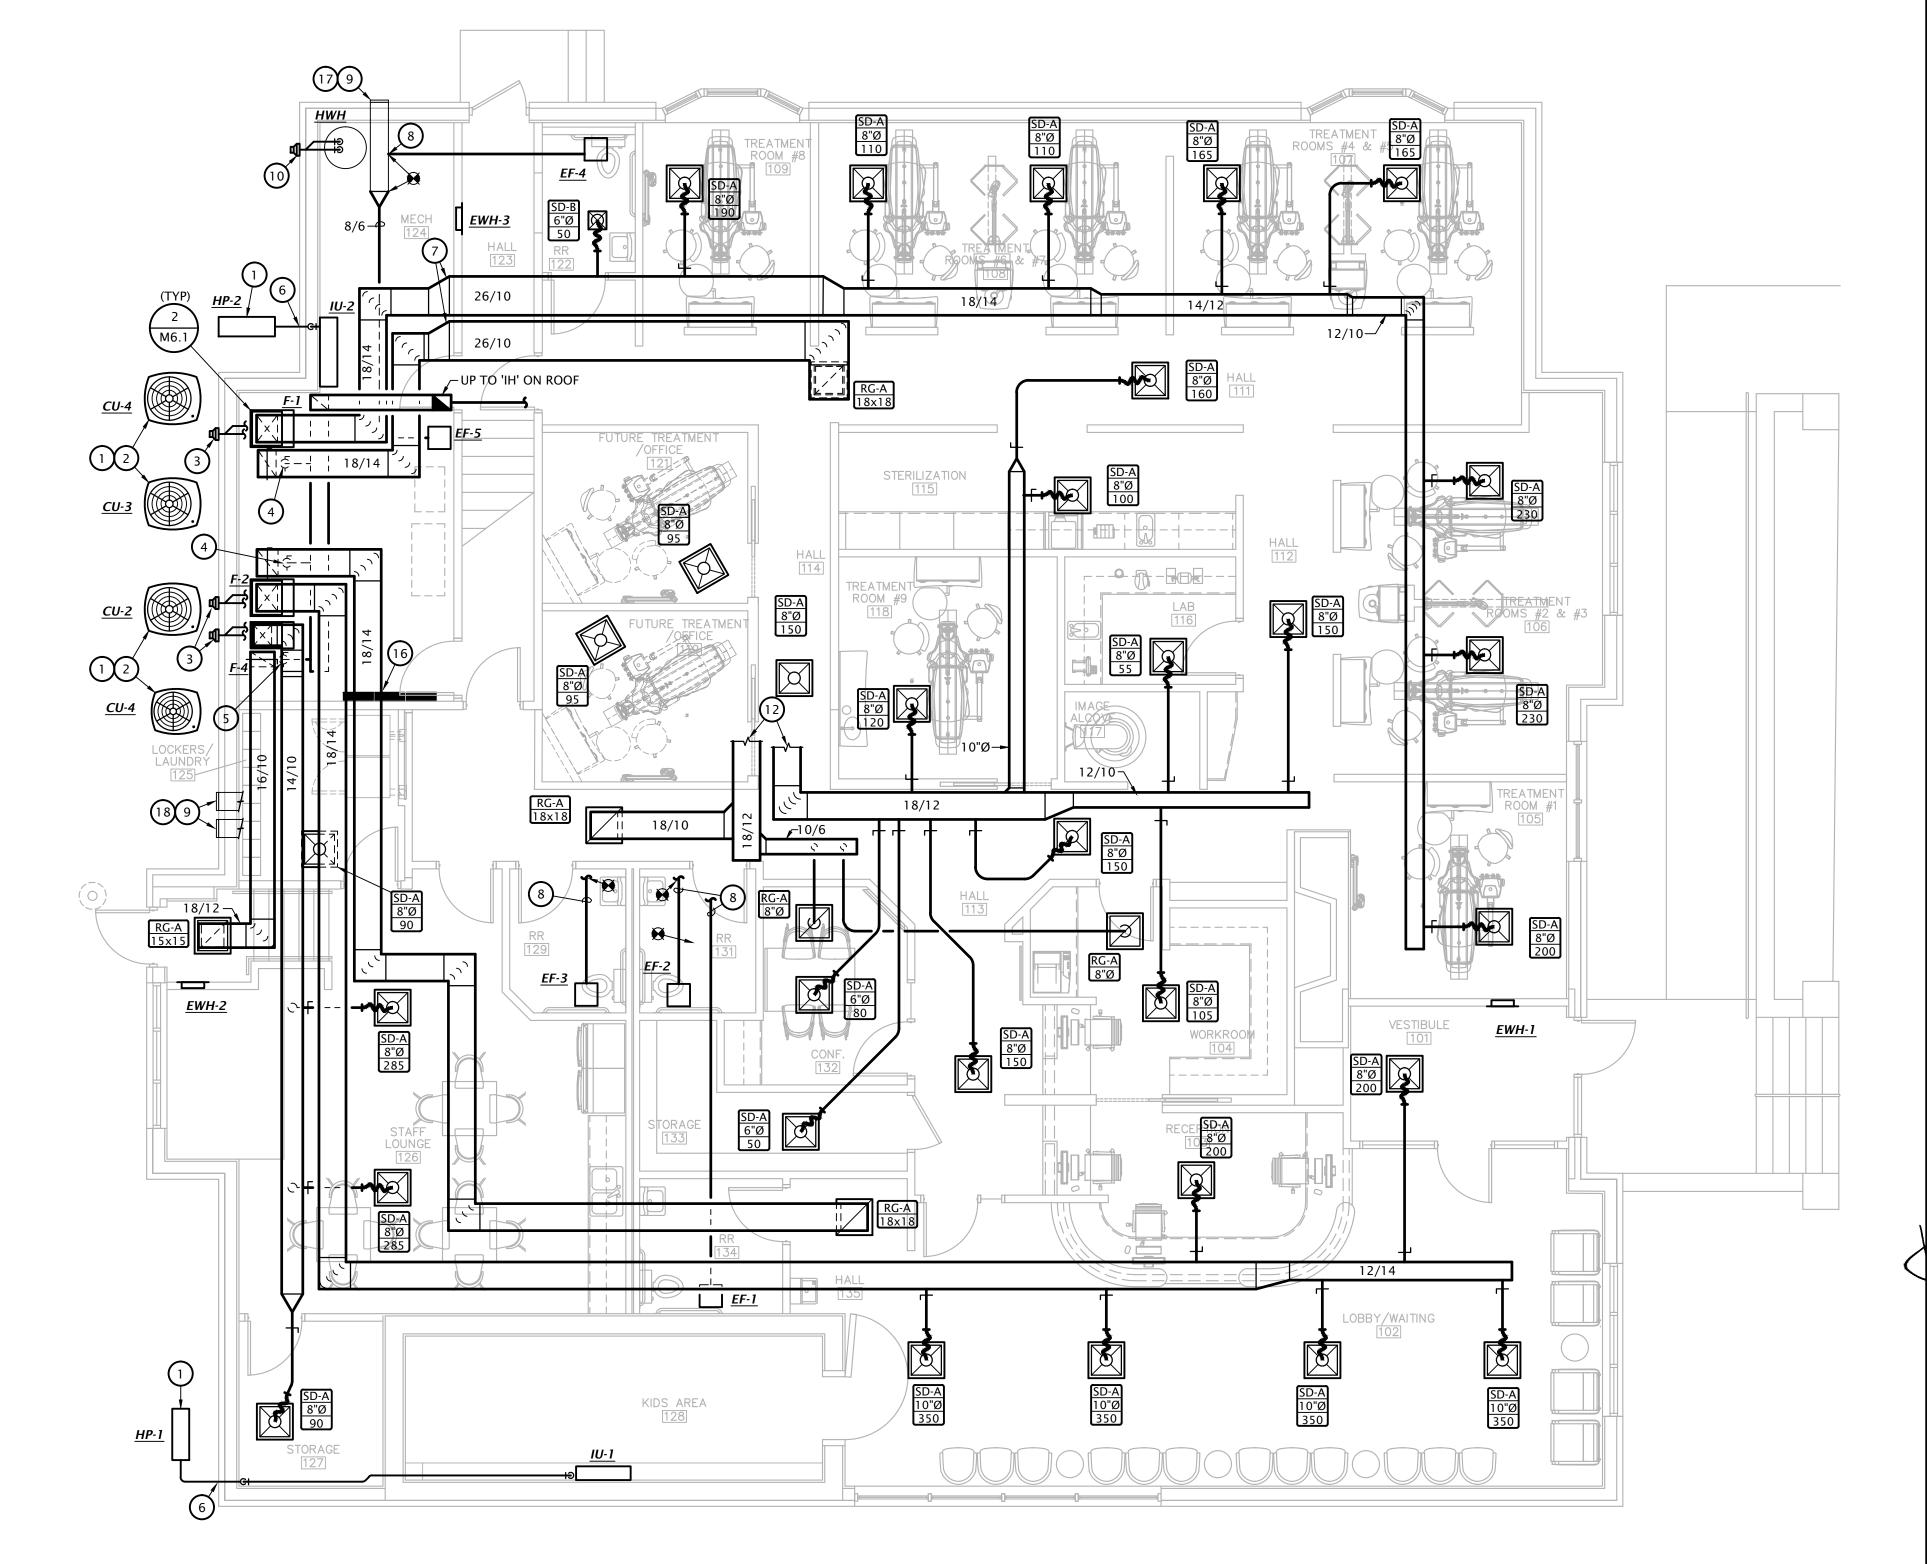6. PROVIDE 1-1/2" TRAPPED DRAIN LINE FOR VACUUM PUMP. PROVIDE 1-1/2" VENT AFTER TEE FOR CONNECTION TO PUMP. COORDINATE EXACT ROUGH-IN LOCATION AND INSTALLATION REQUIREMENTS WITH DENTAL EQUIPMENT SUPPLIER.

7. PROVIDE 3/4" INDIRECT CONNECTION AT TAILPIECE AT 'BS' FOR CONNECTION OF ULTRASONIC CLEANER. COORDINATE EXACT REQUIREMENTS WITH DENTAL EQUIPMENT SUPPLIER.

8. PLASTER TRAP PROVIDED BY DENTAL EQUIPMENT SUPPLIER TO BE INSTALLED BY PLUMBING CONTRACTOR. COORDINATE EXACT REQUIREMENTS WITH EQUIPMENT SUPPLIER.

9. PROVIDE 3/4" VACUUM BRANCH LINE AND TERMINATE WITH 1/2" FPT FITTING AT FINISH. COORDINATE EXACT ROUGH-IN LOCATION AND INSTALLATION REQUIREMENTS WITH DENTAL EQUIPMENT SUPPLIER.


10. PROVIDE 2" VENT FROM VACUUM PUMP LOCATION ROUTED ABOVE CEILING TO EXTERIOR. TERMINATE VENT WITH ELBOW DOWN WITH INSECT SCREEN. COORDINATE EXACT INSTALLATION REQUIREMENTS AND ROUGH-IN LOCATION WITH DENTAL EQUIPMENT SUPPLIER.




**REVISION:** 

9-20-2023 DATE: 22-3211 SHEET NO.:

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3. CONNECT 3/4" GAS TO FURNACE, PROVIDE GAS COCK, UNION AND 4. CONNECT 1" GAS TO FURNACE, PROVIDE GAS COCK, UNION AND DIRT

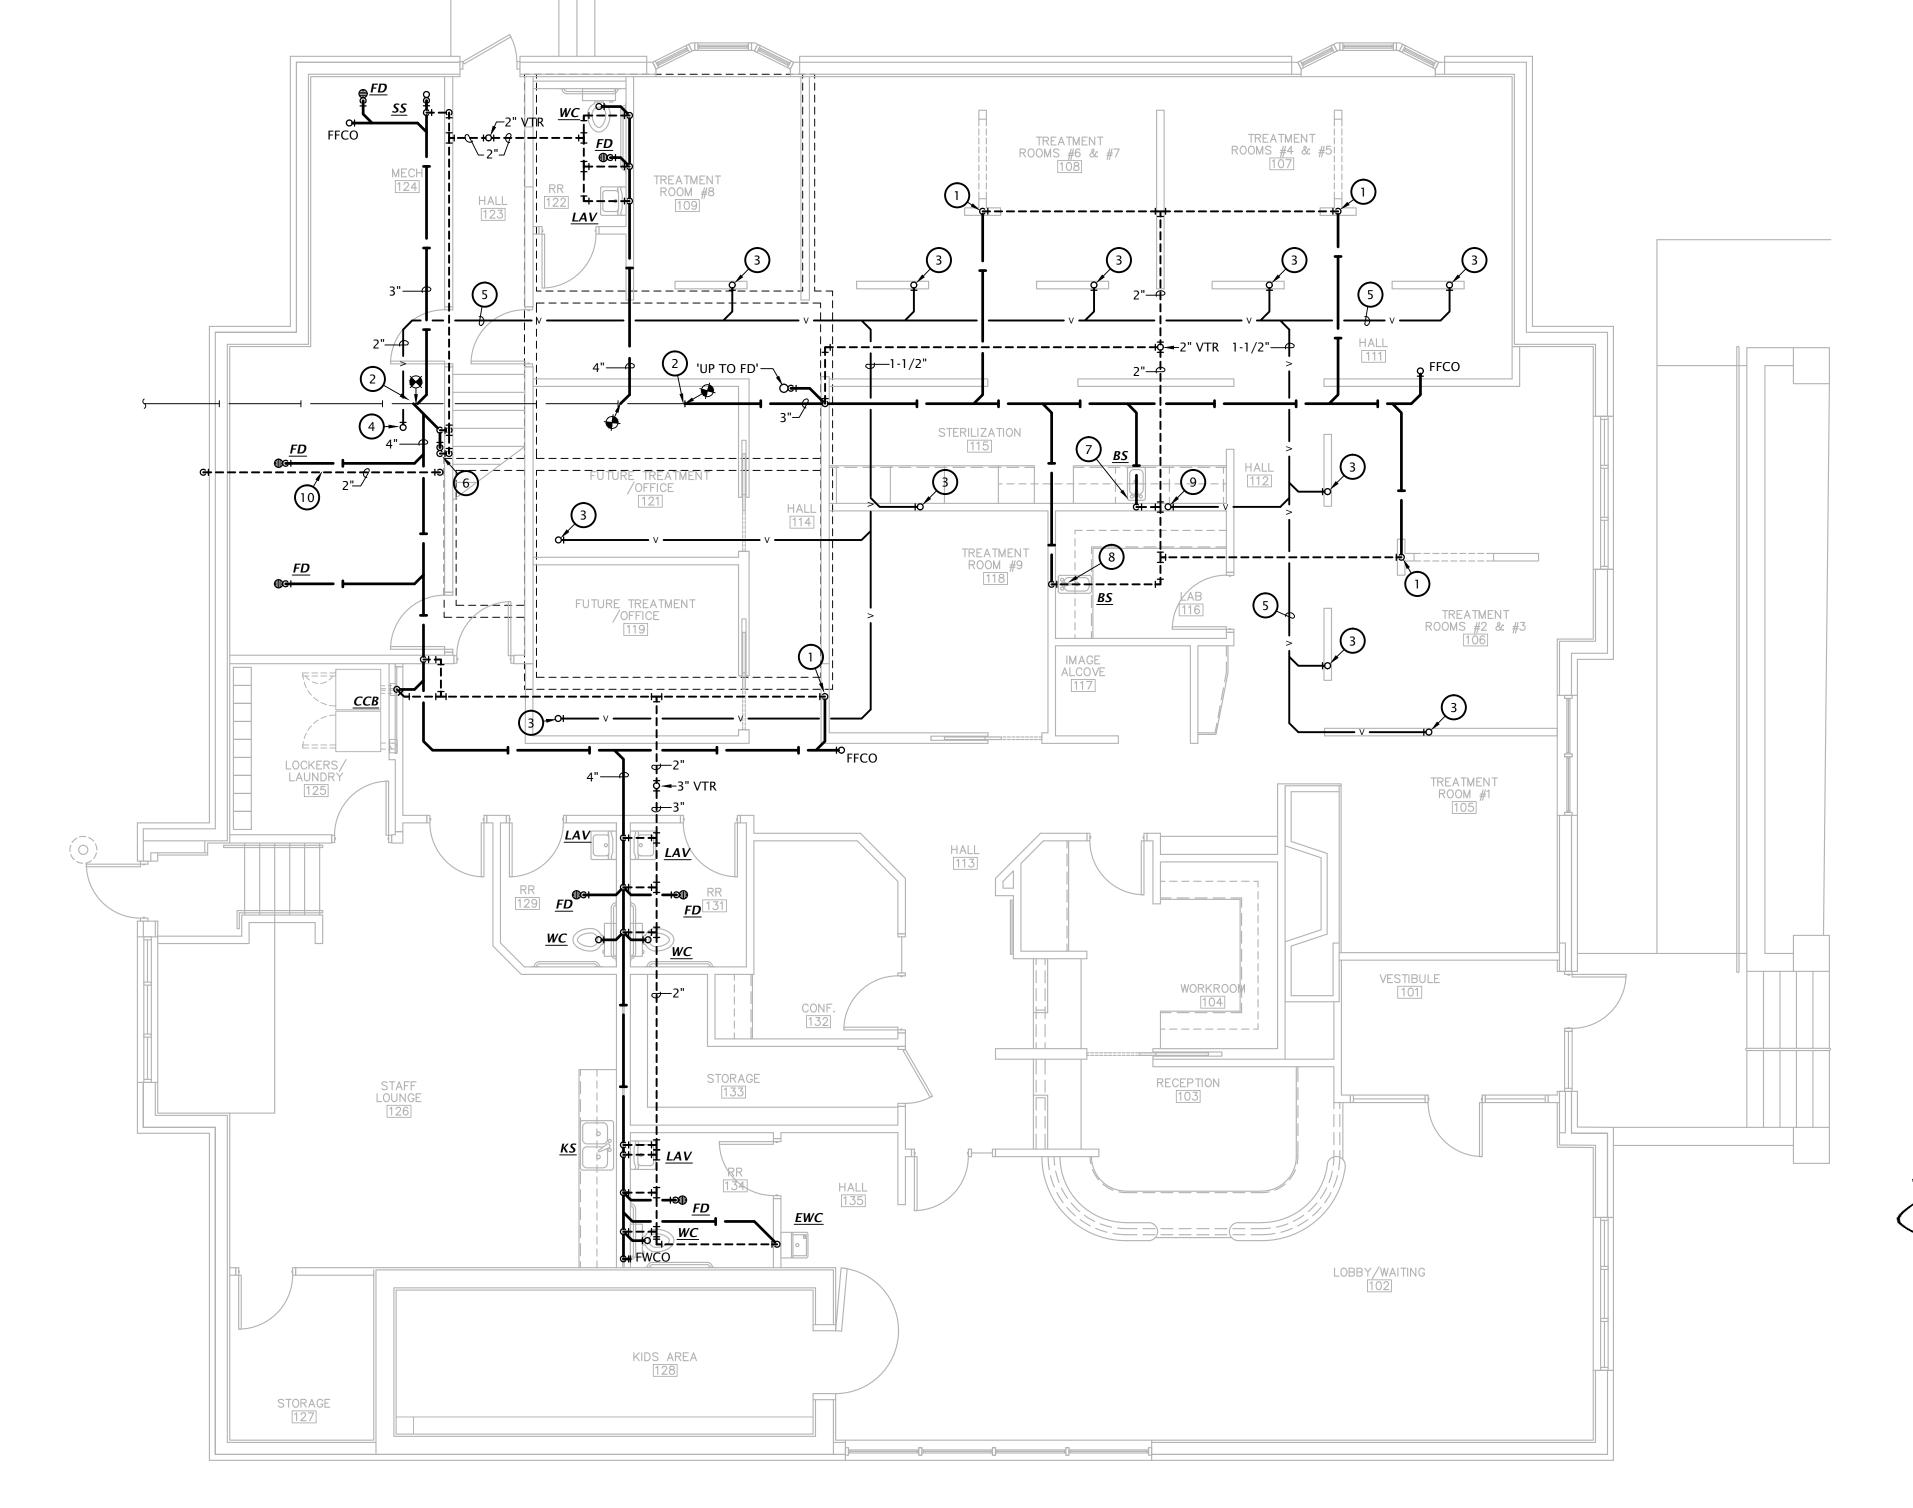5. CONNECT 1-1/2" GAS TO DISCHARGE OF EXISTING GAS METER AND REGULATOR PROVIDED BY GAS UTILITY. TOTAL CONNECTED LOAD =

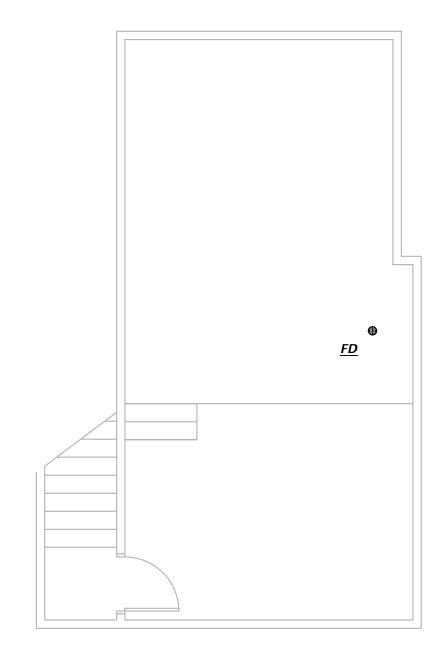405 CFH @ 7" W.C. COORDINATE EXACT REQUIREMENTS WITH GAS UTILITY AND PAY ALL ASSOCIATED FEES. 6. ROUTE 1/2" HW AND CW DOWN TO SINK PROVIDED BY DENTAL EQUIPMENT SUPPLIER AND INSTALLED BY PLUMBING CONTRACTOR.

COORDINATE EXACT REQUIREMENTS WITH EQUIPMENT SUPPLIER AND 7. ROUTE 3/4" CW AND HW DOWN IN WALL AND PROVIDE 1/2" CW AND HW BRANCHES TO 'LAV' AND 'KS'.

8. ROUTE 3/4" CW AND HW DOWN IN WALL AND PROVIDE 1/2" CW AND HW BRANCHES TO EACH 'LAV'.

12. ROUTE 1/2" COMPRESSED AIR DOWN IN WALL TO BELOW SLAB, TO UTILITY CENTER AT CHAIR BASE AND TERMINATE 2" A.F.F. WITH 3/8" ANGLE VALVE. COORDINATE EXACT LOCATION AND INSTALLATION REQUIREMENTS WITH DENTAL EQUIPMENT SUPPLIER. COORDINATE

9. PROVIDE 1/2" CW BRANCH TO DENTAL EQUIPMENT AND PROVIDE

BACK-FLOW PREVENTION IF NOT INCLUDED WITH EQUIPMENT.

COORDINATE EXACT ROUGH-IN LOCATION AND CONNECTION

10. VERIFY EXACT LOCATION OF HOSE BIB 'HB' WITH DENTAL EQUIPMENT

CENTER AND TERMINATE WITH 3/8" ANGLE VALVE. COORDINATE

EXACT LOCATION AND INSTALLATION REQUIREMENTS WITH DENTAL

11. ROUTE 1/2" COMPRESSED AIR DOWN IN WALL TO DENTAL UTILITY

REQUIREMENTS WITH DENTAL EQUIPMENT SUPPLIER.

PROVIDER AND G.C.

EQUIPMENT SUPPLIER.

TRENCHING AND CUTTING OF SLAB WITH G.C. 13. CONNECT COMPRESSED AIR PIPING TO DENTAL AIR COMPRESSOR

PROVIDED BY DENTAL EQUIPMENT SUPPLIER. COORDINATE EXACT REQUIREMENTS WITH EQUIPMENT SUPPLIER AND G.C. 14. PROVIDE 1/2" COMPRESSED AIR LINE AND STUB OUT FROM WALL 1"-2"

AND TERMINATE WITH 3/8" ANGLE VALVE. COORDINATE EXACT ROUGH-IN LOCATION AND REQUIREMENTS WITH DENTAL EQUIPMENT SUPPLIER.

15. PROVIDE 1/2" COMPRESSED AIR LINE AND STUB OUT 1"-2" TERMINATE WITH 1/4" ANGLE VALVE. COORDINATE EXACT ROUGH-IN LOCATION AND REQUIREMENTS WITH DENTAL EQUIPMENT SUPPLIER.

17. ROUTE 3/4" CW DOWN IN WALL AND PROVIDE 1/2" BRANCH TO EACH

16. SEE MEZZANINE PLAN 2:M1.3 FOR CONTINUATION.

18. PROVIDE 2" INTAKE PIPE TO AIR COMPRESSOR LOCATION ROUTED ABOVE CEILING TO EXTERIOR. TERMINATE PIPE WITH ELBOW DOWN WITH INSECT SCREEN. COORDINATE EXACT INSTALLATION REQUIREMENTS AND ROUGH-IN LOCATION WITH DENTAL EQUIPMENT

NOTE: DO NOT ROUTE PIPING IN ATTIC. PIPING SHALL BE ROUTED IN PLENUM ABOVE CEILING BUT BELOW VENTILATED ATTIC.

Note: Pipe sizes indicated on drawings are for Type

L copper pipe. If alternate materials are used, sizes

shall be as indicated above. Where no pipe size is

shown, use of indicated material in design pipe size

is prohibited. Do not use materials other than those

ALTERNATE

MATERIAL/SIZE

1/2"

1-1/4"

1-1/2"

2-1/2"

3-1/2"

Cross-linked

polyethylene

(PEX)


3/4"


3/4"

1-1/4"

1-1/2"

2-1/2"

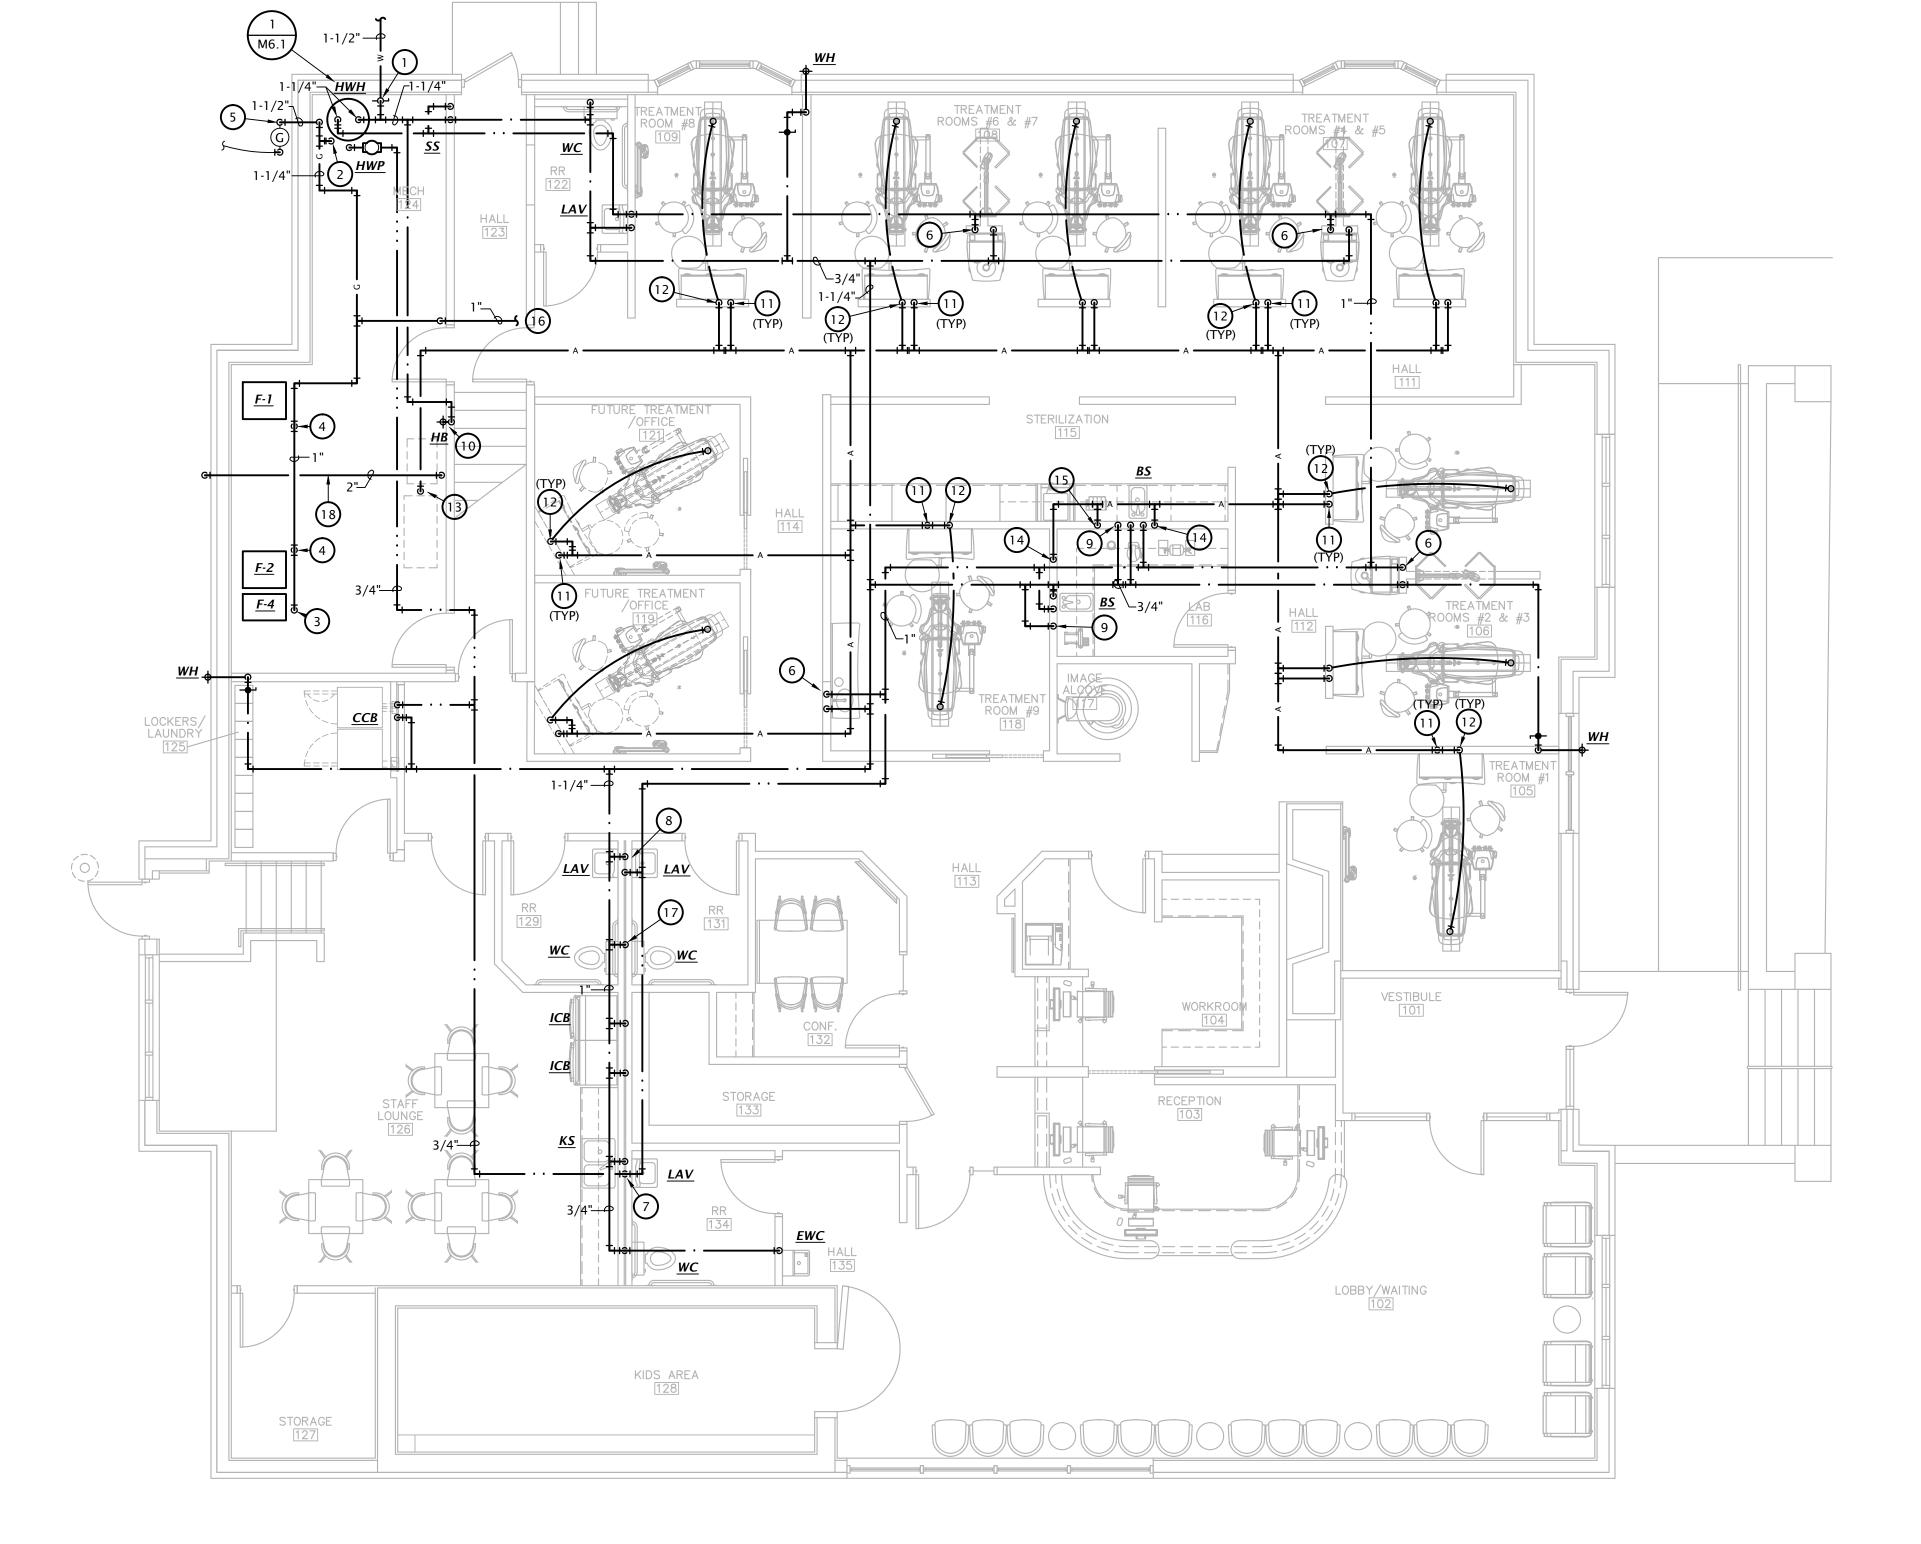

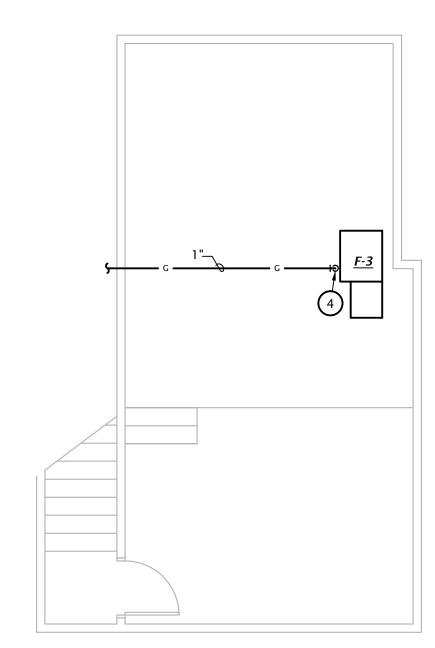

2 MEZZANINE DOMESTIC WATER PLAN

3/16" = 1'-0"

DOMESTIC WATER, GAS AND COMPRESSED AIR PLAN

3/16" = 1'-0"

9-20-2023 DATE: 22-3211

SHEET NO.: M1.3

_ (_	LST Consulting MANHATTAN  4809 Vue Du Lac Place, Suite 201 Manhattan, KS 66503 785.587.8042  www.LSTen	WICHITA  125 S. Washington, Suite 15  Wichita, Kansas 67202  316.285.0696
	mail@LSTen	

KAV MARK	RAVITY ROOF HOOD SCHEDULE       MARK     MANUFACTURER     MODEL     SIZE     THROAT AREA (SF)     FINISH     SCREEN     DAMPER     SERVICE     DESCRIPTION     NOTES													
IH	GREENHECK	GRSI-10	10"x10" damper	0.57	GALVANIZED STEEL	BIRD	GRAVITY	INTAKE	GALVANIZED STEEL GRAVITY INTAKE HOOD	1				
OTES: 1. Provid	e with roof curb co	mpatible with ro	oof slope and constru	iction.										

FURNACE				
MARK	F-1	F-2	F-3	F-4
MANUFACTURER	TRANE	TRANE	TRANE	TRANE
MODEL	S9V2D120D5PSBC	S9V2D120D5PSBC	S9V2C080U5PSBC	S9V2B040U3PSBC
CONFIGURATION	UPFLOW	UPFLOW	HORIZONTAL	UPFLOW
SUPPLY AIRFLOW (CFM)	1,800	1,800	1,600	750
O.A. AIRFLOW (CFM)	140	140	150	100
ESP ("WG)	0.7	0.7	0.7	0.7
BLOWER SPEED	MED-HIGH	MED-HIGH	MED-HIGH	MEDIUM
MOTOR HP	1	1	1	1/2
NAT. GAS INPUT (MBH)	120/78	120/78	80/52	40/26
NAT. GAS OUTPUT (MBH)	116.1/75.8	116.1/75.8	77.7/52	38.9/25.3
MCA	13.9	13.9	13.9	7.9
MOCP	15	15	15	15
VOLTAGE/PHASE	120	120	120	120
EVAPORATOR				
MODEL	4PXDUS0BS3	4PXDUS0BS3	4TXCC007DS3	4TXCB003DS3
ENT. AIR DB	80	80	80	80
ENT. AIR WB	67	67	67	67
NET SENS. CAPACITY (MBH)	40.6	40.6	31.5	17.2
NET TOTAL CAPACITY (MBH)	53.8	53.8	43.0	22.8
CONDENSING UNIT				
MARK	CU-1	CU-2	CU-3	CU-4
MANUFACTURER	TRANE	TRANE	TRANE	TRANE
MODEL	4TTR5060N1	4TTR6060N1	4TTR5048N1	4TTR6024N1
O.A. DB	105°F	105°F	105°F	105°F
REFRIGERANT	R410-A	R410-A	R410-A	R410-A
VOLTAGE/PHASE	208/1	208/1	208/1	208/1
MCA	28	28	24	13
МОСР	50	50	40	20

	_	_	_
NOTES:			

1. Provide refrigerant piping sized in accordance with manufacturer's recommendations for actual field installed length and routing.

2. Provide PVC intake and exhaust piping in accordance with manufacturer's recommendations. Provide with manufacturer's concentric vent

- termination kit.
- 3. Provide with 7-day programmable thermostat.
- 4. Provide with R140a refrigerant.

EXHAUST FAN SCHEDULE													
MARK	MANUFACTURER	MODEL	CFM	ESP (" wg)	POWER	VOLTS/ PHASE	NOTES						
EF-1,2,3,4	GREENHECK	SP-A50-90-VG	50	0.25	22.1 W	120/1	1						
EF-5	GREENHECK	SP-A190	190	0.25	49.2 W	120/1	1						
NOTES:													
1. Provide ir	ntegral disconnect.												

NDOOR UNIT				
MARK	IU-1	IU-2		
MANUFACTURER	TRANE-MITSUBISHI	TRANE-MITSUBISHI		
MODEL	NTXWPH12B112AA	TPKA0A0241KA70A		
CONFIGURATION	WALL MOUNTED	WALL MOUNTED		
VOLTAGE / PHASE	208/1	208/1		
MCA / MOCP	NOTE #4	NOTE #4		
NOMINAL COOLING CAPACITY	12,000 BTU/H	24,000 BTU/H		
OUTDOOR HEAT PUMP UN	IT			
MARK	HP-1	HP-2		
MANUFACTURER	TRANE-MITSUBISHI	TRANE-MITSUBISHI		
MODEL	NTXSPH12B112AA	TRUZA0241HA70		
NOMINAL COOING CAPACITY	12,000 BTU/H	24,000 BTU/H		
VOLTAGE / PHASE	208/1	208/1		
MIN. CKT. AMPS	10	19		
MAX C/B SIZE	15	26		
NOTES	1,2,3,4,5,6,7	1,2,3,4,5,6,7		

- recommendations for actual field installed length and routing.
- 2. Provide with wired Simple MA remote controller.
- 3. Provide with R410-A refrigerant.
- 4. Indoor units are powered from outdoor unit.
- 5. Provide high wall mount indoor unit with manufacturer's accessory condensate lift.
- 6. Provide with hail guards.
- 7. Unit shall be capable of heating down to -13°F O.A.D.B.

PVC INTAKE AND VENT PIPING SIZED PER MANUFACTURER'S RECOMMENDATIONS. SEE PLANS FOR ROUTING.  HWH  PROVIDE T/P RELIEF VALVE OVERFLOW PIPING TO 6" ABOVE DRAIN PAN. TYPICAL.	SEE PLANS FOR SIZING AND CONTINUATION.  PROVIDE AQUASTAT FOR CONTROL OF RECIRC. PUM		PROVIDE WANDOEL DET EXPANSION OR EQUIVAL	ΓA-20 I TANK,
PROVIDE T/P RELIEF VALVE OVERFLOW PIPING TO 6" ABOVE DRAIN PAN.			GAS SHUTOFF VALV	√E
PROVIDE T/P RELIEF VALVE OVERFLOW PIPING TO 6" ABOVE DRAIN PAN.	RECOMMENDATIONS. SEE		MINIMUM 6" DIRT L	.EG
OVERFLOW PIPING TO 6" ABOVE DRAIN PAN.	UNION, TYPICAL	<u>нwн</u>		
	OVERFLOW PIPING TO 6" ABOVE DRAIN PAN.	E T		



COMBUSTION VENT/EXH. PIPING. SIZE AND INSULATE PER MANUFACTURER RECOMMENDATIONS	OFF VALVE	O.A. DUCT TO II SEE PLANS FOR AND ROUTING - 6" MIN. DIRT LEG UNION	SIZE	FILTER WITH PIANO HIN DO NOT PROVIDE FILTE FILTER GRILLES ARE USI PLANS FOR MORE INFO  FLEXIBLE DUCT  MANUAL BALAI DAMPER (TYP.)	ER AT UNIT WHERE ED, REFER TO RMATION.  T CONN. (TYP.)  NCING
SUPPLY AIR DUCT SEE PLANS FOR SIZE AND ROUTING		FURNACE			— R.A. DUCT SEE PLANS FOR SIZE AND ROUTING
SEE PLANS FOR SIZE AND ROUTING	EVAPORATOR—	PROVIDE SECONDARY BELOW FURNACE AND EVAPORATOR, AND PROVIDE SECONDARY	' DRAIN PAN S D U	PROVIDE VIBRATION ISOLA SUPPORT FURNACE AND EV JNI-STRUT SUSPENDED FRO OR MOUNTED ON METAL F	VAPORATOR ON OM STRUCTURE

<u>3</u> _	HORIZONTAL	<b>FURNACE</b>	DETAIL
.) [			

(3)	HOK
	NO SCA

				TRIM		ROUGH-IN	I SIZES		
MARK	MANUFACTURER	DESCRIPTION	MANUFACTURER	DESCRIPTION	WASTE	VENT	CW	HW	NOTES
WC	KOHLER	Model 3999-0 "Highline" ADA compliant flush tank water closet, white vitreous china, two piece, 12" rough-in, elongated 16-1/2" high bowl, siphon jet flushing action, 1.28 GPF, polished chrome actuator.	KOHLER	#4650-0 Lustra white, open front, plastic seat and cover	4"	2"	1/2"		1
LAV	KOHLER	Model 2005-0 wall hung lavatory, white vitrous china, 18-1/4"W x 17-1/4", faucet holes on 4" centers.	KOHLER	Model 15198-4RA single handle faucet. Provide grid drain. Provide point of use tempering valve.	2"	1-1/2"	1/2"	1/2"	1,2,3,4
KS	JUST	Model DL-2233-A-GR two compartment 18 GA stainless steel sink, self rimming, 14"x16"x8"D inside, fully undercoated, faucet holes as req.	DELTA	Model 400-HDF single handle kitchen sink faucet with hose spray attachment. Chrome finish. Provide basket strainer.	2"	1-1/2"	1/2"	1/2"	2,4
BS		Trim only. Sink integral to countertop, coordinate with Architect.	DELTA	Model 27C4944 two handle bar sink faucet, 6" gooseneck spout, 1.5 GPM aerator, 4" blade handles, chrome finish. Provide basket strainer.	2"	1-1/2"	1/2"	1/2"	2,4
SS	FIAT	Model MSB-2424 one piece molded stone mop basin, 24" square, stainless steel integral drain body with caulk connection, stainless steel wall guards.	CHICAGO FAUCETS	Model 897-CPP faucet with hose thread outlet, vacuum breaker spout, pail hook, wall brace, integral check valves, metal lever handles.	3"	1-1/2"	3/4"	3/4"	4
EWC	ELKAY	Model EZSTL8WSLK ADA compliant dual height, selbar actuator, bottler filler, lead-free cooling system			2"	1-1/2"	1/2"		
ССВ	WATER TITE	Model W4700 recessed washing machine box with turn adaptor ball valves, sweat connection.	2"PVC/ABS drain co	oupling and knockout test cap. Two, 1/4	2"	2"	1/2"	1/2"	
ICB	WATER TITE	Model W9700 ice maker connection box with 1/4 t	urn ball valve and 1	/2" sweat copper connection.			1/2"		
WH	WOODFORD	Model B67 automatic draining freezeless wall hydr tee key handle, with recessed box with door. Prov					3/4"		
НВ	WOODFORD	Model 24 hose bib with anit-siphon vacuum breake	er, metal handle.				3/4"		
FD	WADE	1100 series floor drain with 6" satin nickel bronze Trapguard.	strainer. Provide tr	ap protection device equal to ProSet	2"	1-1/2"			
HWH	A.O. SMITH	Model GPDT-50, 50 gallon gas water heater, direct pressure relief valve and brass drain valve. Provide			pplied with	temperat	ture &		
HWP	BELL & GOSSETT	Model NBF-36, three speed circulation pump, bron	ze body, 10 GPM @	10' head, 120 VAC. Provide clamp-on aquast	at for pum	p control.			

Provide fixtures with all trim necessary for complete installation

1. Fixture and installation to meet requirements of Americans with Disabilities Act.

- 2. Provide Dearborn supplies with stops and escutcheon plate, 1-1/4" cast brass p-trap.
- 3. Insulate water and waste piping below lavatory. Utilize insulation kit equivalent to LavGuard by Truebro.
- 4. Trim shall be provided with polished chrome finish.

			Al	APPLICATION							
MARK	MANUFATURER	MODEL	SUPPLY	RETURN	EXHAUST	TRANSFER	FINISH	MOUNTING	DAMPER	DESCRIPTION	NOTES
SD-A	PRICE	SCD	•				WHITE	LAY-IN	NO	24"x24" steel square louvered diffuser, neck size as indicated on plans	
SD-B	PRICE	SMD	•				WHITE	GYP	NO	12"x12" steel square louvered diffuser, with 8"Ø neck adapter	
SD-B	PRICE	520	•				WHITE	SURFACE	NO	Steel double deflection supply grille, size as indicated on plans	
RG-A	PRICE	PDDR		•			WHITE	LAY-IN	NO	24"x24" Perforated face return grille with neck size as indicated on drawings	
RG-B	PRICE	PDDR		•			WHITE	LAY-IN	NO	24"x24" Perforated face return grille with neck size as indicated on drawings	

# GENERAL NOTES:


. Provide mounting frame as required for ceiling type.

- Maximum NC shall be 30.
- Runouts to diffusers shall be same size as neck, U.N.O.
- 4. Ceiling devices shall have adjustable blow pattern, 4-way U.N.O.
- 5. Coordinate locations of all wall devices with Architect.

. Provide with border for 9/16" slotted tee where indicated on Arch reflected ceiling plan.

ELECTRIC HEATER SCHEDULE												
MARK	MANUF.	MODEL	MOUNTING	WATTS	VOLTAGE/PHASE	DESCRIPTION	NOTES					
EWH-1,2,3	TRANE	UHAA	WALL	1,500	120/1	Architectural fan forced wall heater	1,2,3					

- 1. Provide with high temp. thermal cutout and fan delay.
- 2. Provide with integral thermostat and unit mounted disconnect switch.
- 3. Provide with recessed mounting frame.

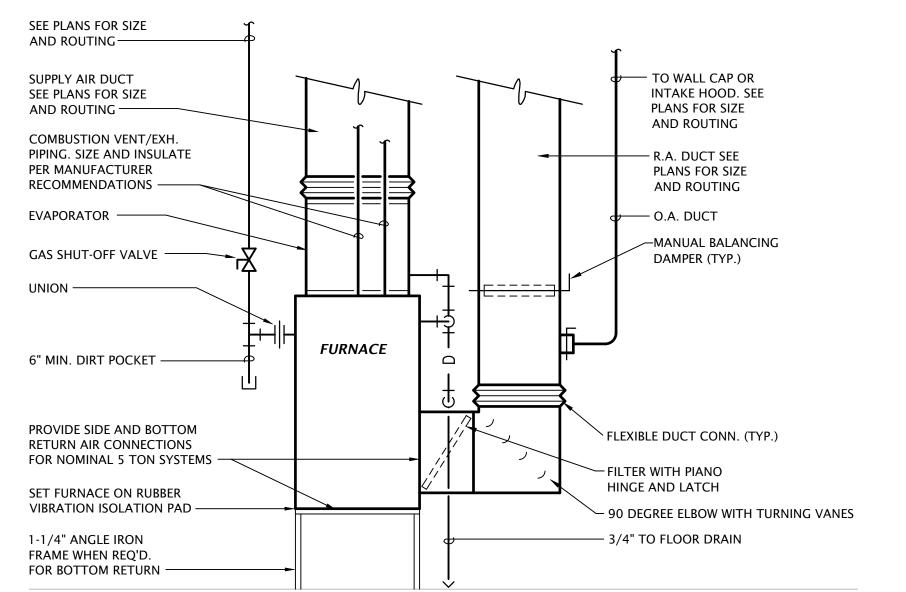

**UPFLOW FURNACE DETAIL** 

FURNACE WITH OVERFLOW DRAIN SHUT-OFF SWITCH.

9-20-2023 22-3211

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**REVISION:** 

DATE: SHEET NO.:

1. SAFETY WIRES MAY BE SLACK BUT SHALL BE SECURED WITH A MINIMUM OF THREE TIGHT TURNS AROUND SELF.

2. FIXTURE INSTALLATION TO COMPLY WITH ASTM C636 AND CISCA STANDARDS.

# RECESSED LUMINAIRE SUPPORT

# SCHEIN REPRESENTATIVE.

- PROVIDE J-BOX WITH120V POWER AND 6' FLEXIBLE WHIP FOR DENTAL TRACK LIGHT PROVIDED BY HENRY SCHEIN DENTAL. DRILL HOLE AND FEED WHIP THROUGH BACKING INTO TRACK LIGHT FOR FINAL CONNECTION. REFER TO HENRY SCHEIN DRAWINGS, SHEET SE.1 AND 6/SED.1, AND FIELD COORDINATE WORK WITH HENRY
- 2. SWITCH EXHAUST FAN WITH ROOM LIGHTS.
- 3. INSTALL EXTERIOR PHOTOCELL ON UNDERSIDE OF SOFFIT, FACING NORTH. 4. TIMECLOCK AND CONTACTOR FOR CONTROL OF EXTERIOR LIGHTING.


(#) LIGHTING PLAN NOTES BY SYMBOL

- 5. ROUTE CIRCUIT THROUGH LIGHTING CONTACTOR INDICATED FOR
- PHOTOCELL/TIMECLOCK CONTROL.
- 6. EXISTING LUMINAIRE TO REMAIN. CONNECT TO NEW CIRCUIT SHOWN. 7. PROJECT ALTERNATE: ELECTRICAL WORK ASSOCIATED WITH ALL TYPE 'L'
- DOWNLIGHTS IN EXTERIOR SOFFIT AND TYPE 'E' EMERGENCY WALL MOUNTED LIGHTS SHALL BE PRICED SEPARATELY AS PART OF ALTERNATE #4.
- 8. PROJECT ALTERNATE: IF ALTERNATE #4 IS ACCEPTED, THIS LUMINAIRE SHALL BE ELIMINATED FROM THE PROJECT.
- 9. J-BOX ABOVE CEILING FOR FUTURE EXTERIOR BUILDING SIGN.

A. THE CIRCUITING OF ALL LUMINAIRES HAS BEEN SHOWN ON THE PLANS, AND THE CONTRACTOR SHALL FOLLOW THIS CIRCUITING LAYOUT .

GENERAL LIGHTING NOTES


- B. CIRCUIT ALL EMERGENCY LIGHTS, NIGHT LIGHTS AND EXIT LIGHTS TO AN UNSWITCHED HOT CONDUCTOR, UPSTREAM OF ALL CONTROLS.
- C. WALL BOX DIMMER SWITCHES SHALL BE ELECTRO-MECHANICAL PRESET TYPE WITH SLIDER, RATED FOR 1200 VA AT 120/277 V, SUITABLE FOR 1-POLE AND 3-WAY OPERATION. DEVICES SHALL PROVIDE DIRECT DIMMING AND SWITCHING CONTROL OF 0-10 V-dc DIMMING DRIVERS WITHOUT THE USE OF AN EXTERNAL POWER PACK. LEVITON #IP710-DLZ OR EQUAL. COORDINATE COLOR OF DEVICES WITH ARCHITECT, AND PROVIDE COLOR CHANGE KIT AS REQUIRED (#IPKIT-[color]).
- D. CONTROL WIRING FOR 0-10 V-dc DIMMING SIGNAL CIRCUITS SHALL BE NEC CLASS 1, ROUTED IN SAME RACEWAY/CABLE WITH LIGHTING CIRCUIT POWER CONDUCTORS. WIRING SHALL CONSIST OF (2) #16 SOLID CU THHN OR TFN CONDUCTORS. CONDUCTOR INSULATION COLOR SHALL BE VIOLET (+ V-dc) AND PINK ( - V-dc). WHERE MC-CABLE IS USED FOR FINAL 6' POWER CONNECTION WHIP TO LUMINAIRE, UTILIZE "LUMINARY" TYPE MC-CABLE WITH INTEGRAL CLASS 1 CONTROL WIRING

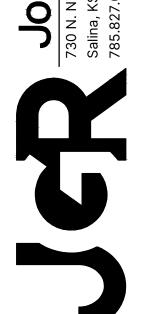


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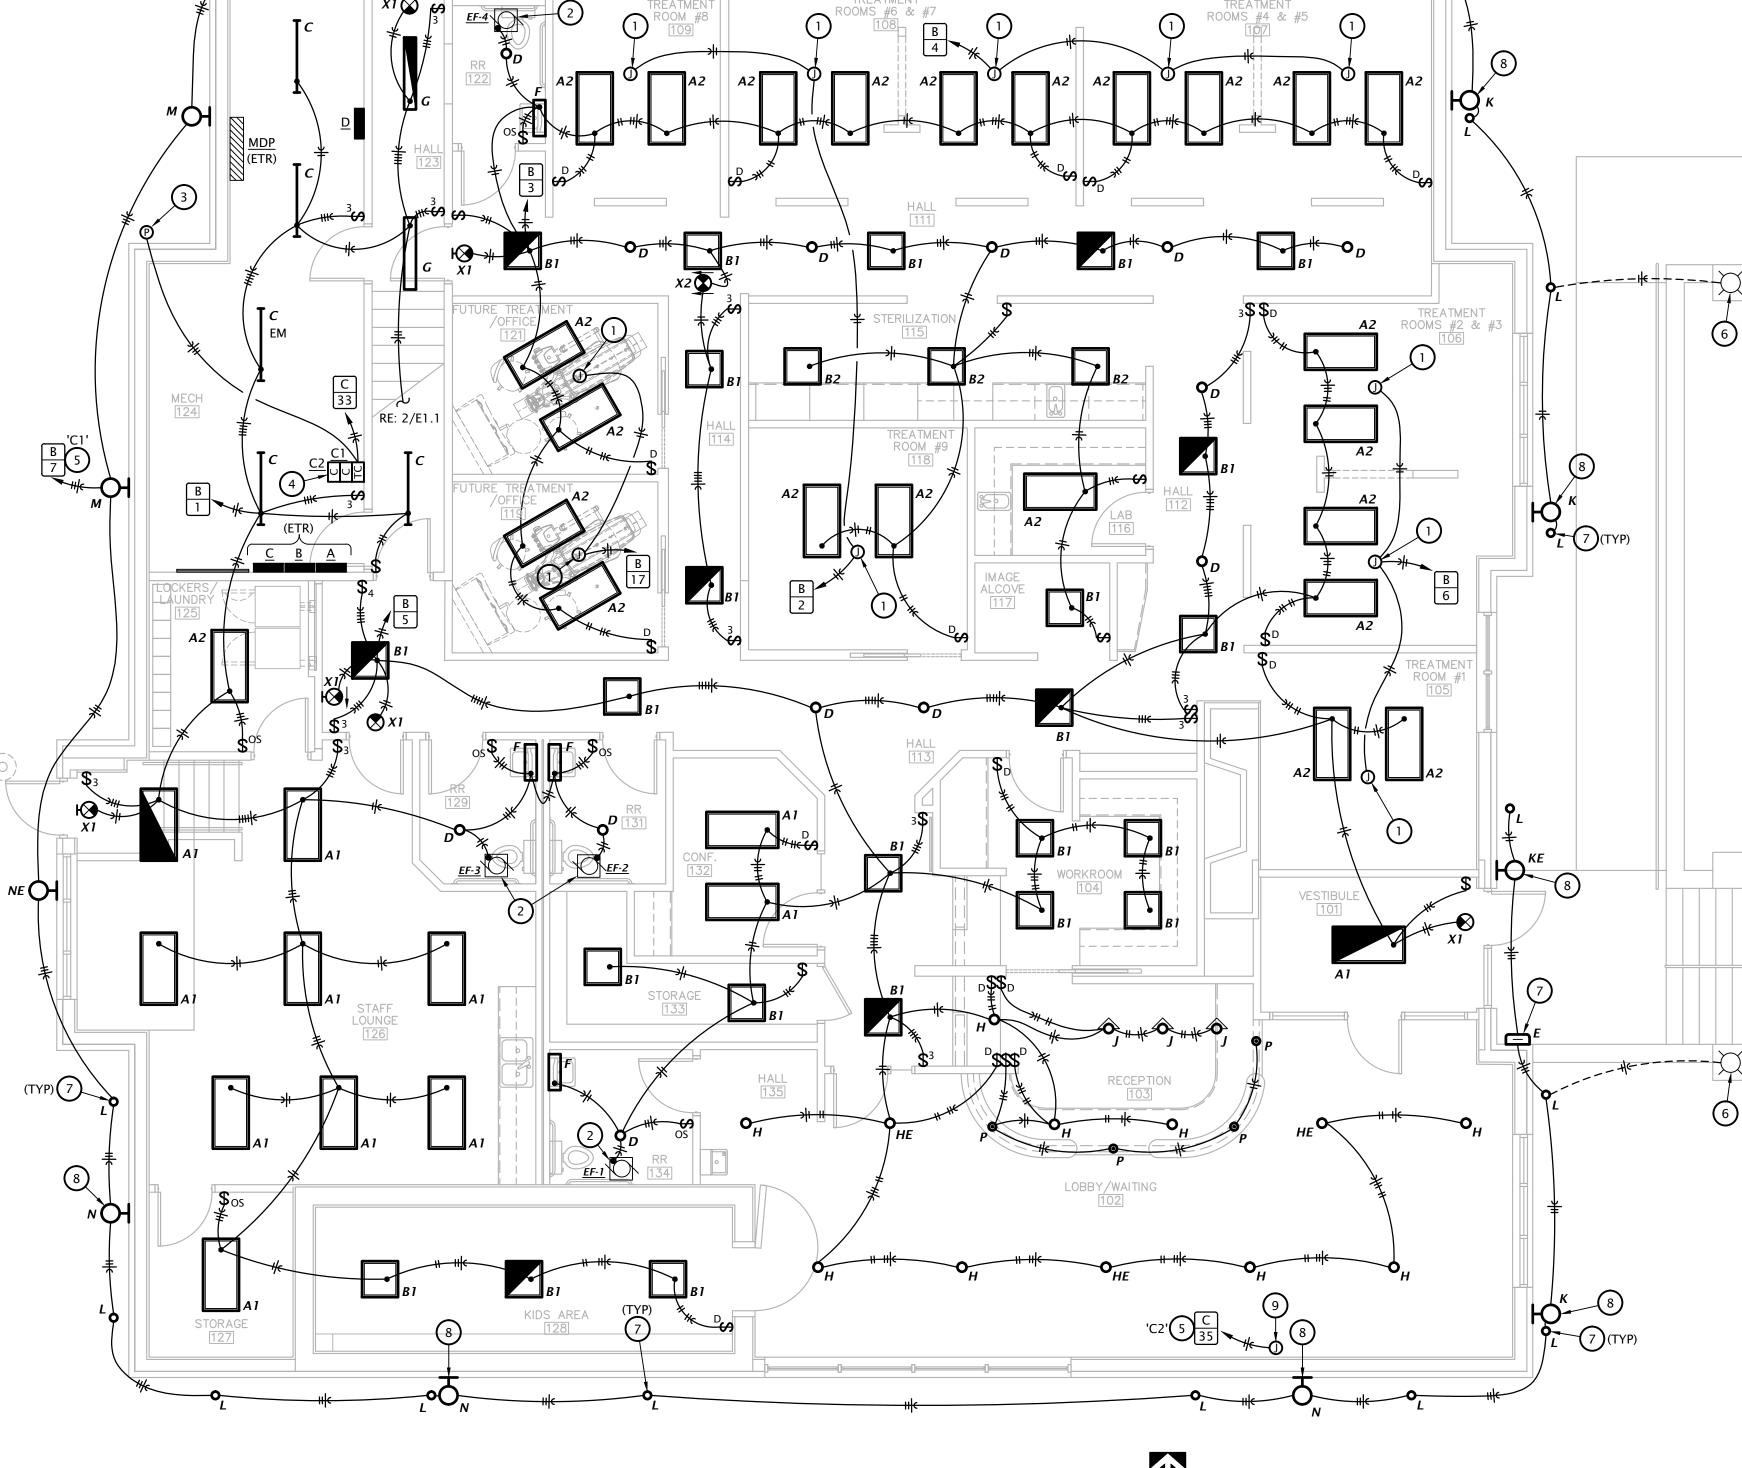
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# 4 LIGHTING CONTROL DIAGRAM No Scale





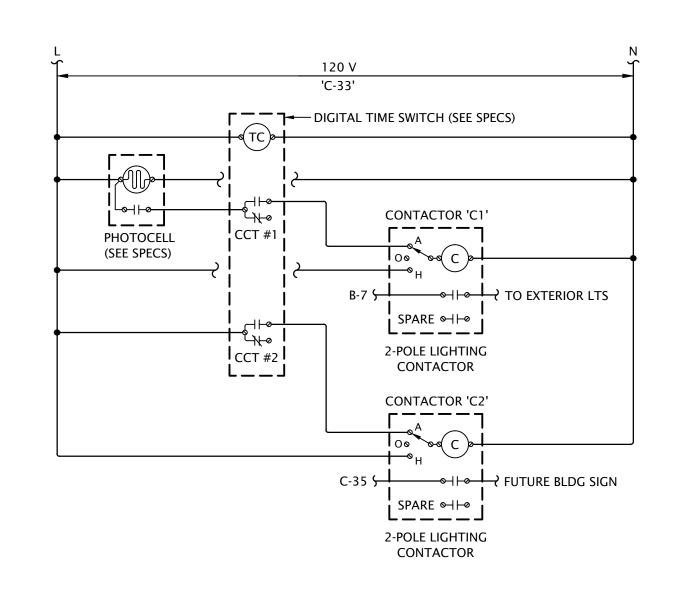

**1** 

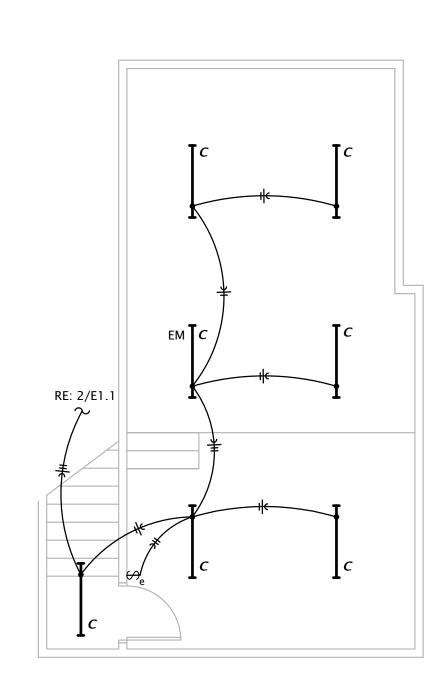- 1. COORDINATE EXACT MOUNTING LOCATION OF DRINKING FOUNTAIN RECEPTACLE WITH PLUMBING CONTRACTOR. WIRE FROM LOAD SIDE OF ADJACENT GFI RECEPTACLE TO PROVIDE GFI PROTECTION FOR DRINKING FOUNTAIN RECEPTACLE.
- 2. MOUNT DOUBLE DUPLEX RECEPTACLE IN DENTAL CHAIR UTILITY FRAME, MAX HEIGHT 4" AFF. REFER TO HENRY SCHEIN DRAWINGS, SHEET SE.1 AND 2A/SED.1.
- 3. CEILING MOUNTED RECEPTACLE FOR MONITOR. REFER TO HENRY SCHEIN DRAWINGS, SHEET SE.1 AND 39/SED.2. FIELD COORDINATE EXACT LOCATION WITH HENRY SCHEIN REPRESENTATIVE.
- 4. PROVIDE 2-GANG WALL BOX AT 3'-6" AFF TO CENTER OF BOX AND DEDICATED 120V/20A CIRCUIT FOR WALL MOUNTED X-RAY. PROVIDE 18" FLEXIBLE POWER WHIP FOR FINAL CONNECTION TO EQUIPMENT BY HENRY SCHEIN DENTAL. REFER TO HENRY SCHEIN DRAWINGS, SHEET SE.1 AND 9/SED.1. FIELD COORDINATE EXACT LOCATION WITH HENRY SCHEIN REPRESENTATIVE.
- 5. PROVIDE POWER FEED ON DEDICATED 120V/20A CIRCUIT FOR PASS-THRU CABINET MOUNTED X-RAY. PROVIDE 18" FLEXIBLE POWER WHIP FOR FINAL CONNECTION TO EQUIPMENT ROUTED THROUGH 1-1/4" HOLE IN POST. FIELD COORDINATE MOUNTING HEIGHT WITH HENRY SCHEIN REPRESENTATIVE. REFER TO HENRY SCHEIN DRAWINGS, SHEET SE.1 AND 9PT/SED.1.
- 6. MOUNT DOUBLE DUPLEX RECEPTACLE IN UTILITY CABINET WITH 16" FLEXIBLE CONDUIT. FIELD COORDINATE MOUNTING LOCATION WITH HENRY SCHEIN REPRESENTATIVE. REFER TO HENRY SCHEIN DRAWINGS, SHEET SE.1 AND 3A/SED.1.
- 7. PROVIDE DEDICATED CIRCUITS FOR PANORAMIC IMAGING UNIT. VERIFY MOUNTING HEIGHT AND REQUIREMENTS WITH HENRY SCHEIN REPRESENTATIVE.
- 8. COORDINATE SAW-CUTTING AND PATCHING OF CONCRETE FLOOR WITH GENERAL CONTRACTOR.
- 9. PROVIDE (3) #12, #12G, 1/2"C BETWEEN OUTDOOR AND INDOOR A/C
- 10. 30A/3P MANUAL MOTOR STARTER SNAP SWITCH (W/O OVERLOAD) IN NEMA 1 ENCLOSURE, HUBBELL #HBL1379D. INSTALL ADJACENT TO EQUIPMENT AND MAKE FINAL CONNECTION.
- 11. 30A/2P NON-FUSED DISCONNECT SWITCH IN NEMA 3R ENCLOSURE. MAKE FINAL FLEXIBLE CONNECTION TO EQUIPMENT IN 'LFMC'
- 12. 60A/2P NON-FUSED DISCONNECT SWITCH IN NEMA 3R ENCLOSURE. MAKE FINAL FLEXIBLE CONNECTION TO EQUIPMENT IN 'LFMC'

# GENERAL POWER NOTES

- A. THE CIRCUITING OF ALL DEVICES HAS BEEN SHOWN ON THE PLANS, AND THE CONTRACTOR SHALL FOLLOW THIS CIRCUITING LAYOUT.
- B. VERIFY EXACT LOCATIONS OF HVAC AND PLUMBING EQUIPMENT WITH THE GENERAL CONTRACTOR AND ASSOCIATED SUB CONTRACTORS. COORDINATE CONDUIT STUB-UP AND POWER CONNECTIONS PRIOR TO COMMENCING ROUGH-IN WORK. ELECTRICAL DEVICES (DISCONNECTS, RECEPTACLES, ETC.) INSTALLED ON EQUIPMENT SHALL BE MOUNTED ON A NON-REMOVABLE PANEL OF THE EQUIPMENT. FIELD COORDINATE EXACT DEVICE MOUNTING LOCATIONS PRIOR TO INSTALLATION.
- C. WALL MOUNTED HVAC CONTROL DEVICES (THERMOSTATS, TEMPERATURE SENSORS, HUMIDISTATS, CO<sub>2</sub> SENSORS, ETC) SHALL BE PROVIDED BY MECHANICAL CONTRACTOR. UNLESS NOTED OTHERWISE, ELECTRICAL CONTRACTOR SHALL PROVIDE SINGLE GANG WALL BOX AT 46" AFF AND 1/2" CONDUIT STUBBED OUT TO ABOVE ACCESSIBLE CEILING WITH NYLON BUSHINGS AND PULLSTRING IN RACEWAY. REFER TO MECHANICAL DRAWINGS FOR LOCATIONS OF DEVICES.



LST Consulting Engineers, PA 125 S. Washington, Suite Wichita, Kansas 67202 September 2023

REVISION:


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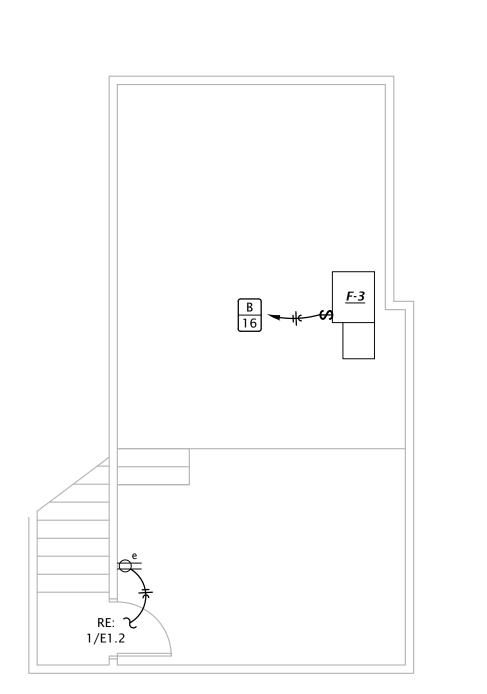
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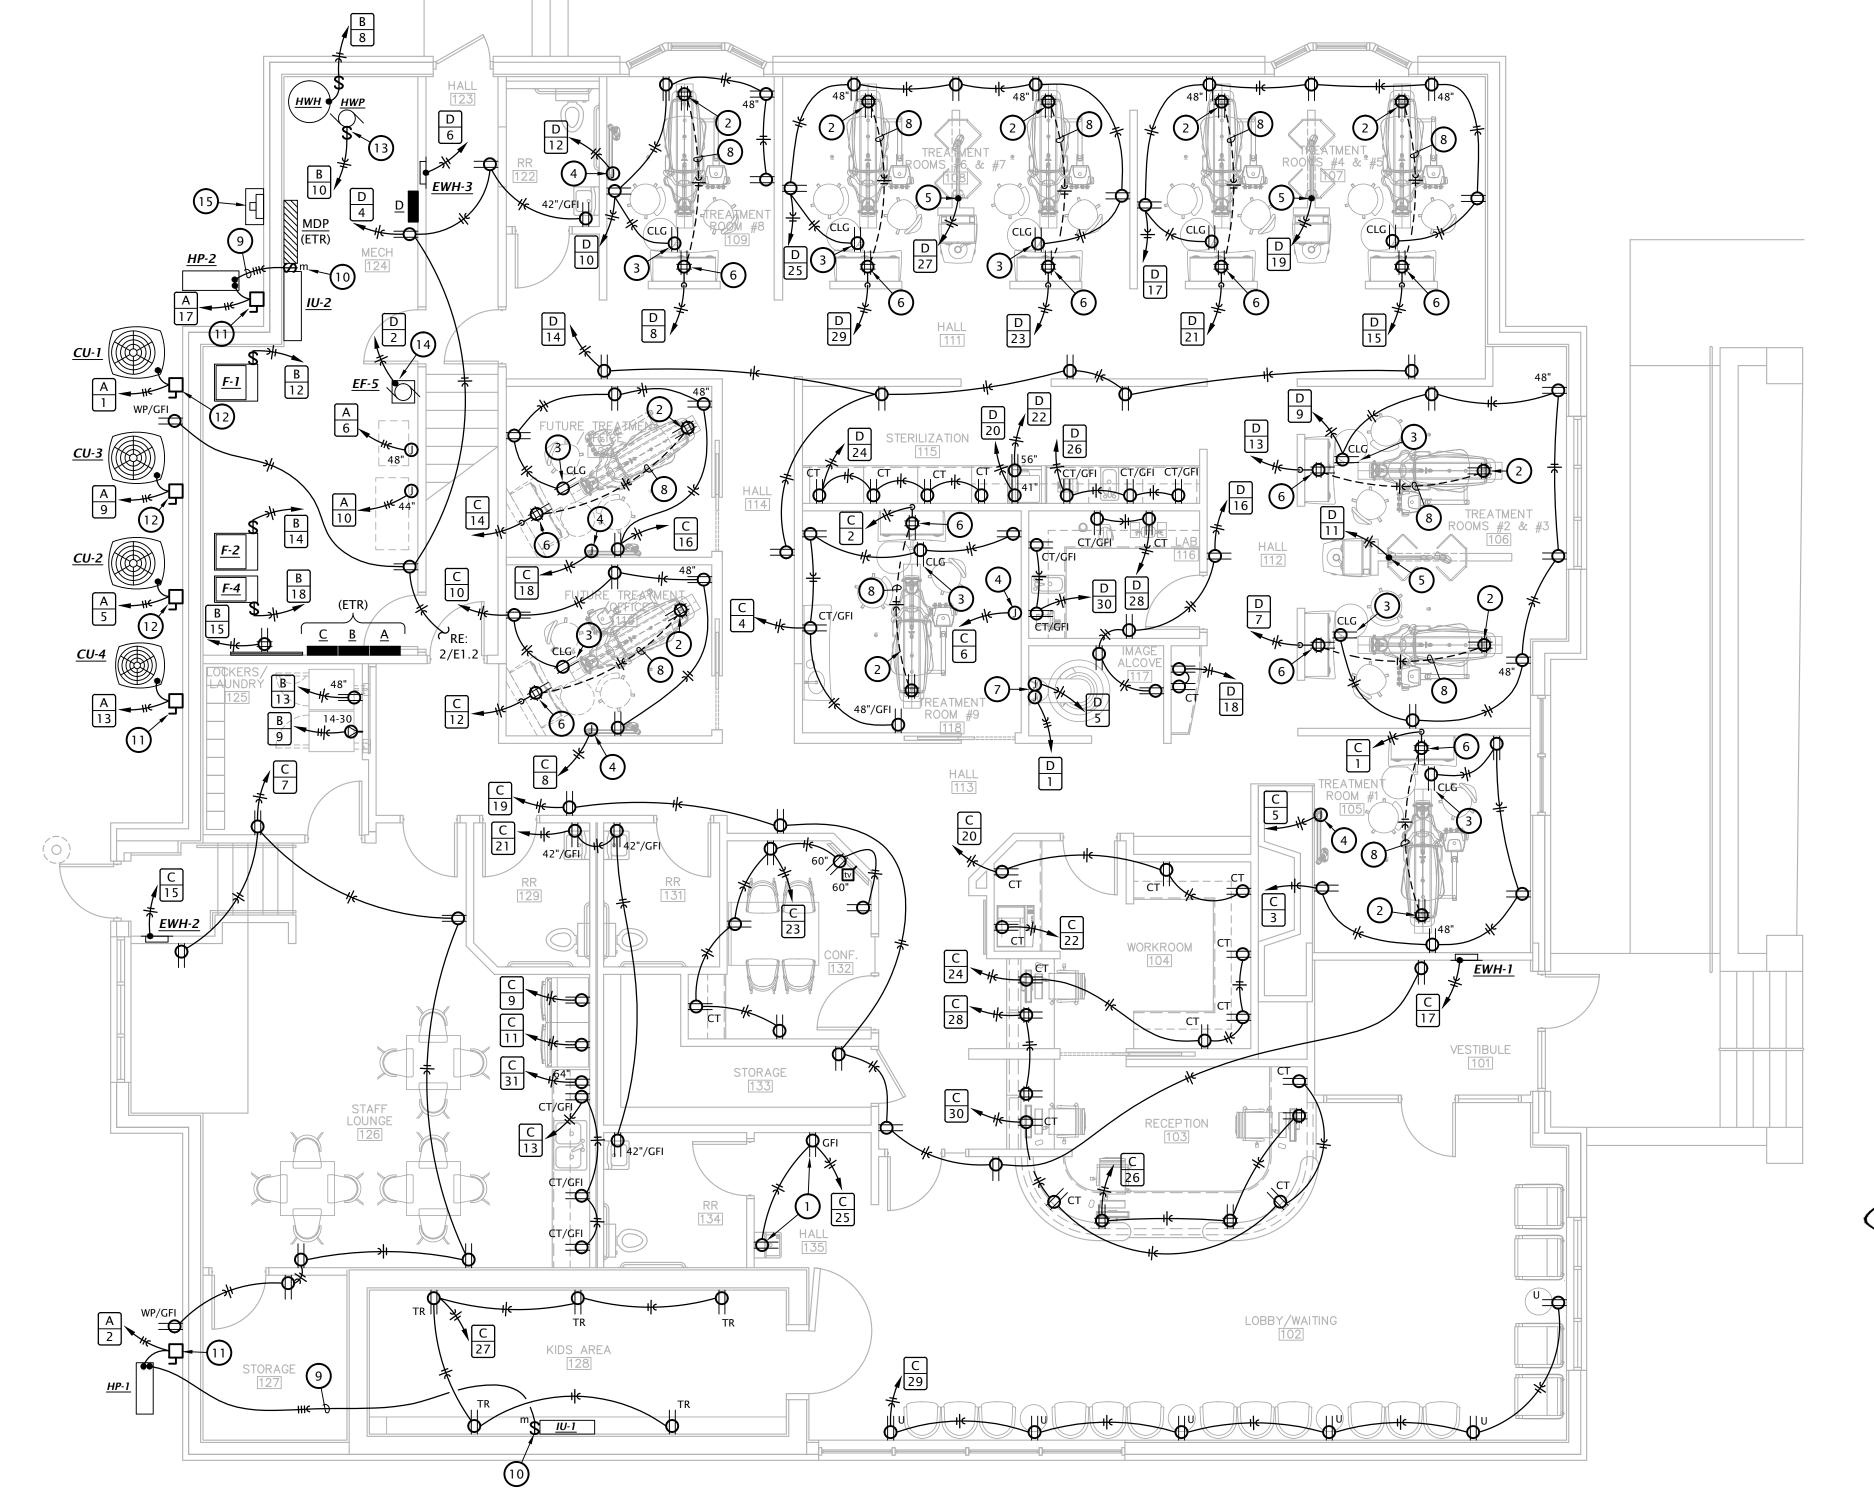
13. ROUTE 120V CIRCUIT FOR HOT WATER RECIRCULATION PUMP ('HWP') THROUGH ADJACENT AQUASTAT. PROVIDE 20A/1P SNAP SWITCH ADJACENT TO PUMP AND MAKE FINAL FLEXIBLE CONNECTION. COORDINATE WITH PLUMBING CONTRACTOR.

14. CIRCUIT FAN FOR CONTINUOUS OPERATION.

15. EXISTING POWER UTILITY C:T CABINET AND METER TO REMAIN.





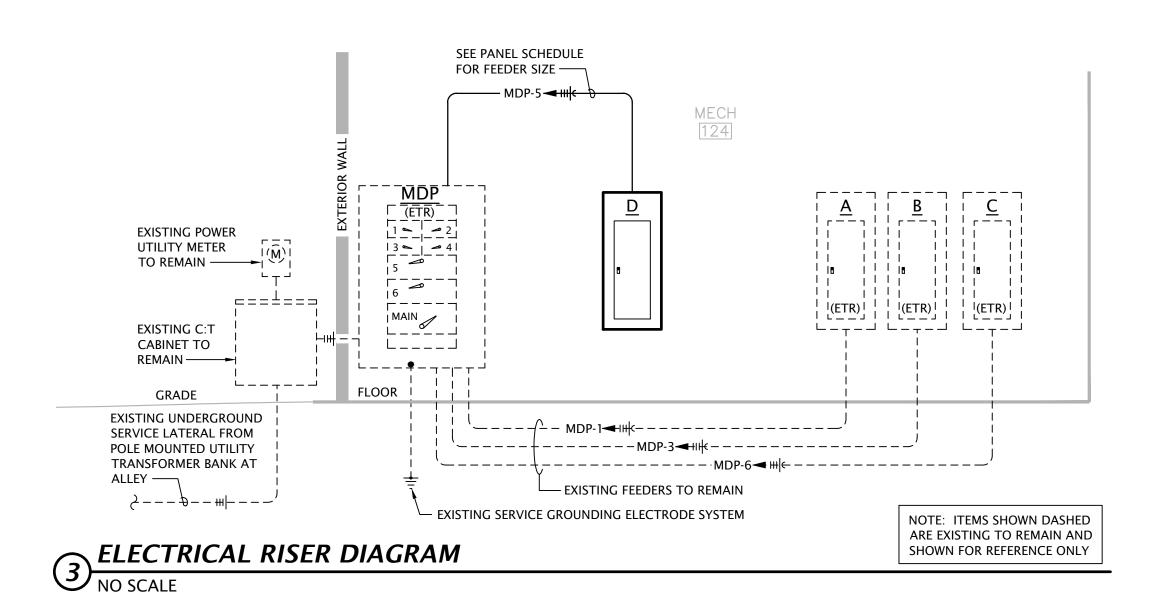

**1** 

- 2. 2" CONDUIT WITH PULL STRING ROUTED VERTICALLY IN WALL FROM ABOVE CEILING DOWN TO 4" AFF. PROVIDE A 1-GANG MUD RING AT SILL PLATE FOR ROUTING CABLES. REFER TO HENRY SCHEIN DRAWINGS, SHEET SE.1 AND 4B/SED.1.
- 3. PROVIDE 1-GANG WALL BOX AT 47" AFF TO CENTER OF BOX AND 1" CONDUIT WITH PULL STRING TO ABOVE CEILING FOR X-RAY MASTER CONTROL. REFER TO HENRY SCHEIN DRAWINGS, SHEET SE.1 AND 9/SED.1
- 4. PROVIDE 1" CONDUIT WITH PULL STRING CONCEALED IN WALL FROM X-RAY MOUNTING PLATE (BY HENRY SCHEIN DENTAL) TO ABOVE CEILING FOR CONTROL CABLING. REFER TO HENRY SCHEIN DRAWINGS, SHEET SE.1 AND 9PT/SED.1.
- 5. PROVIDE 1" CONDUIT WITH PULL STRING FROM WALL MOUNTED X-RAY EXPOSURE BUTTON TO ABOVE CEILING FOR CONTROL WIRING. VERIFY TERMINATION POINT AT WALL WITH HENRY SCHEIN REPRESENTATIVE.
- 6. PROVIDE 1-GANG WALL BOX AT 47" AFF TO CENTER OF BOX AND 1" CONDUIT WITH PULL STRING TO ABOVE CEILING FOR PANORAMIC IMAGING UNIT. REFER TO HENRY SCHEIN DRAWINGS, SHEET SE.1.
- 7. 2-GANG J-BOX AT 60" AFF WITH 1" CONDUIT TO ABOVE CEILING FOR AIR/WATER/VACUUM REMOTE SHUT-OFF SWITCH. PROVIDE 18/4 CMP CABLE FROM BOX TO EACH VACUUM MOTOR, COMPRESSOR AND WATER VALVE TO BE CONTROLLED. PROVIDE 18" WHIPS IN BOX FOR FINAL CONNECTIONS BY HENRY SCHEIN DENTAL.
- 8. PROVIDE 18/4 CONTROL CABLE TO REMOTE SHUT-OFF SWITCH.
- 9. J-HOOKS FOR TELECOM CABLING INSTALLED ABOVE SUSPENDED CEILING, SPACED AT MAXIMUM 5'-0" ON CENTER. J-HOOKS SHALL HAVE 4" MIN BUNDLE CAPACITY, 1" BEND RADIUS CONTROL, AND SHALL BE U.L. 2043 LISTED. PANDUIT "J-PRO JP4 SERIES" OR EQUAL. PROVIDE ALL FASTENERS AND ACCESSORIES AS REQUIRED FOR A COMPLETE INSTALLATION.
- 10. EMT CONDUIT SLEEVE(S) WITH NYLON BUSHINGS FOR OWNER PROVIDED TELECOM CABLING. QUANTITY AND TRADE SIZE AS NOTED. INSTALL ABOVE ACCESSIBLE CEILING.
- 11. TELECOMMUNICATIONS GROUND BAR: 13-1/4"W x 2"H x 1/4" THICK ELECTRO-TIN PLATED COPPER BUS BAR, COMPLETE WITH INSULATED STAND-OFFS AND STAINLESS STEEL BRACKETS, ERICO #TGBA14L06PT OR EQUAL. MOUNT AT 18" AFF AND PROVIDE #6 CU GROUND TO BUILDING STEEL AND TO EQUIPMENT GROUND BUS OF PANEL 'MDP'. ALL CONNECTIONS TO GROUND BAR SHALL BE MADE USING

- 12. EXISTING TELECOM BACKBOARD TO REMAIN.
- 13. INSTALL TV OUTLET FLUSH IN CEILING, ADJACENT TO RECEPTACLE.
- 14. PROVIDE ROUGH-IN ONLY FOR THIS OUTLET. PROVIDE PULL STRING IN RACEWAY. CABLING PROVIDED BY OWNER.

# TELECOMMUNICATIONS GENERAL NOTES A. PROVIDE THE FOLLOWING FOR TELECOMMUNICATIONS OUTLET TYPES INDICATED:

◆ VOICE/DATA OUTLET: 4-11/16" SQUARE x 2-1/8" DEEP BOX (RACO #258) WITH

• TV OUTLET: 4-11/16" SQUARE x 3-1/4" DEEP BOX (RACO #260) WITH 1-GANG

DEVICE RING, 1-1/2" CONDUIT TO ABOVE ACCESSIBLE CEILING AND (1)

CATEGORY 6 UTP CABLES TO TELECOM BACKBOARD IN MECH 124.

1-GANG DEVICE RING, 1" CONDUIT TO ABOVE ACCESSIBLE CEILING, AND (2)

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September 2023

CATEGORY 6 UTP CABLE TO TELECOM BACKBOARD IN MECH 124. B. PROVIDE NYLON BUSHINGS FOR ALL CONDUIT ENDS NOT CONNECTED TO A BOX OR

FITTING TO PROTECT CABLING FROM DAMAGE. C. CONDUITS FROM EACH OUTLET SHALL BE STUBBED 2" ABOVE THE FINISHED CEILINGS IN AREAS WITH ACCESSIBLE TILES. IN AREAS WITH OPEN CEILINGS, STUB CONDUIT

D. PROVIDE BLANK, STAINLESS STEEL COVER PLATES FOR ALL OUTLETS NOT ACTIVATED

INTO STRUCTURAL JOIST SPACE.

E. HORIZONTAL COPPER TELECOMMUNICATIONS CABLING TO VOICE/DATA OUTLETS AND TV OUTLETS SHALL BE CATEGORY 6 UTP, TYPE CMP PLENUM RATED. VOICE/DATA CABLES SHALL HAVE A BLUE OUTER JACKET, AND TV CABLES SHALL HAVE A WHITE OUTER JACKET. PROVIDE A 6ft SERVICE LOOP ABOVE THE CEILING AT EACH OUTLET, AND A 20ft SERVICE LOOP AT THE TELECOM BACK BOARD.

F. ALL TELECOMMUNICATIONS HEAD END EQUIPMENT, PATCH PANELS, JACKS/CONNECTORS, TERMINATIONS AND TESTING SHALL BE PROVIDED BY OWNER.

# CIRCUIT AND RACEWAY SYMBOLS

CIRCUIT DESIGNATION:

TOP INDICATES PANEL OF CIRCUIT ORIGIN BOTTOM INDICATES CIRCUIT NUMBER

HOMERUN - WIRING TO PANEL OF CIRCUIT ORIGIN

PARTIAL HOMERUN - WIRING TO PANEL OF CIRCUIT ORIGIN CONDUIT CONCEALED IN WALL OR ABOVE CEILING

---- CONDUIT BELOW GRADE OR EMBEDDED IN CONCRETE LINE VOLTAGE CIRCUIT CONDUCTORS

SHORT = HOT/TRACER/SWITCH LEG CONDUCTOR

LONG = NEUTRAL (GROUNDED) CONDUCTOR CURVED = GROUNDING (BONDING) CONDUCTOR LOW-VOLTAGE CONTROL WIRING

CONDUIT STUB OUT WITH NYLON END BUSHING

CONDUIT TURNED UP CONDUIT TURNED DOWN

GROUNDING CONNECTION

# LIGHTING SYMBOLS

LAY-IN FLAT PANEL TROFFER

PENDANT OR SURFACE MOUNTED LINEAR LUMINAIRE LENSED STRIP LIGHT

RECESSED DOWNLIGHT

RECESSED WALL WASH DOWNLIGHT WALL MOUNTED LUMINAIRE

SINGLE FACE EXIT SIGN - WALL AND CEILING MOUNTED WITH

DIRECTIONAL ARROWS AS INDICATED ON PLANS DOUBLE FACE EXIT SIGN - WALL AND CEILING MOUNTED WITH

DIRECTIONAL ARROWS AS INDICATED ON PLANS

# **POWER SYMBOLS**

DUPLEX RECEPTACLE

DOUBLE DUPLEX RECEPTACLE

SPECIAL RECEPTACLE (# = NEMA CONFIGURATION)

SINGLE POLE TOGGLE SNAP SWITCH **DOUBLE POLE TOGGLE SNAP SWITCH** 

THREE-WAY TOGGLE SNAP SWITCH

FOUR-WAY TOGGLE SNAP SWITCH

MOTOR HP RATED SWITCH WITHOUT OVERLOAD PROTECTION

PRESET SLIDE DIMMER WALL SWITCH

LINE VOLTAGE OCCUPANCY SENSING WALL SWITCH

TC TIMECLOCK

EXTERIOR PHOTOCELL

CONTACTOR PUSH BUTTON OPERATOR

JUNCTION BOX

DISCONNECT SWITCH

BRANCH CIRCUIT PANELBOARD

DISTRIBUTION PANELBOARD

# TELECOMMUNICATIONS SYMBOLS

TELECOMMUNICATIONS VOICE/DATA OUTLET

TELEVISION OUTLET

TELECOMMUNICATIONS GROUND BAR

TELEPHONE TERMINAL BOARD

J-HOOKS

# SYMBOL MODIFYING DESIGNATORS

• SURFACE MOUNTED TO STRUCTURE ABOVE IN OPEN CEILINGS

PROVIDE LUMINAIRE WITH EMERGENCY BATTERY BACKUP

GROUND FAULT CIRCUIT INTERRUPTING DEVICE

NIGHTLIGHT WIRED TO UNSWITCHED HOT CONDUCTOR

PROVIDE WEATHERPROOF ENCLOSURE FOR DEVICE

# **ABBREVIATIONS**

AMPERE INTERRUPTING CAPACITY

CIRCUIT BREAKER

CORRELATED COLOR TEMPERATURE

ELECTRICAL CONTRACTOR

EXISTING TO REMAIN

FLEXIBLE METALLIC CONDUIT

GROUNDING (BONDING) CONDUCTOR GENERAL CONTRACTOR

LIGHTING

MECHANICAL CONTRACTOR MAIN CIRCUIT BREAKER

MAIN LUG ONLY

NORMALLY CLOSED

NATIONAL ELECTRICAL CODE (NFPA 70)

NATIONAL FIRE PROTECTION ASSOCIATION

NATIONALLY RECOGNIZED TESTING LABORATORY

POLYVINYL CHLORIDE CONDUIT

SURGE PROTECTION DEVICE

TELEPHONE

TYPICAL

**UNLESS NOTED OTHERWISE** 

WATT(S)

EMT CONDUIT SLEEVE WITH NYLON END BUSHINGS

FLUSH MOUNTED IN SUSPENDED CEILINGS

MOUNT BOTTOM OF DEVICE AT 6" ABOVE COUNTERTOP

**DEVICE IS EXISTING TO REMAIN** 

# MOUNTING HEIGHT OF DEVICE ABOVE FINISHED FLOOR

**AMPERE** 

ALTERNATING CURRENT

ABOVE FINISH FLOOR

AMERICAN WIRE GAUGE

CONDUIT

**COLOR RENDERING INDEX** 

ELECTRICAL METALLIC TUBING

GROUND FAULT CIRCUIT INTERRUPTER

NATIONAL ELECTRICAL MANUFACTURERS ASSOCIATION

PH or φ PHASE

RECEPTACLE


SINGLE POLE, DOUBLE THROW

TELEVISION

UNDERGROUND

UNDERWRITERS LABORATORY

**VOLT (ALTERNATING CURRENT)** VOLTAMPERE

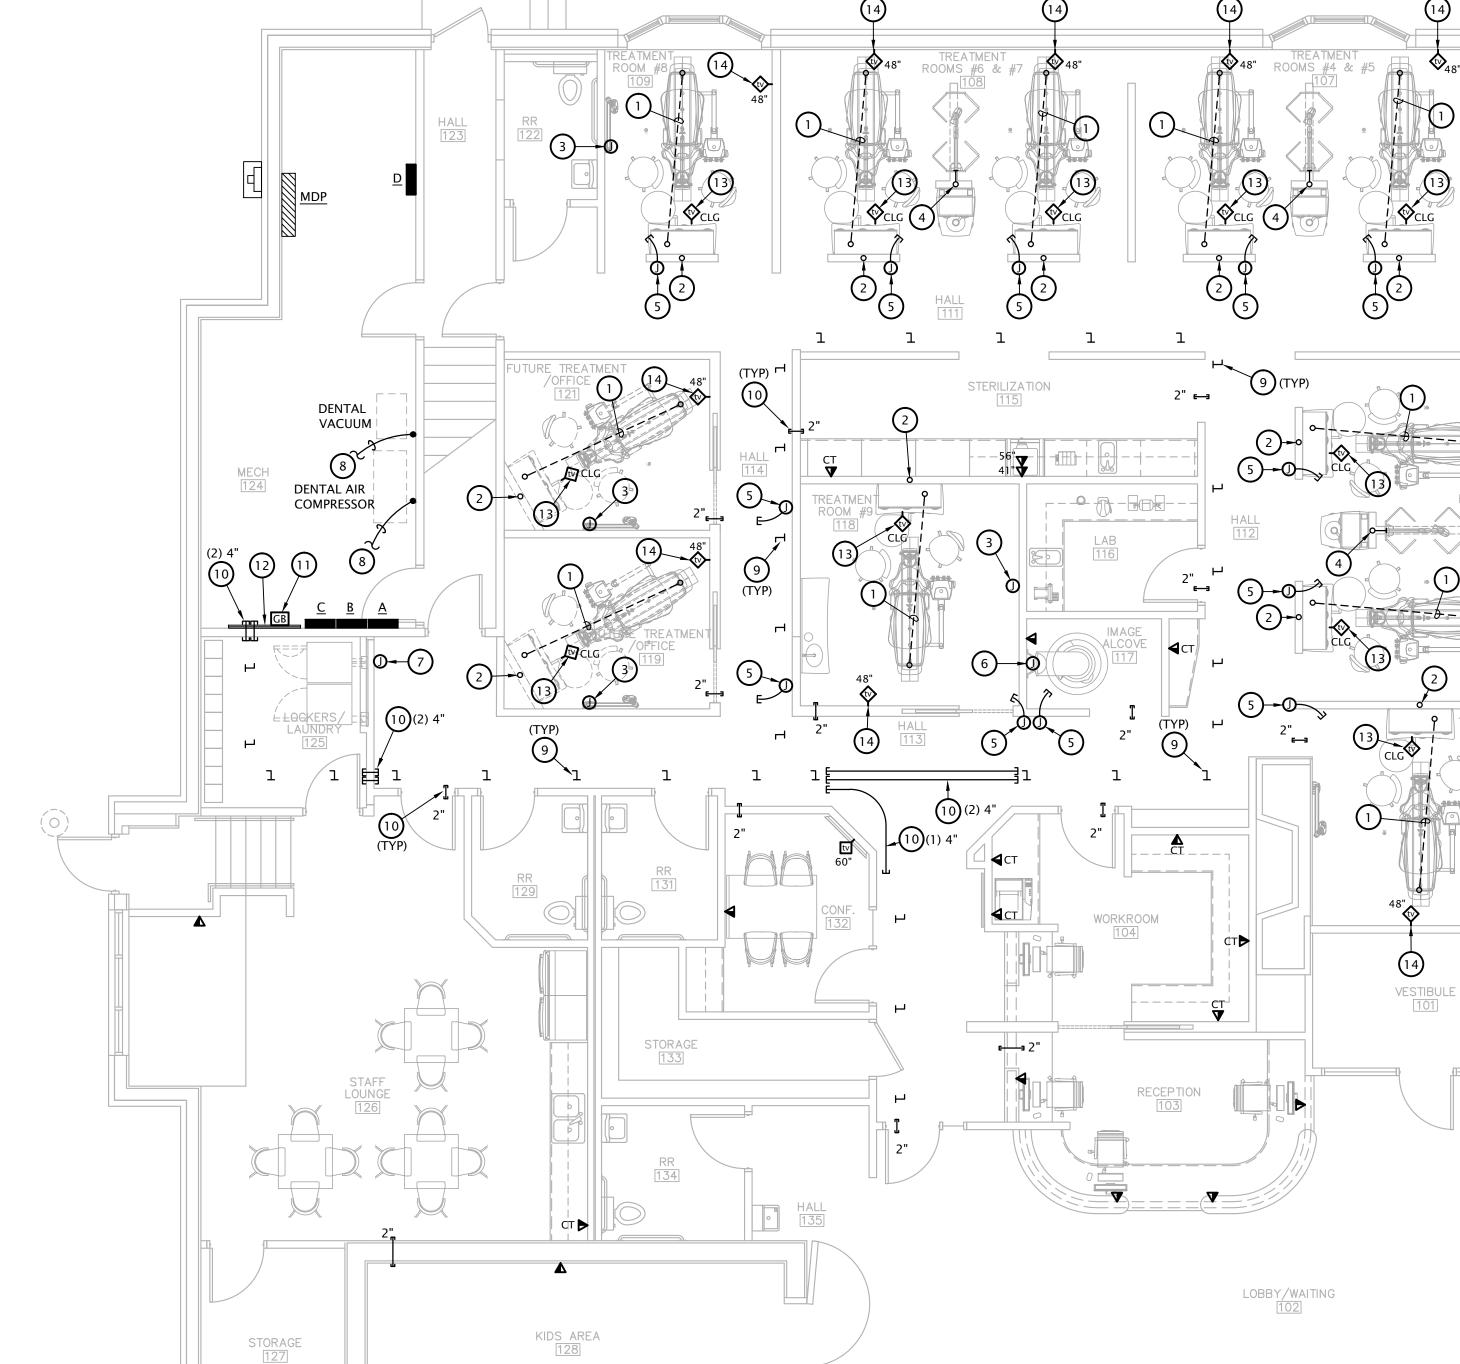



**REVISION:** 

DATE: 9-20-2023 22-3211 SHEET NO.:

E1.3

# **PANEL SCHEDULE NOTES BY SYMBOL**

- EXISTING PANELBOARD TO BE USED FOR NEW WORK. REUSE/REPLACE EXISTING BREAKERS AS NOTED.
- 2. REUSE EXISTING BREAKER FOR NEW CIRCUIT INDICATED.
- 3. REPLACE EXISTING BREAKER WITH NEW BREAKER OF AMP TRIP/POLE AS INDICATED.
- 4. RETAIN EXISTING BREAKER AS 'SPARE'.

				Manufacturer: Square D 'NQOB'  Bus Amps: 225  MCB Amps: MLO  AIC Rating:  Other: Existing Panelboard						
Circuit #	Load Description	Conductors	C/B Size	C/B Size	Conductors	Load Description	Circuit #			
1	RCPT: UTIL CNTRS RM#1	2#12, #12G, 1/2"C	20 / 1	20 / 1	2#12, #12G, 1/2"C	RCPT: UTIL CNTRS RM#9	2			
3	RCPT: WALL, TV RM #1	2#12, #12G, 1/2"C	20 / 1	20 / 1	2#12, #12G, 1/2"C	RCPT: WALL, TV RM#9	4			
5	X-RAY RM#1	2#12, #12G, 1/2"C	20 / 1	20 / 1	2#12, #12G, 1/2"C	X-RAY RM #9	6			
7	RCPT: LOUNGE/LAUNDRY	2#12, #12G, 1/2"C	20 / 1	20 / 1	2#12, #12G, 1/2"C	X-RAY RM 119	8			
9	LOUNGE REFRIGERATOR	2#12, #12G, 1/2"C	20 / 1	20 / 1	2#12, #12G, 1/2"C	RCPT: WALL, TV RM 119	10			
11	LOUNGE REFRIGERATOR	2#12, #12G, 1/2"C	20 / 1	20 / 1	2#12, #12G, 1/2"C	RCPT: UTIL CNTR 119	12			
13	RCPT: LOUNGE COUNTER	2#12, #12G, 1/2"C	20 / 1	20 / 1	2#12,#12G,1/2"C	RCPT: UTIL CNTRS RM121	14			
15	WEST ENTRY WALL HEATER	2#12, #12G, 1/2"C	20 / 1	20 / 1	2#12, #12G, 1/2"C	RCPT: WALL, TV RM 121	16			
17	VEST. 101 WALL HEATER	2#12, #12G, 1/2"C	20 / 1	20 / 1	2#12, #12G, 1/2"C	X-RAY RM 121	18			
19	RCPT: HALL/STOR./VEST	2#12, #12G, 1/2"C	20 / 1	20 / 1	2#12, #12G, 1/2"C	RCPT: WORKROOM CNTR	20			
21	RCPT: RESTROOMS	2#12, #12G, 1/2"C	20 / 1	20 / 1	2#12, #12G, 1/2"C	WORKROOM COPIER	22			
23	RCPT: CONF. ROOM 132	2#12, #12G, 1/2"C	20 / 1	20 / 1	2#12, #12G, 1/2"C	RCPT: WORKROOM CNTR	24			
25	RCPT: DRINKING FTN	2#12, #12G, 1/2"C	20 / 1	20 / 1	2#12, #12G, 1/2"C	RCPT: RECEPTION DESK	26			
27	RCPT: KIDS AREA	2#12, #12G, 1/2"C	20 / 1	20 / 1	2#12, #12G, 1/2"C	RCPT: WRKRM/RECEPT DSK	28			
29	RCPT: WAITING	2#12, #12G, 1/2"C	20 / 1	20 / 1	2#12, #12G, 1/2"C	RCPT: RECEPTION COUNTR	30			
31	LOUNGE MICROWAVE	2#12, #12G, 1/2"C	20 / 1	20 / 1		SPARE BREAKER	32			
33	EXTERIOR LTG CONTROL	2#12, #12G, 1/2"C	20 / 1	20 / 1		SPARE BREAKER	34			
35	EXTERIOR BLDG SIGN	2#12, #12G, 1/2"C	20 / 1	20 / 1		SPARE BREAKER	36			
37	S PARE BREAKER		20 / 1				38			
39	S PARE BREAKER		20 / 1	30 / 3		SPARE BREAKER	40			
41	S PARE BREAKER		20 / 1				42			

				Manufacturer: Square D 'NQ'  Bus Amps: 225  MCB Amps: MLO  AIC Rating: 10 kAIC  Other:							
Circuit #	Load Description	Conductors	C/B Size	C/B Size	Conductors	Load Description	Circuit #				
1	PANORAMIC IMAGING UNIT	2#12, #12G, 1/2"C	20 / 2	15 / 1	2#12, #12G, 1/2"C	MECH RM EXH FAN 'EF-5'	2				
3				20 / 1	2#12, #12G, 1/2"C	RCPT: MECH/HALL/RR	4				
5	PANORAMIC IMAGING UNIT	2#12, #12G, 1/2"C	20 / 1	20 / 1	2#12, #12G, 1/2"C	HALLWAY HEATER 'EWH-3'	6				
7	RCPT: UTIL CNTRS RM#2	2#12, #12G, 1/2"C	20 / 1	20 / 1	2#12, #12G, 1/2"C	RCPT: UTIL CNTR RM #8	8				
9	RCPT: WALL, TV'S RM #2/#3	2#12, #12G, 1/2"C	20 / 1	20 / 1	2#12, #12G, 1/2"C	RCPT: WALL, TV RM #8	10				
11	X-RAY RMS #2/#3	2#12, #12G, 1/2"C	20 / 1	20 / 1	2#12, #12G, 1/2"C	X-RAY RM #8	12				
13	RCPT: UTIL CNTRS RM#3	2#12, #12G, 1/2"C	20 / 1	20 / 1	2#12, #12G, 1/2"C	RCPT: HALL/STERIL	14				
15	RCPT: UTIL CNTRS RM#4	2#12, #12G, 1/2"C	20 / 1	20 / 1	2#12, #12G, 1/2"C	RCPT: HALL/LAB/IMAGE	16				
17	RCPT: WALL, TV'S RM #4/#5	2#12, #12G, 1/2"C	20 / 1	20 / 1	2#12, #12G, 1/2"C	RCPT: HALL 112 COUNTER	18				
19	X-RAY RMS #4/#5	2#12, #12G, 1/2"C	20 / 1	20 / 1	2#12, #12G, 1/2"C	AUTOCLAVE STERILIZER	20				
21	RCPT: UTIL CNTRS RM#5	2#12, #12G, 1/2"C	20 / 1	20 / 1	2#12, #12G, 1/2"C	CASSETTE STERILIZER	22				
23	RCPT: UTIL CNTRS RM#6	2#12, #12G, 1/2"C	20 / 1	20 / 1	2#12, #12G, 1/2"C	RCPT: STERIL. COUNTER	24				
25	RCPT: WALL, TV'S RM#6/#7	2#12, #12G, 1/2"C	20 / 1	20 / 1	2#12, #12G, 1/2"C	RCPT: STERIL. COUNTER	26				
27	X-RAY RMS #6/#7	2#12, #12G, 1/2"C	20 / 1	20 / 1	2#12, #12G, 1/2"C	RCPT: LAB COUNTER	28				
29	RCPT: UTIL CNTRS RM#7	2#12, #12G, 1/2"C	20 / 1	20 / 1	2#12, #12G, 1/2"C	RCPT: LAB COUNTER	30				
31	SPARE BREAKER		20 / 1	20 / 1		SPARE BREAKER	32				
33	SPARE BREAKER		20 / 1	20 / 1		SPARE BREAKER	34				
35	SPARE BREAKER		20 / 1	20 / 1		SPARE BREAKER	36				
37	SPACE ONLY					SPACE ONLY	38				
39	SPACE ONLY					SPACE ONLY	40				
41	SPACE ONLY					SPACE ONLY	42				

MARK	MANUFACTURER	MODEL NUMBER	LAMP DATA	DRIVER	MOUNTING	FINISH	DESCRIPTION	NOTES
A1	ILP	VPAN24-33L/44L/55L-U-CCTS	28W LED 3992 LUMEN	0-10V DIMMING	LAY-IN	WHITE	2x4 BACK-LIT FLAT PANEL, FROSTED ACRYLIC LENS	3,4
A2	ILP	VPAN24-33L/44L/55L-U-CCTS	49W LED 6466 LUMEN	0-10V DIMMING	LAY-IN	WHITE	2x4 BACK-LIT FLAT PANEL, FROSTED ACRYLIC LENS	3,4
B1	ILP	VPAN22-22L/33L/44L-U-CCTS	20W LED 2904 LUMEN	0-10V DIMMING	LAY-IN	WHITE	2x2 BACK-LIT FLAT PANEL, FROSTED ACRYLIC LENS	3,4
B2	ILP	VPAN22-22L/33L/44L-U-CCTS	39W LED 5240 LUMEN	0-10V DIMMING	LAY-IN	WHITE	2×2 BACK-LIT FLAT PANEL, FROSTED ACRYLIC LENS	3,4
С	ILP	FZ4-40W-U40-FRAL	40W LED 5850 LUMEN	0-10V DIMMING	SURFACE	WHITE	4' STRIP WITH FROSTED ACRYLIC LENS	
D	PRESCOLITE	LBRST-6RD-M-LS-SL-CWCS9-WH / LB-6R-F-TG	13W LED 1326 LUMEN	0-10V DIMMING	RECESSED	WHITE TRIM	6"Ø DOWNLIGHT, SELF-FLANGED REFLECTOR, WITH FRAME FOR JOIST AND T-GRID CEILING MOUNTING	
E	EVENLITE	WW-EM-BZ-CT	(8) LED'S 600 LUMEN	N/A	WALL AT 8'-0" AFF	BRONZE	DIE CAST WALL MOUNT, EMERGENCY ONLY OPERATION, INTEGRAL HEATER FOR COLD WEATHER OPERATION	2
F	ILP	SQ2-3L-U-40	22W LED 2700 LUMEN	0-10V DIMMING	WALL AT 7'-0"AFF TO BOTTOM	WHITE	2' WALL MOUNT WRAP WITH CURVED FROSTED ACRYLIC LENS, ALUMINUM HOUSING	
G	ILP	SWR4-36L-U-40	31W LED 3657 LUMEN	0-10V DIMMING	SURFACE	WHITE	4' UTILITY WRAPAROUND, FROSTED POLYCARBONATE LENS	-
Н	PRESCOLITE	LFR-6RD-M-30L40K8-XW-DM1 / LFR-6RD-T-SS / LFR-6RD-H	25W LED 3200 LUMEN	0-10V DIMMING	RECESSED	SEMI-SPECULAR	6"Ø DOWNLIGHT, SELF-FLANGED REFLECTOR, WIDE DISTRIBUTION	
HE	PRESCOLITE	LFR-6RD-M-30L40K8-XW-DM1-EM / LFR-6RD-T-SS-EM / LFR-6RD-H	25W LED 3200 LUMEN	0-10V DIMMING	RECESSED	SEMI-SPECULAR	SAME AS TYPE 'H', EXCEPT WITH INTEGRAL EMERGENCY BATTERY BACKUP	2
J	PRESCOLITE	LFR-6RW-M-15L40K8-LWW-DM1 / LFR-6RD-T-WW-SS / LFR-6RD-H	12W LED 1200 LUMEN	0-10V DIMMING	RECESSED	SEMI-SPECULAR	6"Ø LENSED WALL WASH DOWNLIGHT, SELF-FLANGED REFLECTOR	-
K	KIM LIGHTING	CY1-25-4K8-1-3-UNV-DBT-F-FPP-SCB	26W LED 2130 LUMEN	0-10V DIMMING	WALL AT 9-'0" AFF	DARK BRONZE	CAST ALUMINUM WALL PACK WITH IES TYPE III DISTRIBUTION, SURFACE MOUNT BOX	5
KE	KIM LIGHTING	CY1-25-4K8-1-3-UNV-DBT-F-FPP-SCB/EM	26W LED 2130 LUMEN	0-10V DIMMING	WALL AT 9-'0" AFF	DARK BRONZE	SAME AS TYPE 'K', EXCEPT WITH INTEGRAL EMERGENCY BATTERY BACKUP WITH HEATER	5
L	PRESCOLITE	LFR-4RD-M-20L40K8-DM1/LFR-4RD-T-SSCL/ LFR-4RD-H-IC	16W LED 1930 LUMEN	0-10V DIMMING	RECESSED	SEMI-SPECULAR	4"Ø DOWNLIGHT, SELF-FLANGED REFLECTOR, MEDIUM DISTRIBUTION, WET LISTED UNDER COVERED CEILING, IC RATED HOUSING	-
М	KIM LIGHTING	WDM-D-48L-85-4K7-4W-UNV-DBT-SCM1	85W LED 10900 LUMEN	0-10V DIMMING	WALL AT 13'-0" AFF	DARK BRONZE	CAST ALUMINUM WALL PACK WITH IES TYPE IV WIDE DISTRIBUTION; SURFACE MOUNT BACK BOX, FULL CUTOFF	5
N	KIM LIGHTING	WDS-D-24L-30-4K7-2-UNV-DBT-SCM1	30W LED 3400 LUMEN	0-10V DIMMING	WALL AT 10'-0" AFF	DARK BRONZE	CAST ALUMINUM WALL PACK WITH IES TYPE II DISTRIBUTION; SURFACE MOUNT BACK BOX, FULL CUTOFF	5
NE	KIM LIGHTING	WDS-D-24L-30-4K7-2-UNV-DBT-SCM1/EM	30W LED 3400 LUMEN	0-10V DIMMING	WALL AT 10'-0" AFF	DARK BRONZE	SAME AS TYPE 'N', EXCEPT WITH INTEGRAL EMERGENCY BATTERY BACKUP	5
P	PRIMA	2841S-E6-LO-SV-SC-408-N	12W LED 700 LUMEN	STANDARD INTEGRAL	CORD SUSPENDED AT 84" AFF TO BOTTOM	SILVER	2"Ø DECORATIVE MONOPOINT PENDANT, NARROW FLOOD, DRIVER CONTAINED IN CANOPY	
XI	EVENLITE	CCDS-EM-R-1-WW-CN-SD	RED LED	N/A	WALL/CEILING	WHITE	SINGLE FACE EXIT SIGN WITH EMERGENCY BATTERY BACKUP, CAST ALUMINUM HOUSING	1,2
X2	EVENLITE	CCDS-EM-R-2-WW-CN-SD	RED LED	N/A	CEILING	WHITE	DOUBLE FACE EXIT SIGN WITH EMERGENCY BATTERY BACKUP, CAST ALUMINUM HOUSING	1,2

- All LED's shall be 4000° K correlated color temperature, minimum 80 CRI.
- All light fixtures shall be provided with universal drivers capable of operating at 120V or 277V UNO.
- Provide manufacturer's flange kit where lay-in fixtures are to be installed in gyp board ceilings.

- 1. Fixture shall be capable of wall or ceiling mount applications and shall have break-out directional chevrons.
- 2. Provide with emergency battery integral charger with self-diagnostic/self-testing electronics
- 3. Where fixtures are shown half-shaded, provide with factory installed 10 watt battery backup, 'EM10' option.
- 4. Install fixture per Detail 3, Sheet E1.1.
- 5. Fixture shall be U.L. listed for Wet locations.

Γ		Designation:	В			Manufact urer:	Square D 'NQOB'		1
		Location:	Mech Room			Bus Amps:			
		_	208Y/120V-3Ph-4W			MCB Amps:	MLO		
		Enclosure:				AIC Rating:	Frieting Develler and		
F		Mounting:	Surrace			Otner:	Existing Panelboard	Ι	4
С	ircuit #	Load Description	Conductors	C/B Size	C/B Size	Conductors	Load Description	Circuit #	
	1	LTG: MECH/MEZZ/LOUNGE	2#12, #12G, 1/2"C	20 / 1	20 / 1	2#12, #12G, 1/2"C	DENTAL LTS: RMS 7, 8 & 9	2	2
3	3	LTG: HALL/TRTMT RMS	2#12, #12G, 1/2"C	20 / 1	20 / 1	2#12, #12G, 1/2"C	DENTAL LTS: RMS 4, 5 & 6	4	2
2	5	LTG: HALL/TRTMT/LOBBY	2#12, #12G, 1/2"C	20 / 1	20 / 1	2#12, #12G, 1/2"C	DENTAL LTS: RMS 1, 2 & 3	6	3
2	7	EXTERIOR LIGHTING	2#12, #12G, 1/2"C	20 / 1	20 / 1	2#12, #12G, 1/2"C	WATER HEATER	8	3
2	9	CLOTHES DRYER	3#10, #10G, 3/4"C	30 / 2	15 / 1	2#12, #12G, 1/2"C	HOT WATER RECIRC PUMP	10	3
	11				15 / 1	2#12, #12G, 1/2"C	FURNACE 'F-1'	12	3
3	13	CLOTHES WASHER	2#12, #12G, 1/2"C	20 / 1	15 / 1	2#12, #12G, 1/2"C	FURNACE 'F-2'	14	3
3	15	RCPT: TELECOM BOARD	2#12, #12G, 1/2"C	20 / 1	15 / 1	2#12, #12G, 1/2"C	FURNACE 'F-3'	16	3
3	17	DENTAL LTS: FUTURE RMS	2#12, #12G, 1/2"C	20 / 1	15 / 1	2#12, #12G, 1/2"C	FURNACE 'F-4'	18	3
	19							20	
1	21	SPARE BREAKER		20 / 3	20 / 3		SPARE	22	4
	23							24	
	25						SPACE ONLY	26	
1	27	SPARE BREAKER		50 / 3			SPACE ONLY	28	
	29						SPACE ONLY	30	
	31	SPACE ONLY					SPACE ONLY	32	
	33	SPACE ONLY					SPACE ONLY	34	
	35	SPACE ONLY					SPACE ONLY	36	
	37	SPACE ONLY					SPACE ONLY	38	
	39	SPACE ONLY					SPACE ONLY	40	
	41	SPACE ONLY					S PACE ONLY	42	

D	esignation: MDP  Location: Mech 124  Voltage: 208Y/120V-3Ph-4W	Enclosure: NEMA 1 Mounting: Wall Manufacturer: Square D 'QMB'	Bus Amps: 400 Main Switch: 400/3 w/ 400A Fuses Other: Existing Distribution Pane		
Circuit #	Equipment Served	Feeder Size	Switch Size	Fusing	Remar
1	PANEL 'A'	(ETR)	100	100	EXISTING TO
2	S PARE S WITCH		100		EXISTING TO
3	PANEL 'B'	(ETR)	100	100	EXISTING TO
4	S PARE S WITCH		100		EXISTING TO
5	PANEL 'D'	4#1/0, #6G, 2"C	200	150	SEE NOT
6	PANEL 'C'	(ETR)	200	200	EXISTING TO

	Designation: A  Location: Mech Room  Voltage: 208V-3Ph-3W  Enclosure: NEMA 1  Mounting: Surface					Manufacturer: Square D 'NQOB'  Bus Amps: 100  MCB Amps: MLO  AIC Rating:  Other: Existing Panelboard			
(	Circuit #	Load Description	Conductors	C/B Size	C/B Size	Conductors	Load Description	Circuit #	
_	1	'CU-1'	2#6, #10G, 3/4"C	50 / 2	15 / 2	2#12, #12G, 1/2"C	'HP-1'	2	
3 -	3							4	
3 -	5	'CU-2'	2#6, #10G, 3/4"C	50 / 2	20 / 2	2#12, #12G, 1/2"C	DENTAL VACUUM	6	
_	7							8	
3 -	9	'CU-3'	2#8,#10G, 3/4"C	40 / 2	40 / 2	2#8, #10G, 3/4"C	DENTAL AIR COMPRESSOR	10	
╣	11							12	
2 -	13	'CU-4'	2#10, #10G, 3/4"C	20 / 2	20 / 2		SPARE BREAKER	14	
	15							16	
3 -	17	'HP-2'	2#10, #10G, 3/4"C	30 / 2			SPACE ONLY	18	
$\dashv$	19						SPACE ONLY	20	

LST Consulting Engineers, PA
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9-20-2023 22-3211 © SHEET NO.:

E6.1

# PREPARED FOR:

# DR. BRETT URBAN ROSSVILLE FAMILY DENTISTRY

# GENERAL NOTES & CONDITIONS (ALL TRADES)

# DEFINITIONS

**HENRY SCHEIN**, HENRY SCHEIN INC., HENRY SCHEIN DENTAL, OR HSD INC. REFERS TO THE EQUIPMENT SUPPLIER FOR THIS PROJECT ENGAGED BY THE OWNER UNDER A SEPARATE CONTRACT.

**E.S.** - "EQUIPMENT & TECHNOLOGY SPECIALIST" IS A HENRY SCHEIN EMPLOYEE THAT SPECIALIZES IN THE MANAGEMENT OF EQUIPMENT AND/OR TECHNOLOGY SALES AND INSTALLATIONS AND HAS ASSISTED THE OWNER IN THE PREPARATION OF DRAWINGS AND SPECIFICATIONS FOR THE CONSTRUCTION OF THE PROPOSED FACILITIES.

THE "GENERAL CONTRACTOR", ALSO KNOWN AS THE 'G.C.' IS REFERRED TO AS THE PERSON(S) OR ENTITY WHO HAS ENTERED INTO A CONTRACTUAL AGREEMENT WITH THE OWNER FOR THE WORK DEFINED IN SUCH AGREEMENT. THE G.C. IS RESPONSIBLE FOR ALL WORK CARRIED OUT BY THEIR SUBCONTRACTORS OR SUBTRADES. IF THE CONSTRUCTION OF THE PROJECT IS LET UNDER SEPARATE CONTRACTS BY THE OWNER, THE RESPONSIBILITIES STIPULATED BELOW SHALL APPLY TO EACH CONTRACTOR.

THE "OWNER" IS REFERRED TO AS THE PERSON(S) OR ENTITY WHO OWNS OR LEASES THE PREMISES FOR WHICH A CONSTRUCTION AGREEMENT HAS BEEN ENTERED UPON WITH THE GENERAL CONTRACTOR. WHERE THE OWNER, AS REFERRED TO ABOVE, LEASES THE PREMISES THE ENTITY WHO HAS OWNERSHIP OF THE PROPERTY WILL BE REFERRED TO AS THE LANDLORD.

THE "OWNER'S AGENT" IS A REPRESENTATIVE OF THE AGENT ACTING ON THEIR BEHALF AND MAY HAVE THE AUTHORITY TO MAKE DECISIONS IN THEIR ABSENCE. THIS MAY BE AN OFFICE MANAGER, AN ARCHITECT, AN ENGINEER, OR A PROJECT MANAGER HIRED BY THE OWNER.

# . DRAWINGS

THESE DRAWINGS ARE PREPARED BY HENRY SCHEIN AS DENTAL CONSULTANTS FOR ASSISTING AN ARCHITECT/CONTRACTOR TO PRODUCE CONSTRUCTION DOCUMENTS & BUILD A DENTAL OFFICE. THEY DO NOT CONSTITUTE A COMPLETE SET OF CONSTRUCTION DOCUMENTS. ITEMS REQUIRED FOR BUILDING PERMITS OR CONSTRUCTION MAY NOT APPEAR ON THESE DRAWINGS. IF THESE DRAWINGS ARE BEING SUBMITTED FOR BUILDING PERMIT, IT REMAINS THE OWNER AND/OR GENERAL CONTRACTOR'S RESPONSIBILITY RETAIN THE PROPER CONSULTANTS TO PREPARE COMPLETE ARCHITECTURAL, STRUCTURAL, MECHANICAL AND ELECTRICAL DRAWINGS.

DOOR SPECIFICATIONS, LIGHTING DESIGN, FINAL REFLECTED CEILING PLANS, AND OTHER SPECIFICATIONS NOT COVERED IN THESE DRAWINGS ARE BY OTHERS.

RETENTION OF OTHER CONSULTANTS SUCH AS AN ARCHITECT, M.E.P. ENGINEERS, OR SECURITY CONSULTANT, ARE THE RESPONSIBILITY OF THE OWNER AND/OR GENERAL CONTRACTOR.

# 3. HENRY SCHEIN, INC. RESPONSIBILITIES

HENRY SCHEIN, INC. WILL ISSUE DETAILED DRAWINGS SHOWING CRITICAL LOCATIONS & REQUIREMENTS OF ALL DENTAL-SPECIFIC EQUIPMENT. THE E.S. WILL BE AVAILABLE FOR PERIODIC FIELD VISITS. VISITS WILL BE LIMITED TO A PRE-CONSTRUCTION ON-SITE MEETING, LAYOUT CHECKS AND INSTRUCTIONS TO THE VARIOUS TRADES IN THE CRITICAL ASPECTS OF THE WORK PERTAINING TO DENTAL AND ALLIED EQUIPMENT. ALL REQUESTS FOR FIELD VISITS SHALL ALLOW REASONABLE ADVANCED NOTICE. HENRY SCHEIN, INC. AND ITS REPRESENTATIVES WILL NOT ASSUME ANY RESPONSIBILITIES FOR DEVIATIONS FROM THESE DRAWINGS WITHOUT PRIOR WRITTEN CONSENT.

PRIOR TO CONSTRUCTION, THE E.S. WILL VERIFY THE SITE DIMENSIONS OF THE SPACE PRIOR TO ENSURE THEY COINCIDE WITH THE DETAILED DRAWINGS. DURING CONSTRUCTION, THE E.S. WILL CHECK THE JOBSITE PERIODICALLY AS REQUIRED. THE E.S. WILL BE AVAILABLE TO ASSIST THE CONTRACTOR(S) AND THE OWNER IN THE INTERPRETATION OF THESE DRAWINGS AND SPECIFICATIONS. PRIOR TO ENCLOSING WALLS, THE GENERAL CONTRACTOR AND/OR THE FRAMING SUBCONTRACTOR IS REQUIRED TO COORDINATE WITH THE E.S. AND THE HENRY SCHEIN INSTALLATION TECHNICIAN. THIS INSPECTION IS CRITICAL TO ENSURE THAT THE WALL AND/OR CEILING SUPPORTS FOR DENTAL EQUIPMENT WILL MATCH WITH ANY CHANGES THAT MAY HAVE OCCURRED WITH THE OWNER'S EQUIPMENT ORDER. IT IS THE RESPONSIBILITY OF THE GENERAL CONTRACTOR TO HAVE PLUMBING, ELECTRICAL, SUPPORT BACKING, AND LEAD INSTALLATION APPROVED BY MUNICIPAL INSPECTORS BEFORE POURING SLABS, ENCLOSING PARTITIONS AND CEILING.

HENRY SCHEIN WILL NOT BE RESPONSIBLE FOR ANY UNFORESEEN CONDITIONS ARISING OUT OF, OR DURING THE COURSE OF, CONSTRUCTION NOR FOR ANY DEVIATIONS FROM DRAWINGS AND/OR SPECIFICATIONS WITHOUT PRIOR WRITTEN CONCENT.

# EQUIPMENT INSTALLATION

A PRE-CONSTRUCTION MEETING IS REQUIRED WITH THE GENERAL CONTRACTOR, PLUMBER, ELECTRICIAN, CABINET MAKER, AND THE E.S. ALL TEMPLATES CRITICAL TO EQUIPMENT INSTALLATION WILL BE DISTRIBUTED AT THIS MEETING.

THE E.S. WILL INSPECT PREMISES PRIOR TO THE INSTALLATION OF ITS EQUIPMENT AT WHICH TIME ALL FINISHES (CEILINGS, FLOORING, AND PAINTING) AND MECHANICAL WORK MUST BE COMPLETED. RESPONSIBILITIES FOR THE INSTALLATION AND/OR HOOKUP OF DENTAL EQUIPMENT WILL BE DEFINED IN THE SPECIFICATIONS FOR EACH TRADE. HENRY SCHEIN DENTAL REQUIRES THAT ALL APPLICABLE TRADES BE REPRESENTED AT THE TIME OF INSTALLATION.

# GENERAL CONTRACTOR (G.C.) - RESPONSIBILITIES

ALL ITEMS LISTED OR NOTED HEREIN ARE FOR GUIDANCE ONLY AND DO NOT NECESSARILY CONSTITUTE THE ENTIRE EXTENT OF THE WORK TO BE CARRIED OUT UNDER THE CONTRACT. THE GENERAL CONTRACTOR IS RESPONSIBLE TO DEFINE AND PROVIDE ALL THE WORK REQUIRED TO COMPLETE THIS PROJECT TO THE TRUE INTENT OF THE CONTRACT WHETHER OR NOT IT IS SPECIFICALLY SHOWN OR SPECIFIED. WHERE THESE DOCUMENTS DO NOT PROVIDE ALL THE INFORMATION NECESSARY FOR THE COMPLETE INSTALLATION OF ANY ITEM, THEN THE MANUFACTURER'S INSTRUCTIONS FOR THE ITEM SHALL BE STRICTLY FOLLOWED.

THE GENERAL CONTRACTOR SHALL, SUPPLY AND INSTALL ALL ITEMS, ARTICLES, MATERIALS, INCLUDE ALL LABOR, EQUIPMENT AND TOOLS NECESSARY TO COMPLETE THIS PROJECT AND ALL SYSTEMS SHOWN. TEST AND VERIFY ALL EQUIPMENT INSTALLED UNDER THIS CONTRACT AND INSTRUCT THE OWNER OR OWNER'S AGENT IN THE OPERATION OF THE EQUIPMENT.

THE G.C. SHALL THOROUGHLY FAMILIARIZE HIM/HERSELF WITH THE DRAWINGS, SPECIFICATIONS, AND CONDITIONS COVERING THIS JOB. THE G.C. SHALL ADVISE THE OWNER AND THE E.S. OF ANY CONFLICT BETWEEN THESE DRAWINGS AND THE FIELD CONDITIONS BEFORE PROCEEDING WITH THE WORK.

THE G.C. SHALL COMPLY WITH ALL STATE AND MUNICIPAL LAWS, ORDINANCES, RULES, AND REGULATIONS OF AUTHORITIES HAVING JURISDICTION. ALL WORK MUST MEET OR EXCEED THE CURRENT BUILDING CODE UNDER THE JURISDICTION FOR WHICH THIS PROJECT IS LOCATED. THE G.C. SHALL FILE ALL NECESSARY APPLICATIONS AND OBTAIN AND PAY FOR ALL PERMITS, AND CERTIFICATES OF APPROVAL PERTAINING TO THE CONSTRUCTION OF THE PREMISES, INCLUDING THE FINAL INSPECTION FOR OCCUPANCY PERMIT, UNLESS OTHERWISE STATED. PERMITS OBTAINED SHALL INCLUDE THE CONNECTIONS TO ALL DENTAL EQUIPMENT AND FIXTURES WHICH ARE TO BE COMPLETED BY THE GENERAL CONTRACTOR. HVAC, SPRINKLER DRAWINGS, CORRESPONDING SPECIFICATIONS OR ANY OTHER DRAWINGS AND SPECIFICATIONS THAT MAY BE REQUIRED FOR LICENSES AND PERMITS ARE TO BE PROVIDED BY OTHERS. HENRY SCHEIN INC. WILL NOT PROVIDE OR PAY FOR THESE SERVICES OR ANY OTHER DRAWINGS AND PERMITS.

ALL MEASUREMENTS SHALL BE CHECKED AT THE JOB SITE. THE GENERAL CONTRACTOR SHALL ASSUME ALL RESPONSIBILITY FOR THE ACCURACY OF FIELD MEASUREMENTS AND CONDITIONS. THEY ARE ALSO RESPONSIBLE FOR THE PROPER MODIFICATIONS TO ANY EXISTING, OR PREVIOUSLY INSTALLED WORK. WRITTEN APPROVAL MUST BE OBTAINED FROM THE E.S. BEFORE ANY CHANGES AND/OR DEVIATIONS FROM DRAWINGS AND SPECIFICATIONS ARE MADE.

THE G.C. SHALL ASSUME <u>FULL</u> RESPONSIBILITY FOR THE EXECUTION OF HIS/HER WORK AND FOR ANY CHANGES AND/OR DEVIATIONS FROM DRAWINGS OR SPECIFICATIONS MADE WITHOUT PRIOR WRITTEN APPROVAL FROM THE OWNER AND/OR THE E.S.. THE COST OF CORRECTIONS RESULTING FROM CHANGES AND/OR DEVIATIONS SHALL BE BORNE BY THE GENERAL CONTRACTOR.

A COMPLETE SET OF UP-TO-DATE DRAWINGS MUST BE KEPT AT THE JOB SITE AT ALL TIMES AND ANY CHANGES MUST BE NOTED THEREON AND INITIALED.

THE CONTRACTOR SHALL INDEMNIFY AND HOLD HARMLESS THE OWNER AND THE OWNER'S AGENT FROM AND AGAINST ALL CLAIMS FOR DAMAGE TO PERSON AND/OR PROPERTY SUFFERED AS A RESULT OF THE PERFORMANCE OF WORK, WHETHER OR NOT, CAUSED BY NEGLIGENCE, AND PAY ANY EXPENSES (INCLUDING, WITHOUT LIMITATIONS, ATTORNEY'S FEES, AND DISBURSEMENTS) INCURRED IN THE CONNECTION THEREWITH.

# OTHER REQUIREMENTS

THE G.C. SHALL PARTICIPATE AT JOB COORDINATION MEETINGS WITH THE HENRY SCHEIN REPRESENTATIVE AND ENSURE ATTENDANCE OF THE APPROPRIATE TRADES.

ALL TRADES SHALL DO THEIR OWN CUTTING. THE GENERAL CONTRACTOR SHALL DO ALL PATCHING TO CONFORM TO MATERIAL, TEXTURE, AND SURFACE ALIGNMENT WITH THE ADJOINING SURFACE AND FINAL TOUCH UP OF ALL FINISHED SURFACES.

THE GENERAL CONTRACTOR SHALL ENSURE THE PROTECTION OF ALL EQUIPMENT FURNISHED UNDER HIS/HER CONTRACT AND BY OTHERS.

THE G.C. SHALL REVIEW ALL CUSTOM CABINETRY, SUCH AT THE RECEPTION DESK, LABORATORY, AND STERILIZATION, WITH THE E.S. FOR ANY DENTAL EQUIPMENT INCOPRORATION.

THE G.C. SHALL REMOVE ANY RUBBISH FROM THE CONSTRUCTION SITE AND ENSURE THAT ALL PUBLIC SPACES ARE FREE OF CONSTRUCTION MATERIALS AND DEBRIS THROUGHOUT THE DURATION OF THE CONTRACT. THE G.C. IS RESPONSIBLE FOR THE TOTAL CLEAN UP OF THE JOB SITE UPON COMPLETION OF THEIR WORK.

THE GENERAL CONTRACTOR SHALL ISSUE A WRITTEN ONE-YEAR WARRANTY CERTIFICATE ON ALL WORKMANSHIP AND MATERIALS FROM THE DATE OF OCCUPANCY, UNLESS NOTED OTHERWISE IN THE CONSTRUCTION AGREEMENT BETWEEN THE OWNER AND THE G.C.. THIS CERTIFICATE SHALL BIND THE GENERAL CONTRACTOR TO PROMPTLY CORRECT, REPAIR, OR REPLACE, ANY DEFECTIVE EQUIPMENT OR WORKMANSHIP THAT WAS THE RESPONSIBILITY OF THE G.C., WITHOUT COST TO THE OWNER.

# SEPARATE CONTRACTS BY OWNER

THE OWNER RESERVES THE RIGHT TO PERFORM WORK RELATED TO THE PROJECT WITH HIS/HER OWN FORCES, AND TO AWARD SEPARATE CONTRACTS IN CONNECTION WITH OTHER PORTIONS OF THE PROJECT OR ON OTHER WORK ON THE SITE UNDER THESE OR SIMILAR CONDITIONS OF CONTRACT. IF THE GENERAL CONTRACTOR CLAIMS THAT DELAY OR ADDITIONAL COST IS INVOLVED BECAUSE OF SUCH ACTION BY THE OWNER, THE G.C. MUST ENSURE THAT THEIR CLAIM WAS ORIGINALLY PART OF THEIR CONTRACT AGREEMENT.

THE G.C. SHALL AFFORD THE OWNER AND SEPARATE CONTRACTORS REASONABLE OPPORTUNITY FOR THE INTRODUCTION AND STORAGE OF THEIR MATERIALS AND EQUIPMENT AND THE EXECUTION OF THEIR WORK. THE G.C. SHALL CONNECT AND COORDINATE THEIR WORK WITH OTHERS AS REQUIRED BY THE CONTRACT DOCUMENTS. ANY COSTS CAUSED BY DEFECTIVE AND/OR ILL-TIME WORK SHALL BE BORNE BY THE PARTY RESPONSIBLE.

SEE OWNER OR OWNER'S AGENT FOR NON-DENTAL ITEMS AND AREAS NOT DETAILED IN THESE DRAWINGS (SUCH AS RECEPTION, BUSINESS AREA, OFFICES, STAFF LOUNGE, STORAGE ROOMS, OFFICE-WIDE SOUND SYSTEMS, CONTROLS, ETC.).

# GENERAL NOTES

- 1. THESE DRAWINGS AND SPECIFICATIONS HAVE BEEN PRODUCED FOR THIS SPECIFIC PROJECT ONLY, AND SHALL REMAIN THE EXCLUSIVE PROPERTY OF HENRY SCHEIN INC. THESE DRAWINGS AND SPECIFICATIONS MAY NOT BE REPRODUCED OR USED FOR ANY OTHER PURPOSE WITHOUT EXPRESSED WRITTEN CONSENT AND FULL PAYMENT OF ANY ASSOCIATED FEES TO HENRY SCHEIN, INC.
- 2. ALL COMMUNICATIONS AND COORDINATION WITH TRADES SHALL BE THE RESPONSIBILITY OF THE G.C. UNLESS STATED OTHERWISE IN THE CONTRACT AGREEMENT.
- WITH ALL SPECIFICATIONS BEFORE THE WORK WILL START. A SIGNED COPY OF THE PLANS ARE TO BE RETURNED TO THE OWNER AND HENRY SCHEIN DENTAL.

THE G.C. MUST SIGN THIS SHEET STIPULATING THAT HE/SHE UNDERSTANDS AND WILL COMPLY

- 4. IT IS THE RESPONSIBILITY OF A SUBCONTRACTOR TO READ AND UNDERSTAND ALL NOTES AND ILLUSTRATIONS PERTAINING TO THEIR TRADE AND HOW THEIR WORK AFFECTS OTHER TRADES.
- 5. THE SUPPLY AND INSTALL OF THE CABINETS AND COUNTERTOPS, OTHER THAN THOSE SPECIFIED AND/OR CONTRACTED BY HENRY SCHEIN, INC., IS THE RESPONSIBILITY OF THE G.C...
- 6. THE OWNER SHALL MAKE ARRANGEMENTS FOR INSTALLATION OF NON-DENTAL SYSTEMS UNDER A SEPARATE CONTRACT BEFORE WALLS ARE ENCLOSED.
- 7. ROUGH-IN AND FINISH WORK FOR DENTAL EQUIPMENT IS TO BE ACCORDING TO TEMPLATES FURNISHED BY THE MANUFACTURERS OF EQUIPMENT BEING INSTALLED. THE E.S. WILL POSITION THE TEMPLATES IN THEIR PROPER LOCATIONS, AT WHICH TIME ALL SPECIFICATIONS ON THE PLANS WILL BE EXPLAINED TO THE GENERAL CONTRACTOR OR SUBCONTRACTOR(S). ALL SPECIFIED SIZES OF PIPES, TUBING, FITTINGS, ETC., AS WELL AS PROPER HEIGHTS MARKED, MUST BE STRICTLY FOLLOWED. ANY DEVIATIONS ON SIZES OR HEIGHTS OF PIPES, TUBING, AND/OR FITTINGS MUST BE CORRECTED BEFORE THE EQUIPMENT CAN BE INSTALLED, AND ANY SUCH EXTRA EXPENSE WILL BE THE RESPONSIBILITY OF G.C. AND/OR THE SUBTRADE.
- 8. THE G.C. SHALL SEAL ANY/ALL FLOOR AND FIRE PENETRATIONS MADE BY HENRY SCHEIN INSTALLERS AT THE FINISHING STAGES WITH THE APPROPRIATE MATERIAL.
- THE G.C. SHALL PROVIDE DOOR THRESHOLDS & DOOR SEALS NECESSARY FOR DENTAL EQUIPMENT SOUND ATTENUATION.
- 10. THE GENERAL CONTRACTOR SHALL SUPPLY FASTENERS, ANCHORS, ACCESSORIES AND ADHESIVES REQUIRED FOR FABRICATION AND ERECTION OF THE WORK. KEEP EXPOSED FASTENERS TO A MINIMUM, NEATLY LAID OUT AND EVENLY SPACED. FLOOR FINISHES ARE TO BE CONTINUOUS UNDERNEATH MILLWORK AND EQUIPMENT. TRANSITIONS AND VARIATIONS BETWEEN FLOOR FINISHES TO BE SMOOTH AND LEVEL TO REDUCE INJURY WITH USE. PROVIDE 3/4" (19MM) PLYWOOD SUPPORT BETWEEN STUDS FOR ALL WALLS TO SUPPORT UPPER CABINETRY AND SHELVING, INCLUDING RECEPTION AND ALL TREATMENT ROOMS. WOOD SUPPORTS ABOVE THE CEILING MAY NEED TO BE FIRE RATED, FOLLOW LOCAL CODES.
- 11. PRIOR TO POURING THE CONCRETE FLOOR AND ENCLOSING ALL WALLS, THE GENERAL CONTRACTOR SHALL CONTACT THE E.S. AND INSTALLATION TECHNICIAN FOR FINAL INSPECTION OF PLUMBING, ELECTRICAL AND WOOD SUPPORTS.
- 12. ALL LABOR AND MATERIAL NECESSARY FOR CHANGES IN EXISTING PLUMBING, CARPENTRY, AND ELECTRICAL WORK MUST BE DONE AND SUPPLIED BY THE GENERAL CONTRACTOR AND IS NOT INCLUDED IN THE COST OF EQUIPMENT.
- 13. ALL PLUMBING AND ELECTRICAL LINES ARE TO BE CONCEALED UNLESS OTHERWISE SPECIFIED.

# 14. THE ELECTRICAL PANEL SHALL BE CONVENIENT AND ACCESSIBLE, MEET ELECTRICAL CODE REQUIREMENTS, AND BE LOCATED IN THE SUITE. LOCATION TO BE APPROVED BY THE OWNER AND LANDLORD. THE G.C. SHALL REVIEW THE LOCATION WITH THE E.S., AS WELL AS THE LOCATIONS OF THE TELEPHONE SYSTEM AND SERVER.

- 15. HENRY SCHEIN, INC. SHALL NOT BE HELD RESPONSIBLE FOR SUPPLYING UL/ULC OR CSA APPROVAL CERTIFICATES. THE G.C. MAY CONTACT THE MANUFACTURER IF REQUIRED.
- 16. THE ELECTRICAL SUBCONTRACTOR SHALL PROVIDE SPECIFIED TERMINATION BOXES, RECEPTACLES AND ANY HARDWIRE CIRCUITS LOCATED IN CUSTOM DENTAL CABINETRY. THEY ARE ALSO RESPONSIBLE FOR SUPPLYING GFCI RECEPTACLES WHERE REQUIRED BY CODE.
- 17. THE G.C. IS TO MAKE ARRANGEMENTS FOR TEMPORARY POWER AND/OR DISCONNECTION OF ELECTRICAL AND MECHANICAL SYSTEMS IF AND WHEN REQUIRED.
- 18. IF MULTIMEDIA SYSTEMS, SUCH AS ENTERTAINMENT TVS, MONITORS, OR NETWORK COMPUTER SYSTEMS, OR SECURITY SYSTEMS ARE SUPPLIED AND INSTALLED BY HENRY SCHEIN, INC., THEN THESE SYSTEMS WILL BE THEIR RESPONSIBILITY. WHEN THESE SYSTEMS, OR OTHER SYSTEMS, ARE NOT PROVIDED BY HENRY SCHEIN, INC., HENRY SCHEIN, INC. SHALL NOT BE HELD RESPONSIBLE FOR THEIR INSTALLATION OR COMMISSIONING.
- 19. HENRY SCHEIN, INC. WILL ASSEMBLE EQUIPMENT AND, WHERE SPECIFIED WITHIN THESE DRAWINGS, CONNECT TO UTILITIES PROVIDED, SUCH CONNECTIONS BY OTHER TRADES ARE SUPPLIED CORRECTLY AND COMPLETELY (WITH PROPER SHUT-OFF VALVES/FITTINGS/OUTLETS/TERMINATIONS). VERIFY ALL CONTRACTOR RESPONSIBILITIES FOR FINAL CONNECTIONS WITH THESE DRAWINGS AND HENRY SCHEIN DENTAL E.S.. DIRECT ANY QUESTIONS REGARDING CONTRACTOR RESPONSIBILITIES TO HENRY SCHEIN DENTAL E.S. PRIOR TO CONSTRUCTION.
- 20. WHEN APPLICABLE, THE G.C. SHALL BE RESPONSIBLE FOR PROCURING A PLUMBING SUB-CONTRACTOR THAT IS CERTIFIED TO INSTALL NITROUS OXIDE~OXYGEN CONSCIOUS SEDATION SYSTEMS AS DETAILED IN THESE PLANS. HENRY SCHEIN DENTAL IS A NITROUS OXIDE SYSTEM END USER COMPONENT SUPPLIER AND DOES NOT MANUFACTURE OR DESIGN ANY OF THESE SYSTEMS. ANY SYSTEM DESIGN SHOWN ON THESE PLANS BY HENRY SCHEIN DENTAL IS TO BE USED AS AN ILLUSTRATION ONLY FOR THE PURPOSE OF LOCATING END USER OUTLET STATIONS, CYLINDER ROOM MANIFOLD, AND ALARM PANEL. THE FINAL TRUNK SYSTEM INSTALLATION SHALL ADHERE TO THE MECHANICAL ENGINEERING DRAWINGS PREPARED BY
- 21. PLUMBING SUBCONTRACTOR SHALL PROVIDE GAS CERTIFICATION CREDENTIALS IN ACCORDANCE WITH ANY REQUESTS BY THE OWNER, GENERAL CONTRACTOR, BUILDING DEPARTMENT, OR HENRY SCHEIN DENTAL PRIOR TO COMMENCING WORK IF ANY TYPE OF NITROUS~OXIDE SYSTEM IS BEING INCORPORATED INTO THE PROJECT.

PRIOR TO POURING THE CONCRETE FLOOR AND ENCLOSING ALL WALLS AND CEILINGS, THE GENERAL CONTACT THE E.S. AND INSTALLATION TECHNICIAN FOR FINAL INSPECTION OF PLUMBING, ELECTRICAL AND WOOD SUPPORTS.

EQUIPMENT SPECIALIST (E.S.): TELEPHONE:

ADAM HALABI (316)644-1473

INSTALLATION TECHNICIAN:

A THIRD PARTY.

TELEPHONE:

DR. BRETT URBA SVILLE FAMILY DEN

**SHEET INDEX** 

DENTAL EQUIPMENT FLOOR PLAN

CEILING PLAN - TREATMENT ROOMS

DENTAL PLUMBING SPECIFICATIONS

DENTAL ELECTRICAL SPECIFICATIONS

DENTAL REINFORCEMENT PLAN

DENTAL EQUIPMENT DETAILS

DENTAL EQUIPMENT DETAILS

**COVER SHEET** 

HENRY SCHEIN REP: ADAM HALABI

REGION: KS-KANSAS PHONE #: (316)644-1473

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PROJECT NUMBER: 22-0345
PROJECT START DATE:

03/22/2022 FINALS START DATE: 07/07/2022

DRAWN BY: ARCH.
FINALS BY: LBS
CHECKED BY: 22-0345
REVISIONS:


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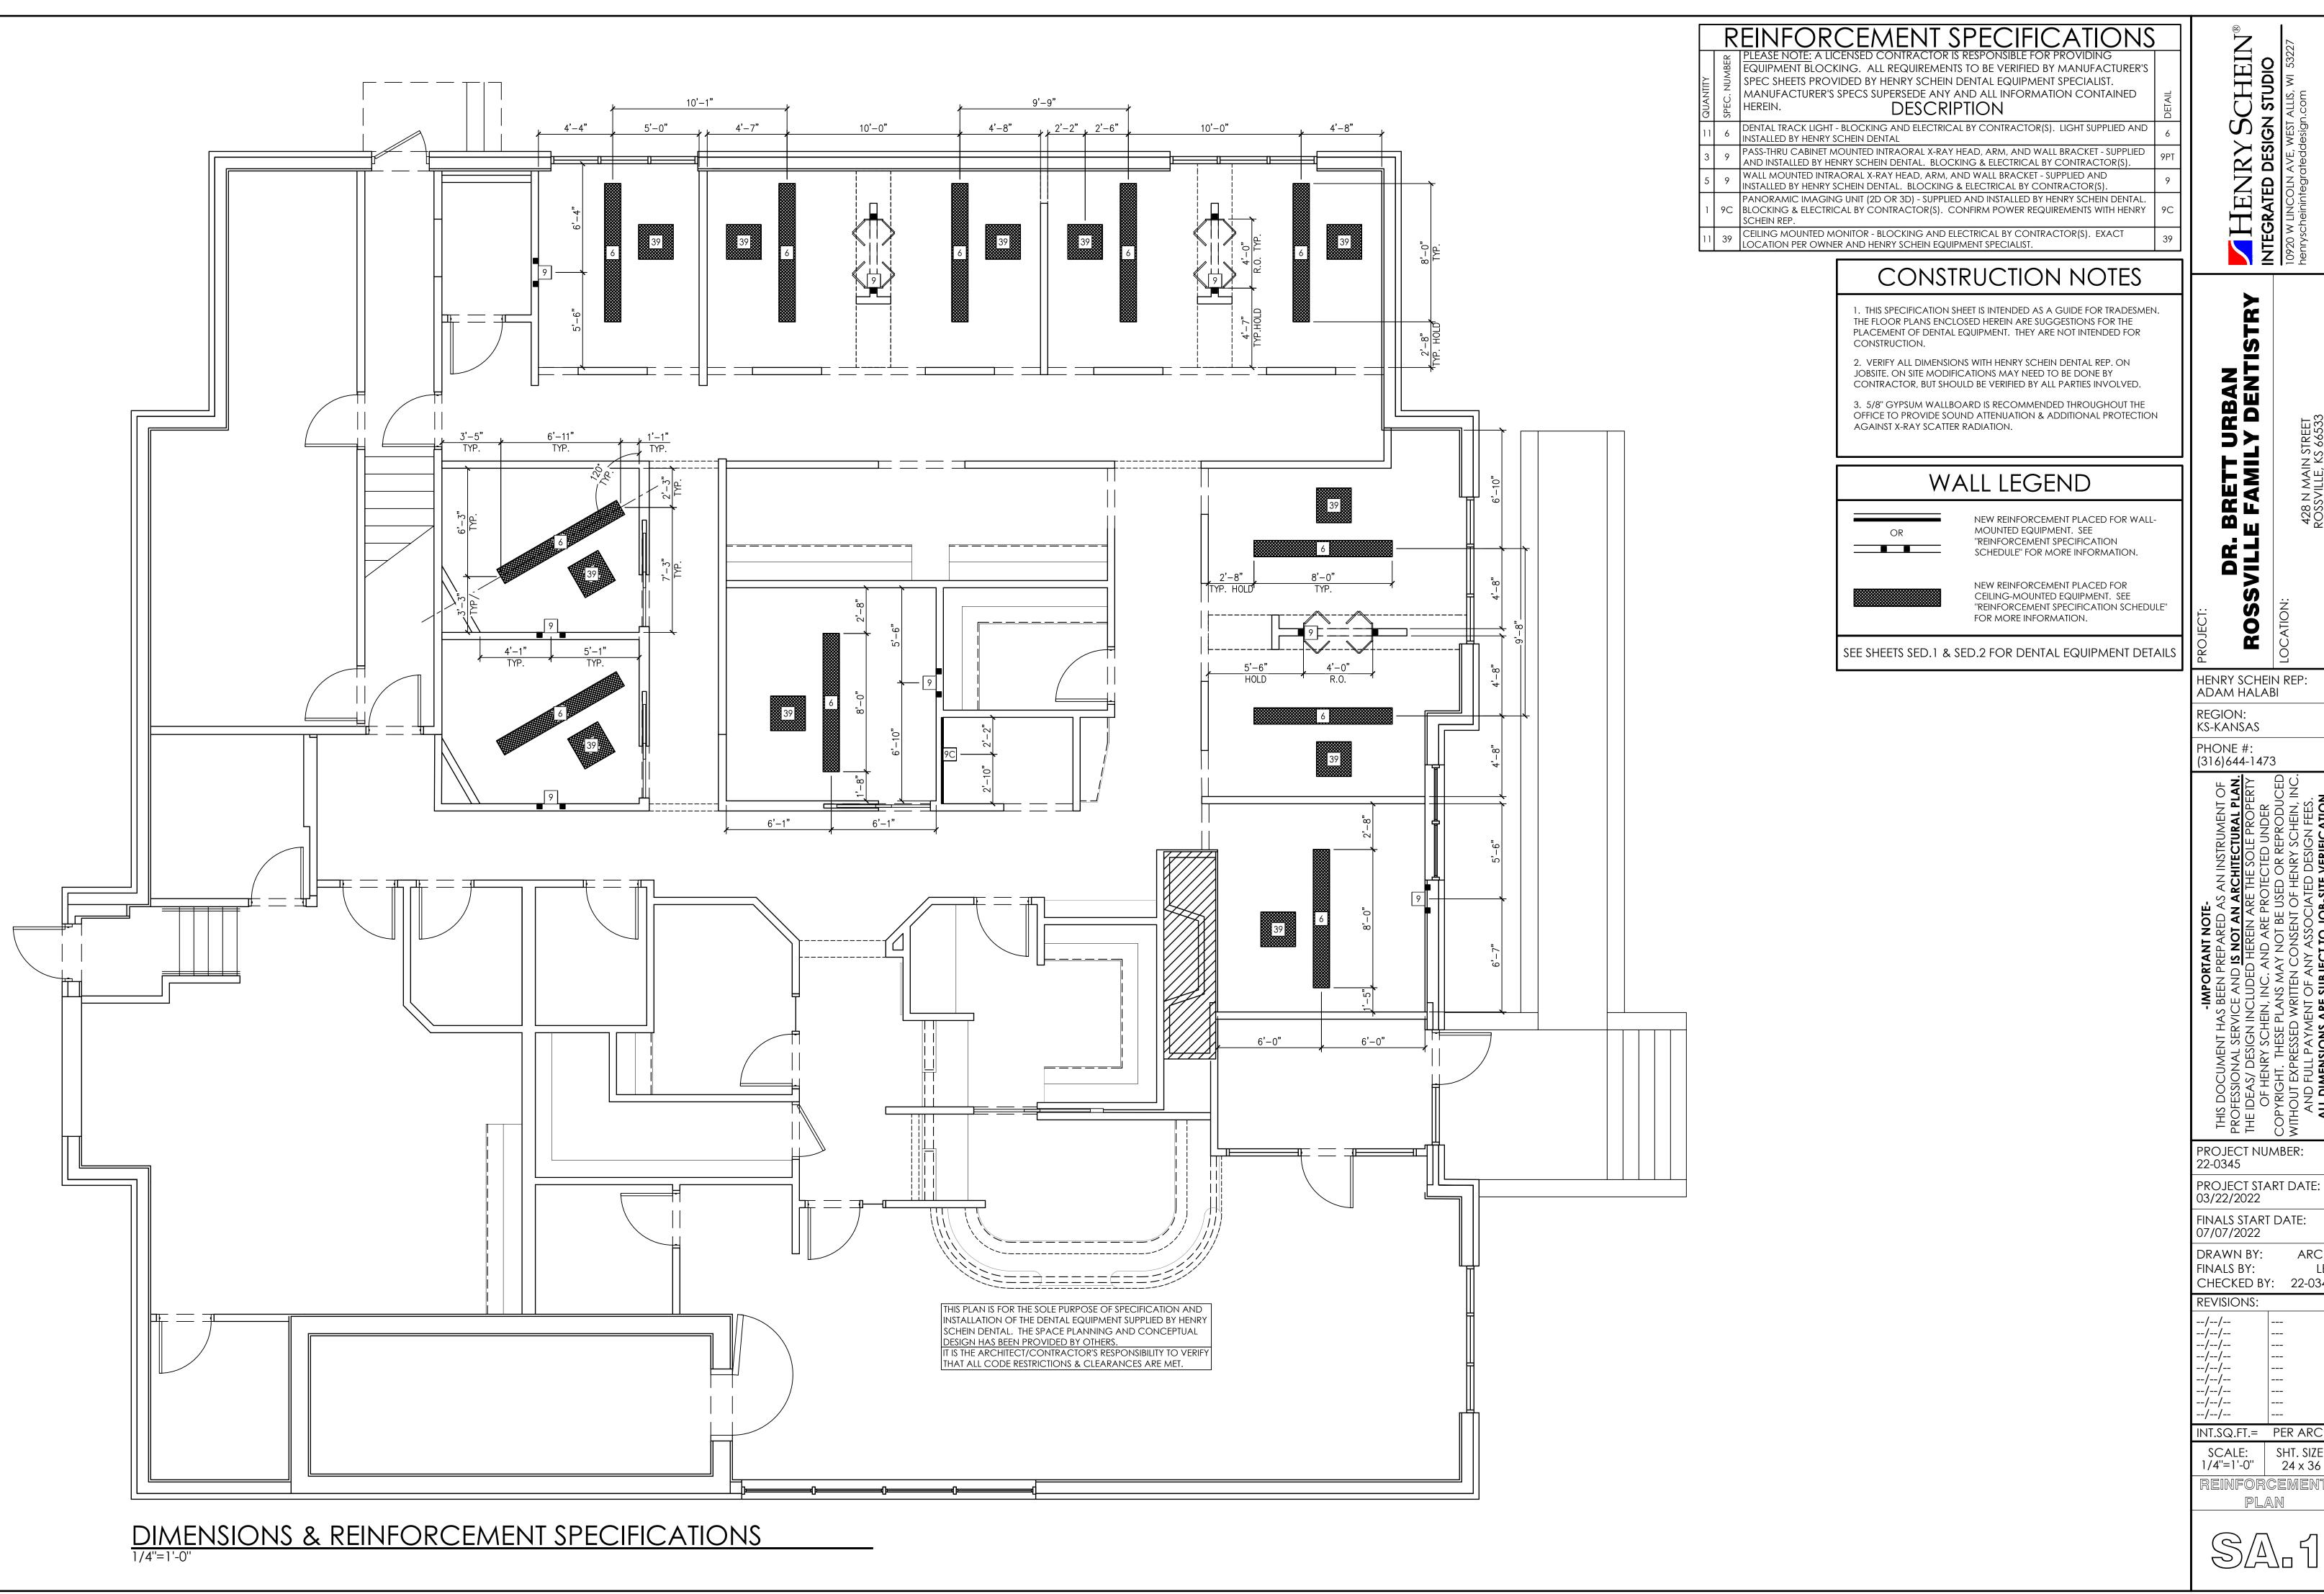
SCALE: SHT. SIZE: N/A 24 x 36

INT.SQ.FT.= PER ARCH

COVER SHEET





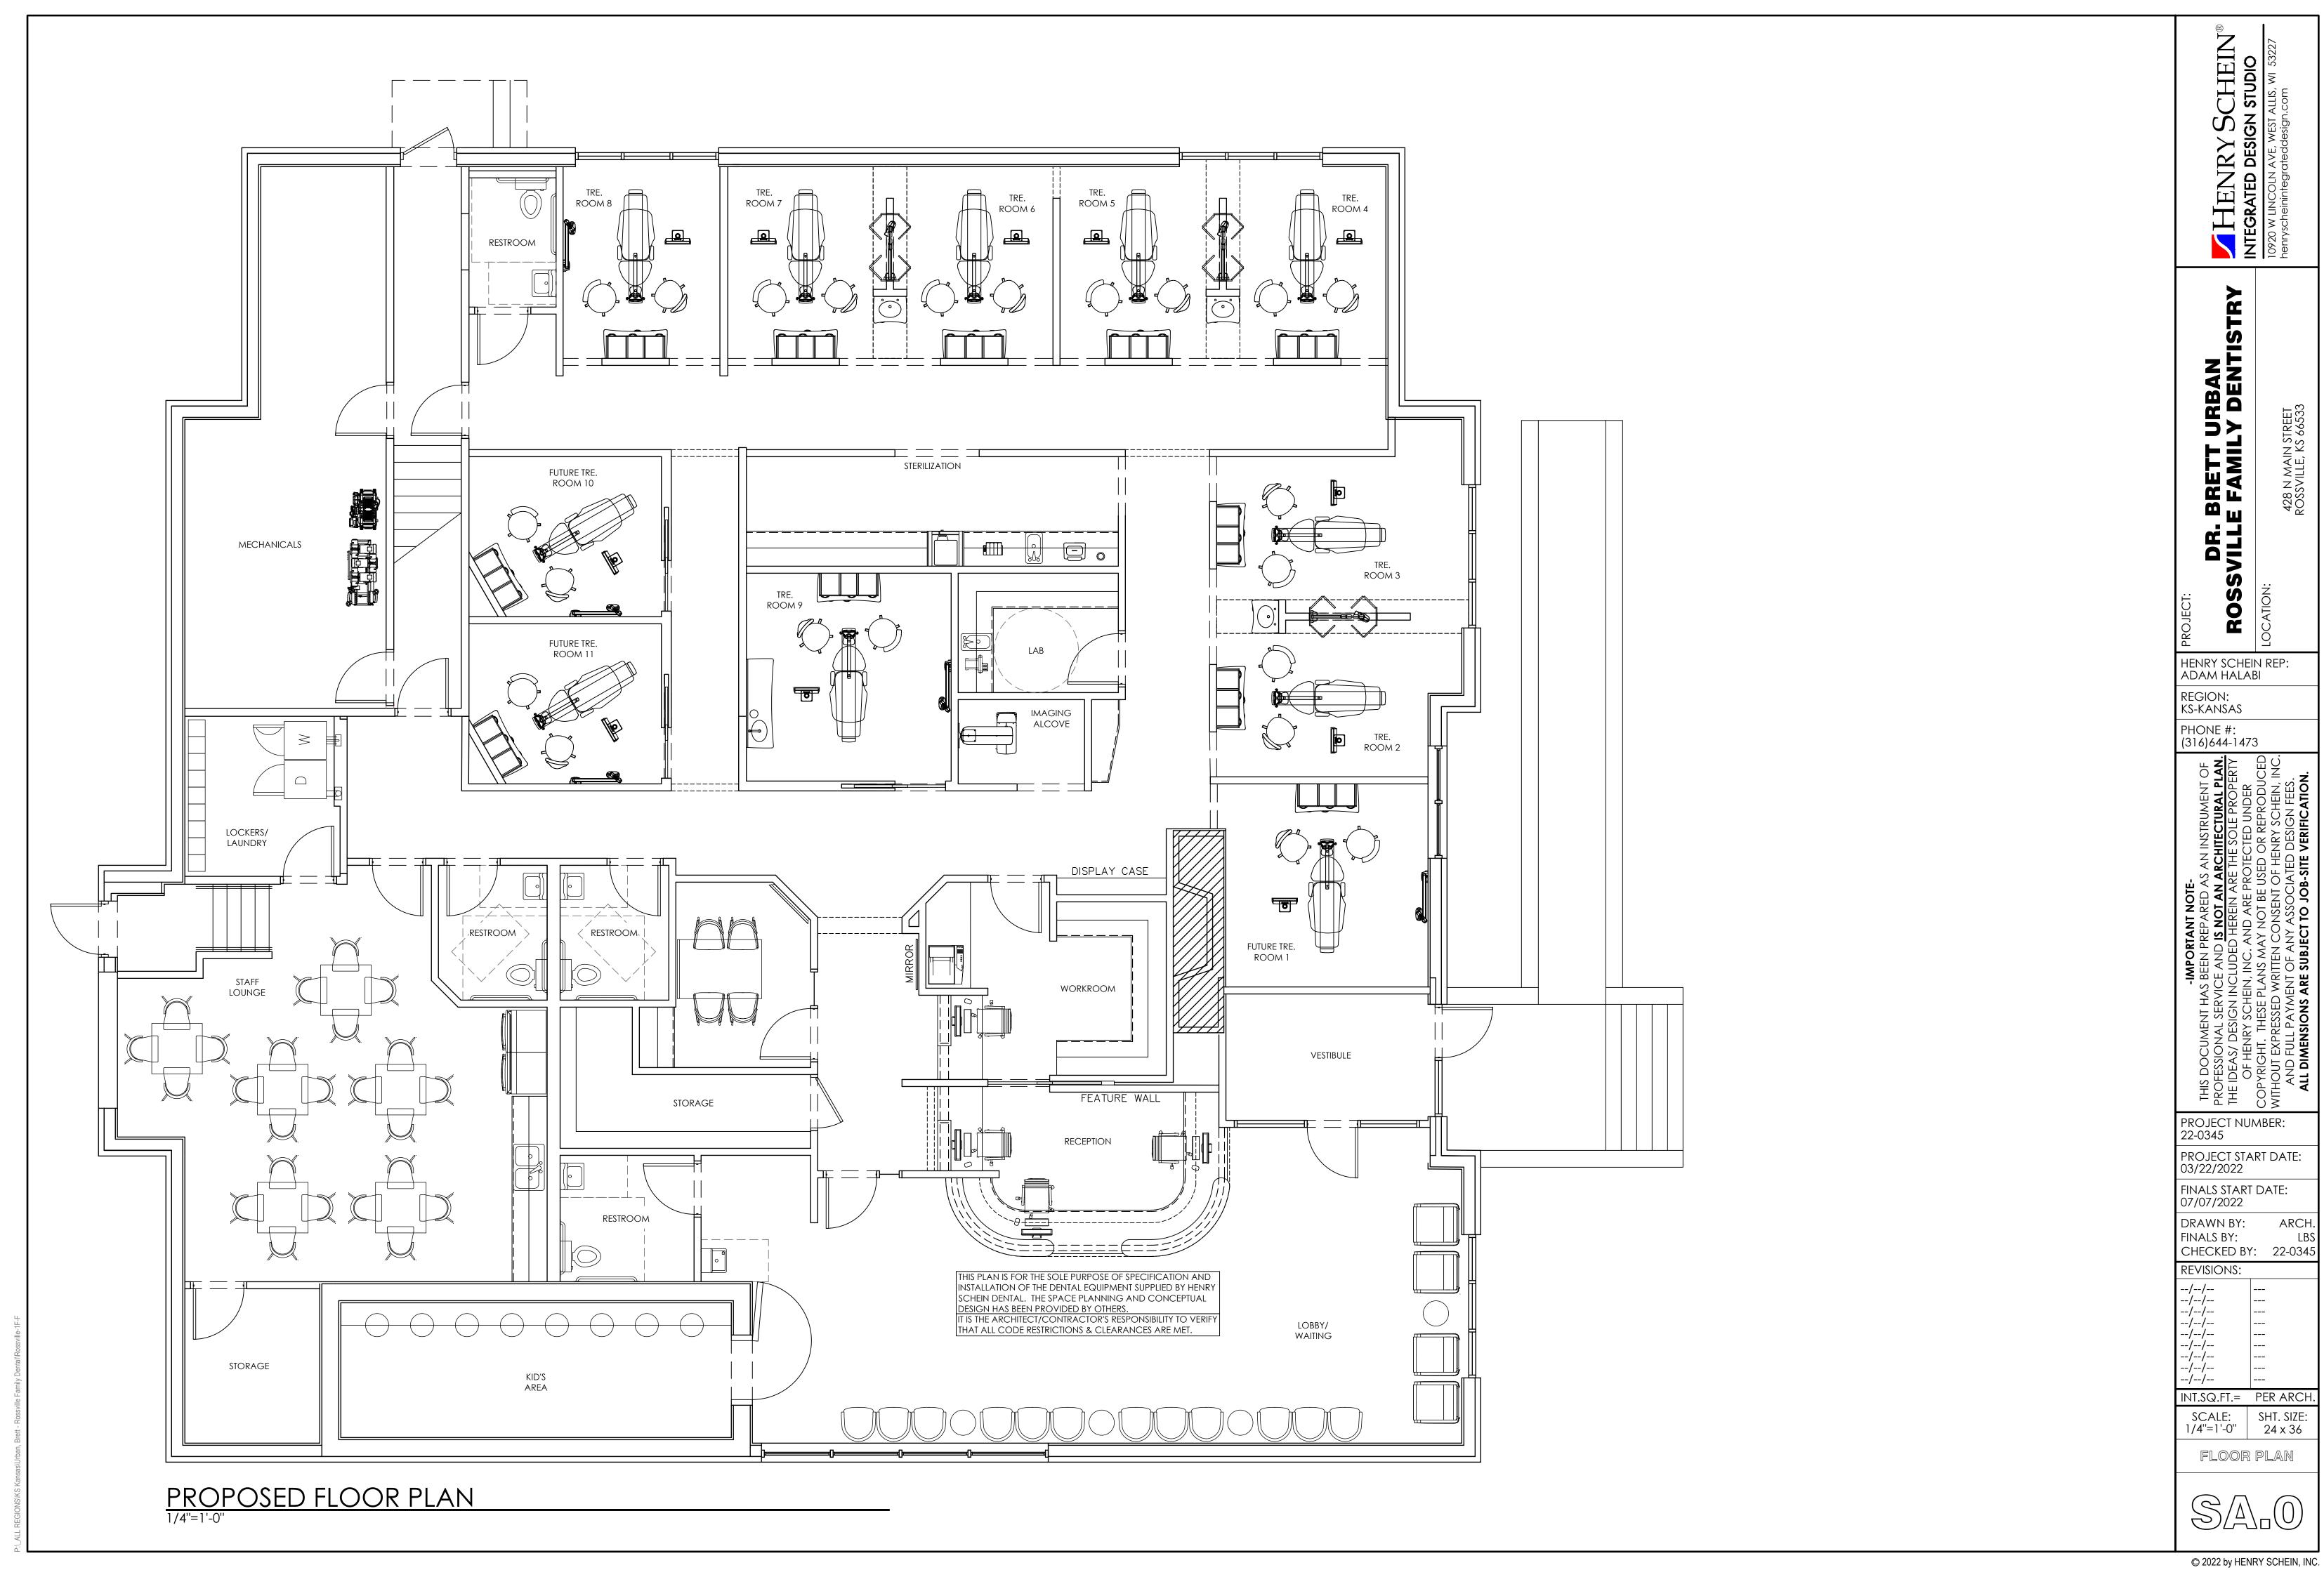

MTEGRATED DESIGN STUDIO

HENRY SCHEIN REP:

(316)644-1473


PROJECT NUMBER: 22-0345

FINALS START DATE: 07/07/2022

ARCH FINALS BY: CHECKED BY: 22-0345 REVISIONS:


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REINFORCEMENT PLAN

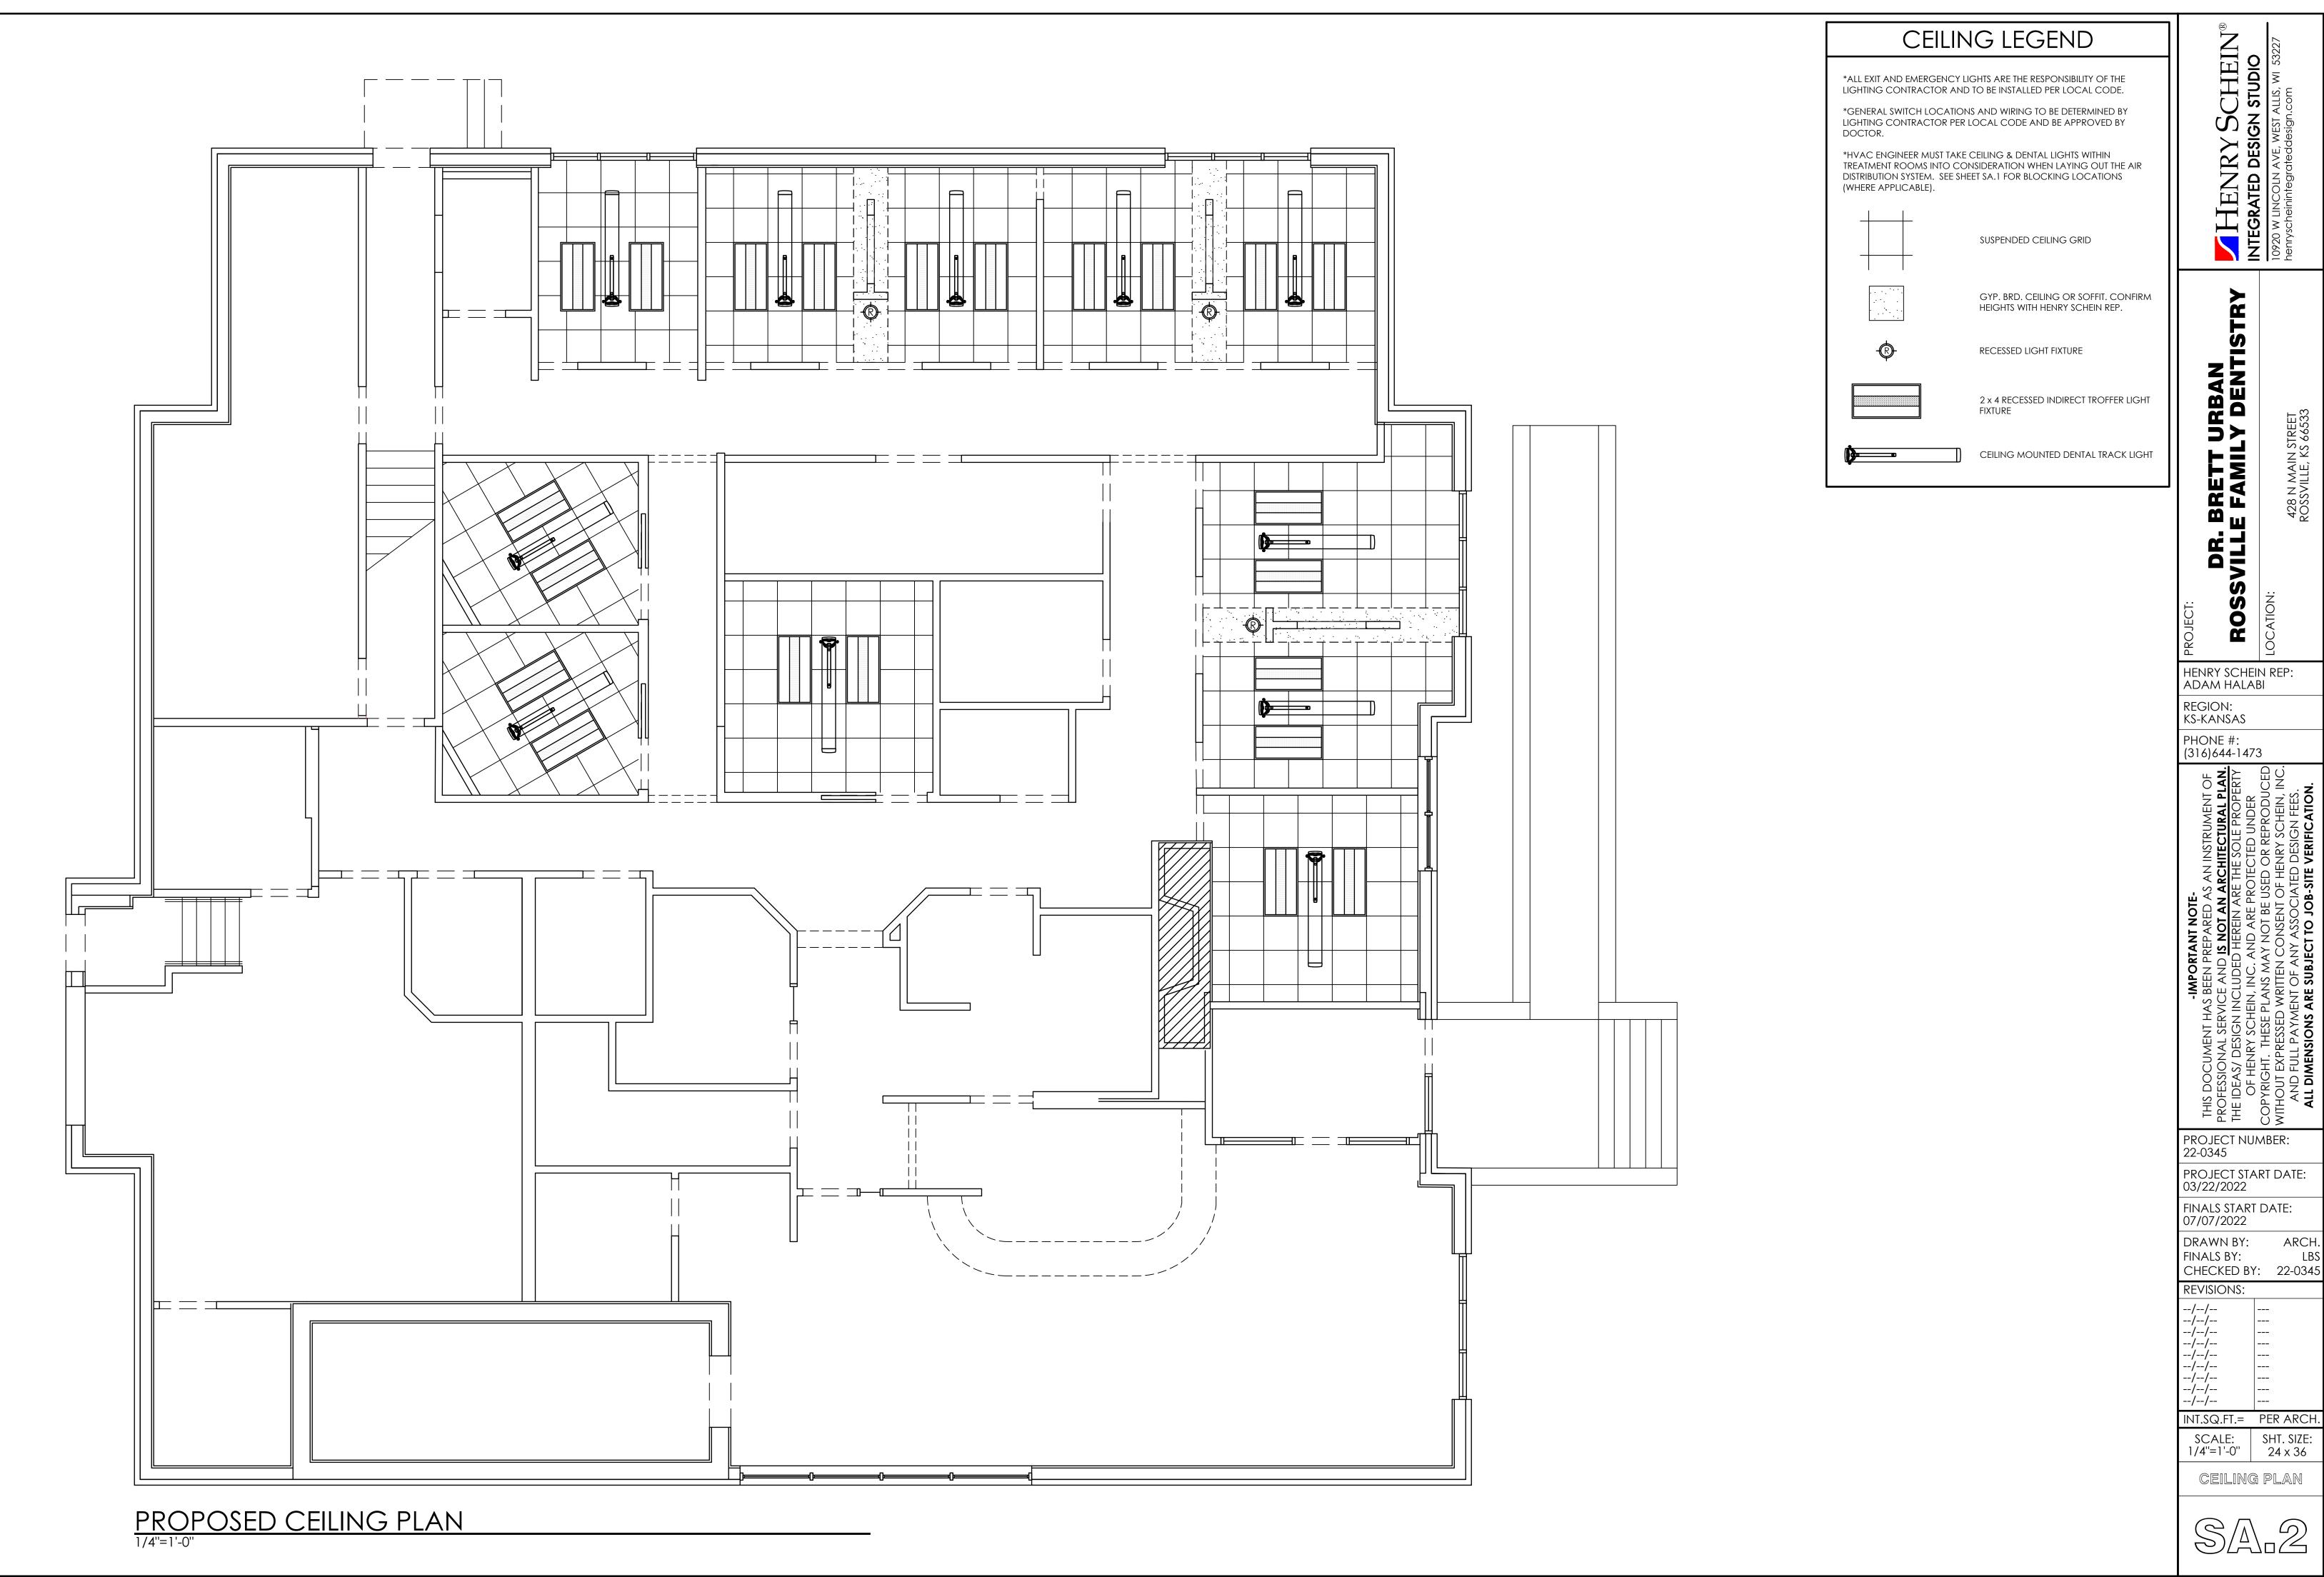


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ARCH.



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# PLUMBING SPECIFICATIONS PROVIDING ALL REQUIRED UTILITIES. ALL REQUIREMENTS TO BE VERIFIED BY MANUFACTURER'S SPEC SHEETS PROVIDED BY HENRY SCHEIN DENTAL EQUIPMENT SPECIALIST. MANUFACTURER'S SPECS SUPERSEDE ANY AND ALL INFORMATION CONTAINED HEREIN. DESCRIPTION 2A UTILITY CENTER - SELF-CONTAINED WATER. 3A UTILITY CENTER - SELF-CONTAINED WATER. MODULAR SINKS & FAUCETS - SINK AND FAUCET SUPPLIED BY HENRY SCHEIN DENTAL, INSTALLED BY PLUMBER. FINAL CONNECTIONS BY PLUMBER. EYEWASH STATION - VERIFY SUPPLIER, INSTALLED BY PLUMBER. VERIFY EXACT LOCATION WITH DOCTOR AND HENRY SCHEIN EQUIPMENT SPECIALIST. COMPRESSED AIR LINE AND VALVE – ½" AIR LINE FROM COMPRESSOR (25) BY PLUMBER. TERMINATE WITH A 3/8" ANGLE VALVE. ULTRASONIC CLEANER - UTILITIES BY CONTRACTOR(S). SUPPLIED AND INSTALLED BY HENRY HANDPIECE MAINTENANCE SYSTEM - CONTRACTOR(S) TO PROVIDE REQ'D UTILITIES. 1/2" AIR 15B LINE WITH 1/4" ANGLE VALVE (ABOVE COUNTERTOP). SYSTEM SUPPLIED AND INSTALLED BY HENRY SCHEIN DENTAL. MODEL TRIMMER - SUPPLIED AND INSTALLED BY HENRY SCHEIN DENTAL. DO NOT TIE INTO COLD WATER LINE FOR SINK. BACK FLOW PREVENTION AS REQUIRED PER CODE. SEE DETAIL. PLASTER TRAP - SUPPLIED BY HSD, INSTALLED BY PLUMBER ON SINK DRAIN LINE. DRAIN LINE DENTAL AIR COMPRESSOR - SUPPLIED BY HENRY SCHEIN DENTAL, INSTALLED BY CONTRACTOR(S). FOR DENTAL AIR DRIVEN DEVICES. PLUMBER TO PROVIDE 1/2" I.D. COPPER TYPE K OR L SUPPLY LINES TO LOCATIONS THAT REQUIRE AIR. BUCK BOOST TRANSFORMER SUPPLIED AND INSTALLED BY ELECTRICIAN (IF REQ'D). FINAL CONNECTIONS BY VACUUM PUMP (DRY) - SUPPLIED BY HENRY SCHEIN DENTAL, INSTALLED BY CONTRACTOR(S). VERIFY TRUNK & BRANCH LINE SIZES WITH MFR RECOMMENDATIONS. USE SCH 40 PVC WHERE PERMITTED BY CODE. PLUMBER TO EXHAUST PUMP TO OUTSIDE. BUCK BOOST TRANSFORMER SUPPLIED AND INSTALLED BY ELECTRICIAN (IF REQ'D). DRAIN BY PLUMBER. FINAL CONNECTIONS BY CONTRACTOR(S). PLUMBER TO PROVIDE WATER LINE WITH HOSE BIB NEAR VACUUM INLET - PLUMBER TO PROVIDE A 3/4" BRANCH LINE FROM VACUUM TRUNK LINE TO 28 LOCATION(S) SHOWN. TERMINATE WITH A 1/2" FPT FITTING AT FINISH. VERIFY TERMINATION, HEIGHT AND LOCATION WITH HENRY SCHEIN DENTAL EQUIPMENT SPECIALIST. AMALGAM SEPARATOR - SUPPLIED BY HENRY SCHEIN DENTAL, INSTALLED BY PLUMBER. VERIFY 29A LOCATION WITH HENRY SCHEIN DENTAL EQUIPMENT SPECIALIST. CONNECT TO VACUUM LINE COMING IN FROM TREATMENT ROOMS.
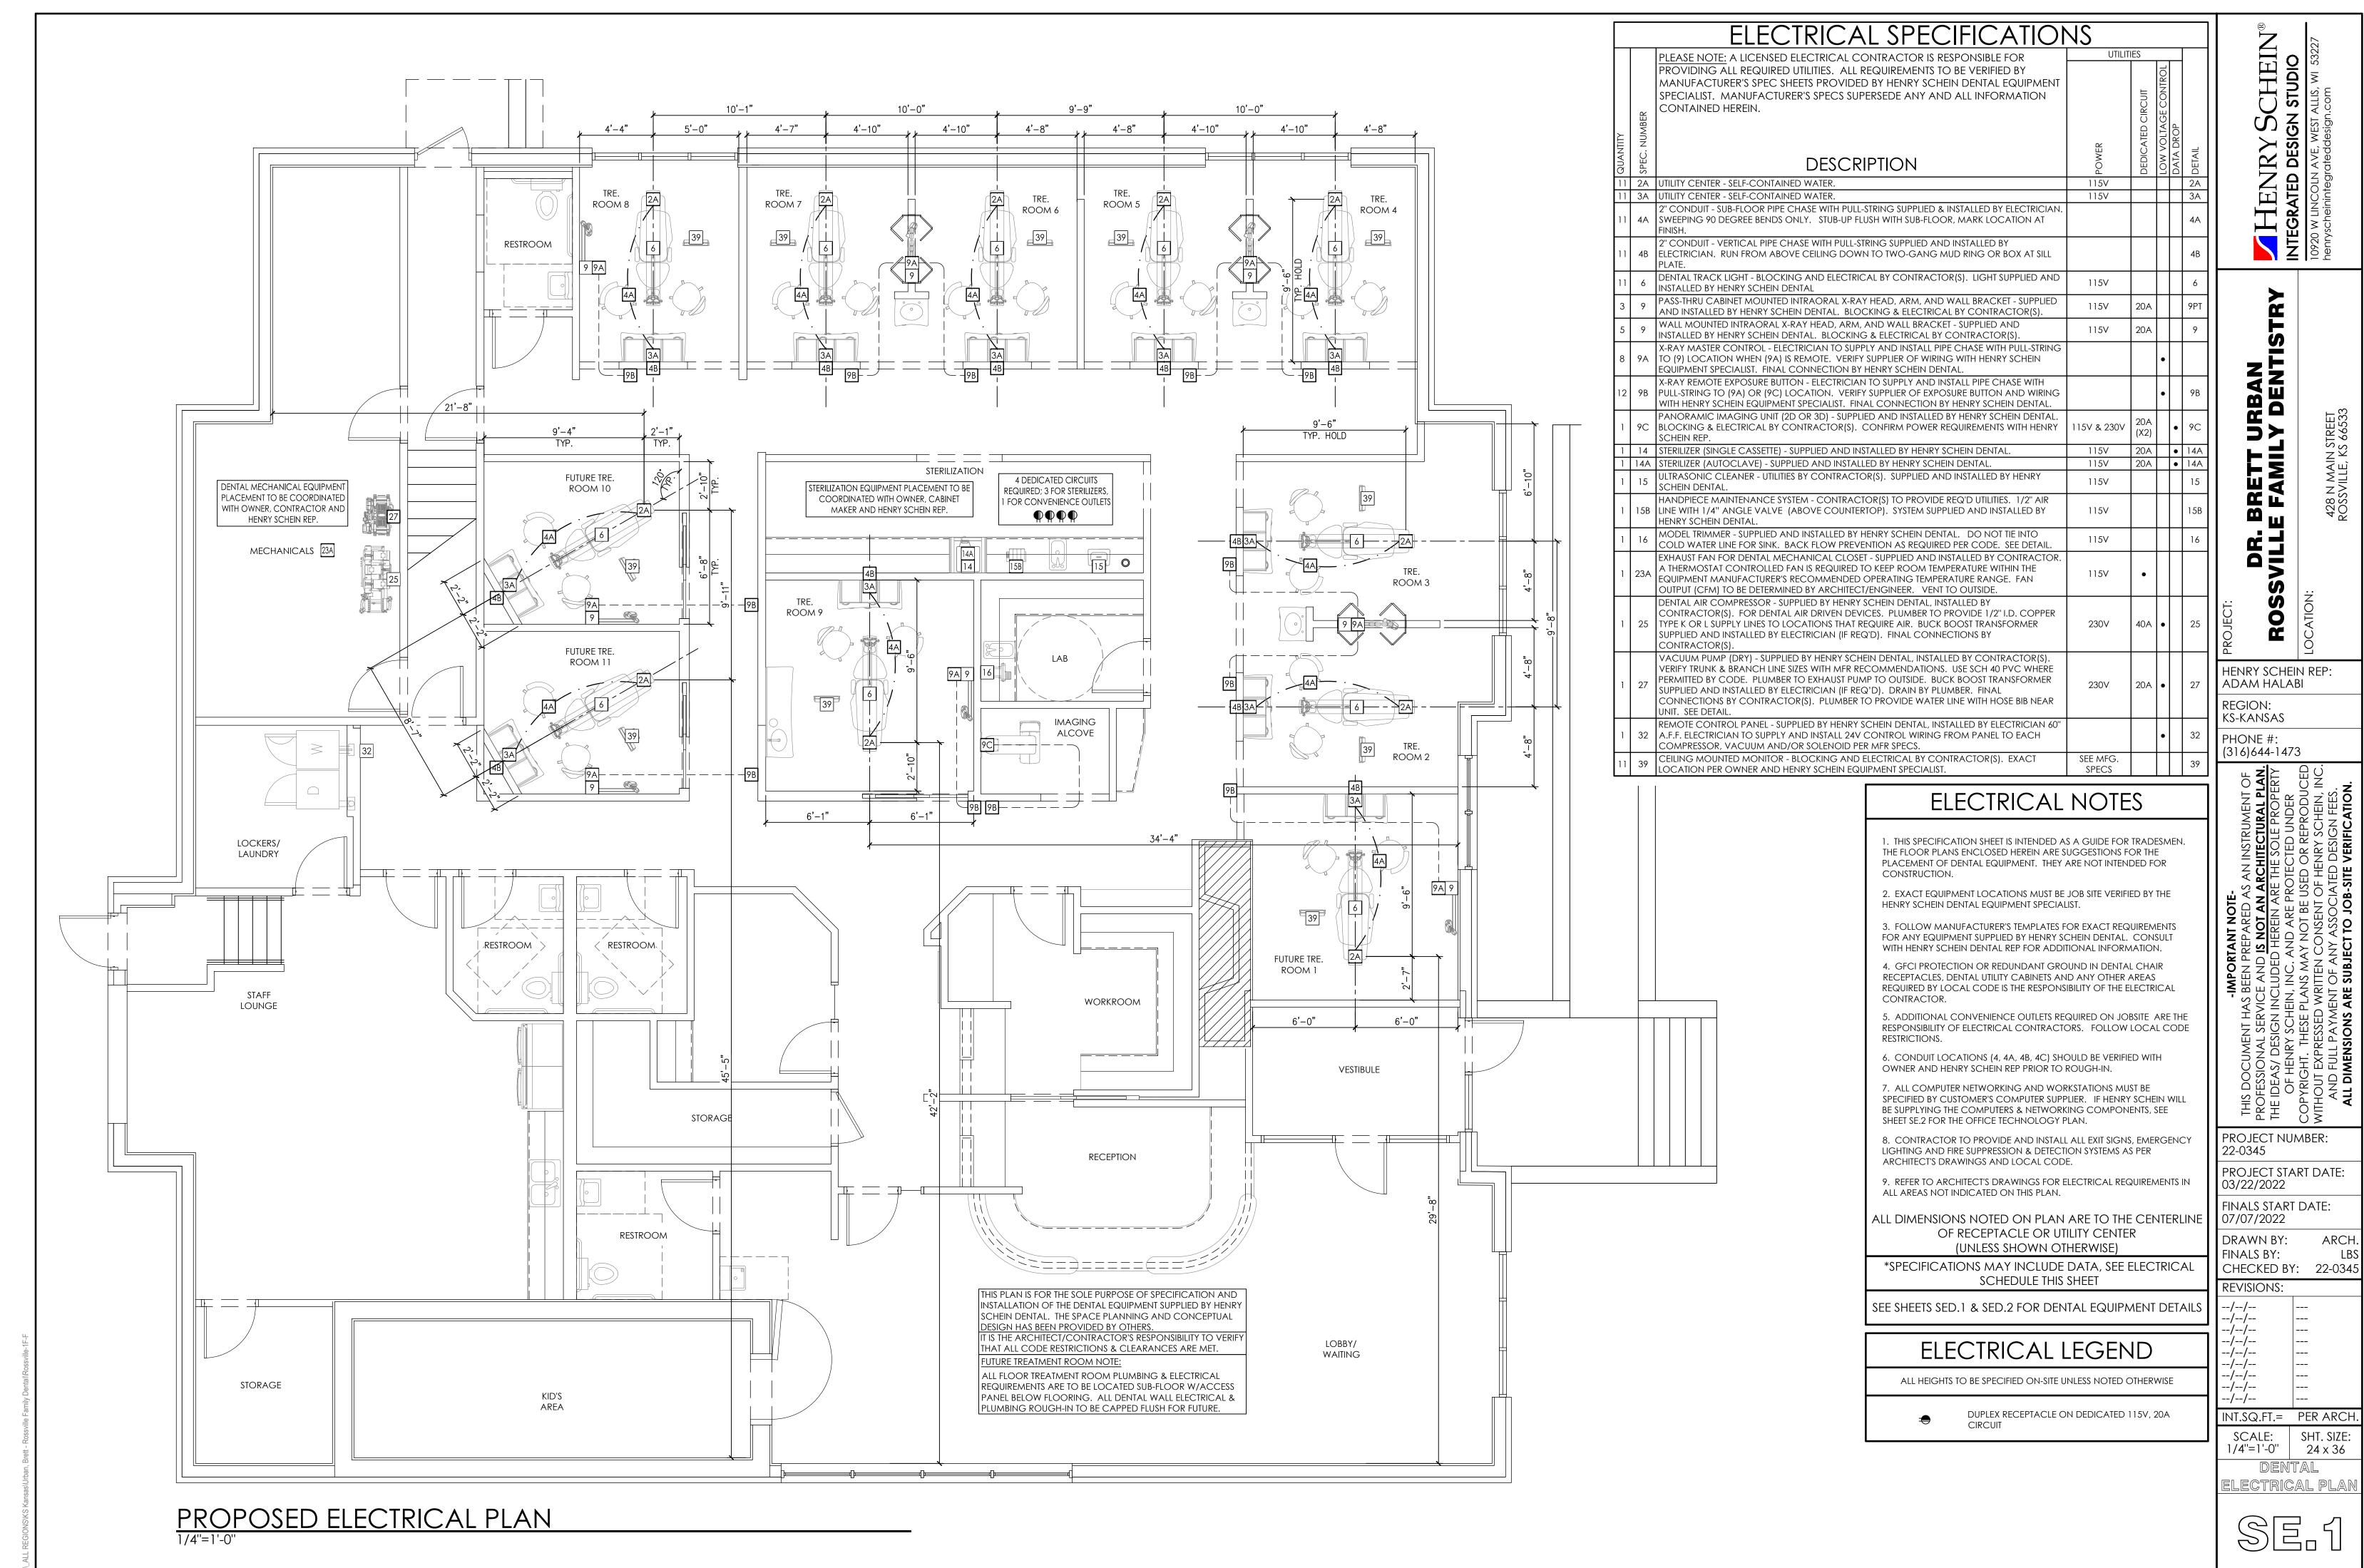
# **VACUUM NOTES**

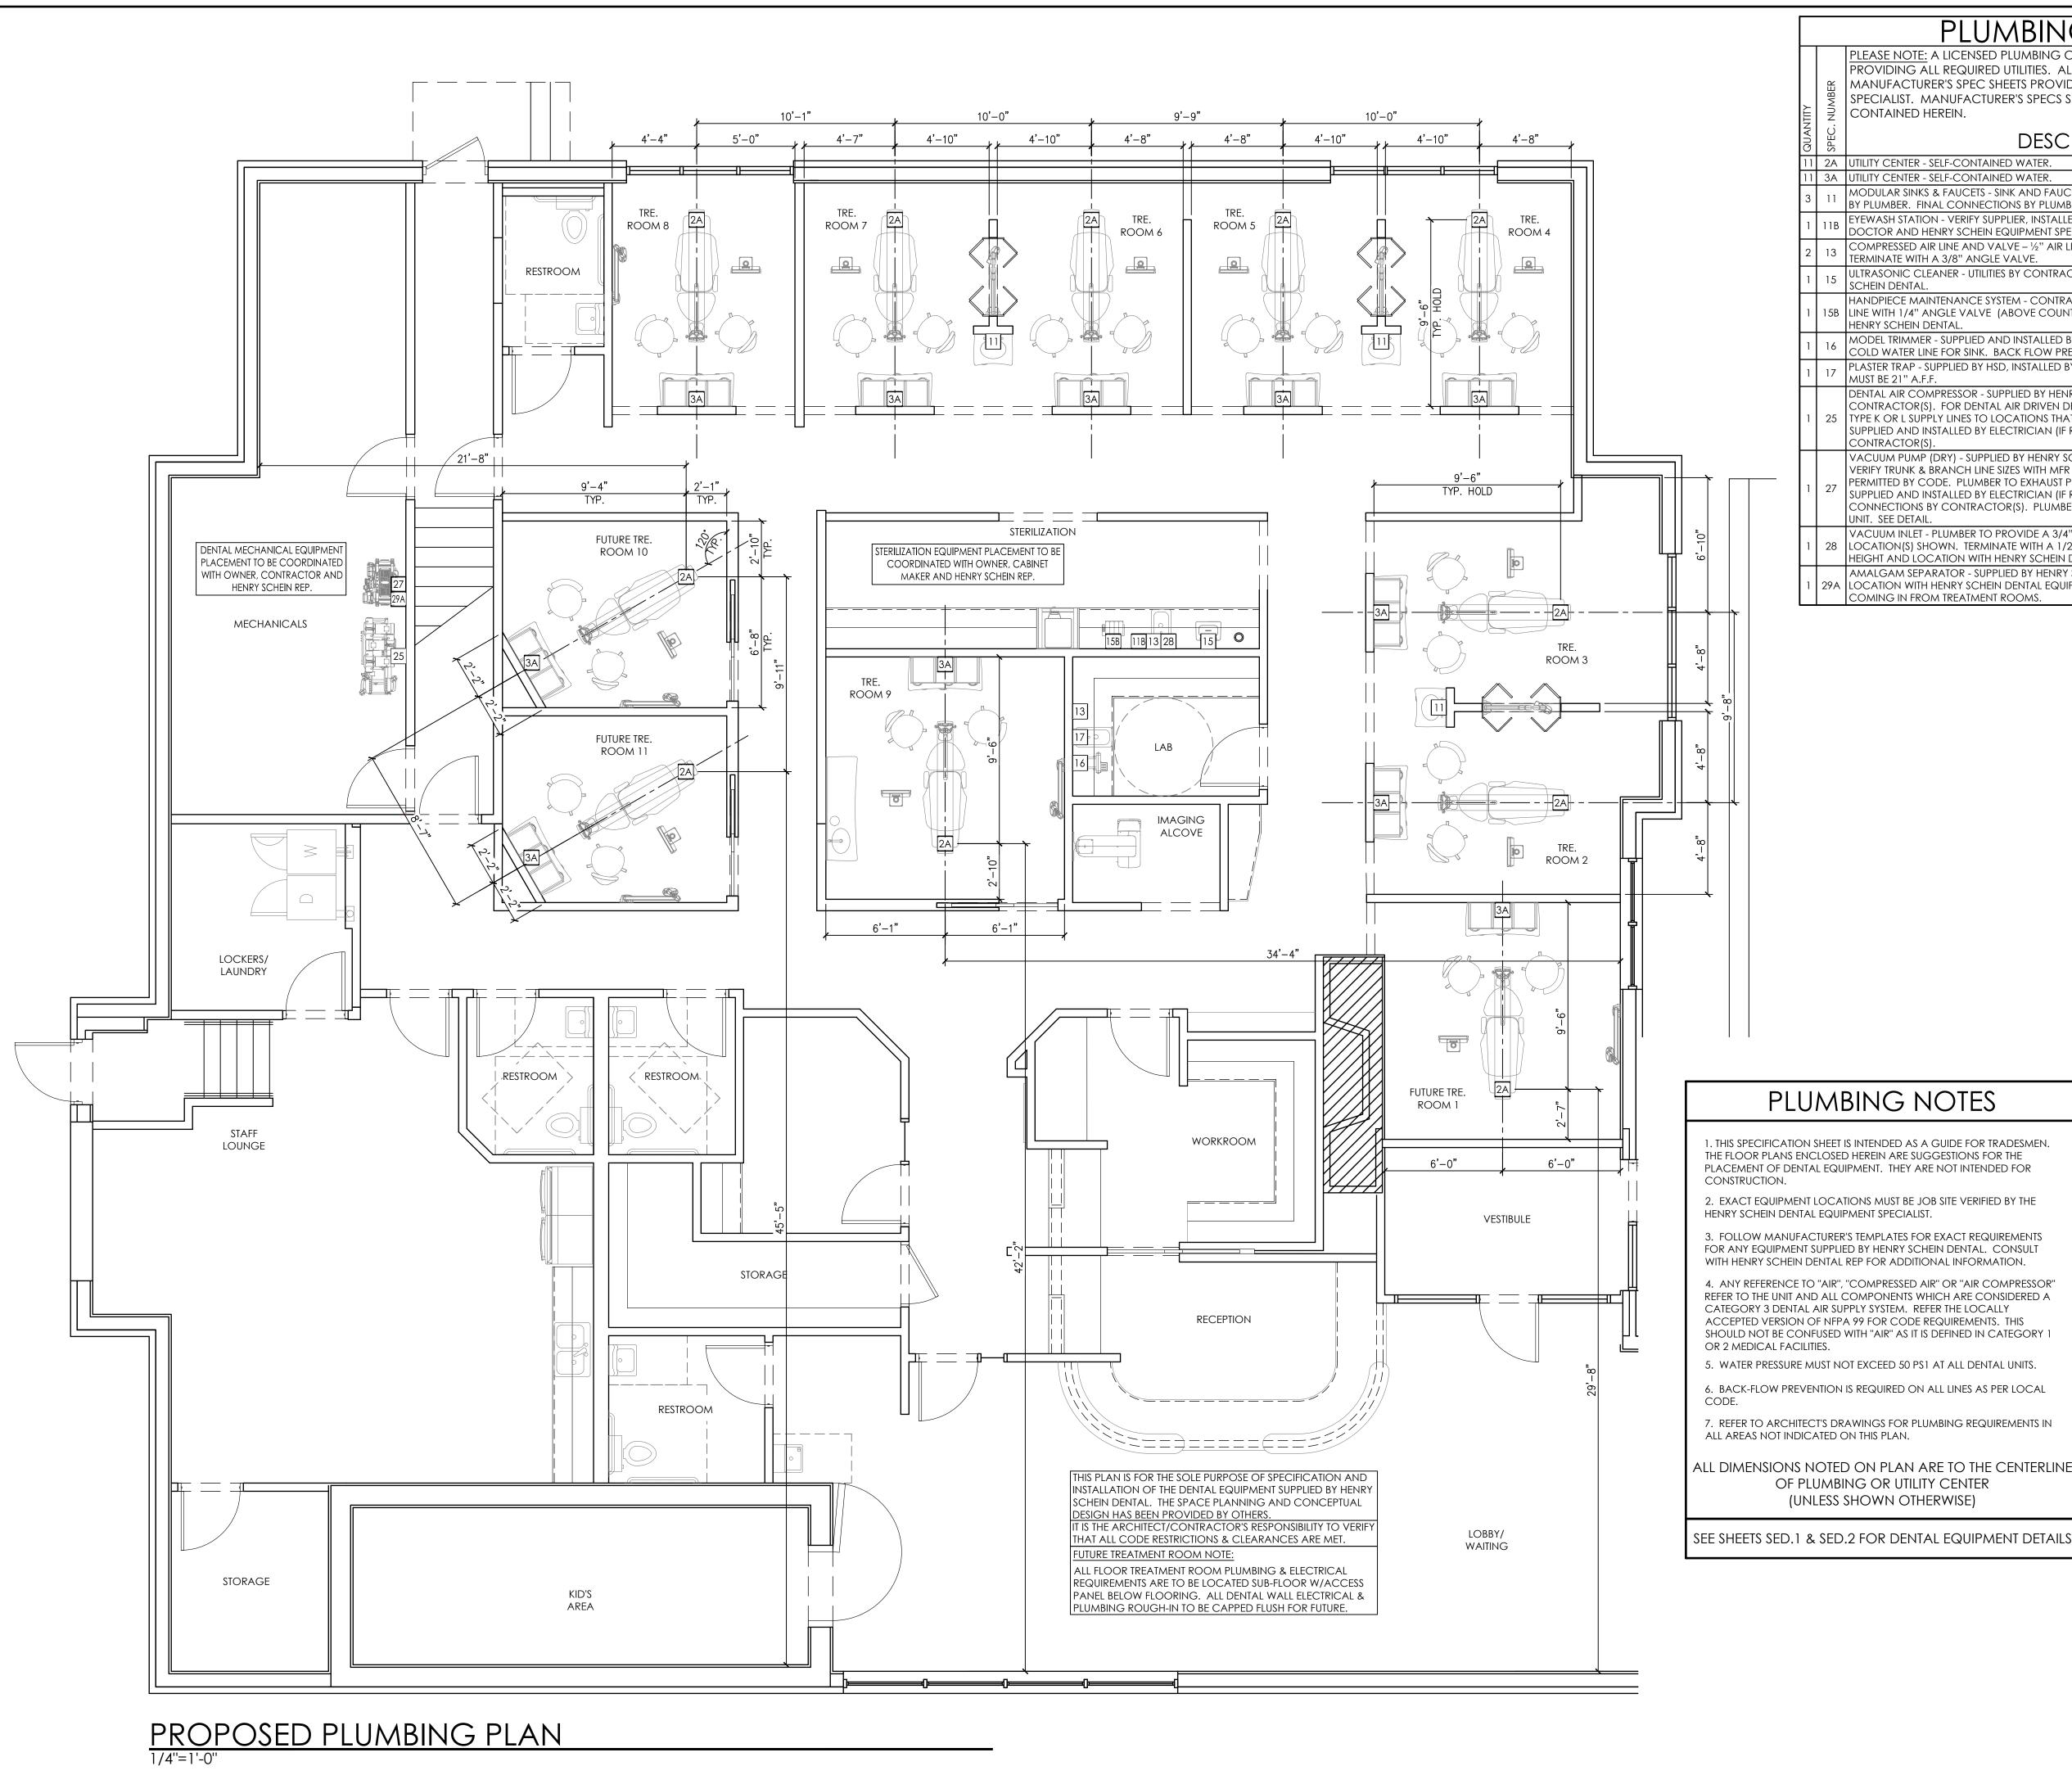THE VACUUM PIPING LAYOUT HAS A LARGE EFFECT ON THE EFFICIENCY AND RELIABILITY OF THE DENTAL VACUUM SYSTEM. REFER TO MANUFACTURER'S PRE-INSTALLATION GUIDE PROVIDED BY HENRY SCHEIN EQUIPMENT SPECIALIST FOR SPECIFIC SIZING OF STUB-UP, TRUNK, AND BRANCH LINES.

IT IS HIGHLY RECOMMENDED THAT VACUUM LINES RUN UNDERNEATH DENTAL EQUIPMENT BY MEANS OF TRENCHING/ CORING (CONCRETE SLAB) OR IN SUB FLOOR (BASEMENT/ CRAWL SPACE). ALL LINES ARE TO BE DESIGNED WITH PVC PIPING UNLESS DICTATED BY LOCAL CODES TO

TO ENSURE OPTIMUM VACUUM PERFORMANCE, INSTALL MAIN LINE DIRECTLY BELOW THE DENTAL CHAIR, CABINET OR WALL JUNCTION BOX TO REDUCE OR ELIMINATE BRANCH LINE RUNS WHEREVER POSSIBLE.

TERMINATE VACUUM TRUNK LINE IN MECHANICAL ROOM. PLUMBING CONTRACTOR TO PROVIDE FPT ADAPTOR ON END OF STUB-UP FROM FLOOR OR WALL. SIZE OF ADAPTOR TO BE DETERMINED BY TRUNK AND PUMP INTAKE PIPE SIZES. SEE DETAILS THIS SET & MANUFACTURER TEMPLATES PROVIDED BY HENRY SCHEIN EQUIPMENT REP. IN THE CASE OF DUAL TRUNK LINE SYSTEM, PROVIDE ENOUGH SPACE BETWEEN STUB-UPS TO INSTALL TEES ON BOTH LINES.

VACUUM TRUNK LINES(S) TO BE SUPPORTED EVERY 6'-0" TO PREVENT SAG AND SLOPED A MINIMUM OF 1/4" PER 10'-0" TOWARD THE

# 3. BRANCH LINE(S)

BRANCH LINES ARE TO HAVE "SWEEPING" 90 DEGREE TURNS TO AVOID VACUUM LOSS. A "WYE" FITTING SHOULD BE USED TO JOIN BRANCH



DO NOT PIPE TRUNK LINE IN A SERIES

MANNER LOOPING FROM J-BOX TO J-BOX. A CONTINUOUS TRUNK LINE MUST BE MAINTAINED FROM THE PUMP TO THE FURTHEST J-BOX USING BRANCH LINES OFF OF THE TRUNK LINE TO PICK UP EACH VACUUM OUTLET. TRUNK LINE MAY FOLLOW DRAIN LINE TRENCHES WITHIN REASON. USE ONLY 45 DEGREE EL'S. DO NOT USE ANY 90 DEGREE EL'S. ALL SUB FLOOR SCH 40 PVC CONNECTIONS ARE TO BE PLUMBED WITH 45 DEGREE EL'S

SPECIAL NOTE:

IF VACUUM LINES ENCROACH ON EITHER A WALL OR COLUMN FOOTING, USE 45 DEGREE ELBOWS TO PIPE AROUND FOOTING SO PIPE

USE COPPER OR CAST IRON.

VACUUM PUMP.

LINES TO THE TRUNK LINE.

USING DETAIL A FOR TEEING BRANCH LINE CONNECTIONS INTO TRUNK LINE.

REACHES PROPER LOCATION.

INT.SQ.FT.= PER ARCH SCALE: SHT. SIZE: 1/4"=1'-0" | 24 x 36 DENTAL PLUMBING

PROJECT NUMBER:

PROJECT START DATE:

FINALS START DATE:

CHECKED BY: 22-0345

ARCH

22-0345

03/22/2022

07/07/2022

DRAWN BY:

FINALS BY:

REVISIONS:

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PLAN

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