NOTE: ALL EXHAUST FANS AND AIR DEVICES THAT PENETRATE A CEILING ASSEMBLY SHALL BE PROVIDED WITH A U.L. LISTED RADIATION DAMPER, GREENHECK CRD OR EQUIVALENT.

1 FIRST FLOOR HVAC PLAN
1/8" = 1'-0"



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January 2024

### **#** MECHANICAL NOTES BY SYMBOL

1. PROVIDE UL LISTED DRYER BOX EQUAL TO IN-O-VATE TECHNOLOGIES IN WALL INSTALLED IN ACCORDANCE WITH MANUFACTURER'S RECOMMENDATIONS, AND ROUTE 4"Ø DRYER EXHAUST DUCT TO WALL CAP WITH BACKDRAFT DAMPER. MAXIMUM ALLOWABLE EQUIVALENT DUCT LENGTH = 35'. UTILIZE LONG RADIUS SMOOTH ELBOWS WHERE REQUIRED. MAXIMUM EQUIVALENT DUCT LENGTH MAY BE INCREASE WHERE DRYER MANUFACTURER'S INSTALLATION INSTRUCTIONS ALLOW, AND DOCUMENTATION IS PROVIDED TO CODE OFFICIAL PRIOR TO CONCEALMENT INSPECTION. COORDINATE EXACT REQUIREMENTS WITH EQUIPMENT PROVIDED. PROVIDE PERMANENT LABEL IDENTIFYING EQUIVALENT LENGTH OF DRYER DUCT INSTALLED PER IMC 504.

NOTE: ANNULAR SPACE AROUND DUCT IS TO BE SEALED AT ALL PENETRATIONS OF FLOORS AND CEILINGS WITH U.L. LISTED FIRE STOPPING SYSTEM.

- 2. PROVIDE UL LISTED DRYER BOX EQUAL TO IN-O-VATE TECHNOLOGIES IN WALL INSTALLED IN ACCORDANCE WITH MANUFACTURER'S RECOMMENDATIONS, AND ROUTE 4"Ø DRYER EXHAUST DUCT TO ROOF JACK WITH BACKDRAFT DAMPER. MAXIMUM ALLOWABLE EQUIVALENT DUCT LENGTH = 35'. UTILIZE LONG RADIUS SMOOTH ELBOWS WHERE REQUIRED. MAXIMUM EQUIVALENT DUCT LENGTH MAY BE INCREASE WHERE DRYER MANUFACTURER'S INSTALLATION INSTRUCTIONS ALLOW, AND DOCUMENTATION IS PROVIDED TO CODE OFFICIAL PRIOR TO CONCEALMENT INSPECTION. COORDINATE EXACT REQUIREMENTS WITH EQUIPMENT PROVIDED. PROVIDE PERMANENT LABEL IDENTIFYING EQUIVALENT LENGTH OF DRYER DUCT INSTALLED PER IMC 504.

  NOTE: ANNULAR SPACE AROUND DUCT IS TO BE SEALED AT ALL PENETRATIONS OF FLOORS AND CEILINGS WITH U.L. LISTED FIRE STOPPING SYSTEM.
- 3. ROUTE REFRIGERANT PIPING FROM BLOWER COIL TO MATCHING HEAT PUMP CONCEALED ABOVE CEILINGS AND IN WALLS . SEE M1.4 FOR HEAT PUMP LOCATIONS.
- 4. MOUNT TRANSFER GRILLE IN BEDROOM 6" BELOW CEILING AND MOUNT TRANSFER GRILLE ON OPPOSITE SIDE OF WALL 6" ABOVE FINISHED FLOOR. LINE STUD CAVITY WITH SHEET METAL.
- 5. PROVIDE AUXILIARY DRAIN PAN BELOW BLOWER COIL AND PIPE OVERFLOW DRAIN TO FLOOR DRAIN.6. ROUTE 4" EXHAUST UP IN WALL TO ROOF. DUCTS SHALL BE RUN IN WALLS CONTINUOUS FROM

EXHAUST FAN TO EXTERIOR OF BUILDING WITHOUT BEING COMBINED. COORDINATE EXACT


- ROUTING AND WALL LOCATIONS WITH G.C. AND EXISTING CONDITIONS.

  7. CONNECT OUTDOOR AIR DUCT TO RETURN DUCT AT BLOWER COIL AND BALANCE AS INDICATED
- ON PLANS.

  8. OUTDOOR AIR DUCT UP TO INTAKE HOOD ON ROOF, SEE ROOF PLAN ON M1.4 FOR MORE
- INFORMATION.
- 9. ROUTE 6"Ø OUTDOOR AIR INTAKE TO WALL CAP WITH BIRD SCREEN.
- 10. PROVIDE DRYER WALL CAP EQUAL TO INNOVATE TECHNOLOGIES 'DRYER WALL VENT' IN COLOR AS SELECTED BY ARCHITECT. COORDINATE EXACT MOUNTING HEIGHT AND LOCATION WITH ARCHITECT.
- 11. MOUNT DRYER MAKE-UP AIR GRILLE LOW IN WALL BEHIND DRYER.
- 12. ROUTE UP THROUGH ROOF AND TRANSITION TO CONNECTION AT INTAKE HOOD.
- 13. ROUTE CONDENSATE FROM INDOOR UNIT TO INDIRECT CONNECTION AT DRAIN BOX IN LAUNDRY CLOSET. COORDINATE WITH PLUMBING CONTRACTOR.
- 14. ROUTE REFRIGERANT PIPING CONCEALED IN WALLS AND ABOVE CEILING FROM INDOOR UNIT TO MATCHING HEAT PUMP UNIT ON ROOF. FIELD COORDINATE EXACT ROUTING WITH EXISTING CONDITIONS AND OTHER TRADES.
- 15. ROUTE CONDENSATE FROM INDOOR UNIT TO INDIRECT CONNECTION AT DRAIN BOX IN LAUNDRY CLOSET. COORDINATE WITH PLUMBING CONTRACTOR.
- 16. THERMOSTAT SHALL BE CONFIGURED TO PROVIDE A TEMPERATURE RANGE OR DEADBAND OF NOT LESS THAN 5°F BETWEEN CHANGEOVER FROM HEATING TO COOLING MODES.

NC

- ALL DUCTWORK SHALL BE SEALED PER 2021 IECC REQUIREMENTS. COORDINATE REQUIREMENTS WITH G.C.
- DUCTWORK AT SUPPLY, RETURN, AND TRANSFER AIR REGISTERS
- DUCTWORK AT SUPPLY, RETURN, AND TRANSFER AIR REGISTER SHALL BE SEALED TO FLOOR, WALL, OR CEILING USING HVAC TAPE.

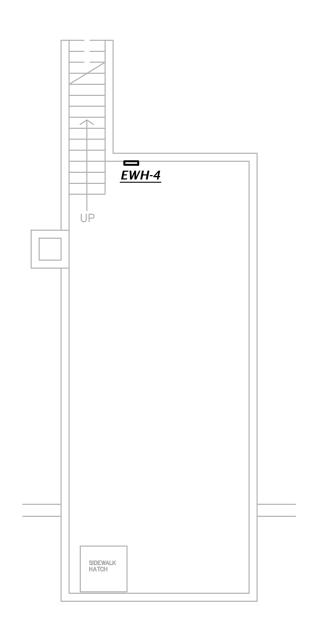

BASEMENT HVAC PLAN

1/8" = 1'-0"



>

M1.1

1-16-2024 21-3166

1-16-2024


1 Addendum #2 02-20-2024

**REVISION:** 

SHEET NO .:

730 N. Salina, 785.82

HISTORIC REHABILITATION - APARTMENTS
TEXA

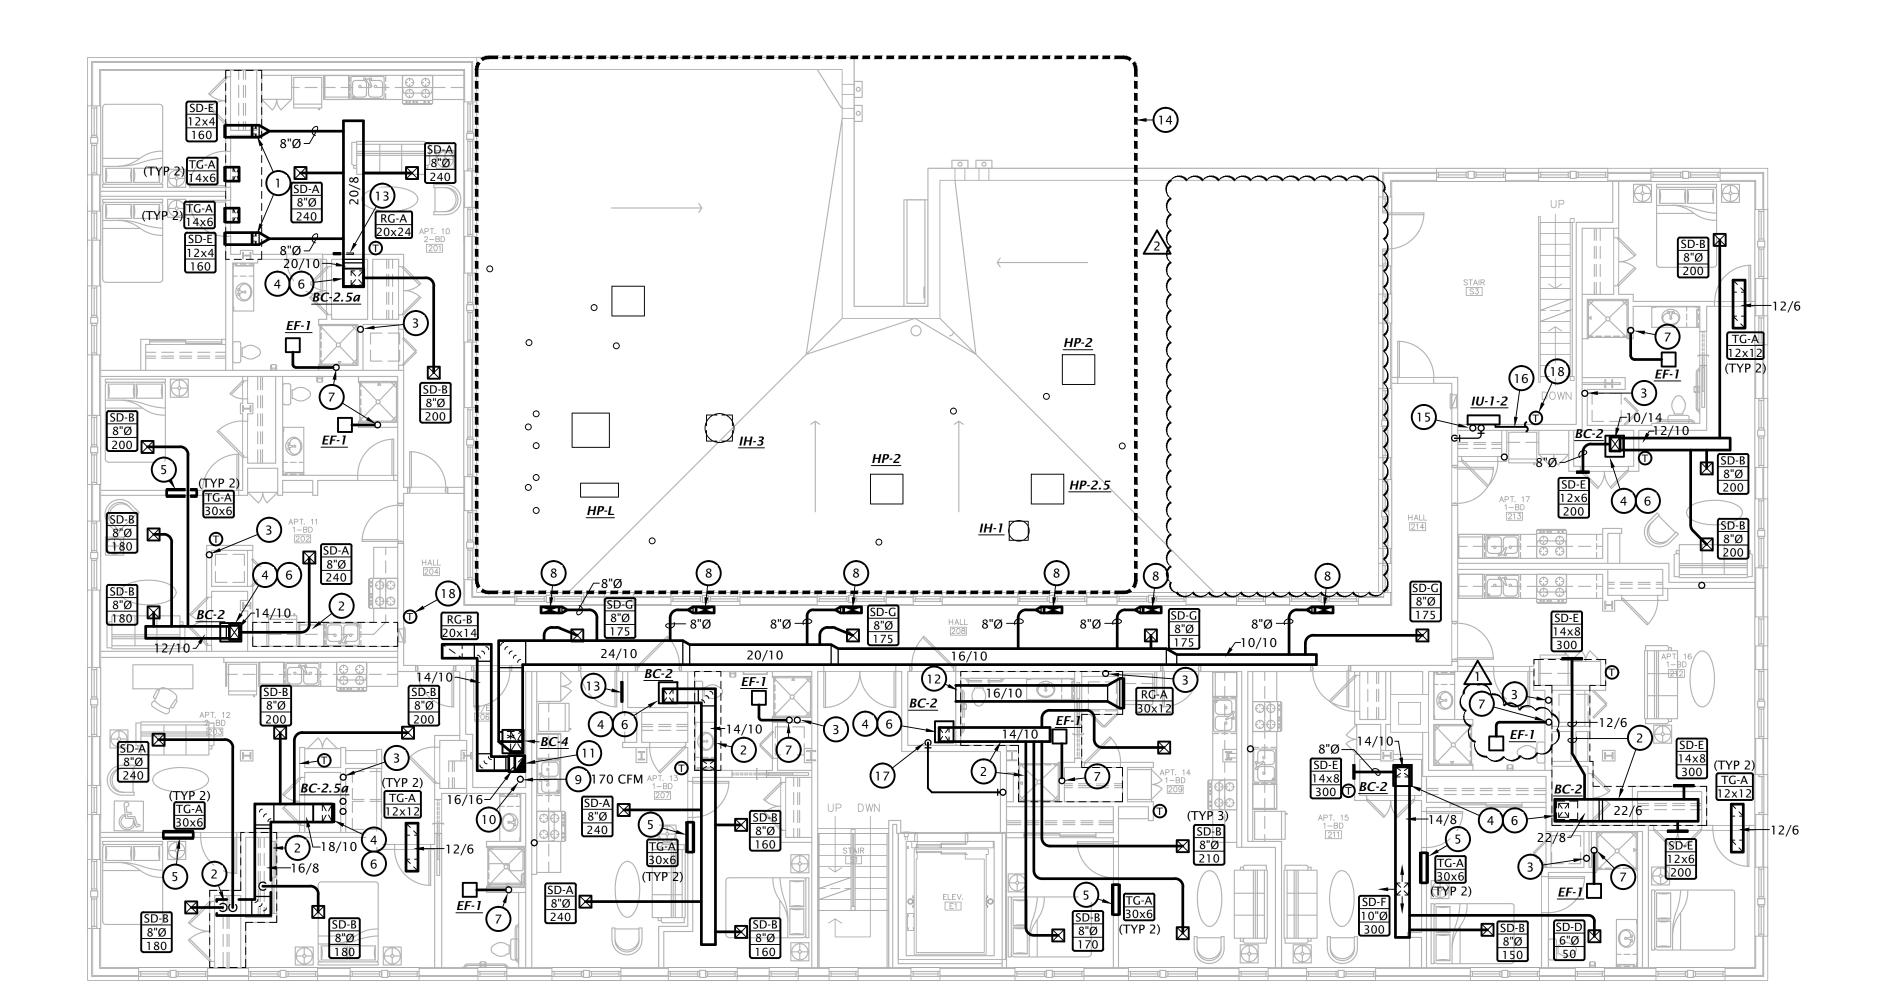

NOTE: ALL EXHAUST FANS AND AIR DEVICES THAT PENETRATE A CEILING ASSEMBLY SHALL BE PROVIDED WITH A U.L. LISTED RADIATION DAMPER, GREENHECK CRD OR EQUIIVALENT.

1 SECOND FLOOR HVAC PLAN

1/8" = 1'-0"



January 2024

### **#** MECHANICAL NOTES BY SYMBOL

ARCHITECT.

- 3. PROVIDE UL LISTED DRYER BOX EQUAL TO IN-O-VATE TECHNOLOGIES IN WALL INSTALLED IN ACCORDANCE WITH MANUFACTURER'S RECOMMENDATIONS, AND ROUTE 4"Ø DRYER EXHAUST DUCT TO ROOF JACK WITH BACKDRAFT DAMPER. MAXIMUM ALLOWABLE EQUIVALENT DUCT LENGTH = 35'. COORDINATE EXACT REQUIREMENTS WITH EQUIPMENT PROVIDED. PROVIDE PERMANENT LABEL IDENTIFYING EQUIVALENT LENGTH OF DRYER DUCT INSTALLED PER IMC 504. NOTE: ANNULAR SPACE AROUND DUCT IS TO BE SEALED AT ALL PENETRATIONS OF FLOORS AND CEILINGS WITH U.L. LISTED FIRE STOPPING SYSTEM.
- 4. ROUTE REFRIGERANT PIPING FROM BLOWER COIL TO MATCHING HEAT PUMP CONCEALED ABOVE CEILINGS AND IN WALLS . SEE M1.4 FOR HEAT PUMP LOCATIONS.
- 6. PROVIDE AUXILIARY DRAIN PAN BELOW BLOWER COIL AND PIPE OVERFLOW DRAIN TO FLOOR DRAIN.
- ROUTING AND WALL LOCATIONS WITH G.C. AND EXISTING CONDITIONS.
- 8. ROUTE DUCTWORK UP TO SUPPLY GRILLE AT FLOOR ABOVE.
- 9. CONNECT OUTDOOR AIR DUCT TO RETURN DUCT AT BLOWER COIL AND BALANCE AS INDICATED
- 10. 8"Ø OUTDOOR AIR DUCT FROM FLOOR ABOVE, SEE M1.3 FOR CONTINUATION. 11. TRANSITION TO 16/10 RETURN DUCT AND ROUTE UP TO 3RD FLOOR, SEE M1.3 FOR
- TRANSITION TO WALL MOUNTED RETURN GRILLE IN APARTMENT.
- 14. SEE ROOF PLAN ON M1.4 FOR MORE INFORMATION.
- MATCHING HEAT PUMP UNIT ON ROOF. FIELD COORDINATE EXACT ROUTING WITH EXISTING CONDITIONS AND OTHER TRADES.
- 16. ROUTE CONDENSATE PIPING FROM INDOOR UNIT CONCEALED IN WALL TO FLOOR DRAIN IN
- 18. THERMOSTAT SHALL BE CONFIGURED TO PROVIDE A TEMPERATURE RANGE OR DEADBAND OF NOT

- REQUIREMENTS. COORDINATE REQUIREMENTS WITH G.C.
- DUCTWORK AT SUPPLY, RETURN, AND TRANSFER AIR REGISTERS SHALL BE SEALED TO FLOOR, WALL, OR CEILING USING HVAC

1. TRANSITION FROM 8"Ø TO 12/4 DUCT AND ROUTE BELOW BEAM IN SOFFIT. INSTALL DUCT AS HIGH AS POSSIBLE TO BEAM. COORDINATE EXACT ROUTING AND SOFFIT LOCATION WITH G.C. AND

- 2. DUCT TO BE ROUTED IN SOFFIT, INSTALL AS HIGH AS POSSIBLE TO STRUCTURE. COORDINATE EXACT ROUTING AND SOFFIT LOCATION WITH G.C. AND ARCHITECT.
- 5. MOUNT TRANSFER GRILLE IN BEDROOM 6" BELOW CEILING AND MOUNT TRANSFER GRILLE ON OPPOSITE SIDE OF WALL 6" ABOVE FINISHED FLOOR. LINE STUD CAVITY WITH SHEET METAL.
- 7. ROUTE 4" EXHAUST UP IN WALL TO ROOF. DUCTS SHALL BE RUN IN WALLS CONTINUOUS FROM EXHAUST FAN TO EXTERIOR OF BUILDING WITHOUT BEING COMBINED. COORDINATE EXACT

- 12. ROUTE OPEN ENDED TRANSFER DUCT FROM MECHANICAL CLOSET THROUGH LOWERED CEILING,
- 13. MOUNT RETURN GRILLE LOW IN WALL.
- 15. ROUTE REFRIGERANT PIPING CONCEALED IN WALLS AND ABOVE CEILING FROM INDOOR UNIT TO
- MECHANICAL CLOSET. FIELD COORDINATE ROUTING WITH OTHER TRADES.
- 17. ROUTE CONDENSATE PIPING FORM INDOOR UNIT ABOVE CONCEALED ABOVE CEILING TO FLOOR DRAIN IN MECHANICAL CLOSET. FIELD COORDINATE EXACT ROUTING WITH EXISTING CONDITIONS AND OTHER TRADES.
- LESS THAN 5°F BETWEEN CHANGEOVER FROM HEATING TO COOLING MODES.


- ALL DUCTWORK SHALL BE SEALED PER 2021 IECC

1-16-2024

1-16-2024 21-3166 SHEET NO .:

M1.2

2\ASI #3 05-08-2024

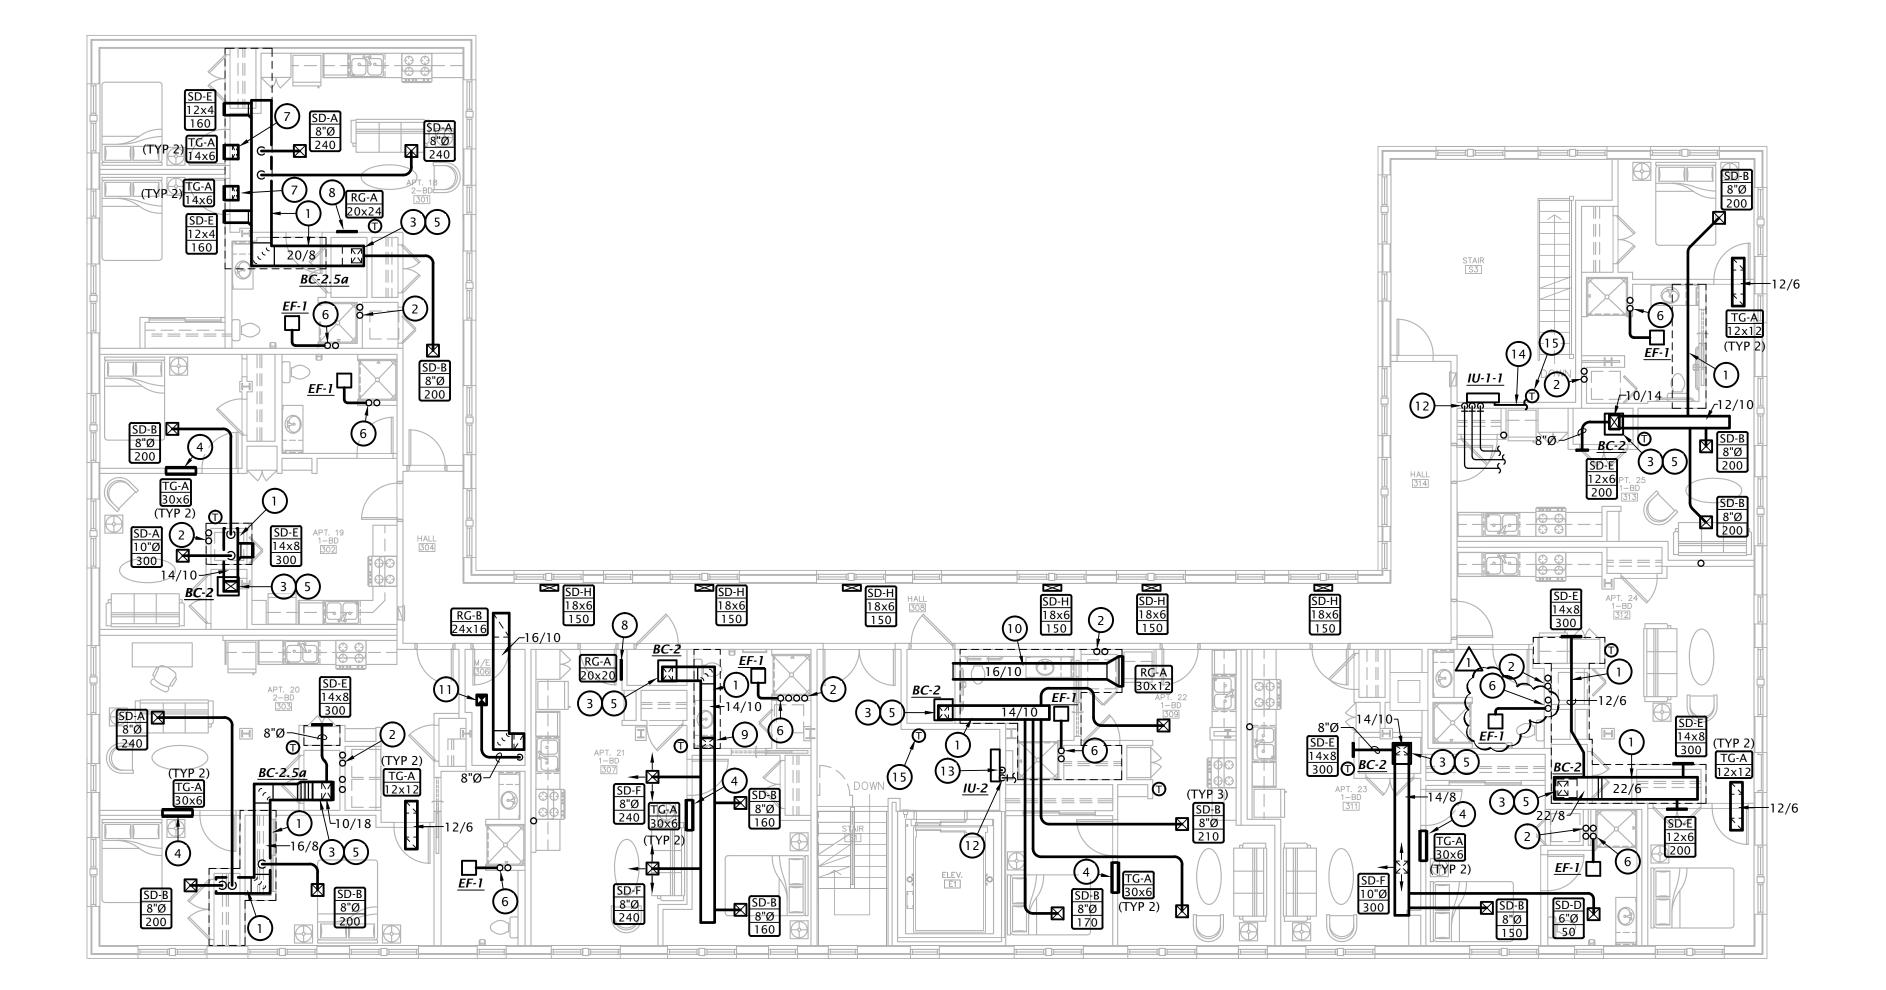

NOTE: ALL EXHAUST FANS AND AIR DEVICES THAT PENETRATE A CEILING ASSEMBLY SHALL BE PROVIDED WITH A U.L. LISTED RADIATION DAMPER, GREENHECK CRD OR EQUIIVALENT.



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January 2024

## **#** MECHANICAL NOTES BY SYMBOL

- 1. DUCT TO BE ROUTED IN LOWERED CEILING/ SOFFIT, INSTALL AS HIGH AS POSSIBLE TO STRUCTURE. COORDINATE EXACT ROUTING AND SOFFIT LOCATION WITH G.C. AND ARCHITECT.
- DUCT TO ROOF JACK WITH BACKDRAFT DAMPER. MAXIMUM ALLOWABLE EQUIVALENT DUCT LENGTH = 35'. COORDINATE EXACT REQUIREMENTS WITH EQUIPMENT PROVIDED. PROVIDE CEILINGS WITH U.L. LISTED FIRE STOPPING SYSTEM.

- 6. ROUTE 4" EXHAUST UP IN WALL TO ROOF. DUCTS SHALL BE RUN IN WALLS CONTINUOUS FROM EXHAUST FAN TO EXTERIOR OF BUILDING WITHOUT BEING COMBINED. COORDINATE EXACT
- 7. MOUNT TRANSFER GRILLE IN BEDROOM WALL AND DUCT TO GRILLE IN SOFFIT.
- 8. MOUNT RETURN GRILLE LOW IN WALL.
- 9. ROUTE DUCT BELOW BEAM IN SOFFIT, TRANSITION UP TO ABOVE BEDROOM CEILING.
- 10. ROUTE OPEN ENDED TRANSFER DUCT FROM MECHANICAL CLOSET THROUGH LOWERED CEILING, TRANSITION TO WALL MOUNTED RETURN GRILLE IN APARTMENT.
- 11. OUTDOOR AIR DUCT UP TO INTAKE HOOD ON ROOF, SEE ROOF PLAN ON M1.4 FOR MORE
- 13. ROUTE CONDENSATE PIPING FROM INDOOR UNIT DOWN CONCEALED IN WALL AND ROUTE TO ABOVE FLOOR DRAIN IN MECHANICAL ROOM AT FLOOR BELOW.
- MECHANICAL CLOSET. FIELD COORDINATE ROUTING WITH OTHER TRADES.
- 15. THERMOSTAT SHALL BE CONFIGURED TO PROVIDE A TEMPERATURE RANGE OR DEADBAND OF NOT LESS THAN 5°F BETWEEN CHANGEOVER FROM HEATING TO COOLING MODES.

- ALL DUCTWORK SHALL BE SEALED PER 2021 IECC REQUIREMENTS. COORDINATE REQUIREMENTS WITH G.C.
- DUCTWORK AT SUPPLY, RETURN, AND TRANSFER AIR REGISTERS SHALL BE SEALED TO FLOOR, WALL, OR CEILING USING HVAC

- 2. PROVIDE UL LISTED DRYER BOX EQUAL TO IN-O-VATE TECHNOLOGIES IN WALL INSTALLED IN ACCORDANCE WITH MANUFACTURER'S RECOMMENDATIONS, AND ROUTE 4"Ø DRYER EXHAUST PERMANENT LABEL IDENTIFYING EQUIVALENT LENGTH OF DRYER DUCT INSTALLED PER IMC 504. NOTE: ANNULAR SPACE AROUND DUCT IS TO BE SEALED AT ALL PENETRATIONS OF FLOORS AND
- 3. ROUTE REFRIGERANT PIPING FROM BLOWER COIL TO MATCHING HEAT PUMP CONCEALED ABOVE CEILINGS AND IN WALLS . SEE M1.4 FOR HEAT PUMP LOCATIONS.
- 4. MOUNT TRANSFER GRILLE IN BEDROOM 6" BELOW CEILING AND MOUNT TRANSFER GRILLE ON OPPOSITE SIDE OF WALL 6" ABOVE FINISHED FLOOR. LINE STUD CAVITY WITH SHEET METAL.
- 5. PROVIDE AUXILIARY DRAIN PAN BELOW BLOWER COIL AND PIPE OVERFLOW DRAIN TO FLOOR DRAIN.
- ROUTING AND WALL LOCATIONS WITH G.C. AND EXISTING CONDITIONS.

- INFORMATION.
- 12. ROUTE REFRIGERANT PIPING CONCEALED IN WALLS AND ABOVE CEILING FROM INDOOR UNIT TO MATCHING HEAT PUMP UNIT ON ROOF. FIELD COORDINATE EXACT ROUTING WITH EXISTING CONDITIONS AND OTHER TRADES.
- 14. ROUTE CONDENSATE PIPING FROM INDOOR UNIT CONCEALED IN WALL TO FLOOR DRAIN IN


1-16-2024

1 Addendum #2 02-20-2024

1-16-2024 21-3166 SHEET NO .:

M1.3



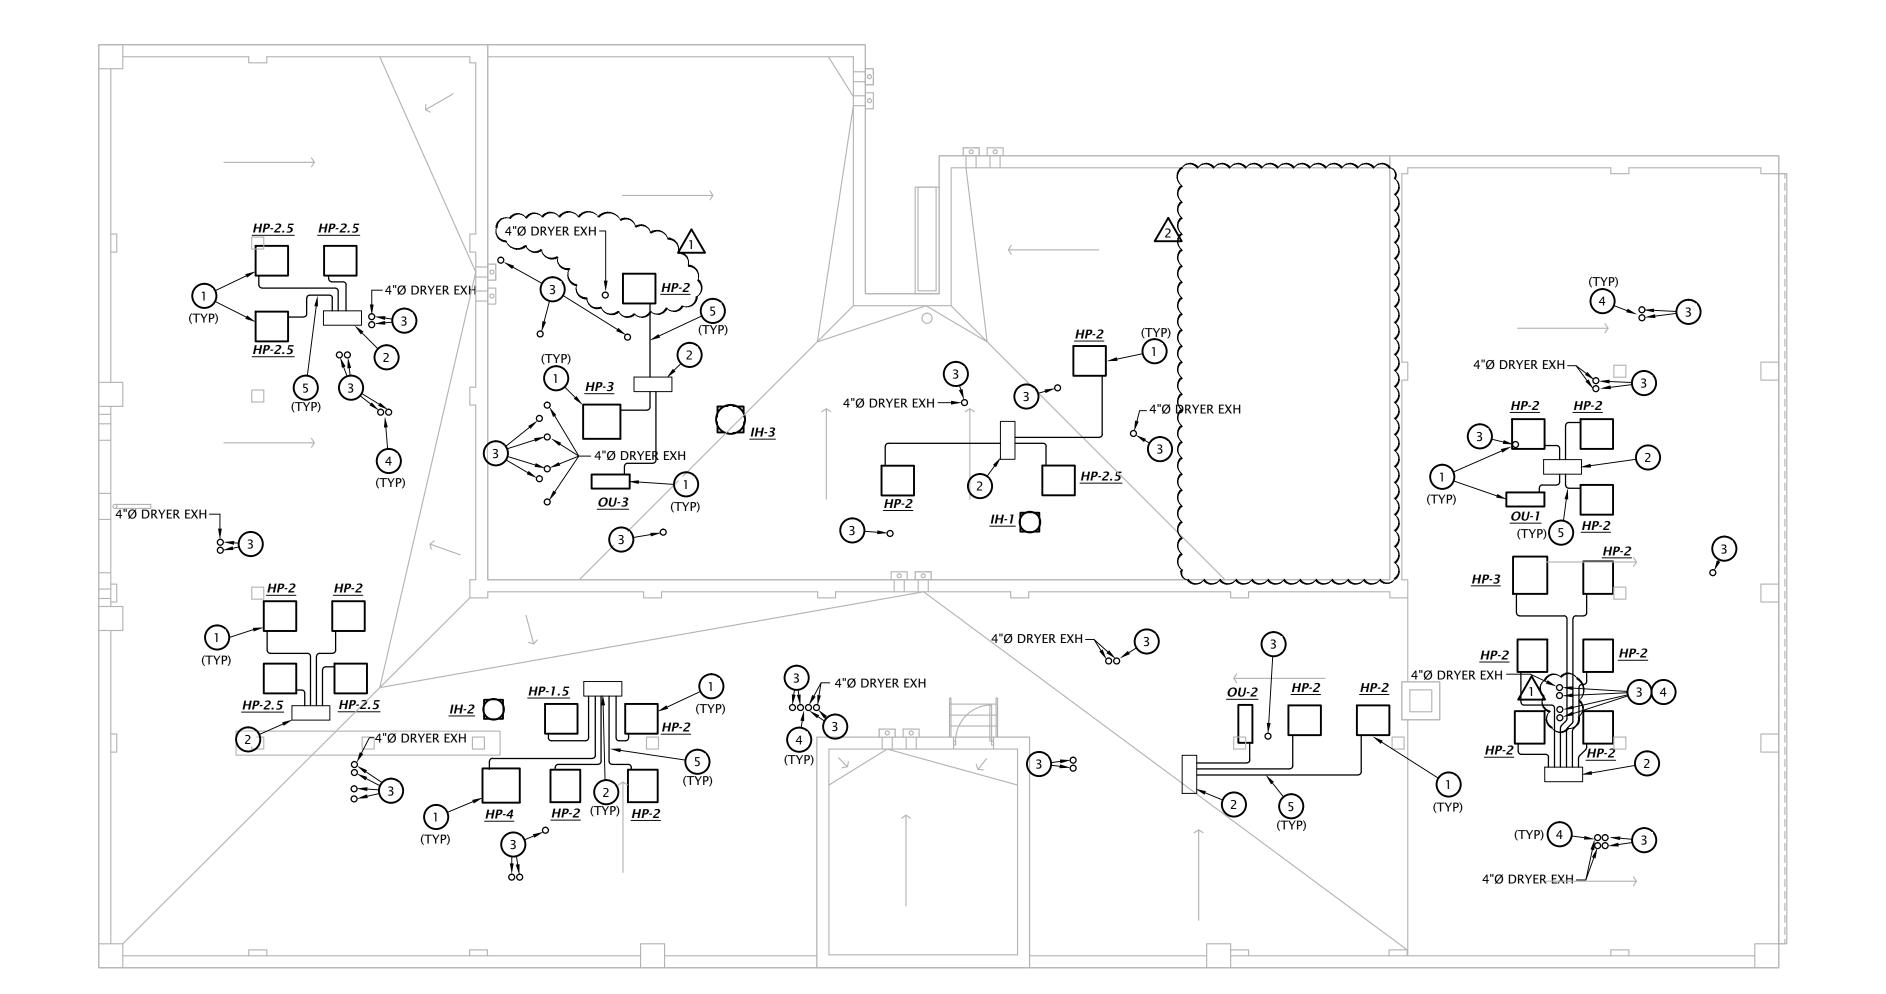

1 ROOF HVAC PLAN
1/8" = 1'-0"





# **#** MECHANICAL NOTES BY SYMBOL

- MOUNT HEAT PUMP ON METAL SUPPORT FRAME ABOVE ROOF ON PAD VIBRATION ISOLATORS. COORDINATE REQUIREMENTS STRUCTURAL ENGINEER AND G.C.
- 2. ROUTE REFRIGERANT PIPING FROM HEAT PUMP TO INDOOR UNIT BELOW. PROVIDE ROOF CURB WITH PIPING PENETRATION ASSEMBLY EQUAL TO ALTA PRODUCTS SIGRIST PIPE CHASE HOUSING. PROVIDE WITH EXIT SEALS FOR REFRIGERANT PIPING AND ELECTRICAL CONDUIT FOR EACH HEAT PUMP AND ONE ADDITIONAL SPARE EXIT SEAL. FIELD LOCATE PIPE CHASE LOCATIONS AND COORDINATE WITH EXISTING CONDITIONS AND OTHER TRADES. COORDINATE CURB REQUIREMENTS WITH G.C.
- 3. PROVIDE PIPE CURB EQUAL TO PATE AT DUCT PENETRATIONS OF ROOF. COORDINATE REQUIREMENTS WITH G.C. DO NOT USE PITCH POCKETS. TERMINATE WITH GOOSE NECK, SEE DETAIL 1:M6.3 FOR MORE INFORMATION.
- 4. PROVIDE PIPE CURB FOR MULTIPLE EXHAUST TERMINATIONS ON ROOF WHERE PENETRATIONS ARE GROUPED TOGETHER.
- 5. SEE DETAIL 2:M6.3 FOR REFRIGERANT PIPING ROUTED ALONG ROOF.



2ASI #3 05-08-2024

1-16-2024 21–3166 SHEET NO.:

M1.4

1-16-2024

/1\Addendum #2 02-20-2024


1-16-2024 21-3166 SHEET NO .:

NOTES:

SEE ROUGH-IN REQUIREMENTS IN PLUMBING SCHEDULE ON


SHEET M6.1 FOR ADDITIONAL INFORMATION. PIPING SHALL NOT BE ROUTED VERTICALL IN FIREWALLS SEPARATING UNITS. ALL PIPING SHALL BE ROUTED VERTICALLY IN FURRED OUT WALL AS INDICATED ON PLANS.

WHERE PIPING PENETRATES FIRE RATED ASSEMBLIES, INSTALL PER ARCH. DETAILS.

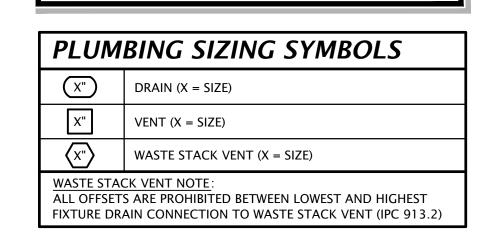

### **# WASTE AND VENT NOTES BY SYMBOL**


- 1. PROVIDE LINT INTERCEPTOR FOR WASHING MACHINES EQUAL TO SMITH MFG. CO. 8910-50, RATED FOR 50 GPM FLOW RATE, PRIMARY AND SECONDARY LINT SCREENS, SECURED AND GASKETED STEEL COVER, 3" INLET AND OUTLET. PROVIDE WITH EXTENSIONS AS REQUIRED.
- 2. PROVIDE DRAIN BOX IN LAUNDRY CLOSET FOR INDIRECT CONNECTION OF CONDENSATE DRAIN FROM INDOOR UNIT LOCATED IN HALLWAY. COORDINATE EXACT LOCATION AND REQUIREMENTS WITH M.C.
- PROVIDE DRAIN BOX IN WALL OF LAUNDRY ROOM FOR INDIRECT CONNECTION OF CONDENSATE DRAIN FROM INDOOR UNIT LOCATED IN HALLWAY. COORDINATE EXACT LOCATION AND REQUIREMENTS WITH M.C.
- 4. ELEVATOR SUMP PUMP. SEE DETAIL 3:M6.3.
- 5. ELEVATOR SUMP PUMP CONTROL PANEL. COORDINATE WITH E.C.
- 6. EXTEND ELEVATOR SUMP PUMP DISCHARGE TO DAYLIGHT. COORDINATE WITH CIVIL

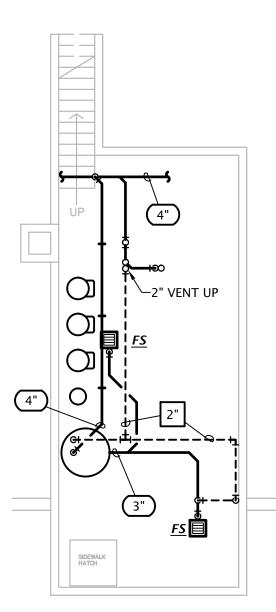



FIRST FLOOR WASTE AND VENT PLAN

1/8' = 1'-0"

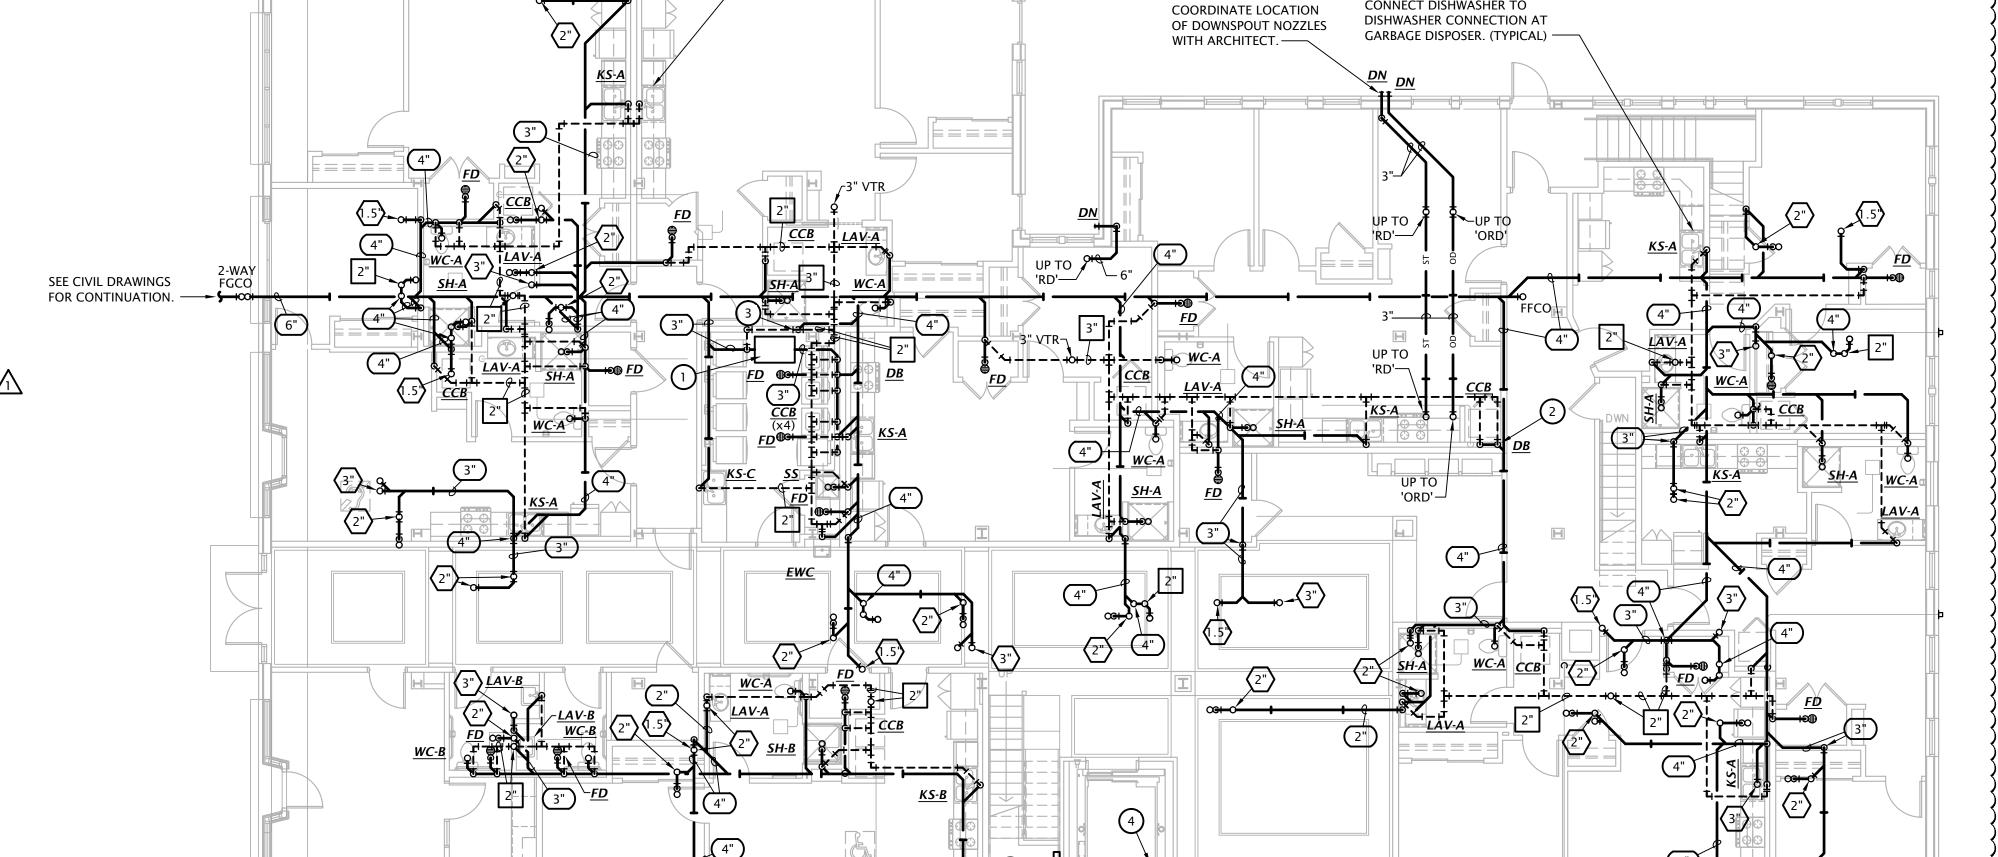

CONNECT DISHWASHER TO

DISHWASHER CONNECTION AT

GARBAGE DISPOSER. (TYPICAL)

**REVIEWED** for code

CONNECT DISHWASHER TO

compliance 5/30/2024

SEE CIVIL DRAWINGS FOR CONTINUATION.

NOTES:

SEE ROUGH-IN REQUIREMENTS IN PLUMBING SCHEDULE ON SHEET M6.1 FOR ADDITIONAL INFORMATION.

PIPING SHALL NOT BE ROUTED VERTICALL IN FIREWALLS


SEPARATING UNITS. ALL PIPING SHALL BE ROUTED VERTICALLY IN FURRED OUT WALL AS INDICATED ON PLANS.

WHERE PIPING PENETRATES FIRE RATED ASSEMBLIES, INSTALL PER ARCH. DETAILS.


### PLUMBING SIZING SYMBOLS

X"	DRAIN (X = SIZE)
Χ"	VENT (X = SIZE)
(X")	WASTE STACK VENT (X = SIZE)

WASTE STACK VENT NOTE:
ALL OFFSETS ARE PROHIBITED BETWEEN LOWEST AND HIGHEST
FIXTURE DRAIN CONNECTION TO WASTE STACK VENT (IPC 913.2)

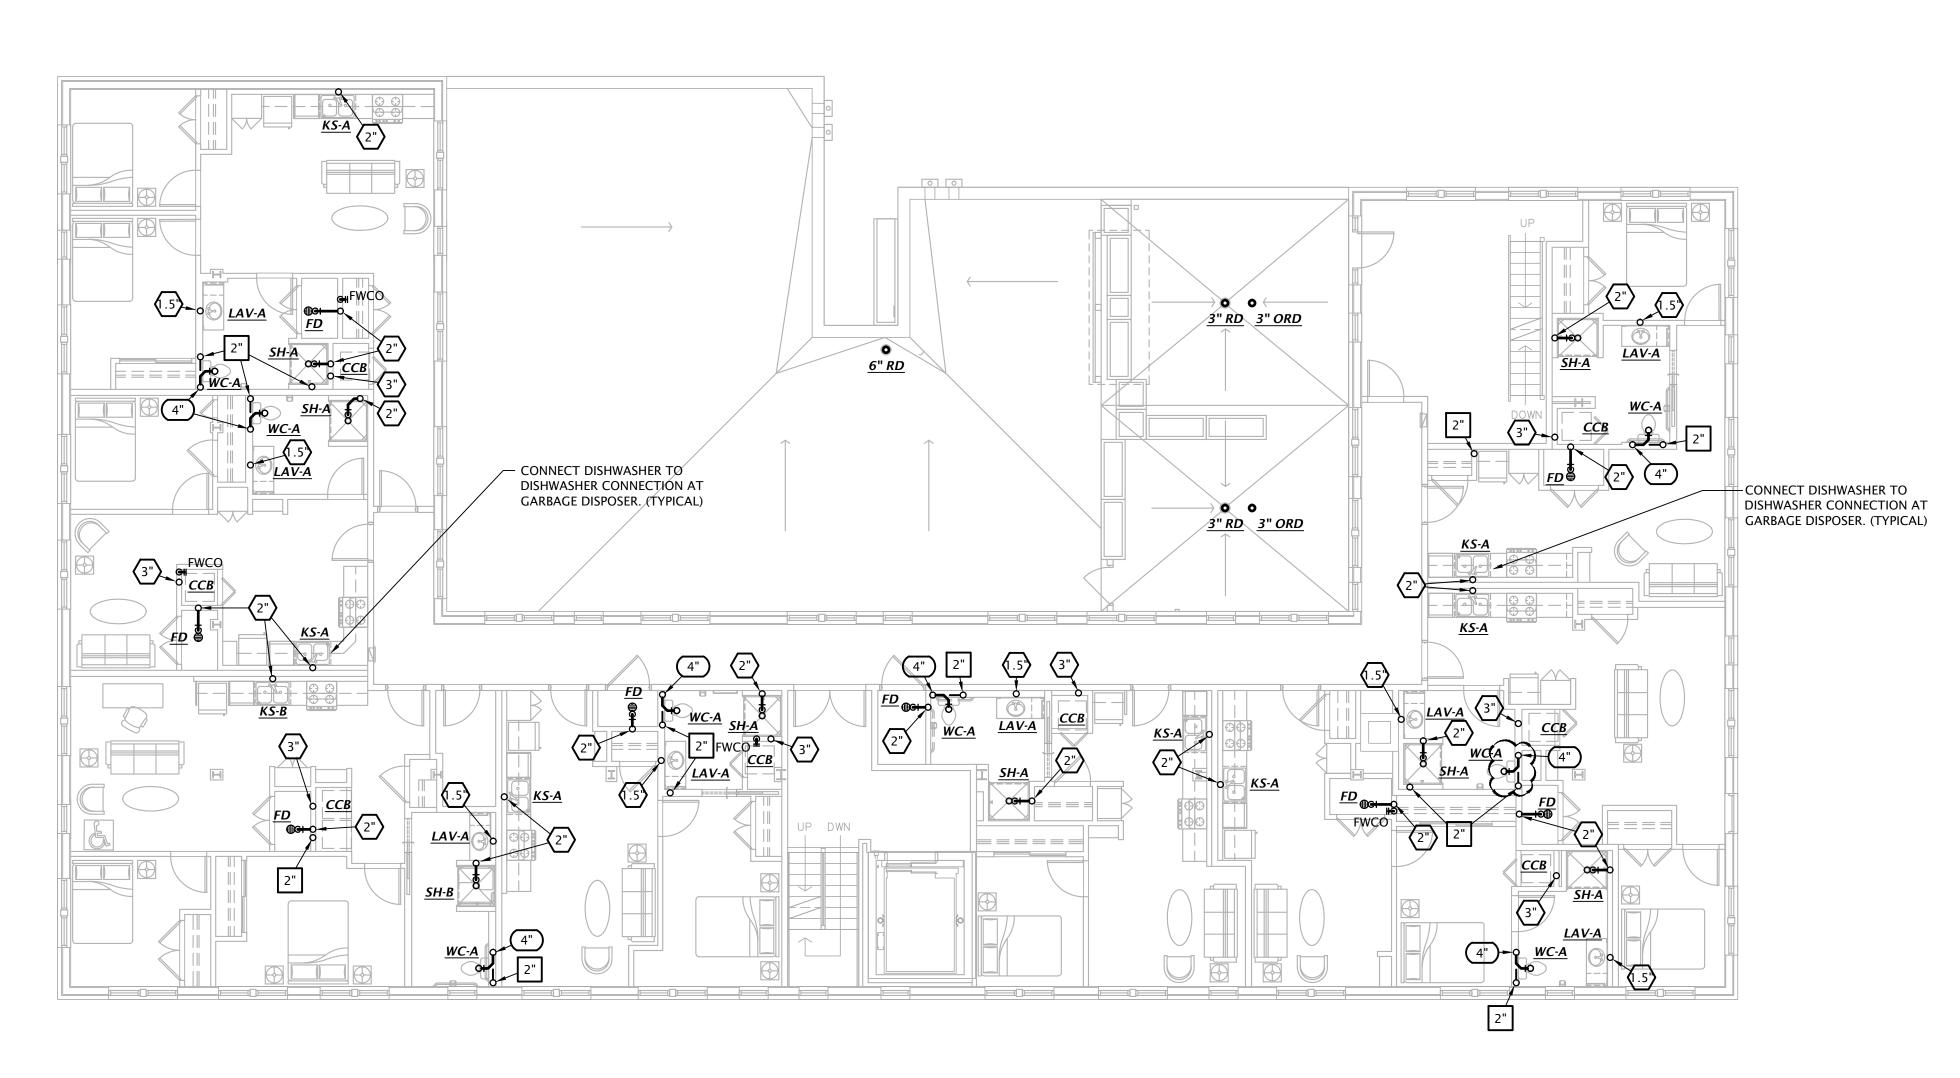



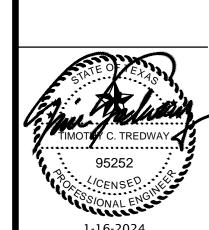

1-16-2024

REVISION:

1-16-2024 SHEET NO.:

M1.6

21–3166





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January 2024

- NOTES:

  SEE ROUGH-IN REQUIREMENTS IN PLUMBING SCHEDULE ON SHEET M6.1 FOR ADDITIONAL INFORMATION.
- PIPING SHALL NOT BE ROUTED VERTICALL IN FIREWALLS SEPARATING UNITS. ALL PIPING SHALL BE ROUTED VERTICALLY IN FURRED OUT WALL AS INDICATED ON PLANS. WHERE PIPING PENETRATES FIRE RATED ASSEMBLIES, INSTALL

# PER ARCH. DETAILS.

### PLUMBING SIZING SYMBOLS


0									
X"	DRAIN (X = SIZE)								
X"	VENT (X = SIZE)								
(X")	WASTE STACK VENT (X = SIZE)								
<u>WASTE STACK VENT NOTE</u> : ALL OFFSETS ARE PROHIBITED BETWEEN LOWEST AND HIGHES									

FIXTURE DRAIN CONNECTION TO WASTE STACK VENT (IPC 913.2)

1-16-2024 REVISION:

1-16-2024 21–3166 SHEET NO.:



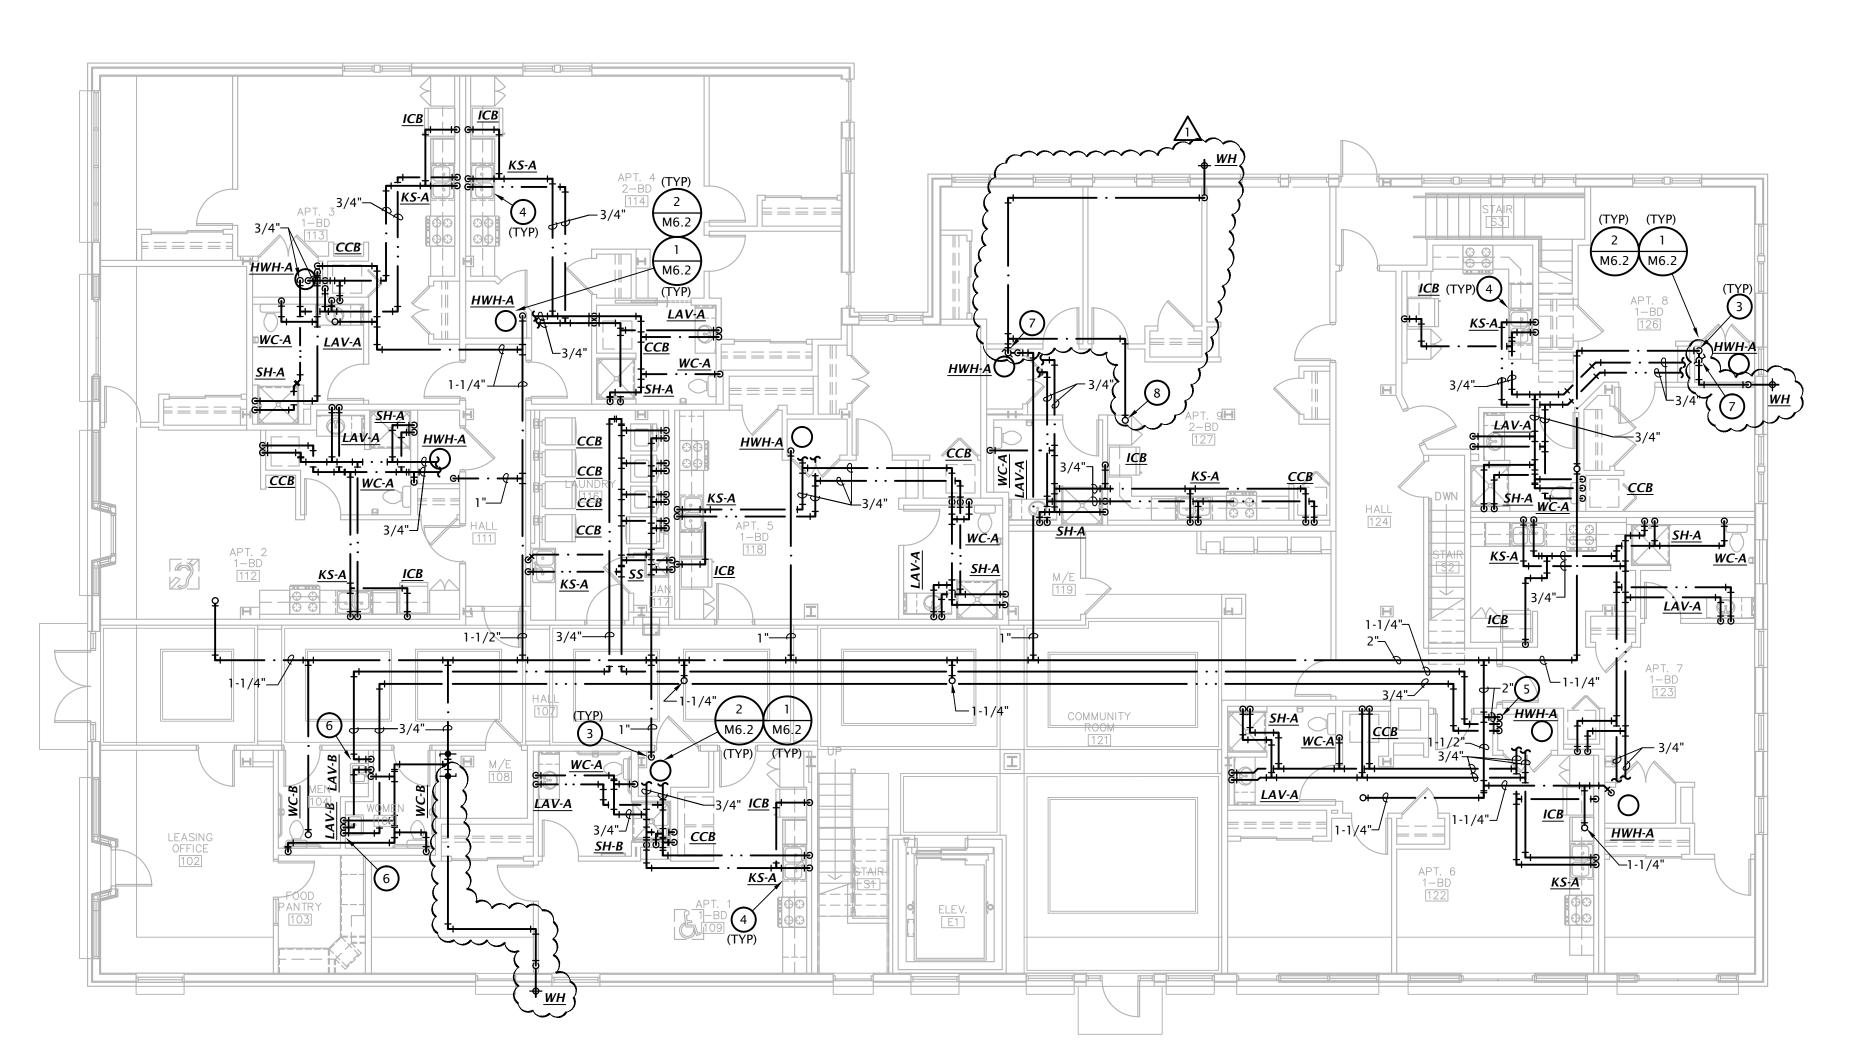





January 2024

		MATER	IAL/SIZE
		Cross-linked polyethylene (PEX)	Polypropylene (PP)
F F	1/2"	3/4"	1/2"
COPPER PIPE SIZE INDICATED	3/4"	1"	1"
PER PIPES INDICATED	1"		1-1/4"
PIP YAT	1-1/4"		1-1/2"
:R	1-1/2"		2"
JA C	2"		2-1/2"
0	2-1/2"		3"
<u> </u>	3"		3-1/2"
5:			с <b>т</b>

**ALTERNATE** 


Note: Pipe sizes indicated on drawings are for Type L copper pipe. If alternate materials are used, sizes shall be as indicated above. Where no pipe size is shown, use of indicated material in design pipe size is prohibited. Do not use materials other than those

- PIPING SHALL NOT BE INSTALLED ABOVE ELECTRICAL PANELS.
- COORDINATE INSTALLATION OF PIPING IN MECHANICAL CLOSET W/ M.C. & E.C. • SEE PLUMBING FIXTURE SCHEDULE ON SHEET P6.1 FOR FIXTURE ROUGH-IN
- INFORMATION.
- INSULATE ALL HW PIPING PER SPECIFICATIONS.


### **# DOMESTIC WATER PLAN NOTES BY SYMBOL**

- 1. FIRE PROTECTION SERVICE ENTRANCE. INSTALL IN ACCORDANCE WITH NFPA 13. COORDINATE LOCATION OF ALL VALVES AND APPURTENANCES WITH AHJ.
- 2. PROVIDE SHUT-OFF VALVE AT WATER SERVICE ENTRANCE WITH PRESSURE REDUCING VALVE SET TO 80 PSI IF REQUIRED. COORDINATE REQUIREMENTS WITH CITY OF SAN
- PROVIDE 1" WATER SERVICE TO APARTMENT WITH SHUT-OFF VALVE. SEE TYPICAL APARTMENT RISER DIAGRAM ON SHEET M6.2 FOR ADDITIONAL INFO.
- 4. PROVIDE 1/2" VALVED BRANCH BELOW SINK AND CONNECT DISHWASHER. ROUTE PIPING ALONG BACK OF CABINETRY, COORDINATE EXACT ROUTING WITH G.C. COORDINATE EXACT REQUIREMENTS WITH DISHWASHER PROVIDED.
- 5. ROUTE 2" CW, 1-1/4" HW, AND 3/4" HW RECIRC. DOWN TO BASEMENT.
- 6. HOT WATER RECIRC LOOP SHALL DROP IN WALL TO LIMIT HOT WATER BRANCH TO PUBLIC LAVATORY TO 2 FT MAX.

- CONNECT TO DOMESTIC COLD WATER BRANCH UPSTREAM OF APARTMENT SHUT-OFF AND TENANT METER AND PROVIDE VALVED BRANCH TO WALL HYDRANT.
- ROUTE 3/4" BRANCH UP TO ROOF HYDRANT. PROVIDE 1/8" DRAIN DRAIN FROM ROOF HYDRANT TO ABOVE NEAREST FLOOR DRAIN IN MECH CLOSET.

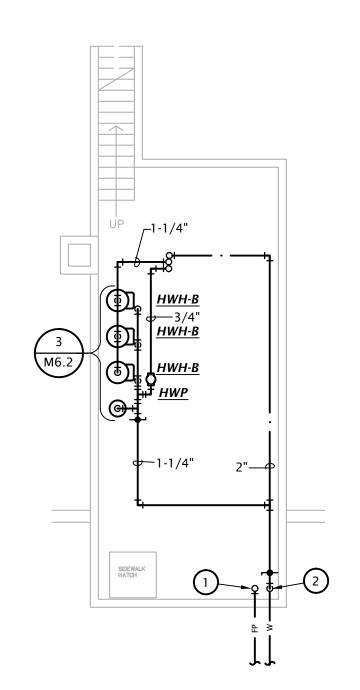



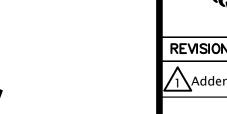

1-16-2024 21-3166 SHEET NO.:

M1.8

ALTERNATE									
	MATER	IAL/SIZE							
	Cross-linked polyethylene (PEX)	Polypropylene (PP)							
1/2"	3/4"	1/2"							
3/4"	1"	1"							
1"		1-1/4"							
-1/4"		1-1/2"							
1/2"		2"							
2"		2-1/2"							
2-1/2"		3"							

Note: Pipe sizes indicated on drawings are for Type L copper pipe. If alternate materials are used, sizes shall be as indicated above. Where no pipe size is shown, use of indicated material in design pipe size is prohibited. Do not use materials other than those

PIPING SHALL NOT BE INSTALLED ABOVE ELECTRICAL PANELS.


- COORDINATE INSTALLATION OF PIPING IN MECHANICAL CLOSET W/ M.C. & E.C.
- SEE PLUMBING FIXTURE SCHEDULE ON SHEET P6.1 FOR FIXTURE ROUGH-IN INFORMATION.
- INSULATE ALL HW PIPING PER SPECIFICATIONS.

### **# DOMESTIC WATER PLAN NOTES BY SYMBOL**


- 1. PROVIDE 1" WATER SERVICE TO APARTMENT WITH SHUT-OFF VALVE. SEE TYPICAL APARTMENT DOMESTIC WATER RISER DIAGRAM ON SHEET M6.2 FOR ADDITIONAL INFO.
- 2. PROVIDE 1/2" VALVED BRANCH BELOW SINK AND CONNECT DISHWASHER. ROUTE PIPING ALONG BACK OF CABINETRY, COORDINATE EXACT ROUTING WITH G.C. COORDINATE

EXACT REQUIREMENTS WITH DISHWASHER PROVIDED.

3. FIELD COORDINATE EXACT LOCATION OF ROOF HYDRANT WITH ARCHITECT AND OTHER TRADES PRIOR TO ROUGH-IN. COORDINATE INSTALLATION WITH G.C. 

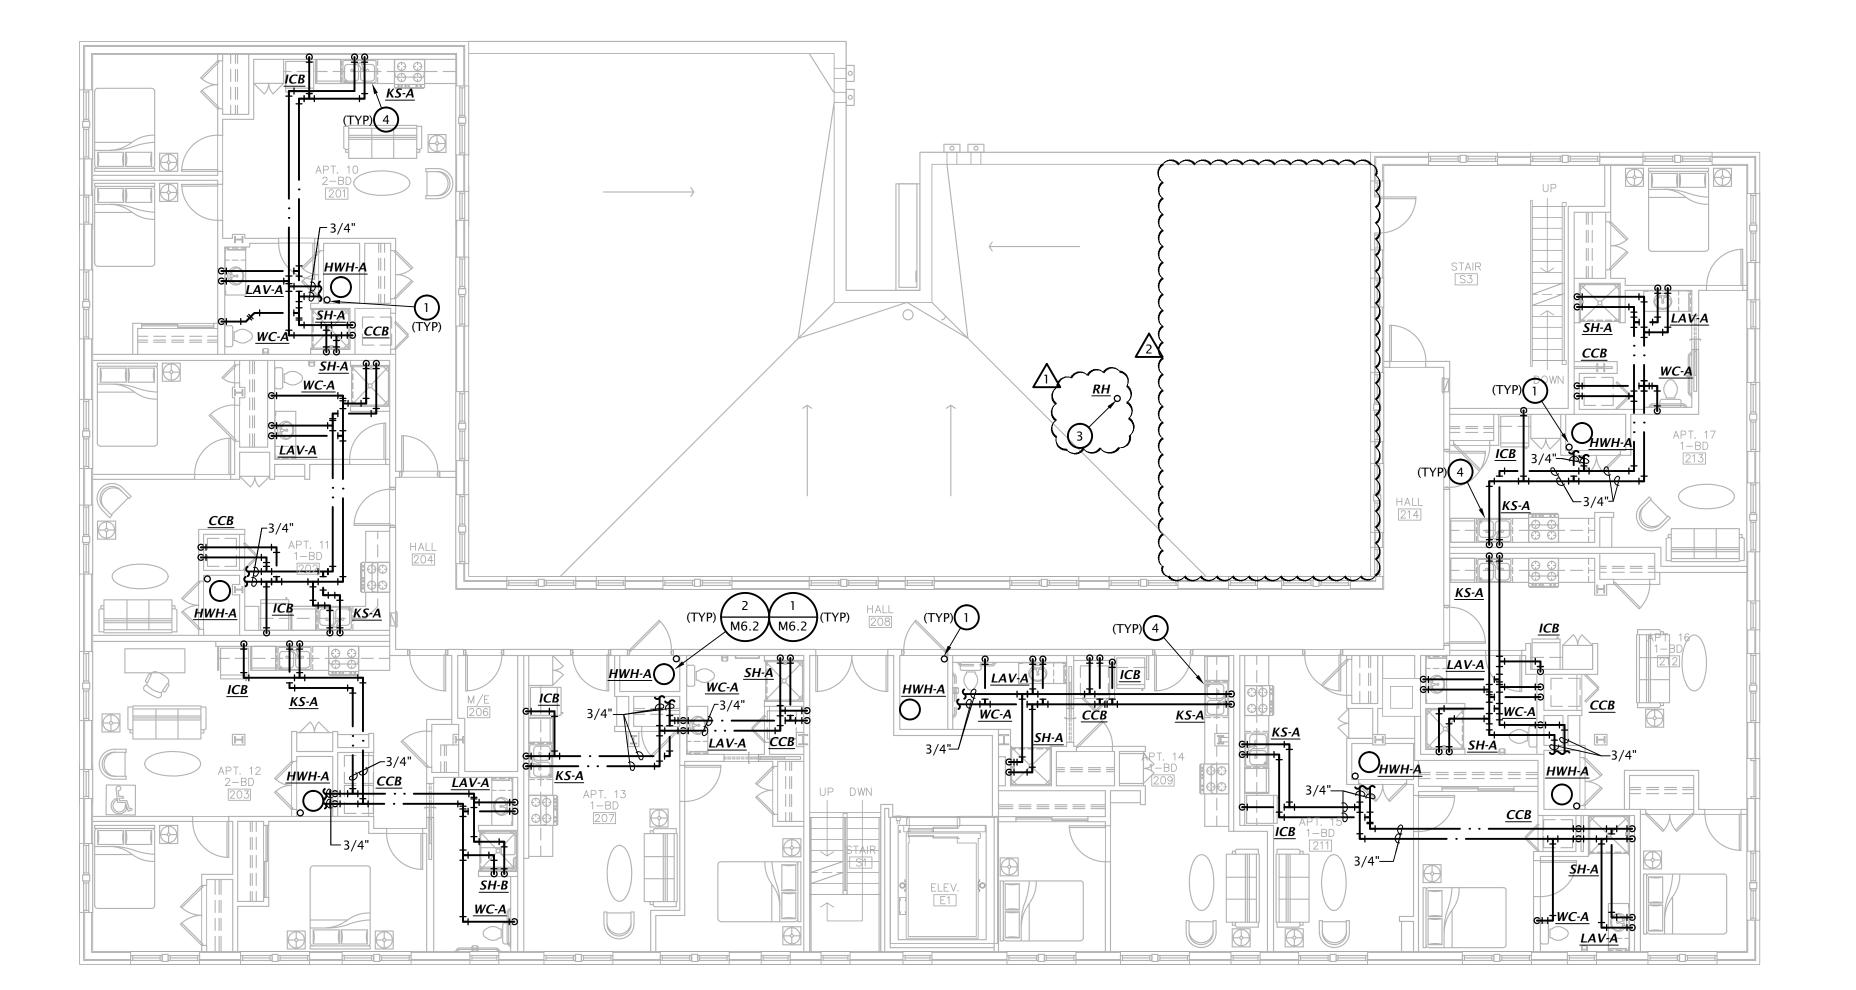



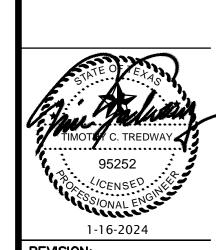

2 ASI #3 05-08-2024

1-16-2024 21–3166 SHEET NO.:

M1.9

Addendum #2 02-20-2024

DATE: 1−16−2024

JOB: 21−3166

SHEET NO.:

M1 10


		MATER	IAL/SIZE
		Cross-linked polyethylene (PEX)	Polypropylei (PP)
<b>4</b>	1/2"	3/4"	1/2"
COPPER PIPE SIZE INDICATED	3/4"	1"	1"
PER PIPE S INDICATED	1"		1-1/4"
PIP YA	1-1/4"		1-1/2"
18. 200	1-1/2"		2"
7PE	2"		2-1/2"
0.	2-1/2"		3"
	3"		3-1/2"
Note: Pin	e sizes indic	ated on drawin	as are for Tyr

Note: Pipe sizes indicated on drawings are for Type L copper pipe. If alternate materials are used, sizes shall be as indicated above. Where no pipe size is shown, use of indicated material in design pipe size is prohibited. Do not use materials other than those listed.

- NOTES:
- PIPING SHALL NOT BE INSTALLED ABOVE ELECTRICAL PANELS.
- COORDINATE INSTALLATION OF PIPING IN MECHANICAL CLOSET W/ M.C. & E.C.
   SEE PLUMBING FIXTURE SCHEDULE ON SHEET P6.1 FOR FIXTURE ROUGH-IN
- INFORMATION.INSULATE ALL HW PIPING PER SPECIFICATIONS.

### **# DOMESTIC WATER PLAN NOTES BY SYMBOL**

- 1. PROVIDE 1" WATER SERVICE TO APARTMENT WITH SHUT-OFF VALVE. SEE TYPICAL APARTMENT DOMESTIC WATER RISER DIAGRAM ON SHEET M6.2 FOR ADDITIONAL INFO.
- 2. PROVIDE 1/2" VALVED BRANCH BELOW SINK AND CONNECT DISHWASHER. ROUTE PIPING ALONG BACK OF CABINETRY, COORDINATE EXACT ROUTING WITH G.C. COORDINATE EXACT REQUIREMENTS WITH DISHWASHER PROVIDED.
- 3. CONNECT TO DOMESTIC COLD WATER BRANCH UPSTREAM OF APARTMENT SHUT-OFF AND TENANT METER AND PROVIDE VALVED BRANCH UP TO PENTHOUSE AND PROVIDE WALL HYDRANT <u>WH</u> ON ROOF. LOCATE WALL HYDRANT 18" ABOVE ROOF IN PENTHOUSE WALL.

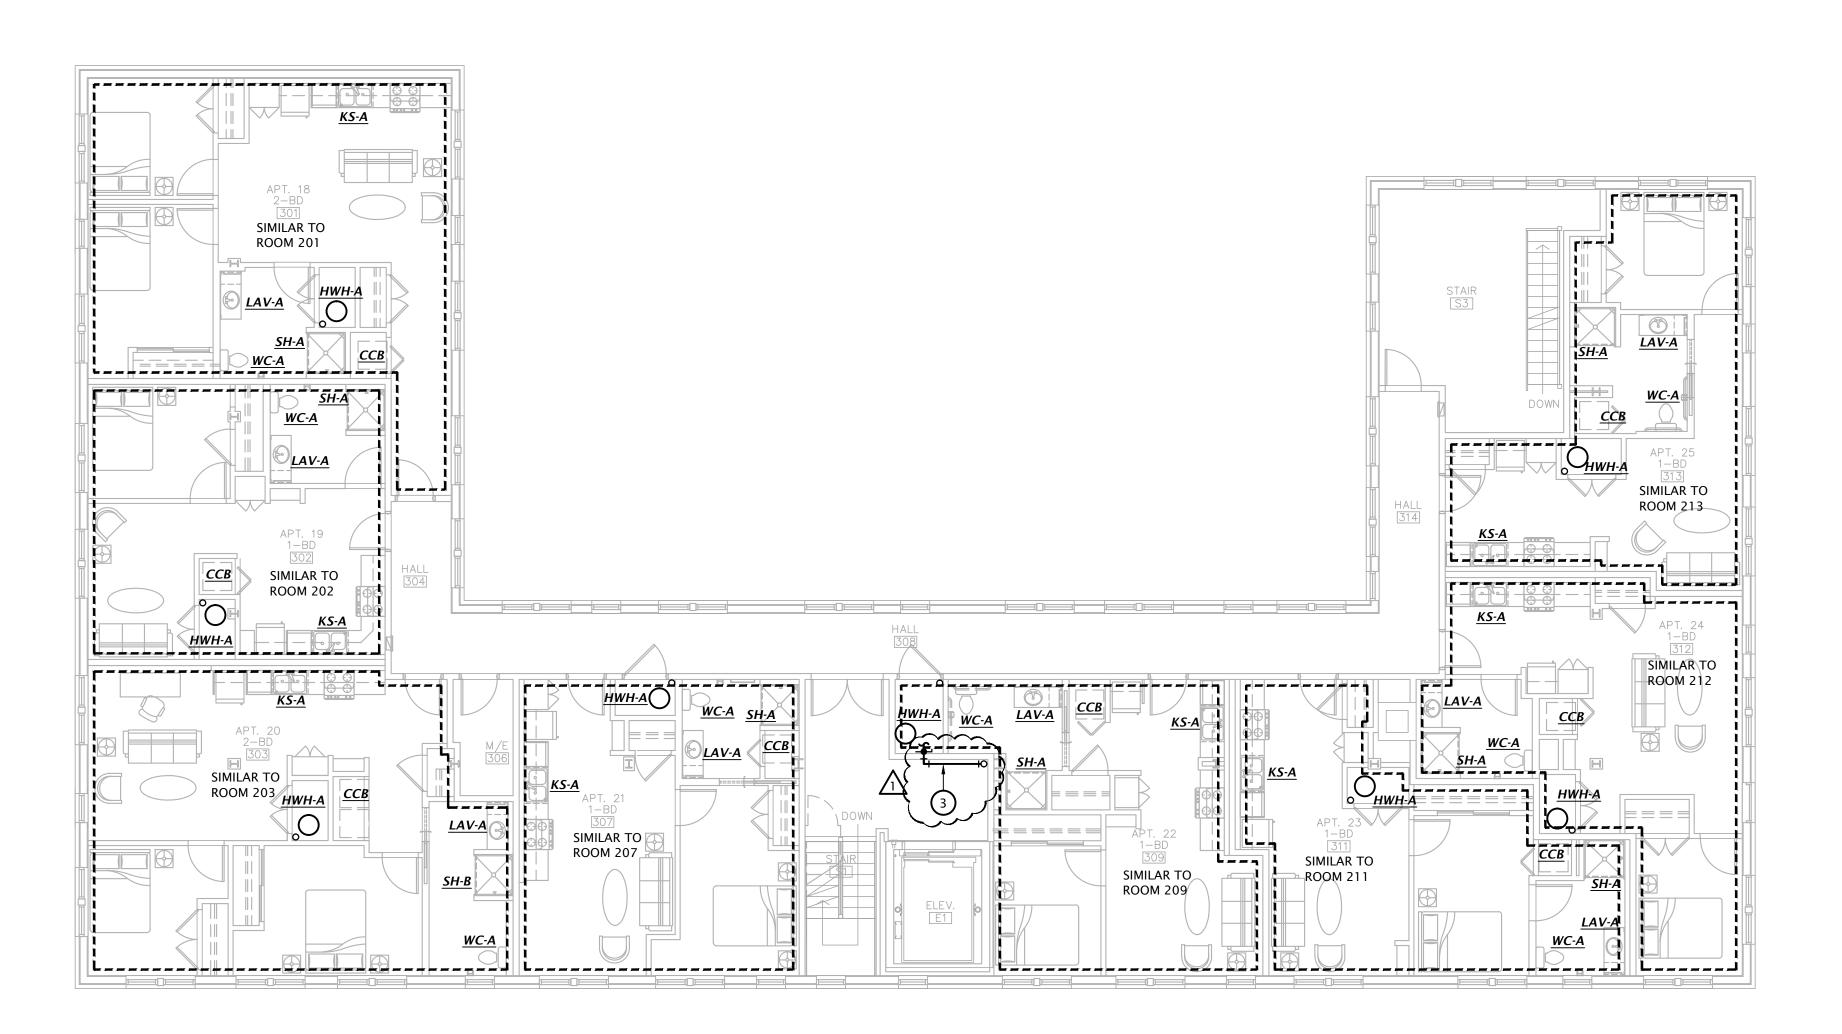

**REVIEWED** for code

compliance 5/30/2024



				Nominal	Nominal	Cooling Design	Heating Design		Corrected Capacity	1	Estimated	Estimated	\ \ \ \ \ \ \ \ \ \ \ \ \ \ \ \ \ \ \	
Room Name	Tag Reference	Model	Туре	Cooling Capacity (BTU/h)	Heating Capacity (BTU/h)	Entering Temp DB/WB (°F) / [Water in temp]	Entering Temp DB/WB (°F) / [Water in temp]		Cooling Sensible Capacity (BTU/h)				Voltage / Thase	MCAWIHA
3rd Floor Stair	IU-1-1	NTXWST09B112AA	Wall -Mounted	8,000	8,300	80.0/67.0	70	7,158.3	7,146.3	7,280.3	61.4	88.6		00000249 by WEDdigoco
2nd Floor Stair	IU-1-2	NTXWST09B112AA	Wall -Mounted	8,000	8,300	80.0/67.0	70	7,111.8	7,111.8	7,266.9	61.5	88.6		<b>024</b> Outdoor
1st Floor Hall	IU-1-3	MSZ-EF09NAW-U2	Wall -Mounted	8,000	8,300	80.0/67.0	70	7,041.9	7,041.9	7,246.8	63.0	87.2	208/230V/1- phase	Powered by Outdoor
3rd Elevator Lobby	IU-2	NTXWMT09A112AA	Wall -Mounted	9,000	10,900	80.0/67.0	70	8,130.9	7,071.4	6,931.7	62.3	87.0	208/230V/1- phase	Powered by Outdoor
Laundry	IU-3	NTXWMT12A112AA	Wall -Mounted	12,000	12,200	80.0/67.0	70	10,841.2	8,814.5	8,472.1	57.9	90.8	208/230V/1- phase	Powered by Outdoor

MITSUBISH	II ELECTRIC T	TRANE HVA	C US: OUTE	DOOR UNI	T SCHEDU	'LE		
				Cooling	Heating COP	Design	Design	Co
(		Nominal Cooling	Nominal Heating	Efficiency	Treating COF	Cooling	Heating	Cool

Tag Reference	Model Number	Nominal Cooling Capacity (BTU/h)	-	11/h)   IEER/EER   @ 4/°F		Design Cooling Outdoor	Design Heating Outdoor Temp	Corrected Cooling Total Capacity	Corrected Heating Capacity	Electrical-Per Module  208/230 or [460V]			
				[SEER]	[HSPF]	Temp DB (°F)	WB (°F)	(BTU/h)	(BTU/h)	Voltage / Phase	MCA 208/230	RFS	MOCP
OU-1	NTXMPH24A132CA	22,000	25,000	11.75 [17.25]	[9.5]	101.0	16.5	21,312.0	21,794.1	208/230V / 1- phase	31.5	40	40
OU-2	NTXSMT09A112AB	9,000	10,900	12 [18]	3.549564 [10]	101.0	16.5	8,130.9	6,931.7	208/230V / 1- phase	9	15	15
OU-3	NTXSMT12A112AB	12,000	12,200	9.9 [18]	3.611733 [10]	101.0	16.5	10,841.2	8,472.1	208/230V / 1- phase	9	15	15

MADIZ	MANUEACTURER	DESCRIPTION		TRIM		ROUGH-IN	I SIZES		NOTES
MARK	MANUFACTURER	DESCRIPTION	MANUFACTURER	DESCRIPTION	WASTE	VENT	CW	HW	NOTE
WC-A	KOHLER	Model 3999-0 "Highline" ADA compliant flush tank water closet, white vitreous china, two piece, 12" rough-in, elongated 16-1/2" high bowl, siphon jet flushing action, 1.28 GPF, polished chrome actuator located on open side of room.	KOHLER	#K-4636-0 white, closed front plastic seat with slow closing lid.	4"	2"	1/2"		1
WC-B	KOHLER	Model 3999-0 "Highline" ADA compliant flush tank water closet, white vitreous china, two piece, 12" rough-in, elongated 16-1/2" high bowl, siphon jet flushing action, 1.28 GPF, polished chrome actuator located on open side of room.	KOHLER	#4650-0 Lustra white, open front, plastic seat with cover	4"	2"	1/2"		1
LAV-A	AMERICAN STANDARD	Model 0610.000 under counter mounted lavatory, white vitreous china, 20-1/4"W x 16"	I MALLED I Drovido non-un drain		2"	1-1/2"	1/2"	1/2"	1,2,4
LAV-B	KOHLER	Model K-2035-1 wall hung, white vitreous china, 22"W x 18", single hole faucet.	DELTA	Model 597LF-PNMPU single handle faucet, with polished nickel finish. Provide with pop-up drain.	2"	1-1/2"	1/2"	1/2"	1,2,3
KS-A	JUST	Model DL-ADA-2233-A-GR two compartment 18 GA stainless steel sink, self rimming, 14"x16"x5"D inside, fully undercoated, faucet holes as req., and drain holes center rear.	DELTA IN-SINK-ERATOR	Model 400-HDF single handle kitchen sink faucet with hose spray attachment. Chrome finish. Provide basket strainer.  "Badger 5" garbage disposal, 1/2hp, 120V,	2"	1-1/2"	1/2"	1/2"	1,3,2,4
KS-B	BLANCO	Model Liven Silgranit single compartment granite composite sink, 22-1/4"x16-15/16"x12"D inside, faucet holes as req., metallic gray finish. Coordinate mounting type with Arch.	MOEN	cord and plug connected.  Model 87194 single handle high arc kitchen sink faucet with spring pulldown sprayer. Stainless finish. Provide basket strainer.	2"	1-1/2"	1/2"	1/2"	2
SH-A	AQUARIUS	Model 'G-3600-BF-1S' reinforced fiberglass ADA shower, 36"W x36"D x77"H, with integral soap/toiletry shelves, integral seat and grab bars in accordance with ADA requirements. Right or left hand rough-in as required, center drain, white finish.	KOHLER	#K-304 pressure balancing valve with integral temperature limits and stops, #K-TS10584-4 valve trim, #K-355 wall supply elbow, #K-9514 60" hose, #K-10549 hand shower, and #K-8524/K-349 slide bar. Entire assembly shall have rubbed bronze finish.	2"	1-1/2"	1/2"	1/2"	1
SH-B	AQUARIUS	Model 'G-3600-BF-1S' reinforced fiberglass ADA shower, 36"W x36"D x77"H, with integral soap/toiletry shelves, integral seat and grab bars in accordance with ADA requirements. Right or left hand rough-in as required, center drain, white finish.	KOHLER	#K-304 pressure balancing valve with integral temperature limits and stops, #K-TS10584-4 valve trim, #K-355 wall supply elbow, #K-9514 60" hose, #K-10549 hand shower, and #K-8524/K-349 slide bar. Entire assembly shall have rubbed bronze finish.	2"	1-1/2"	1/2"	1/2"	1
SS	FIAT	Model MSB-2424 one piece molded stone mop basin, 24" square, stainless steel integral drain body with caulk connection, stainless steel wall guards.	DELTA	Model 28T9 faucet with hose thread outlet, vacuum breaker, pail hook, wall brace, metal lever handles.	3"	1-1/2"	3/4"	3/4"	4
EWC	ELKAY	Model EZS8WSLK ADA compliant , self-contained w bottler filler, lead-free cooling system capable of co			2"	1-1/2"	1/2"		
WH	WOODFORD	Model 25 frost proof wall hydrant with anti-siphon	vacuum breaker, n	netal handle.			3/4"		
RH	WOODFORD	Model RHY2-MS frost proof roof hydrant with ASSE integral vent that allows drainage with 1/8" drain hanufacturers roof mounting system consisting of boot, and shims as required. Coordinate installation	nole drilled and tap cast iron hydrant	ped in body of hydrant. Provide with			3/4"		
CCB	WATER TITE	Model W4700 recessed washing machine box with turn adaptor ball valves, sweat connection.	2"PVC/ABS drain c	oupling and knockout test cap. Two, 1/4	2"	2"	1/2"	1/2"	
ICB	WATER TITE	Model W9700 ice maker connection box with 1/4 t	urn ball valve and	1/2" sweat copper connection.			1/2"		
DB	SOUIX CHIEF	Model 696-3 drainage box box with 2" drain conne protection device.	ection and solid cov	ver. Provide with Proset Trapguard trap	2"				
FD	SIOUX CHIEF	Series 833 adjustable floor drain with nickel bronz	e strainer. Provide	Proset Trapguard trap protection device.	2"				
FS	WADE	Model 9140 floor sink with 8" deep body, enamele openings as requried.	d interior, sedimen	t bucket, nickel bronze trim and grate with	3"	1-1/2"			
RD	WADE	Model 3000 cast iron side outlet body roof drain w	Model 3000 cast iron side outlet body roof drain with flange, flashing ring with gravel stop, underdeck clamp						
ORD	WADE	Model 3000 cast iron side outlet body overflow roo	of drain with 2" cas	st iron dam/ flashing ring, flange, underdeck (	clamp and	cast iron	dome st	rainer.	
DN	WADE	Model 3940 nickel bronze downspout nozzle with	threaded outlet and	d flange to secure nozzle to wall.					
HWH-A	A.O. SMITH	Model ENT-40, 40 gallon electric water heater, (2) rise. Minimum 0.95 Energy Factor. Supplied with te			nts, 21 GPF	H recovery	@ 90°F	temp	5
HWH-B	RHEEM	Model ELD52-TB, 50 gallon electric water heater, (2 with temperature & pressure relief valve and brass	2) 4500 watt, 208 v		ery @ 90°F	temp rise	. Suppl	ied	
HWP	BELL & GOSSETT	Model NBF-33 circulation pump, bronze body, 10 C		20.14.5. Provide along					

### GENERAL:

· Provide fixtures with all trim necessary for complete installation

- 1. Fixture and installation to meet accessibility requirements of the Fair Housing Act.
- 2. Provide Dearborn supplies with stops and escutcheon plate, 1-1/4" cast brass p-trap.

3. Insulate water and waste piping below lavatory. Utilize insulation kit equivalent to LavGuard by Truebro.

- 4. Trim shall be provided with polished chrome finish.
- 5. Mount water heater on stand equivalent to Oatey water heater stand.

BLOV	LOWER COIL SCHEDULE														
MARK	MANUF.	MODEL		HEATING	V/Ph	MOTOR	MCA	МОСР	NOTES						
WARK	ARK MANUF.	MODEL	CFM	ESP	SPEED	KW	V/FII	FLA	MCA	MOCP	140123				
BC-1.5	TRANE	TEM4A0B18	600	0.6	HIGH	5.8	208/1	1.2	36	40					
BC-2	TRANE	TEM4A0B31	800	0.6	HIGH	5.8	208/1	4.1	42	45					
BC-2.5a	TRANE	TEM4A0B36	1000	0.6	HIGH	7.2	208/1	2.0	46	50					
BC-2.5b	TRANE	TEM4A0B36	1000	0.6	HIGH	7.2/3.6	208/1	2.0	46/22	50/25	1				
ВС-3	TRANE	TEM4A0C42	1200	0.6	MED	7.2	208/1	4.1	48	50					
BC-4	TRANE	TEM4A0C49	1380	0.6	HIGH	7.2/7.2	208/1	6.0	51/43	60/45	1				

- Single point connection required, coordinate the exact electrical requirements of equipment provided with E.C., UNO - Electric heater shall not operate simultaneously with heat pump. Electric heater shall be used as back-up heat only.

1. Blower coil heat has two circuits, first circuit indicated includes fan motor.


i	V/Ph	MOTOR FLA	МСА	МОСР	NOTES
	208/1	1.2	36	40	
	208/1	4.1	42	45	
	208/1	2.0	46	50	
	208/1	2.0	46/22	50/25	1
	208/1	4.1	48	50	

HEAT	HEAT PUMP SCHEDULE														
MADIC	MANUE	MODEL	NOMINAL TONG		CO	OLING CAPAC	ITY		HEAT	ING CAPAC	ITY	MIN	E	LECTRICA	ıL.
MARK	MANUF.	MODEL	NOMINAL TONS	OA DB	ENT AIR DB/WB	SENS MBH	TOT MBH	MIN SEER2	OA DB	ENT AIR DB	TOT MBH	HSPF2	MCA	МОСР	V/PH
HP-1.5	TRANE	4TWR4018	1.5	105	75/63	10.5	13.1	14.3	47	70	18.9	7.5	12	20	208/1
HP-2	TRANE	4TWR4024	2	105	75/63	16.6	20.7	14.3	47	70	22.5	7.5	13	25	208/1
HP-2.5	TRANE	4TWR4030	2.5	105	75/63	20.0	25.1	14.3	47	70	27.7	7.5	17	25	208/1
HP-3	TRANE	4TWR4036	3	105	75/63	24.5	29.9	14.3	47	70	33.9	7.5	18	30	208/1
HP-4	TRANE	4TWR4048	4	105	75/63	32.1	41.7	14.3	47	70	45.3	7.5	24	40	208/1

- 1. Refrigerant lines shall be field fabricated. Coordinate line sizing requirements with equipment manufacturer for length of run for each apartment. Provide suction accumulators, etc. as required.
- 2. Note not used
- 3. Provide 7-day programmable thermostat.
- 4. Provide with R140a refrigerant.
- 5. Provide 2 sets of MERV-7 filters.

MARK	MANUF.	MODEL	MOUNTING	WATTS	VOLTAGE/PHASE	DESCRIPTION	NOTES
EWH-1,2,3	TRANE	UHWA	WALL	1,500	120/1	Architectural fan forced wall heater	1,2,3

- 1. Provide with high temp. thermal cutout and fan delay.
- 2. Provide with integral thermostat and unit mounted disconnect switch.
- 3. Provide with manufacturer's surface mounting adapter sleeve. Coordinate exact mounting requirements and locations with Arch. and rated construction.

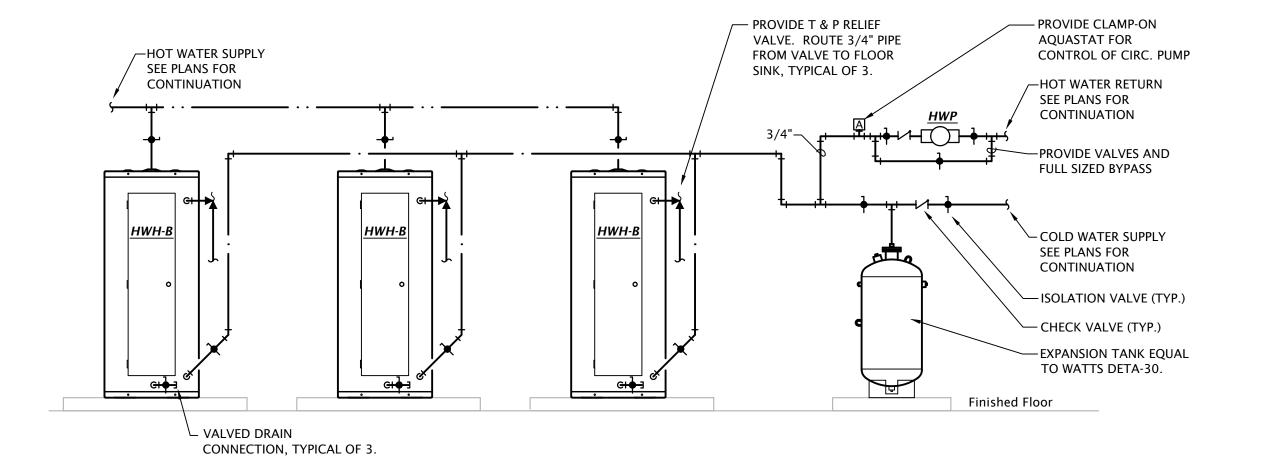



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1-16-2024 **REVISION:** 

1-16-2024 DATE: 21-3166 SHEET NO.:

LST Consulting  MANHATTAN  4809 Vue Du Lac Place, Suite 201  Manhattan, KS 66503  785.587.8042	Engineers, PA WICHITA  125 S. Washington, Suite 150 Wichita, Kansas 67202 316.285.0696				
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Project 23061	January 2024				
	MANHATTAN 4809 Vue Du Lac Place, Suite 201 Manhattan, KS 66503 785.587.8042 www.LSTengir mail@LSTengir				


GillamRe

CDAL	//TV DOO!	- 11005	8	6					
<u>JKA V</u>	<u>ITY ROOF</u>	- HOOL	) SCF	တ					
MARK	MANUFACTURER	MODEL	TZIZZ SE	FINISH	SCREEN	DAMPER	SERVICE	DESCRIPTION	NOTES
IH-1,2	GREENHECK	GRSI-10	10"x10 DAMPER NSPE	GALVANIZED STEEL	BIRD	GRAVITY	INTAKE	GALVANIZED STEEL GRAVITY INTAKE HOOD	1
IH-3	GREENHECK	GRSI-16	BE24-00000249 1.45	GALVANIZED STEEL	BIRD	120V	INTAKE	GALVANIZED STEEL GRAVITY INTAKE HOOD	1
IOTES:	de with roof curb cor	mpatible with r	compliance 5/30/2024 cool slope and construction.						


EXHAUST FAN SCHEDULE											
MARK	MANUFACTURER	MODEL	CFM	ESP (" wg)	POWER	VOLTS/ PHASE					
EF-1	BROAN	XB80	80	0.25"	36 W	120 / 1					
EF-2	BROAN	XB50	50	0.25"	5.1 W	120 / 1					
NOTES:											
1. Fixtur	e shall be Energy Sta	ar listed.									

6. Provide with manufacturer's ceiling radiation damper.


2. Fixture shall operate at <1 SONE 3. Provide with integral disconnect. 4. Provide manufacturer's wall cap or roof jack, see plans. 5. Provide integral backdraft damper. ROUTE MAIN DUCT BETWEEN JOISTS

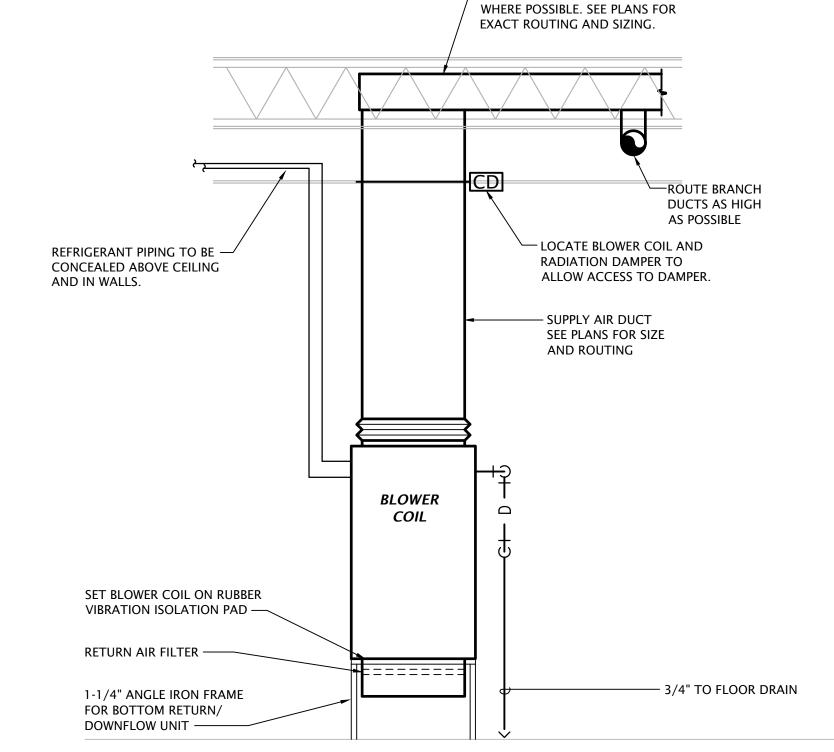



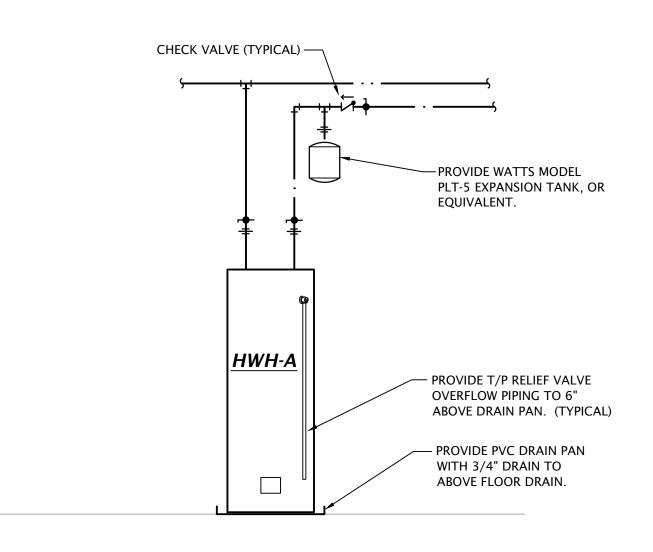



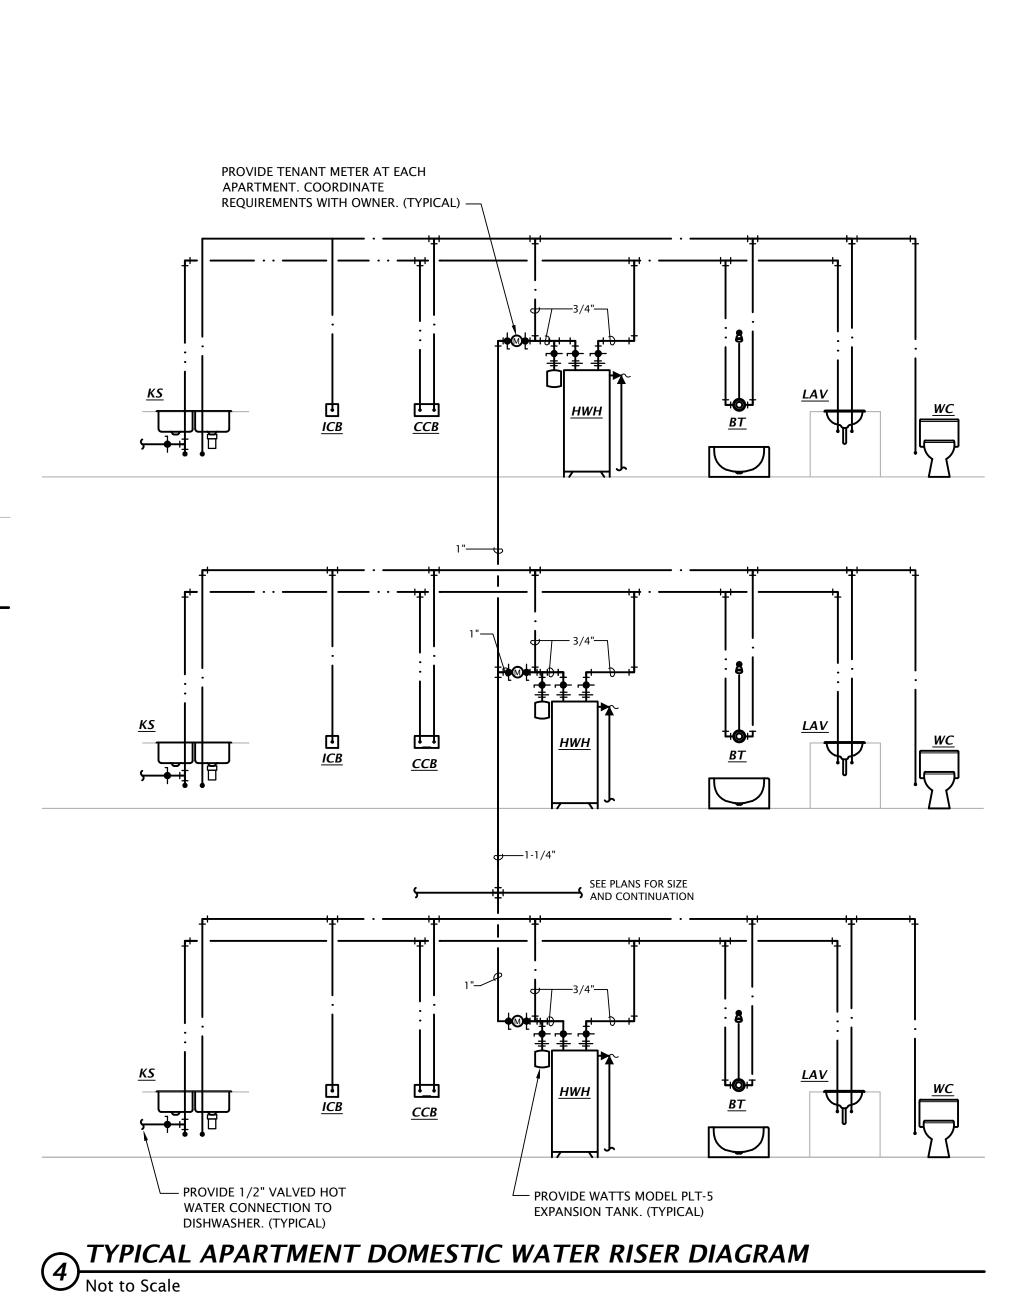



1-16-2024 **REVISION:** 1-16-2024 21-3166 SHEET NO .:

M6.2

8"x8" steel 4-way ceiling register with **HART & COOLEY** 684 WHITE SURFACE YES 6"x6" steel 4-way ceiling register with YES **HART & COOLEY** 684 WHITE SURFACE Aluminum, straight blade vertical fin 618 WHITE YES HART & COOLEY SURFACE register with opposed blade damper 12"x12" steel 3-way ceiling register with YES SD-F **HART & COOLEY** 683 WHITE SURFACE damper 12"x12" steel square louvered diffuser, SD-G PRICE SPD WHITE SURFACE YES neck size as indicated on drawings Heavy duty aluminum bar grille with SD-H PRICE LBMH-26C MILL 3/16" bars spaced at 7/16" with 15° FLOOR YES deflection, size as indicated on drawings Single deflection, steel, louvered face SURFACE HART & COOLEY 650 WHITE RG-A NO return grille, size as indicated on drawings Steel louvered return grille, size as PRICE 530 WHITE SURFACE NO RG-B indicated on drawings Single deflection, steel, louvered face **HART & COOLEY** 650 WHITE SURFACE TG-A return grill GENERAL NOTES: . Provide mounting frame as required for ceiling type. 2. Maximum NC shall be 25. 3. Paint objects visible through grilles with flat black paint. 4. Provide ceiling radiation damper for all devices located in a rated ceiling.

FINISH

WHITE

WHITE

MOUNTING DAMPER

YES

YES

SURFACE

SURFACE

DESCRIPTION

12"x12" steel 4-way ceiling register with

10"x10" steel 4-way ceiling register with

NOTES

1,2

1,2

1,2

1,2

APPLICATION

AIR DEVICE SCHEDULE

HART & COOLEY

HART & COOLEY


SD-B

NOTES:

MANUFACTURER | MODEL

684

684

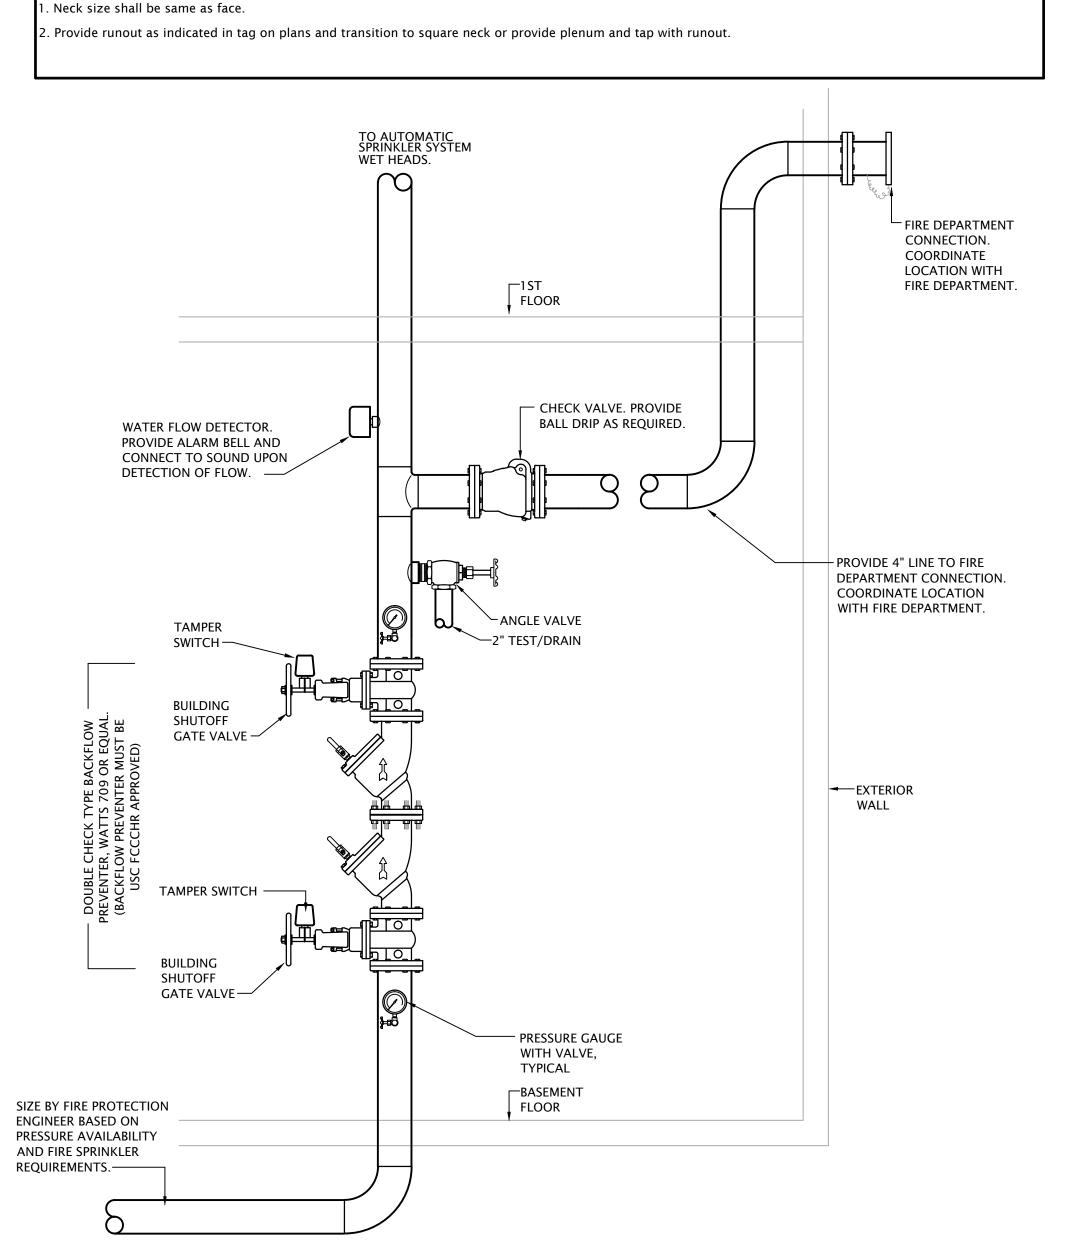

FIRE PROTECTION RISER DIAGRAM

DATE: 1-16-2024 21-3166 SHEET NO .:

M6.3

**REVIEWED** for code compliance 5/30/2024

### **MECHANICAL SYMBOLS**

- THERMOSTAT
- CONTROL CABLE, VERIFY TYPE WITH EQUIPMENT MANUFACTURER
- SQUARE SUPPLY DIFFUSER -TYPE AND AIRFLOW INDICATED
- SQUARE RETURN GRILLE TYPE INDICATED

- GRILLE/DIFFUSER TAG TOP: DEVICE TAG (SEE SCHEDULE) MIDDLE: NECK SIZE

BOTTOM: AIRFLOW

- MANUAL BALANCING DAMPER
- RECTANGULAR RETURN OR RELIEF AIR DUCT UP
- RECTANGULAR RETURN OR RELIEF AIR DUCT UP
- RECTANGULAR SUPPLY AIR DUCT UP
- RECTANGULAR SUPPLY AIR DUCT DOWN
- RECTANGULAR RETURN OR EXHAUST AIR DUCT DOWN
- ROUND DUCT UP
- ROUND DUCT DOWN
- FLEXIBLE DUCTWORK MAX 5'
- RIGID DUCT RUNOUT 90° ELBOW WITH TURNING VANES
- VERTICAL FIRE DAMPER
- PIPE TURNING UP
- PIPE TURNING DOWN

- —— D —— CONDENSATE DRAIN LINE
- ── ►── SANITARY DRAIN BELOW GRADE
- STORM DRAIN BELOW GRADE
- → OD OVERFLOW DRAIN BELOW GRADE
- SANITARY DRAIN ABOVE GRADE
- → OD OVERFLOW DRAIN ABOVE GRADE

→ STORM DRAIN ABOVE GRADE


- ---- SANITARY VENT
- · DOMESTIC COLD WATER
- · · · DOMESTIC HOT WATER
- · · · DOMESTIC HOT WATER RECIRC
- FP FIRE PROTECTION PIPING

— w — WATER SERVICE PIPING

- BALL VALVE
- CHECK VALVE


### SYMBOL MODIFICATION DESIGNATORS/ABBREVIATIONS


- OA OUTDOOR AIR
- RA RETURN AIR SA SUPPLY AIR
- MC MECHANICAL CONTRACTOR
- EC ELECTRICAL CONTRACTOR
- GC GENERAL CONTRACTOR AFF ABOVE FINISHED FLOOR
- AFG ABOVE FINISHED GRADE
- BG BELOW GRADE
- FG FINISHED GRADE
- FFCO FINISH FLOOR CLEAN OUT FWCO FINISH WALL CLEAN OUT
- FGCO FINISH GRADE CLEAN OUT
- UNO UNLESS NOTED OTHERWISE

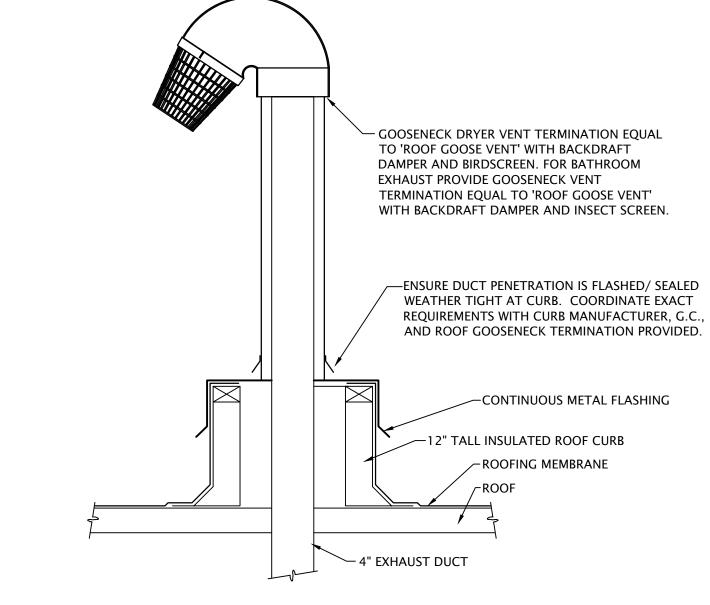

DUCT THROUGH ROOF DETAIL


(2) NO SCALE

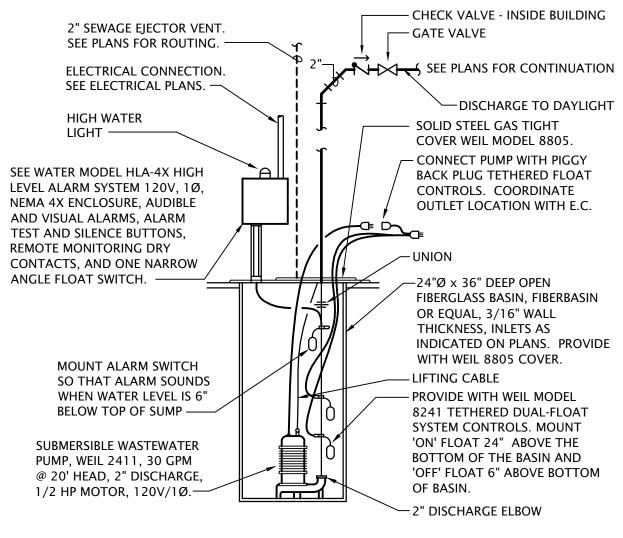

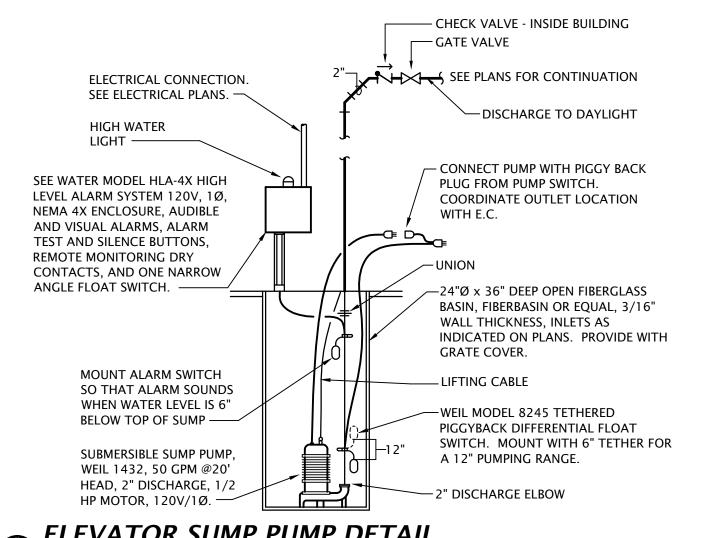

ELEVATOR SUMP PUMP DETAIL

SEWAGE EJECTOR DETAIL

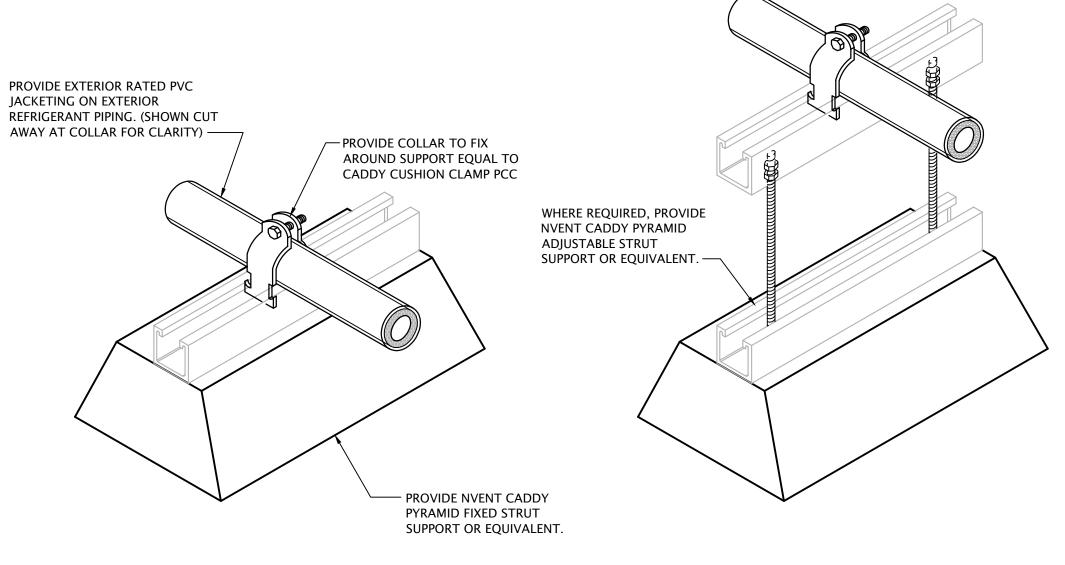

REFRIGERANT LINESET ROOF SUPPORT DETAIL

1" = 20'-0"

January 2024

### GENERAL SITE POWER NOTES

- A. CONTRACTOR SHALL BE RESPONSIBLE FOR ALL CONDUIT AND ASSOCIATED CONDUCTORS.
- B. CONTRACTOR SHALL BE RESPONSIBLE FOR ALL CONDUIT AND ASSOCIATED

### (#) ELECTRICAL SITE PLAN NOTES BY SYMBOL

- 1. POWER COMPANY PAD MOUNTED TRANSFORMER. PROVIDE 8' W x 8' L x 6" D CONCRETE PAD PER AEP TEXAS SERVICE STANDARDS. COORDINATE EXACT LOCATION AND REQUIREMENTS WITH AEP TEXAS PRIOR TO COMMENCING WORK.
- SERVICE LATERAL CABLING. COORDINATE ROUTING WITH AEP TEXAS.
- 5. EXISTING UTILITY POLE TO BE UTILIZED FOR NEW PRIMARY SERVICE DROP. COORDINATE
- 6. (2) 4" CONDUITS BELOW GRADE FOR COMMUNICATIONS SERVICES. PROVIDE PULLSTRING
- 7. EXISTING ELECTRIC UTILITY 3-PHASE OVERHEAD PRIMARY DISTRIBUTION TO REMAIN.
- 8. SEE SHEET E1.7 FOR CONTINUATION INSIDE BUILDING.
- 9. ELECTRICAL UTILITY SERVICE TAP BOX. SEE RISER DIAGRAM, SHEET E6.1.
- AS POSSIBLE. COORDINATE LOCATION WITH G.C. SEAL WEATHER TIGHT.
- 11. MAKE FINAL CONNECTION TO OWNER PROVIDED SINGLE PORT EV CHARGING STATION EQUIPMENT. VERIFY EXACT REQUIREMENTS WITH MANUFACTURER'S INSTRUCTIONS.
- 12. MOUNT RECEPTACLE ON BOLLARD 18" AFG. COORDINATE EXACT LOCATION AND REQUIREMENTS WITH G.C.
- 13. ROUTE CIRCUIT THROUGH CONTACTOR 'C4'. RE: 5/E6.1.

- TRENCHING AND BACKFILL REQUIRED FOR UNDERGROUND ELECTRICAL UTILITY PRIMARY CABLE. POWER COMPANY SHALL FURNISH, INSTALL, AND TERMINATE ALL
- TRENCHING AND BACKFILL REQUIRED FOR UNDERGROUND ELECTRICAL SERVICE LATERALS FROM UTILITY TRANSFORMERS TO SERVICE EQUIPMENT AT BUILDING EXTERIORS. POWER COMPANY SHALL FURNISH, INSTALL, AND TERMINATE ALL
- C. ALL CONDUIT BELOW GRADE SHALL BE SCHEDULE 40 PVC. ALL CONDUIT ABOVE GRADE SHALL BE SCHEDULE 80 PVC.
- D. ALL CONDUIT TRENCHES MUST BE INSPECTED BY AEP BEFORE BACKFILLING.

- 2. EXISTING UTILITY POLE TO REMAIN, SHOWN FOR REFERENCE ONLY.
- 3. 4" CONDUIT WITH PULL ROPE BELOW GRADE FOR POWER COMPANY PROVIDED PRIMARY CABLING. COORDINATE ROUTING WITH AEP TEXAS.
- 4. (4) 4" CONDUITS WITH PULL ROPE BELOW GRADE FOR POWER COMPANY PROVIDED
- PRIMARY CONDUIT STUB-UP WITH POWER COMPANY.

- 10. PENETRATE EXTERIOR WALL WITH WEATHERPROOF CONDUIT BODIES AS LOW TO GROUND

1-16-2024

1-16-2024 21-3166 SHEET NO .:

E1.0

## **ELECTRICAL PLAN NOTES BY SYMBOL**

- 1. CONNECT EXHAUST FAN PROVIDED BY MECHANICAL CONTRACTOR.
- 3. PROVIDE 60A/2P DISCONNECT SWITCH AND CONNECT TO BLOWER COIL WITH ELECTRIC HEAT. SEE EQUIPMENT SCHEDULE FOR MORE INFORMATION. COORDINATE REQUIREMENTS WITH M.C.
- 4. SPLIT-WIRE DUPLEX RECEPTACLE BELOW COUNTER. TOP HALF OF RECEPTACLE TO BE SWITCHED FOR CONTROL OF GARBAGE DISPOSAL. BOTTOM HALF OF RECEPTACLE TO BE WIRED UNSWITCHED FOR DISHWASHER. RECEPTACLE SHALL BE LOCATED IN BACK OF BASE CABINET ADJACENT TO DISHWASHER TO ALLOW ACCESS. PROVIDE CORDS AND GROUNDING PLUGS AS REQUIRED FOR DISPOSER AND DISHWASHER .
- PROVIDE 120V CONNECTION TO MICROWAVE/RANGE HOOD. STANDARD AND ADAPTABLE UNITS WILL HAVE MICROWAVE ABOVE RANGE. ACCESSIBLE UNITS WILL HAVE RANGE HOOD. COORDINATE EXACT ELECTRICAL ROUGH-IN REQUIREMENTS WITH EQUIPMENT PROVIDED. IF EQUIPMENT IS CORD AND PLUG, PROVIDE RECEPTACLE INSIDE CABINET ABOVE RANGE.
- 6. PROVIDE SWITCH IN ACCESSIBLE UNITS FOR CONTROL OF RANGE HOOD.
- 7. IN ACCESSIBLE UNITS, INSTALL COUNTERTOP RECEPTACLES A MINIMUM 36" AWAY REQUIREMENT, INSTALL RECEPTACLE AS FAR FROM CORNER AS POSSIBLE.PROVIDE ADDITIONAL OUTLETS WITHIN 36" OF CORNER TO ENSURE COMPLIANCE WITH NEC SPACING REQUIREMENTS.
- 8. SWITCH CLOSEST TO DOOR SHALL CONTROL ALL LIGHTS IN BATHROOM, AND THE
- 10. PROVIDE TIMER SWITCH EQUAL TO AIR CYCLER 'SMART EXHAUST' FOR CONTROL OF EXHAUST FAN. SET SWITCH PER MANUFACTURER'S INSTRUCTIONS TO OPERATE FAN AS INDICATED BELOW:
  - 1 BEDROOM: 20 MINUTES PER HOUR
- 11. ROUTE 120V CIRCUIT FOR HOT WATER RECIRCULATION PUMP ('HWP') THROUGH FINAL FLEXIBLE CONNECTION. COORDINATE WITH PLUMBING CONTRACTOR.
- 12. CONNECT UNBALANCED PORTION OF WATER HEATER LOAD TO PHASE LEG INDICATED.
- 13. (3) #12, #12G, 1/2"C FROM ASSOCIATED OUTDOOR UNIT ON ROOF. SEE SHEET E1.7.
- PROTECTION) IN NEMA 1 ENCLOSURE, P&S #7803W OR EQUAL. MOUNT ADJACENT TO UNIT AND MAKE FINAL FLEXIBLE CONNECTION TO EQUIPMENT.
- 16. 30A/2P DISCONNECT SWITCH WITH SOLID NEUTRAL AND (1) 20A DUAL-ELEMENT, TIME WITH CIRCUIT NUMBER. COORDINATE EXACT MOUNTING LOCATION AND ELEVATOR DOOR JAMB.
- DUAL ELEMENT, TIME DELAY CLASS 'J' FUSES, 120V CONTROL TRANSFORMER, FIRE ALARM SAFETY INTERFACE RELAY, KEY TEST SWITCH, GREEN PILOT LIGHT, AUXILIARY CONTACTS FOR ELEVATOR RECALL, AND FIRE ALARM VOLTAGE MONITORING RELAY. COOPER BUSSMAN #PS-1-T20-R1-K-G-B-F1 OR EQUAL. COORDINATE EXACT MOUNTING
- 18. 3-PHASE POWER FEEDER AND (2) #18 STRANDED CU CONDUCTORS FROM ELEVATOR
- 20. INSTALL LIGHT AND RECEPTACLE ON WALL OF ELEVATOR PIT. VERIFY EXACT LOCATION LADDER AT 48" ABOVE FLOOR LANDING.
- 21. INSTALL LIGHT AND RECEPTACLE ON WALL NEAR TOP OF ELEVATOR HOISTWAY. VERIFY EXACT LOCATION WITH ELEVATOR EQUIPMENT INSTALLER. INSTALL LIGHT SWITCH ADJACENT ENTRY AT 48" ABOVE FLOOR LANDING.
- 22. SWITCH EXHAUST FAN WITH ROOM LIGHTS.
- 25. ELEVATOR SUMP PUMP ALARM PANEL IN CLOSET BELOW STAIR LANDING. PROVIDE 120V POWER CONNECTION AND 1" CONDUIT WITH PULL STRING STUBBED INTO ELEVATOR PIT FOR CONTROL CABLING. COORDINATE ALL WORK WITH PLUMBING
- 26. MOUNT LIGHT FIXTURE FOR CLOSET BELOW STAIR LANDING. MOUNT TO STRUCTURE.
- 27. ROUTE DRYER CIRCUIT THROUGH CURRENT SWITCH FOR OPERATION OF OUTSIDE AIR INTAKE HOOD. HOOD DAMPER SHALL OPEN WHEN ANY DRYER IS OPERATING. SEE
- 29. PROVIDE 120V POWER CONNECTION TO SEWAGE EJECTOR ALARM PANEL AND SIMPLEX RECEPTACLE FOR POWER TO SEWAGE EJECTOR PUMP. COORDINATE REQUIREMENTS WITH G.C. AND PLUMBING CONTRACTOR.
- 30. PROVIDE DOOR ANNUNCIATOR SYSTEM A/V HORN/STROBE DEVICE AND LOW VOLTAGE TRANSFORMER AT ALL ACCESSIBLE APARTMENTS AND ALSO AT APARTMENTS DESIGNATED HEARING-IMPAIRED. INSTALL HORN/STROBE APPLIANCE AT 80" AFF. INSTALL TRANSFORMER IN DOUBLE GANG JUNCTION BOX ABOVE HORN/STROBE WITH BLANK COVER PLATE AND PROVIDE LOW VOLTAGE CONTROL WIRING. SEE DETAIL 3, SHEET E6.2. PROVIDE ENGRAVED SIGN AT THE HORN/STROBE DEVICE TO READ
- APARTMENTS AND ALSO AT APARTMENTS DESIGNATED FOR HEARING-IMPAIRED. REFER TO ARCH DRAWINGS FOR APPLICABLE ROOMS. SEE DETAIL 3, SHEET E6.2.
- 32. IN ADA/ACCESSIBLE UNITS, DISPOSER SWITCH SHALL BE COUNTERTOP MOUNTED, AIR ACTIVATED PUSH BUTTON TYPE, FINISH TO MATCH SINK. COORDINATE EXACT LOCATION OF PUSH BUTTON WITH ARCHITECT.
- 33. RELAY FOR CONTROL OF MOTORIZED INTAKE HOOD ON ROOF. SEE 2/E6.2.
- 37. PRESET SLIDE DIMMER, 0-10V, LEVITON #IP710-DLZ OR EQUAL. COORDINATE DEVICE COLOR WITH ARCHITECT.
- CONTROLLED RECEPTACLE SHALL BE MARKED IN ACCORDANCE WITH NEC 406.3(E).



SEE SHEET E1.5 FOR GENERAL ELECTRICAL NOTES

METER →

UTILITY

SERVICE

\_\_\_\_\_\_


PARTIAL FIRST FLOOR ELECTRICAL PLAN

1/4" = 1'-0"

TAP BOX -

- 2. PROVIDE 30A/2P SNAP SWITCH AND CONNECT WATER HEATER.

- FROM CORNER PER FAIR HOUSING ACT DESIGN MANUAL CHAPTER 5 'SIDE REACH OVER AN OBSTRUCTION' REQUIREMENTS. WHERE AN OBSTRUCTION PREVENTS 36" DISTANCE
- OTHER SWITCH SHALL CONTROL THE EXHAUST FAN.
- 9. PROVIDE PRESET SLIDE DIMMER COMPATIBLE WITH ASSOCIATED LIGHT FIXTURES.
- 2 BEDROOM: 35 MINUTES PER HOUR
- ADJACENT AQUASTAT. PROVIDE 20A/1P SNAP SWITCH ADJACENT TO PUMP AND MAKE
- 14. 30A/3P MANUAL MOTOR CONTROLLER SNAP SWITCH (WITHOUT OVERLOAD
- 15. AT RECEPTACLES ABOVE KITCHEN COUNTERS IN ACCESSIBLE UNITS (#109 & #203, PROVIDE 1" DEEP FLUSH TYPE EXTENSION ADAPTER, WIREMOLD #V5751WH, TO BRING RECEPTACLE CLOSER TO COUNTERTOP EDGE TO COMPLY WITH 24" SIDE REACH
- DELAY FUSE IN NEMA 1 ENCLOSURE FOR ELEVATOR CAB LIGHTS & EXHAUST. SWITCH SHALL BE CAPABLE OF BEING LOCKED "OFF". MOUNT AT 6'-0" AFF TO TOP AND LABEL REQUIREMENTS WITH ELEVATOR EQUIPMENT INSTALLER. PROVIDE FINAL ELECTRICAL CONNECTION TO INSPECTION AND TEST PANEL (LDU) AT TOP OF 3RD FLOOR WITHIN
- 17. ELEVATOR POWER MODULE SWITCH: 100A/208V/3P SWITCH COMPLETE WITH 70A LOCATION AND REQUIREMENTS WITH ELEVATOR EQUIPMENT INSTALLER.
- POWER MODULE SWITCH TO 'JH1' DISCONNECT SWITCH.
- 19. 100A/3P NON-FUSED DISCONNECT SWITCH (JH1) IN NEMA 1 ENCLOSURE. PROVIDE WITH SPST AUXILIARY CONTACTS RATED FOR MIN 2A AT 24VDC. MAKE FINAL CONNECTION TO ELEVATOR FUSE BOX. COORDINATE MOUNTING LOCATION AT TOP OF HOISTWAY AND REQUIREMENTS WITH ELEVATOR EQUIPMENT INSTALLER.
- WITH ELEVATOR EQUIPMENT INSTALLER. INSTALL LIGHT SWITCH ADJACENT TO PIT
- 23. ROUTE CIRCUIT THROUGH CONTACTOR INDICATED. SEE 5/E6.1.
- 24. SIMPLEX RECEPTACLE IN ELEVATOR PIT FOR ELEVATOR SUMP PUMP. COORDINATE EXACT MOUNTING LOCATION WITH PLUMBING CONTRACTOR AND ELEVATOR EQUIPMENT INSTALLER.
- DETAIL 2/E6.2.
- 28. COORDINATE EXACT MOUNTING LOCATION OF DRINKING FOUNTAIN RECEPTACLE WITH
- 31. PROVIDE PUSH BUTTON AT 48" AFF FOR ANNUNCIATOR SYSTEM AT ALL ACCESSIBLE
- 34. TIMECLOCK AND CONTACTORS FOR LIGHTING AND RECEPTACLE CONTROL. RE: 5/E6.1.
- 35. 2-HOUR DIAL TIMER OVERRIDE SWITCH FOR SWITCHED RECEPTACLES. SEE 5/E6.1 36. LINE VOLTAGE CEILING OCCUPANCY SENSOR/PHOTOCELL WITH DAYLIGHT HARVESTING CAPABILITY. SENSOR SHALL DIM 0-10V LIGHTS WHEN ADEQUATE DAYLIGHT IS PRESENT. SENSORWORX #SWX-2-3-1-2-D OR EQUAL.
- 38. ONE RECEPTACLE SHALL BE CONNECTED TO CIRCUIT #44 (UNCONTROLLED) AND THE OTHER RECEPTACLES SHALL BE CONNECTED TO CIRCUIT #46 (CONTROLLED).

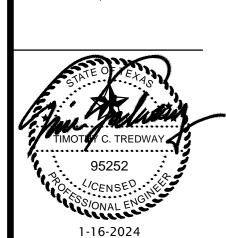

**REVISION:** 

21-3166 SHEET NO.:


1-16-2024

316.285.0696

January 2024

### **ELECTRICAL PLAN NOTES BY SYMBOL**

- 1. CONNECT EXHAUST FAN PROVIDED BY MECHANICAL CONTRACTOR.
- 2. PROVIDE 30A/2P SNAP SWITCH AND CONNECT WATER HEATER.
- 3. PROVIDE 60A/2P DISCONNECT SWITCH AND CONNECT TO BLOWER COIL WITH ELECTRIC HEAT. SEE EQUIPMENT SCHEDULE FOR MORE INFORMATION. COORDINATE REQUIREMENTS WITH M.C.
- 4. SPLIT-WIRE DUPLEX RECEPTACLE BELOW COUNTER. TOP HALF OF RECEPTACLE TO BE SWITCHED FOR CONTROL OF GARBAGE DISPOSAL. BOTTOM HALF OF RECEPTACLE TO BE WIRED UNSWITCHED FOR DISHWASHER. RECEPTACLE SHALL BE LOCATED IN BACK OF BASE CABINET ADJACENT TO DISHWASHER TO ALLOW ACCESS. PROVIDE CORDS AND GROUNDING PLUGS AS REQUIRED FOR DISPOSER AND DISHWASHER
- 5. PROVIDE 120V CONNECTION TO MICROWAVE/RANGE HOOD. STANDARD AND ADAPTABLE UNITS WILL HAVE MICROWAVE ABOVE RANGE. ACCESSIBLE UNITS WILL HAVE RANGE HOOD. COORDINATE EXACT ELECTRICAL ROUGH-IN REQUIREMENTS WITH EQUIPMENT PROVIDED. IF EQUIPMENT IS CORD AND PLUG, PROVIDE RECEPTACLE INSIDE CABINET ABOVE RANGE.
- 6. PROVIDE SWITCH IN ACCESSIBLE UNITS FOR CONTROL OF RANGE HOOD.
- 7. IN ACCESSIBLE UNITS, INSTALL COUNTERTOP RECEPTACLES A MINIMUM 36" AWAY FROM CORNER PER FAIR HOUSING ACT DESIGN MANUAL CHAPTER 5 'SIDE REACH OVER AN OBSTRUCTION' REQUIREMENTS. WHERE AN OBSTRUCTION PREVENTS 36" DISTANCE REQUIREMENT, INSTALL RECEPTACLE AS FAR FROM CORNER AS POSSIBLE.PROVIDE ADDITIONAL OUTLETS WITHIN 36" OF CORNER TO ENSURE COMPLIANCE WITH NEC SPACING REQUIREMENTS.
- 8. SWITCH CLOSEST TO DOOR SHALL CONTROL ALL LIGHTS IN BATHROOM, AND THE OTHER SWITCH SHALL CONTROL THE EXHAUST FAN.
- 9. PROVIDE PRESET SLIDE DIMMER COMPATIBLE WITH ASSOCIATED LIGHT FIXTURES.
- 10. PROVIDE TIMER SWITCH EQUAL TO AIR CYCLER 'SMART EXHAUST' FOR CONTROL OF EXHAUST FAN. SET SWITCH PER MANUFACTURER'S INSTRUCTIONS TO OPERATE FAN AS INDICATED BELOW:
  - 1 BEDROOM: 20 MINUTES PER HOUR 2 BEDROOM: 35 MINUTES PER HOUR
- 11. ROUTE 120V CIRCUIT FOR HOT WATER RECIRCULATION PUMP ('HWP') THROUGH ADJACENT AQUASTAT. PROVIDE 20A/1P SNAP SWITCH ADJACENT TO PUMP AND MAKE FINAL FLEXIBLE CONNECTION. COORDINATE WITH PLUMBING CONTRACTOR.
- 12. CONNECT UNBALANCED PORTION OF WATER HEATER LOAD TO PHASE LEG INDICATED.
- 13. (3) #12, #12G, 1/2"C FROM ASSOCIATED OUTDOOR UNIT ON ROOF. SEE SHEET E1.7.
- 14. 30A/3P MANUAL MOTOR CONTROLLER SNAP SWITCH (WITHOUT OVERLOAD PROTECTION) IN NEMA 1 ENCLOSURE, P&S #7803W OR EQUAL. MOUNT ADJACENT TO UNIT AND MAKE FINAL FLEXIBLE CONNECTION TO EQUIPMENT.
- 15. AT RECEPTACLES ABOVE KITCHEN COUNTERS IN ACCESSIBLE UNITS (#109 & #203, PROVIDE 1" DEEP FLUSH TYPE EXTENSION ADAPTER, WIREMOLD #V5751WH, TO BRING RECEPTACLE CLOSER TO COUNTERTOP EDGE TO COMPLY WITH 24" SIDE REACH
- 16. 30A/2P DISCONNECT SWITCH WITH SOLID NEUTRAL AND (1) 20A DUAL-ELEMENT, TIME DELAY FUSE IN NEMA 1 ENCLOSURE FOR ELEVATOR CAB LIGHTS & EXHAUST. SWITCH SHALL BE CAPABLE OF BEING LOCKED "OFF". MOUNT AT 6'-0" AFF TO TOP AND LABEL WITH CIRCUIT NUMBER. COORDINATE EXACT MOUNTING LOCATION AND REOUIREMENTS WITH ELEVATOR EOUIPMENT INSTALLER. PROVIDE FINAL ELECTRICAL CONNECTION TO INSPECTION AND TEST PANEL (LDU) AT TOP OF 3RD FLOOR WITHIN ELEVATOR DOOR JAMB.
- 17. ELEVATOR POWER MODULE SWITCH: 100A/208V/3P SWITCH COMPLETE WITH 70A DUAL ELEMENT, TIME DELAY CLASS 'J' FUSES, 120V CONTROL TRANSFORMER, FIRE ALARM SAFETY INTERFACE RELAY, KEY TEST SWITCH, GREEN PILOT LIGHT, AUXILIARY CONTACTS FOR ELEVATOR RECALL, AND FIRE ALARM VOLTAGE MONITORING RELAY. COOPER BUSSMAN #PS-1-T20-R1-K-G-B-F1 OR EQUAL. COORDINATE EXACT MOUNTING LOCATION AND REQUIREMENTS WITH ELEVATOR EQUIPMENT INSTALLER.
- 18. 3-PHASE POWER FEEDER AND (2) #18 STRANDED CU CONDUCTORS FROM ELEVATOR POWER MODULE SWITCH TO 'JH1' DISCONNECT SWITCH.
- 19. 100A/3P NON-FUSED DISCONNECT SWITCH (JH1) IN NEMA 1 ENCLOSURE. PROVIDE WITH SPST AUXILIARY CONTACTS RATED FOR MIN 2A AT 24VDC. MAKE FINAL CONNECTION TO ELEVATOR FUSE BOX. COORDINATE MOUNTING LOCATION AT TOP OF HOISTWAY AND REQUIREMENTS WITH ELEVATOR EQUIPMENT INSTALLER.
- 20. INSTALL LIGHT AND RECEPTACLE ON WALL OF ELEVATOR PIT. VERIFY EXACT LOCATION WITH ELEVATOR EQUIPMENT INSTALLER. INSTALL LIGHT SWITCH ADJACENT TO PIT LADDER AT 48" ABOVE FLOOR LANDING.
- 21. INSTALL LIGHT AND RECEPTACLE ON WALL NEAR TOP OF ELEVATOR HOISTWAY. VERIFY EXACT LOCATION WITH ELEVATOR EQUIPMENT INSTALLER. INSTALL LIGHT SWITCH ADJACENT ENTRY AT 48" ABOVE FLOOR LANDING.
- 22. SWITCH EXHAUST FAN WITH ROOM LIGHTS.
- 23. ROUTE CIRCUIT THROUGH CONTACTOR INDICATED. SEE 5/E6.1.
- 24. SIMPLEX RECEPTACLE IN ELEVATOR PIT FOR ELEVATOR SUMP PUMP. COORDINATE EXACT MOUNTING LOCATION WITH PLUMBING CONTRACTOR AND ELEVATOR EQUIPMENT INSTALLER.
- 25. ELEVATOR SUMP PUMP ALARM PANEL IN CLOSET BELOW STAIR LANDING. PROVIDE 120V POWER CONNECTION AND 1" CONDUIT WITH PULL STRING STUBBED INTO ELEVATOR PIT FOR CONTROL CABLING. COORDINATE ALL WORK WITH PLUMBING
- 26. MOUNT LIGHT FIXTURE FOR CLOSET BELOW STAIR LANDING. MOUNT TO STRUCTURE.
- 27. ROUTE DRYER CIRCUIT THROUGH CURRENT SWITCH FOR OPERATION OF OUTSIDE AIR INTAKE HOOD. HOOD DAMPER SHALL OPEN WHEN ANY DRYER IS OPERATING. SEE DETAIL 2/E6.2.
- 28. COORDINATE EXACT MOUNTING LOCATION OF DRINKING FOUNTAIN RECEPTACLE WITH PLUMBING CONTRACTOR.
- 29. PROVIDE 120V POWER CONNECTION TO SEWAGE EJECTOR ALARM PANEL AND SIMPLEX RECEPTACLE FOR POWER TO SEWAGE EJECTOR PUMP. COORDINATE REQUIREMENTS WITH G.C. AND PLUMBING CONTRACTOR.
- 30. PROVIDE DOOR ANNUNCIATOR SYSTEM A/V HORN/STROBE DEVICE AND LOW VOLTAGE TRANSFORMER AT ALL ACCESSIBLE APARTMENTS AND ALSO AT APARTMENTS DESIGNATED HEARING-IMPAIRED. INSTALL HORN/STROBE APPLIANCE AT 80" AFF. INSTALL TRANSFORMER IN DOUBLE GANG JUNCTION BOX ABOVE HORN/STROBE WITH BLANK COVER PLATE AND PROVIDE LOW VOLTAGE CONTROL WIRING. SEE DETAIL 3, SHEET E6.2. PROVIDE ENGRAVED SIGN AT THE HORN/STROBE DEVICE TO READ
- 31. PROVIDE PUSH BUTTON AT 48" AFF FOR ANNUNCIATOR SYSTEM AT ALL ACCESSIBLE APARTMENTS AND ALSO AT APARTMENTS DESIGNATED FOR HEARING-IMPAIRED. REFER TO ARCH DRAWINGS FOR APPLICABLE ROOMS. SEE DETAIL 3, SHEET E6.2.
- 32. IN ADA/ACCESSIBLE UNITS, DISPOSER SWITCH SHALL BE COUNTERTOP MOUNTED, AIR ACTIVATED PUSH BUTTON TYPE, FINISH TO MATCH SINK. COORDINATE EXACT LOCATION OF PUSH BUTTON WITH ARCHITECT.
- 33. RELAY FOR CONTROL OF MOTORIZED INTAKE HOOD ON ROOF. SEE 2/E6.2.
- 34. TIMECLOCK AND CONTACTORS FOR LIGHTING AND RECEPTACLE CONTROL. RE: 5/E6.1.
- 35. 2-HOUR DIAL TIMER OVERRIDE SWITCH FOR SWITCHED RECEPTACLES. SEE 5/E6.1
- 36. LINE VOLTAGE CEILING OCCUPANCY SENSOR/PHOTOCELL WITH DAYLIGHT HARVESTING CAPABILITY. SENSOR SHALL DIM 0-10V LIGHTS WHEN ADEQUATE DAYLIGHT IS PRESENT. SENSORWORX #SWX-2-3-1-2-D OR EQUAL.
- 37. PRESET SLIDE DIMMER, 0-10V, LEVITON #IP710-DLZ OR EQUAL. COORDINATE DEVICE COLOR WITH ARCHITECT.
- 38. ONE RECEPTACLE SHALL BE CONNECTED TO CIRCUIT #44 (UNCONTROLLED) AND THE OTHER RECEPTACLES SHALL BE CONNECTED TO CIRCUIT #46 (CONTROLLED). CONTROLLED RECEPTACLE SHALL BE MARKED IN ACCORDANCE WITH NEC 406.3(E).

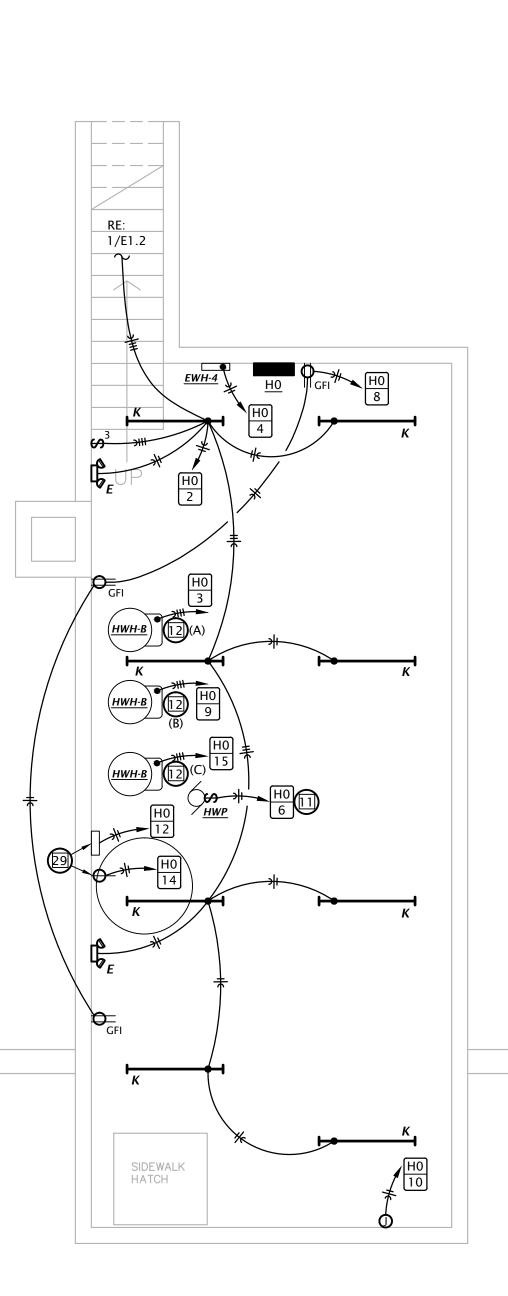

**REVIEWED** for code

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9'-6" AFF

(TYP FOR 18)

compliance

5/30/2024

RE: MA

COMMUNIT'

ROOM

PARTIAL FIRST FLOOR ELECTRICAL PLAN

BASEMENT ELECTRICAL PLAN



95252

1-16-2024

1-16-2024 21-3166

SHEET NO.:

**REVIEWED** for code

compliance

5/30/2024

PARTIAL SECOND FLOOR ELECTRICAL PLAN

1/4" = 1'-0"

785.587.8042 316.285.0696

January 2024

- 2. PROVIDE 30A/2P SNAP SWITCH AND CONNECT WATER HEATER.
- 3. PROVIDE 60A/2P DISCONNECT SWITCH AND CONNECT TO BLOWER COIL WITH ELECTRIC HEAT. SEE EQUIPMENT SCHEDULE FOR MORE INFORMATION. COORDINATE REQUIREMENTS WITH M.C.
- SWITCHED FOR CONTROL OF GARBAGE DISPOSAL. BOTTOM HALF OF RECEPTACLE TO BE WIRED UNSWITCHED FOR DISHWASHER. RECEPTACLE SHALL BE LOCATED IN BACK OF BASE CABINET ADJACENT TO DISHWASHER TO ALLOW ACCESS. PROVIDE CORDS AND GROUNDING PLUGS AS REQUIRED FOR DISPOSER AND DISHWASHER .
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- 6. PROVIDE SWITCH IN ACCESSIBLE UNITS FOR CONTROL OF RANGE HOOD.
- 7. IN ACCESSIBLE UNITS, INSTALL COUNTERTOP RECEPTACLES A MINIMUM 36" AWAY FROM CORNER PER FAIR HOUSING ACT DESIGN MANUAL CHAPTER 5 'SIDE REACH OVER AN OBSTRUCTION' REQUIREMENTS. WHERE AN OBSTRUCTION PREVENTS 36" DISTANCE REOUIREMENT, INSTALL RECEPTACLE AS FAR FROM CORNER AS POSSIBLE, PROVIDE ADDITIONAL OUTLETS WITHIN 36" OF CORNER TO ENSURE COMPLIANCE WITH NEC
- 8. SWITCH CLOSEST TO DOOR SHALL CONTROL ALL LIGHTS IN BATHROOM, AND THE OTHER SWITCH SHALL CONTROL THE EXHAUST FAN.
- 10. PROVIDE TIMER SWITCH EQUAL TO AIR CYCLER 'SMART EXHAUST' FOR CONTROL OF EXHAUST FAN. SET SWITCH PER MANUFACTURER'S INSTRUCTIONS TO OPERATE FAN AS INDICATED BELOW:
  - 1 BEDROOM: 20 MINUTES PER HOUR 2 BEDROOM: 35 MINUTES PER HOUR
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- 13. (3) #12, #12G, 1/2"C FROM ASSOCIATED OUTDOOR UNIT ON ROOF. SEE SHEET E1.7.
- PROTECTION) IN NEMA 1 ENCLOSURE, P&S #7803W OR EQUAL. MOUNT ADJACENT TO UNIT AND MAKE FINAL FLEXIBLE CONNECTION TO EQUIPMENT.
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- ELEVATOR DOOR JAMB. 17. ELEVATOR POWER MODULE SWITCH: 100A/208V/3P SWITCH COMPLETE WITH 70A DUAL ELEMENT, TIME DELAY CLASS 'J' FUSES, 120V CONTROL TRANSFORMER, FIRE ALARM SAFETY INTERFACE RELAY, KEY TEST SWITCH, GREEN PILOT LIGHT, AUXILIARY CONTACTS FOR ELEVATOR RECALL, AND FIRE ALARM VOLTAGE MONITORING RELAY.
- LOCATION AND REQUIREMENTS WITH ELEVATOR EQUIPMENT INSTALLER. 18. 3-PHASE POWER FEEDER AND (2) #18 STRANDED CU CONDUCTORS FROM ELEVATOR
- 21. INSTALL LIGHT AND RECEPTACLE ON WALL NEAR TOP OF ELEVATOR HOISTWAY. VERIFY EXACT LOCATION WITH ELEVATOR EQUIPMENT INSTALLER. INSTALL LIGHT SWITCH ADJACENT ENTRY AT 48" ABOVE FLOOR LANDING.
- 22. SWITCH EXHAUST FAN WITH ROOM LIGHTS.
- 25. ELEVATOR SUMP PUMP ALARM PANEL IN CLOSET BELOW STAIR LANDING. PROVIDE 120V POWER CONNECTION AND 1" CONDUIT WITH PULL STRING STUBBED INTO ELEVATOR PIT FOR CONTROL CABLING. COORDINATE ALL WORK WITH PLUMBING
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- 27. ROUTE DRYER CIRCUIT THROUGH CURRENT SWITCH FOR OPERATION OF OUTSIDE AIR
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- WITH G.C. AND PLUMBING CONTRACTOR.
- 30. PROVIDE DOOR ANNUNCIATOR SYSTEM A/V HORN/STROBE DEVICE AND LOW VOLTAGE TRANSFORMER AT ALL ACCESSIBLE APARTMENTS AND ALSO AT APARTMENTS DESIGNATED HEARING-IMPAIRED. INSTALL HORN/STROBE APPLIANCE AT 80" AFF. INSTALL TRANSFORMER IN DOUBLE GANG JUNCTION BOX ABOVE HORN/STROBE WITH BLANK COVER PLATE AND PROVIDE LOW VOLTAGE CONTROL WIRING. SEE DETAIL 3, SHEET E6.2. PROVIDE ENGRAVED SIGN AT THE HORN/STROBE DEVICE TO READ
- 31. PROVIDE PUSH BUTTON AT 48" AFF FOR ANNUNCIATOR SYSTEM AT ALL ACCESSIBLE TO ARCH DRAWINGS FOR APPLICABLE ROOMS. SEE DETAIL 3, SHEET E6.2.
- ACTIVATED PUSH BUTTON TYPE, FINISH TO MATCH SINK. COORDINATE EXACT LOCATION OF PUSH BUTTON WITH ARCHITECT.
- 33. RELAY FOR CONTROL OF MOTORIZED INTAKE HOOD ON ROOF. SEE 2/E6.2.
- 35. 2-HOUR DIAL TIMER OVERRIDE SWITCH FOR SWITCHED RECEPTACLES. SEE 5/E6.1
- COLOR WITH ARCHITECT.
- 38. ONE RECEPTACLE SHALL BE CONNECTED TO CIRCUIT #44 (UNCONTROLLED) AND THE OTHER RECEPTACLES SHALL BE CONNECTED TO CIRCUIT #46 (CONTROLLED). CONTROLLED RECEPTACLE SHALL BE MARKED IN ACCORDANCE WITH NEC 406.3(E).

# **ELECTRICAL PLAN NOTES BY SYMBOL**

- 1. CONNECT EXHAUST FAN PROVIDED BY MECHANICAL CONTRACTOR.
- 4. SPLIT-WIRE DUPLEX RECEPTACLE BELOW COUNTER. TOP HALF OF RECEPTACLE TO BE
- 5. PROVIDE 120V CONNECTION TO MICROWAVE/RANGE HOOD. STANDARD AND CABINET ABOVE RANGE.
- SPACING REQUIREMENTS.
- 9. PROVIDE PRESET SLIDE DIMMER COMPATIBLE WITH ASSOCIATED LIGHT FIXTURES.
- FINAL FLEXIBLE CONNECTION. COORDINATE WITH PLUMBING CONTRACTOR.
- 12. CONNECT UNBALANCED PORTION OF WATER HEATER LOAD TO PHASE LEG INDICATED.
- 14. 30A/3P MANUAL MOTOR CONTROLLER SNAP SWITCH (WITHOUT OVERLOAD
- 15. AT RECEPTACLES ABOVE KITCHEN COUNTERS IN ACCESSIBLE UNITS (#109 & #203, PROVIDE 1" DEEP FLUSH TYPE EXTENSION ADAPTER, WIREMOLD #V5751WH, TO BRING RECEPTACLE CLOSER TO COUNTERTOP EDGE TO COMPLY WITH 24" SIDE REACH
- REQUIREMENTS WITH ELEVATOR EQUIPMENT INSTALLER. PROVIDE FINAL ELECTRICAL CONNECTION TO INSPECTION AND TEST PANEL (LDU) AT TOP OF 3RD FLOOR WITHIN
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- POWER MODULE SWITCH TO 'JH1' DISCONNECT SWITCH.
- 19. 100A/3P NON-FUSED DISCONNECT SWITCH (JH1) IN NEMA 1 ENCLOSURE. PROVIDE WITH SPST AUXILIARY CONTACTS RATED FOR MIN 2A AT 24VDC. MAKE FINAL CONNECTION TO ELEVATOR FUSE BOX. COORDINATE MOUNTING LOCATION AT TOP OF HOISTWAY AND REQUIREMENTS WITH ELEVATOR EQUIPMENT INSTALLER.
- 20. INSTALL LIGHT AND RECEPTACLE ON WALL OF ELEVATOR PIT. VERIFY EXACT LOCATION WITH ELEVATOR EQUIPMENT INSTALLER. INSTALL LIGHT SWITCH ADJACENT TO PIT LADDER AT 48" ABOVE FLOOR LANDING.
- 23. ROUTE CIRCUIT THROUGH CONTACTOR INDICATED. SEE 5/E6.1.
- 24. SIMPLEX RECEPTACLE IN ELEVATOR PIT FOR ELEVATOR SUMP PUMP. COORDINATE EXACT MOUNTING LOCATION WITH PLUMBING CONTRACTOR AND ELEVATOR EQUIPMENT INSTALLER.

- INTAKE HOOD. HOOD DAMPER SHALL OPEN WHEN ANY DRYER IS OPERATING. SEE DETAIL 2/E6.2.
- 29. PROVIDE 120V POWER CONNECTION TO SEWAGE EJECTOR ALARM PANEL AND SIMPLEX RECEPTACLE FOR POWER TO SEWAGE EJECTOR PUMP. COORDINATE REQUIREMENTS
- APARTMENTS AND ALSO AT APARTMENTS DESIGNATED FOR HEARING-IMPAIRED. REFER
- 32. IN ADA/ACCESSIBLE UNITS, DISPOSER SWITCH SHALL BE COUNTERTOP MOUNTED, AIR
- 34. TIMECLOCK AND CONTACTORS FOR LIGHTING AND RECEPTACLE CONTROL. RE: 5/E6.1.
- 36. LINE VOLTAGE CEILING OCCUPANCY SENSOR/PHOTOCELL WITH DAYLIGHT HARVESTING CAPABILITY. SENSOR SHALL DIM 0-10V LIGHTS WHEN ADEQUATE DAYLIGHT IS PRESENT. SENSORWORX #SWX-2-3-1-2-D OR EQUAL.
- 37. PRESET SLIDE DIMMER, 0-10V, LEVITON #IP710-DLZ OR EQUAL. COORDINATE DEVICE

95252 1-16-2024

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**REVISION:** 

21-3166 SHEET NO.:

1-16-2024

785.587.8042 316.285.0696

January 2024

# **ELECTRICAL PLAN NOTES BY SYMBOL**

- 1. CONNECT EXHAUST FAN PROVIDED BY MECHANICAL CONTRACTOR.
- 2. PROVIDE 30A/2P SNAP SWITCH AND CONNECT WATER HEATER.
- 3. PROVIDE 60A/2P DISCONNECT SWITCH AND CONNECT TO BLOWER COIL WITH ELECTRIC HEAT. SEE EQUIPMENT SCHEDULE FOR MORE INFORMATION. COORDINATE REQUIREMENTS WITH M.C.
- 4. SPLIT-WIRE DUPLEX RECEPTACLE BELOW COUNTER. TOP HALF OF RECEPTACLE TO BE SWITCHED FOR CONTROL OF GARBAGE DISPOSAL. BOTTOM HALF OF RECEPTACLE TO BE WIRED UNSWITCHED FOR DISHWASHER. RECEPTACLE SHALL BE LOCATED IN BACK OF BASE CABINET ADJACENT TO DISHWASHER TO ALLOW ACCESS. PROVIDE CORDS AND GROUNDING PLUGS AS REQUIRED FOR DISPOSER AND DISHWASHER.
- 5. PROVIDE 120V CONNECTION TO MICROWAVE/RANGE HOOD. STANDARD AND ADAPTABLE UNITS WILL HAVE MICROWAVE ABOVE RANGE. ACCESSIBLE UNITS WILL HAVE RANGE HOOD. COORDINATE EXACT ELECTRICAL ROUGH-IN REQUIREMENTS WITH EQUIPMENT PROVIDED. IF EQUIPMENT IS CORD AND PLUG, PROVIDE RECEPTACLE INSIDE CABINET ABOVE RANGE.
- 6. PROVIDE SWITCH IN ACCESSIBLE UNITS FOR CONTROL OF RANGE HOOD.
- 7. IN ACCESSIBLE UNITS, INSTALL COUNTERTOP RECEPTACLES A MINIMUM 36" AWAY FROM CORNER PER FAIR HOUSING ACT DESIGN MANUAL CHAPTER 5 'SIDE REACH OVER AN OBSTRUCTION' REQUIREMENTS. WHERE AN OBSTRUCTION PREVENTS 36" DISTANCE REQUIREMENT, INSTALL RECEPTACLE AS FAR FROM CORNER AS POSSIBLE.PROVIDE ADDITIONAL OUTLETS WITHIN 36" OF CORNER TO ENSURE COMPLIANCE WITH NEC SPACING REQUIREMENTS.
- 8. SWITCH CLOSEST TO DOOR SHALL CONTROL ALL LIGHTS IN BATHROOM, AND THE OTHER SWITCH SHALL CONTROL THE EXHAUST FAN.
- 9. PROVIDE PRESET SLIDE DIMMER COMPATIBLE WITH ASSOCIATED LIGHT FIXTURES.
- 10. PROVIDE TIMER SWITCH EQUAL TO AIR CYCLER 'SMART EXHAUST' FOR CONTROL OF EXHAUST FAN. SET SWITCH PER MANUFACTURER'S INSTRUCTIONS TO OPERATE FAN AS INDICATED BELOW:
  - 1 BEDROOM: 20 MINUTES PER HOUR 2 BEDROOM: 35 MINUTES PER HOUR
- 11. ROUTE 120V CIRCUIT FOR HOT WATER RECIRCULATION PUMP ('HWP') THROUGH ADJACENT AQUASTAT. PROVIDE 20A/1P SNAP SWITCH ADJACENT TO PUMP AND MAKE FINAL FLEXIBLE CONNECTION. COORDINATE WITH PLUMBING CONTRACTOR.
- 12. CONNECT UNBALANCED PORTION OF WATER HEATER LOAD TO PHASE LEG INDICATED.
- 13. (3) #12, #12G, 1/2"C FROM ASSOCIATED OUTDOOR UNIT ON ROOF. SEE SHEET E1.7.
- 14. 30A/3P MANUAL MOTOR CONTROLLER SNAP SWITCH (WITHOUT OVERLOAD PROTECTION) IN NEMA 1 ENCLOSURE, P&S #7803W OR EQUAL. MOUNT ADJACENT TO UNIT AND MAKE FINAL FLEXIBLE CONNECTION TO EQUIPMENT.
- 15. AT RECEPTACLES ABOVE KITCHEN COUNTERS IN ACCESSIBLE UNITS (#109 & #203, PROVIDE 1" DEEP FLUSH TYPE EXTENSION ADAPTER, WIREMOLD #V5751WH, TO BRING RECEPTACLE CLOSER TO COUNTERTOP EDGE TO COMPLY WITH 24" SIDE REACH
- 16. 30A/2P DISCONNECT SWITCH WITH SOLID NEUTRAL AND (1) 20A DUAL-ELEMENT, TIME DELAY FUSE IN NEMA 1 ENCLOSURE FOR ELEVATOR CAB LIGHTS & EXHAUST. SWITCH SHALL BE CAPABLE OF BEING LOCKED "OFF". MOUNT AT 6'-0" AFF TO TOP AND LABEL WITH CIRCUIT NUMBER. COORDINATE EXACT MOUNTING LOCATION AND REQUIREMENTS WITH ELEVATOR EQUIPMENT INSTALLER. PROVIDE FINAL ELECTRICAL CONNECTION TO INSPECTION AND TEST PANEL (LDU) AT TOP OF 3RD FLOOR WITHIN ELEVATOR DOOR JAMB.
- 17. ELEVATOR POWER MODULE SWITCH: 100A/208V/3P SWITCH COMPLETE WITH 70A DUAL ELEMENT, TIME DELAY CLASS 'J' FUSES, 120V CONTROL TRANSFORMER, FIRE ALARM SAFETY INTERFACE RELAY, KEY TEST SWITCH, GREEN PILOT LIGHT, AUXILIARY CONTACTS FOR ELEVATOR RECALL, AND FIRE ALARM VOLTAGE MONITORING RELAY. COOPER BUSSMAN #PS-1-T20-R1-K-G-B-F1 OR EQUAL. COORDINATE EXACT MOUNTING LOCATION AND REQUIREMENTS WITH ELEVATOR EQUIPMENT INSTALLER.
- 18. 3-PHASE POWER FEEDER AND (2) #18 STRANDED CU CONDUCTORS FROM ELEVATOR POWER MODULE SWITCH TO 'JH1' DISCONNECT SWITCH.
- 19. 100A/3P NON-FUSED DISCONNECT SWITCH (JH1) IN NEMA 1 ENCLOSURE. PROVIDE WITH SPST AUXILIARY CONTACTS RATED FOR MIN 2A AT 24VDC. MAKE FINAL CONNECTION TO ELEVATOR FUSE BOX. COORDINATE MOUNTING LOCATION AT TOP OF HOISTWAY AND REQUIREMENTS WITH ELEVATOR EQUIPMENT INSTALLER.
- 20. INSTALL LIGHT AND RECEPTACLE ON WALL OF ELEVATOR PIT. VERIFY EXACT LOCATION WITH ELEVATOR EQUIPMENT INSTALLER. INSTALL LIGHT SWITCH ADJACENT TO PIT LADDER AT 48" ABOVE FLOOR LANDING.
- 21. INSTALL LIGHT AND RECEPTACLE ON WALL NEAR TOP OF ELEVATOR HOISTWAY. VERIFY EXACT LOCATION WITH ELEVATOR EQUIPMENT INSTALLER. INSTALL LIGHT SWITCH ADJACENT ENTRY AT 48" ABOVE FLOOR LANDING.
- 22. SWITCH EXHAUST FAN WITH ROOM LIGHTS.

EQUIPMENT INSTALLER.

COLOR WITH ARCHITECT.

4'-0" AFF (2ND FLR)


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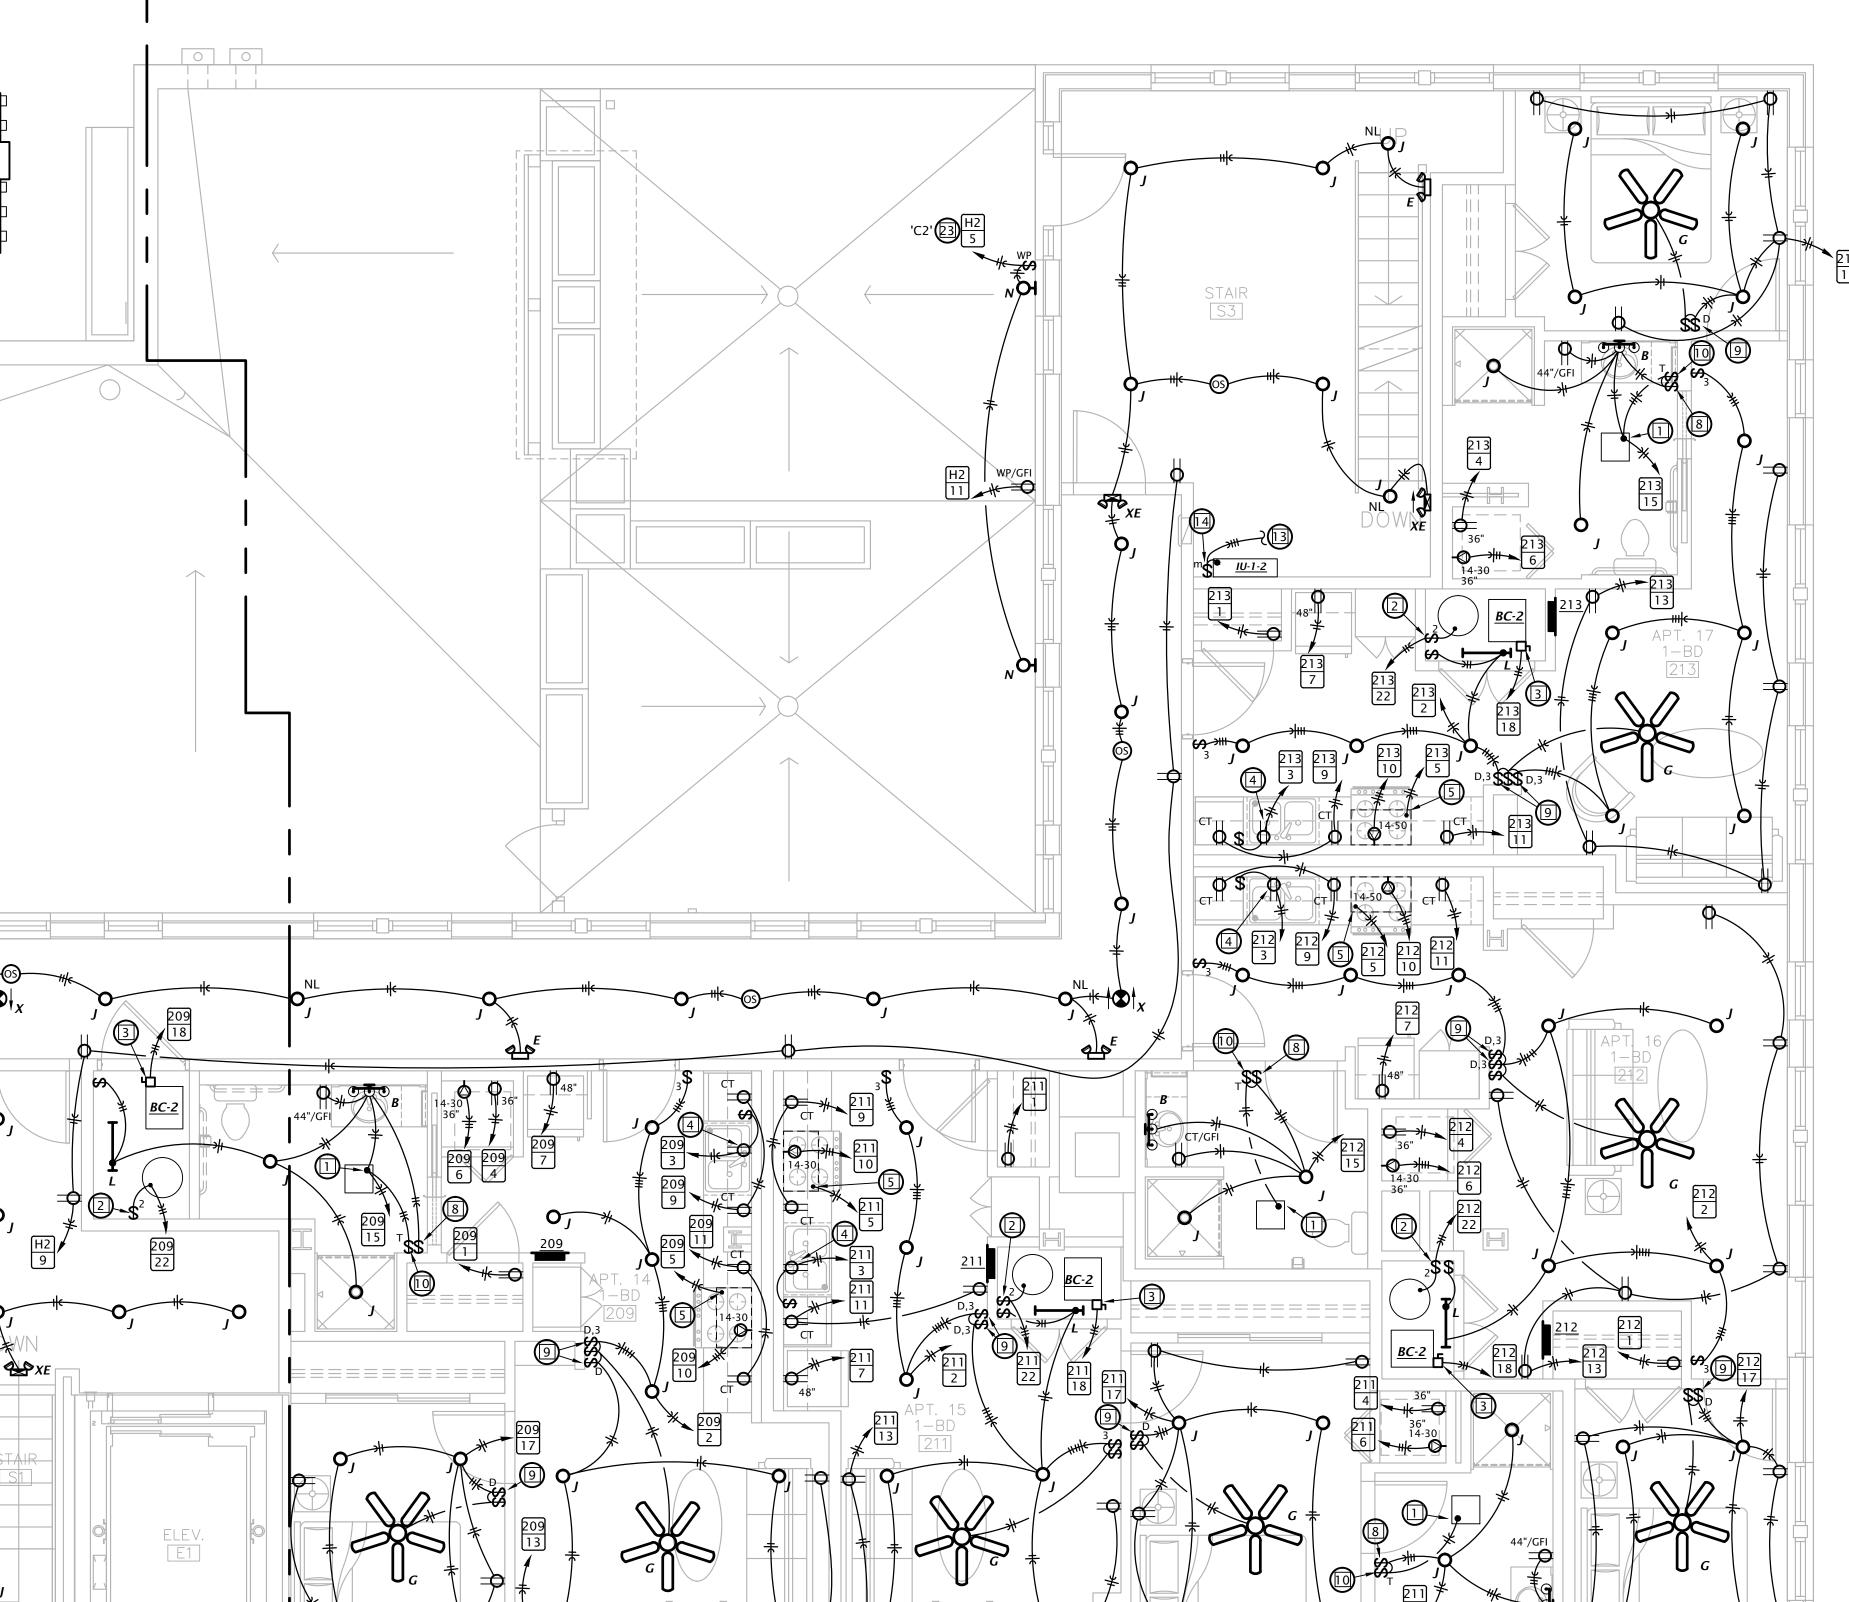
- 23. ROUTE CIRCUIT THROUGH CONTACTOR INDICATED. SEE 5/E6.1. 24. SIMPLEX RECEPTACLE IN ELEVATOR PIT FOR ELEVATOR SUMP PUMP. COORDINATE EXACT MOUNTING LOCATION WITH PLUMBING CONTRACTOR AND ELEVATOR
- 25. ELEVATOR SUMP PUMP ALARM PANEL IN CLOSET BELOW STAIR LANDING. PROVIDE 120V POWER CONNECTION AND 1" CONDUIT WITH PULL STRING STUBBED INTO ELEVATOR PIT FOR CONTROL CABLING. COORDINATE ALL WORK WITH PLUMBING
- 26. MOUNT LIGHT FIXTURE FOR CLOSET BELOW STAIR LANDING. MOUNT TO STRUCTURE.
- 27. ROUTE DRYER CIRCUIT THROUGH CURRENT SWITCH FOR OPERATION OF OUTSIDE AIR INTAKE HOOD. HOOD DAMPER SHALL OPEN WHEN ANY DRYER IS OPERATING. SEE
- 28. COORDINATE EXACT MOUNTING LOCATION OF DRINKING FOUNTAIN RECEPTACLE WITH PLUMBING CONTRACTOR.
- 29. PROVIDE 120V POWER CONNECTION TO SEWAGE EJECTOR ALARM PANEL AND SIMPLEX RECEPTACLE FOR POWER TO SEWAGE EJECTOR PUMP. COORDINATE REQUIREMENTS WITH G.C. AND PLUMBING CONTRACTOR.
- 30. PROVIDE DOOR ANNUNCIATOR SYSTEM A/V HORN/STROBE DEVICE AND LOW VOLTAGE TRANSFORMER AT ALL ACCESSIBLE APARTMENTS AND ALSO AT APARTMENTS DESIGNATED HEARING-IMPAIRED. INSTALL HORN/STROBE APPLIANCE AT 80" AFF. INSTALL TRANSFORMER IN DOUBLE GANG JUNCTION BOX ABOVE HORN/STROBE WITH BLANK COVER PLATE AND PROVIDE LOW VOLTAGE CONTROL WIRING. SEE DETAIL 3, SHEET E6.2. PROVIDE ENGRAVED SIGN AT THE HORN/STROBE DEVICE TO READ
- 31. PROVIDE PUSH BUTTON AT 48" AFF FOR ANNUNCIATOR SYSTEM AT ALL ACCESSIBLE APARTMENTS AND ALSO AT APARTMENTS DESIGNATED FOR HEARING-IMPAIRED. REFER TO ARCH DRAWINGS FOR APPLICABLE ROOMS. SEE DETAIL 3, SHEET E6.2.
- 32. IN ADA/ACCESSIBLE UNITS, DISPOSER SWITCH SHALL BE COUNTERTOP MOUNTED, AIR ACTIVATED PUSH BUTTON TYPE, FINISH TO MATCH SINK. COORDINATE EXACT LOCATION OF PUSH BUTTON WITH ARCHITECT.
- 33. RELAY FOR CONTROL OF MOTORIZED INTAKE HOOD ON ROOF. SEE 2/E6.2.
- 34. TIMECLOCK AND CONTACTORS FOR LIGHTING AND RECEPTACLE CONTROL. RE: 5/E6.1.
- 35. 2-HOUR DIAL TIMER OVERRIDE SWITCH FOR SWITCHED RECEPTACLES. SEE 5/E6.1
- 36. LINE VOLTAGE CEILING OCCUPANCY SENSOR/PHOTOCELL WITH DAYLIGHT HARVESTING CAPABILITY. SENSOR SHALL DIM 0-10V LIGHTS WHEN ADEQUATE DAYLIGHT IS PRESENT. SENSORWORX #SWX-2-3-1-2-D OR EQUAL.
- 37. PRESET SLIDE DIMMER, 0-10V, LEVITON #IP710-DLZ OR EQUAL. COORDINATE DEVICE
- 38. ONE RECEPTACLE SHALL BE CONNECTED TO CIRCUIT #44 (UNCONTROLLED) AND THE OTHER RECEPTACLES SHALL BE CONNECTED TO CIRCUIT #46 (CONTROLLED). CONTROLLED RECEPTACLE SHALL BE MARKED IN ACCORDANCE WITH NEC 406.3(E).

95252

1-16-2024 **REVISION:** 

1-16-2024 21-3166 SHEET NO.:



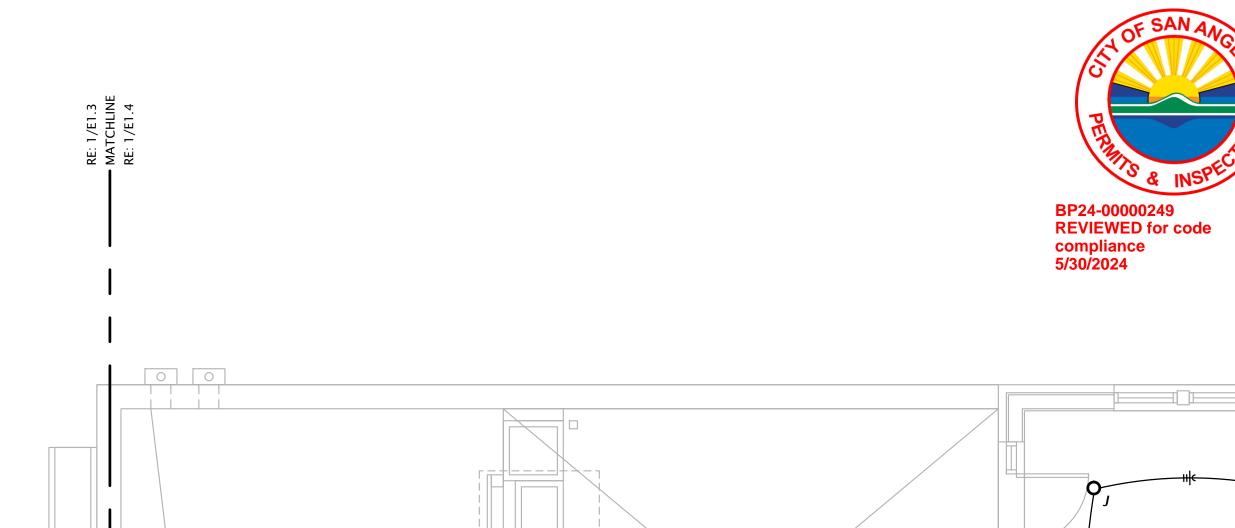

PARTIAL SECOND FLOOR ELECTRICAL PLAN

1/4" = 1'-0"

1-16-2024

DATE: 1-16-2024 21-3166 SHEET NO.:

- ON THE ELECTRICAL CONSTRUCTION DOCUMENTS WITH ARCHITECTURAL, MECHANICAL AND PLUMBING DRAWINGS PRIOR TO FINAL PLACEMENT.
- INFRARED, WITH 2000 SQFT COVERAGE OVER 360° PATTERN. SENSORWORX
- E. IN AREAS WHERE CEILING MOUNTED OCCUPANCY SENSORS ARE USED FOR LIGHTING CONTROL IN CONJUNCTION WITH WALL SWITCHES, OCCUPANCY SENSOR SWITCH LEG SHALL BE WIRED IN SERIES WITH WALL SWITCH(ES) TO PROVIDE OVERRIDE "OFF"
- VERIFY EXACT LOCATIONS OF HVAC AND PLUMBING EQUIPMENT WITH THE GENERAL CONTRACTOR AND ASSOCIATED SUB CONTRACTORS. COORDINATE ELECTRICAL
- G. PROVIDE TAMPER PROOF RECEPTACLES IN DWELLING UNITS PER NEC REQUIREMENTS.
- WIRING SHALL CONSIST OF (2) #16 SOLID CU THHN OR TFN CONDUCTORS. CONDUCTOR INSULATION COLOR SHALL BE VIOLET (+ V-dc) AND PINK ( - V-dc).

- PROVIDED OR SELECTED BY OWNER.

- CONTROL FOR LIGHTS.
- INSTALLATION REQUIRED PRIOR TO COMMENCING ROUGH-IN WORK.
- H. CONTROL WIRING FOR 0-10 V-dc DIMMING SIGNAL CIRCUITS SHALL BE NEC CLASS 1, ROUTED IN SAME RACEWAY/CABLE WITH LIGHTING CIRCUIT POWER CONDUCTORS.

- B. VERIFY EXACT PLACEMENT OF ALL LUMINAIRES, DEVICES, AND EQUIPMENT SHOWN

- 1. CONNECT EXHAUST FAN PROVIDED BY MECHANICAL CONTRACTOR.


  - 2. PROVIDE 30A/2P SNAP SWITCH AND CONNECT WATER HEATER.
  - 3. PROVIDE 60A/2P DISCONNECT SWITCH AND CONNECT TO BLOWER COIL WITH ELECTRIC HEAT. SEE EQUIPMENT SCHEDULE FOR MORE INFORMATION. COORDINATE REQUIREMENTS WITH M.C.

**ELECTRICAL PLAN NOTES BY SYMBOL** 

- 4. SPLIT-WIRE DUPLEX RECEPTACLE BELOW COUNTER. TOP HALF OF RECEPTACLE TO BE SWITCHED FOR CONTROL OF GARBAGE DISPOSAL, BOTTOM HALF OF RECEPTACLE TO BE WIRED UNSWITCHED FOR DISHWASHER. RECEPTACLE SHALL BE LOCATED IN BACK OF BASE CABINET ADJACENT TO DISHWASHER TO ALLOW ACCESS. PROVIDE CORDS AND GROUNDING PLUGS AS REQUIRED FOR DISPOSER AND DISHWASHER.
- 5. PROVIDE 120V CONNECTION TO MICROWAVE/RANGE HOOD. STANDARD AND ADAPTABLE UNITS WILL HAVE MICROWAVE ABOVE RANGE. ACCESSIBLE UNITS WILL HAVE RANGE HOOD. COORDINATE EXACT ELECTRICAL ROUGH-IN REQUIREMENTS WITH EQUIPMENT PROVIDED. IF EQUIPMENT IS CORD AND PLUG, PROVIDE RECEPTACLE INSIDE CABINET ABOVE RANGE.
- 6. PROVIDE SWITCH IN ACCESSIBLE UNITS FOR CONTROL OF RANGE HOOD.
- 7. IN ACCESSIBLE UNITS, INSTALL COUNTERTOP RECEPTACLES A MINIMUM 36" AWAY FROM CORNER PER FAIR HOUSING ACT DESIGN MANUAL CHAPTER 5 'SIDE REACH OVER AN OBSTRUCTION' REQUIREMENTS. WHERE AN OBSTRUCTION PREVENTS 36" DISTANCE REQUIREMENT, INSTALL RECEPTACLE AS FAR FROM CORNER AS POSSIBLE.PROVIDE ADDITIONAL OUTLETS WITHIN 36" OF CORNER TO ENSURE COMPLIANCE WITH NEC SPACING REQUIREMENTS.
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- 11. ROUTE 120V CIRCUIT FOR HOT WATER RECIRCULATION PUMP ('HWP') THROUGH ADJACENT AQUASTAT. PROVIDE 20A/1P SNAP SWITCH ADJACENT TO PUMP AND MAKE FINAL FLEXIBLE CONNECTION. COORDINATE WITH PLUMBING CONTRACTOR.
- 12. CONNECT UNBALANCED PORTION OF WATER HEATER LOAD TO PHASE LEG INDICATED.
- 13. (3) #12, #12G, 1/2"C FROM ASSOCIATED OUTDOOR UNIT ON ROOF. SEE SHEET E1.7. 14. 30A/3P MANUAL MOTOR CONTROLLER SNAP SWITCH (WITHOUT OVERLOAD PROTECTION) IN NEMA 1 ENCLOSURE, P&S #7803W OR EQUAL. MOUNT ADJACENT TO UNIT AND MAKE FINAL FLEXIBLE CONNECTION TO EQUIPMENT.
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EOUIPMENT INSTALLER.

- 23. ROUTE CIRCUIT THROUGH CONTACTOR INDICATED. SEE 5/E6.1. 24. SIMPLEX RECEPTACLE IN ELEVATOR PIT FOR ELEVATOR SUMP PUMP. COORDINATE EXACT MOUNTING LOCATION WITH PLUMBING CONTRACTOR AND ELEVATOR
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PARTIAL THIRD FLOOR ELECTRICAL PLAN

1/4" = 1'-0"

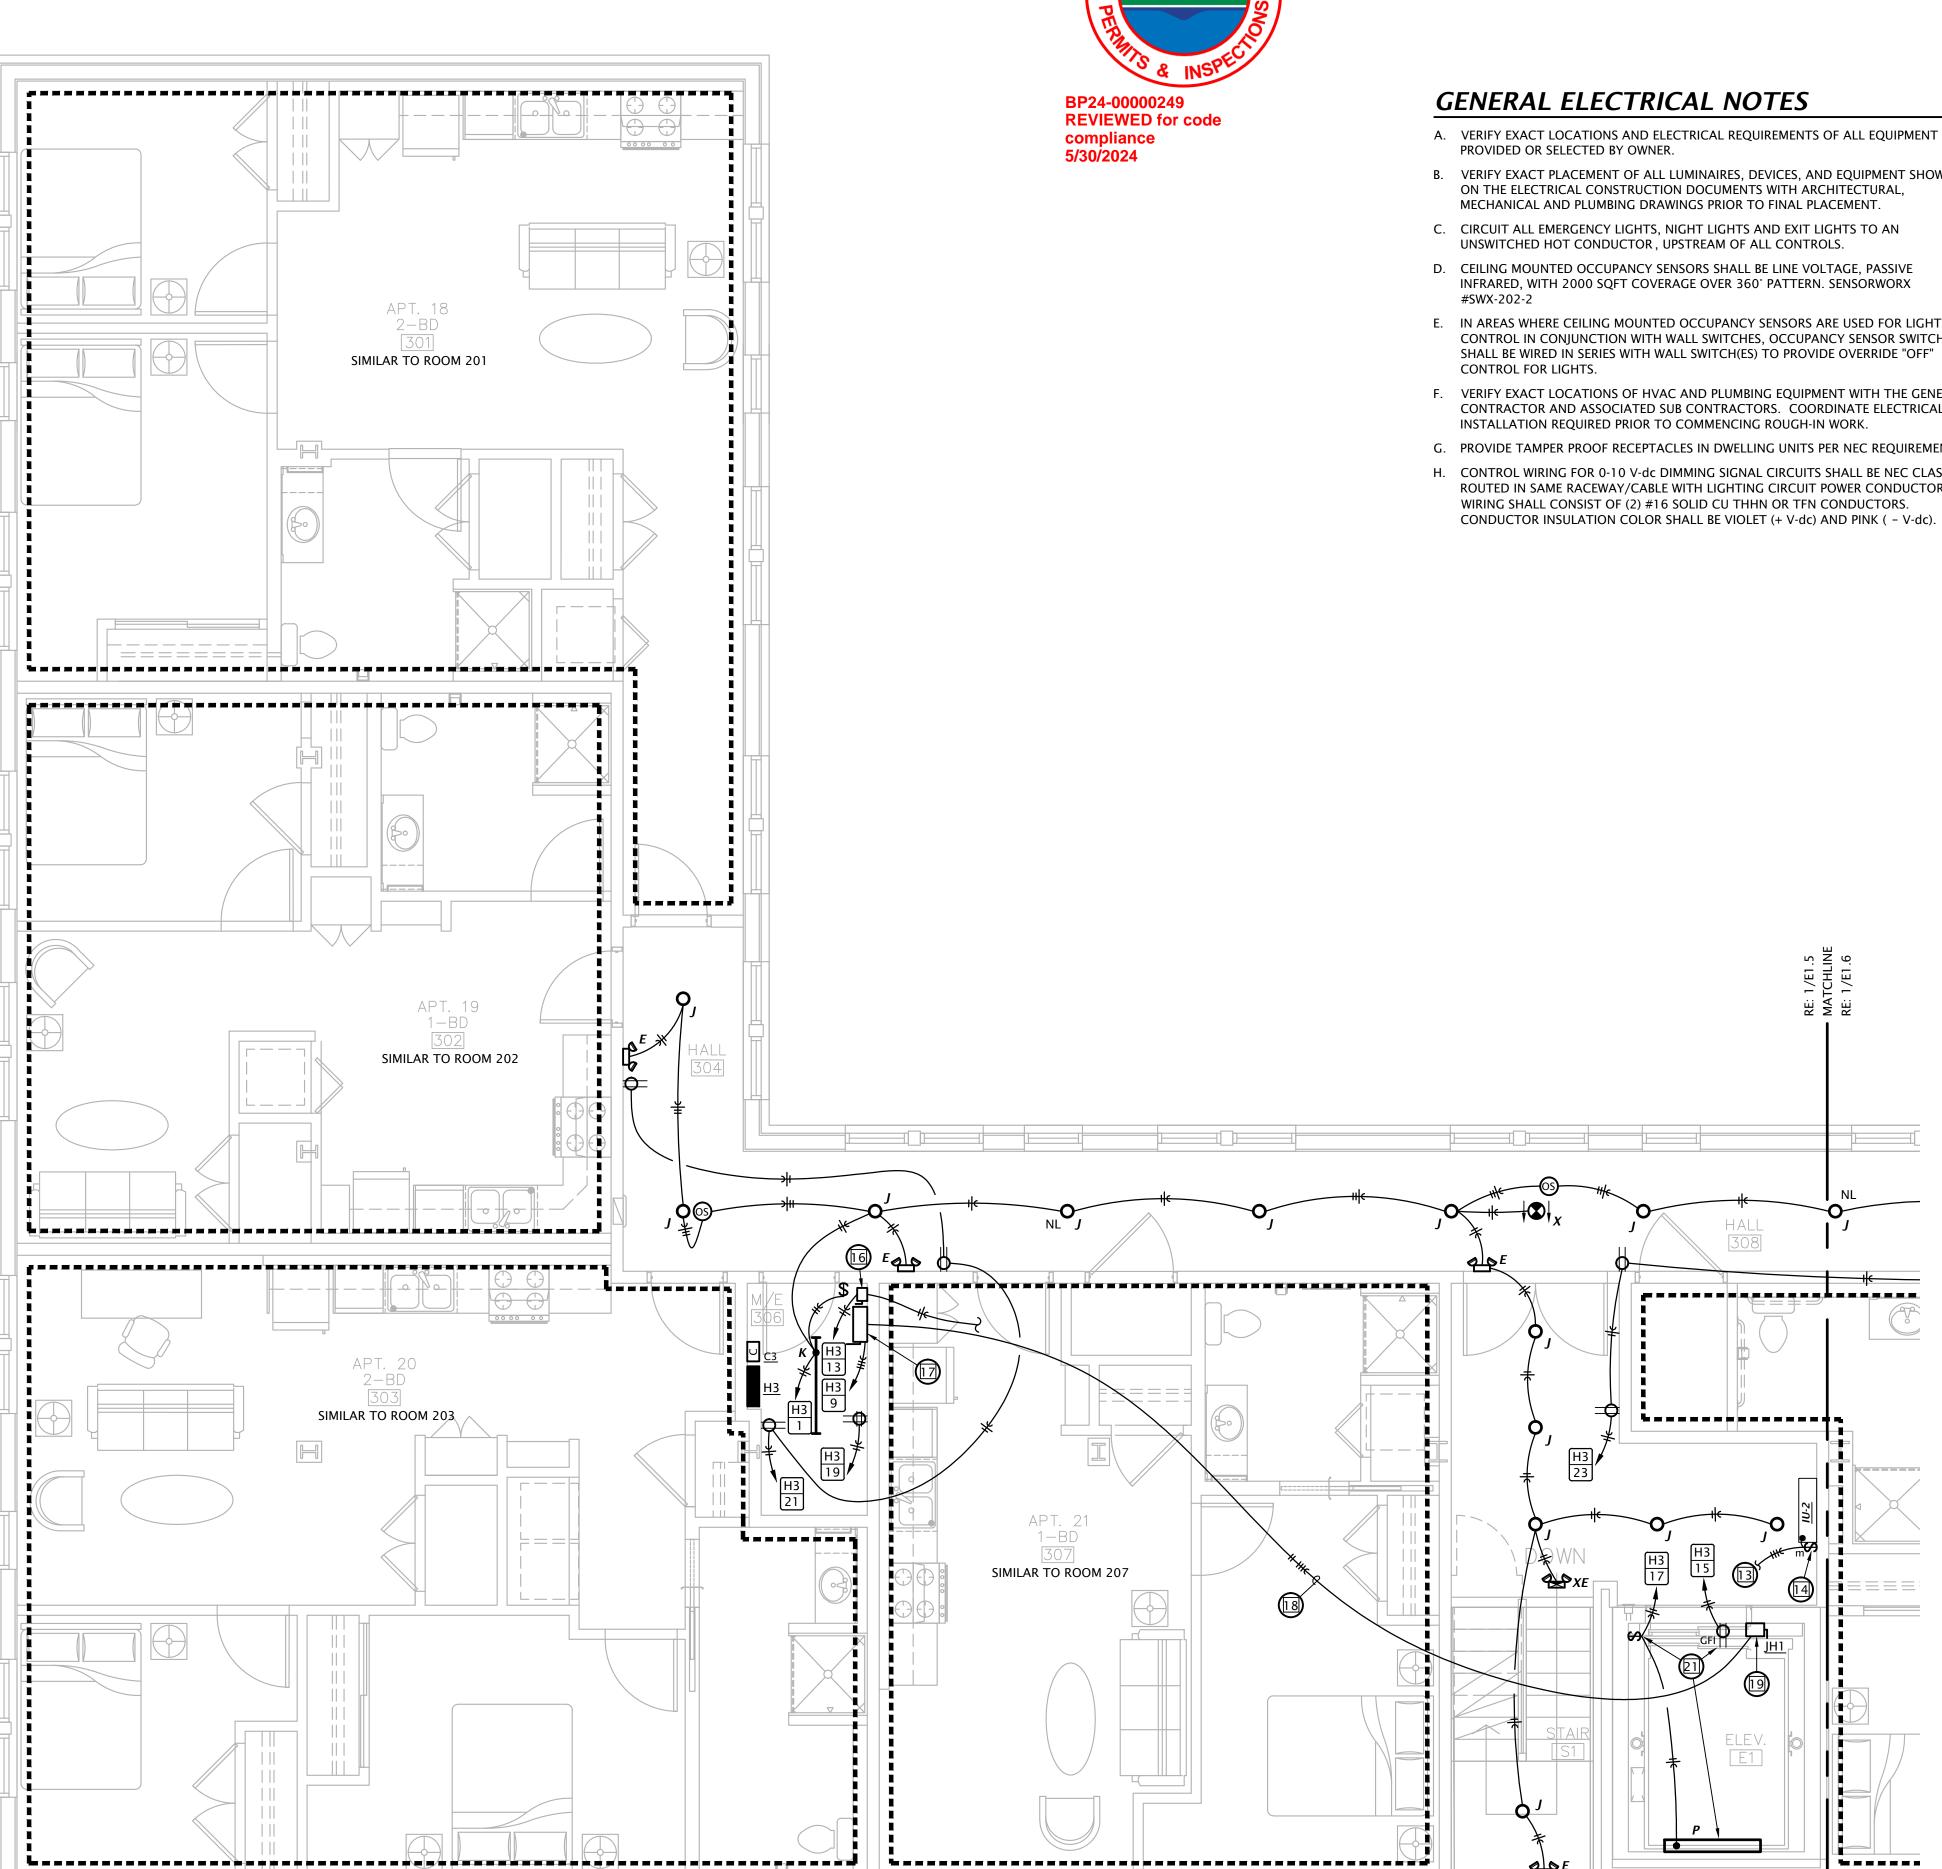
DATE: 1-16-2024 21-3166 SHEET NO .:

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- 18. 3-PHASE POWER FEEDER AND (2) #18 STRANDED CU CONDUCTORS FROM ELEVATOR POWER MODULE SWITCH TO 'JH1' DISCONNECT SWITCH.
- 19. 100A/3P NON-FUSED DISCONNECT SWITCH (JH1) IN NEMA 1 ENCLOSURE. PROVIDE WITH SPST AUXILIARY CONTACTS RATED FOR MIN 2A AT 24VDC. MAKE FINAL CONNECTION TO ELEVATOR FUSE BOX. COORDINATE MOUNTING LOCATION AT TOP OF HOISTWAY AND REQUIREMENTS WITH ELEVATOR EQUIPMENT INSTALLER.
- 20. INSTALL LIGHT AND RECEPTACLE ON WALL OF ELEVATOR PIT. VERIFY EXACT LOCATION WITH ELEVATOR EQUIPMENT INSTALLER. INSTALL LIGHT SWITCH ADJACENT TO PIT LADDER AT 48" ABOVE FLOOR LANDING.
- 21. INSTALL LIGHT AND RECEPTACLE ON WALL NEAR TOP OF ELEVATOR HOISTWAY. VERIFY EXACT LOCATION WITH ELEVATOR EQUIPMENT INSTALLER. INSTALL LIGHT SWITCH ADJACENT ENTRY AT 48" ABOVE FLOOR LANDING.
- 22. SWITCH EXHAUST FAN WITH ROOM LIGHTS.
- 23. ROUTE CIRCUIT THROUGH CONTACTOR INDICATED. SEE 5/E6.1.
- 24. SIMPLEX RECEPTACLE IN ELEVATOR PIT FOR ELEVATOR SUMP PUMP. COORDINATE EXACT MOUNTING LOCATION WITH PLUMBING CONTRACTOR AND ELEVATOR
- 25. ELEVATOR SUMP PUMP ALARM PANEL IN CLOSET BELOW STAIR LANDING. PROVIDE 120V POWER CONNECTION AND 1" CONDUIT WITH PULL STRING STUBBED INTO ELEVATOR PIT FOR CONTROL CABLING. COORDINATE ALL WORK WITH PLUMBING
- 26. MOUNT LIGHT FIXTURE FOR CLOSET BELOW STAIR LANDING. MOUNT TO STRUCTURE.
- 27. ROUTE DRYER CIRCUIT THROUGH CURRENT SWITCH FOR OPERATION OF OUTSIDE AIR INTAKE HOOD. HOOD DAMPER SHALL OPEN WHEN ANY DRYER IS OPERATING. SEE
- 28. COORDINATE EXACT MOUNTING LOCATION OF DRINKING FOUNTAIN RECEPTACLE WITH PLUMBING CONTRACTOR.
- 29. PROVIDE 120V POWER CONNECTION TO SEWAGE EJECTOR ALARM PANEL AND SIMPLEX RECEPTACLE FOR POWER TO SEWAGE EJECTOR PUMP. COORDINATE REQUIREMENTS WITH G.C. AND PLUMBING CONTRACTOR.
- 30. PROVIDE DOOR ANNUNCIATOR SYSTEM A/V HORN/STROBE DEVICE AND LOW VOLTAGE TRANSFORMER AT ALL ACCESSIBLE APARTMENTS AND ALSO AT APARTMENTS DESIGNATED HEARING-IMPAIRED. INSTALL HORN/STROBE APPLIANCE AT 80" AFF. INSTALL TRANSFORMER IN DOUBLE GANG JUNCTION BOX ABOVE HORN/STROBE WITH BLANK COVER PLATE AND PROVIDE LOW VOLTAGE CONTROL WIRING. SEE DETAIL 3, SHEET E6.2. PROVIDE ENGRAVED SIGN AT THE HORN/STROBE DEVICE TO READ
- 31. PROVIDE PUSH BUTTON AT 48" AFF FOR ANNUNCIATOR SYSTEM AT ALL ACCESSIBLE APARTMENTS AND ALSO AT APARTMENTS DESIGNATED FOR HEARING-IMPAIRED. REFER TO ARCH DRAWINGS FOR APPLICABLE ROOMS. SEE DETAIL 3, SHEET E6.2.
- 32. IN ADA/ACCESSIBLE UNITS, DISPOSER SWITCH SHALL BE COUNTERTOP MOUNTED, AIR ACTIVATED PUSH BUTTON TYPE, FINISH TO MATCH SINK. COORDINATE EXACT LOCATION OF PUSH BUTTON WITH ARCHITECT.
- 33. RELAY FOR CONTROL OF MOTORIZED INTAKE HOOD ON ROOF. SEE 2/E6.2.
- 34. TIMECLOCK AND CONTACTORS FOR LIGHTING AND RECEPTACLE CONTROL. RE: 5/E6.1
- 35. 2-HOUR DIAL TIMER OVERRIDE SWITCH FOR SWITCHED RECEPTACLES. SEE 5/E6.1 36. LINE VOLTAGE CEILING OCCUPANCY SENSOR/PHOTOCELL WITH DAYLIGHT HARVESTING
- PRESENT. SENSORWORX #SWX-2-3-1-2-D OR EQUAL. 37. PRESET SLIDE DIMMER, 0-10V, LEVITON #IP710-DLZ OR EQUAL. COORDINATE DEVICE COLOR WITH ARCHITECT.

CAPABILITY. SENSOR SHALL DIM 0-10V LIGHTS WHEN ADEQUATE DAYLIGHT IS

38. ONE RECEPTACLE SHALL BE CONNECTED TO CIRCUIT #44 (UNCONTROLLED) AND THE OTHER RECEPTACLES SHALL BE CONNECTED TO CIRCUIT #46 (CONTROLLED). CONTROLLED RECEPTACLE SHALL BE MARKED IN ACCORDANCE WITH NEC 406.3(E).

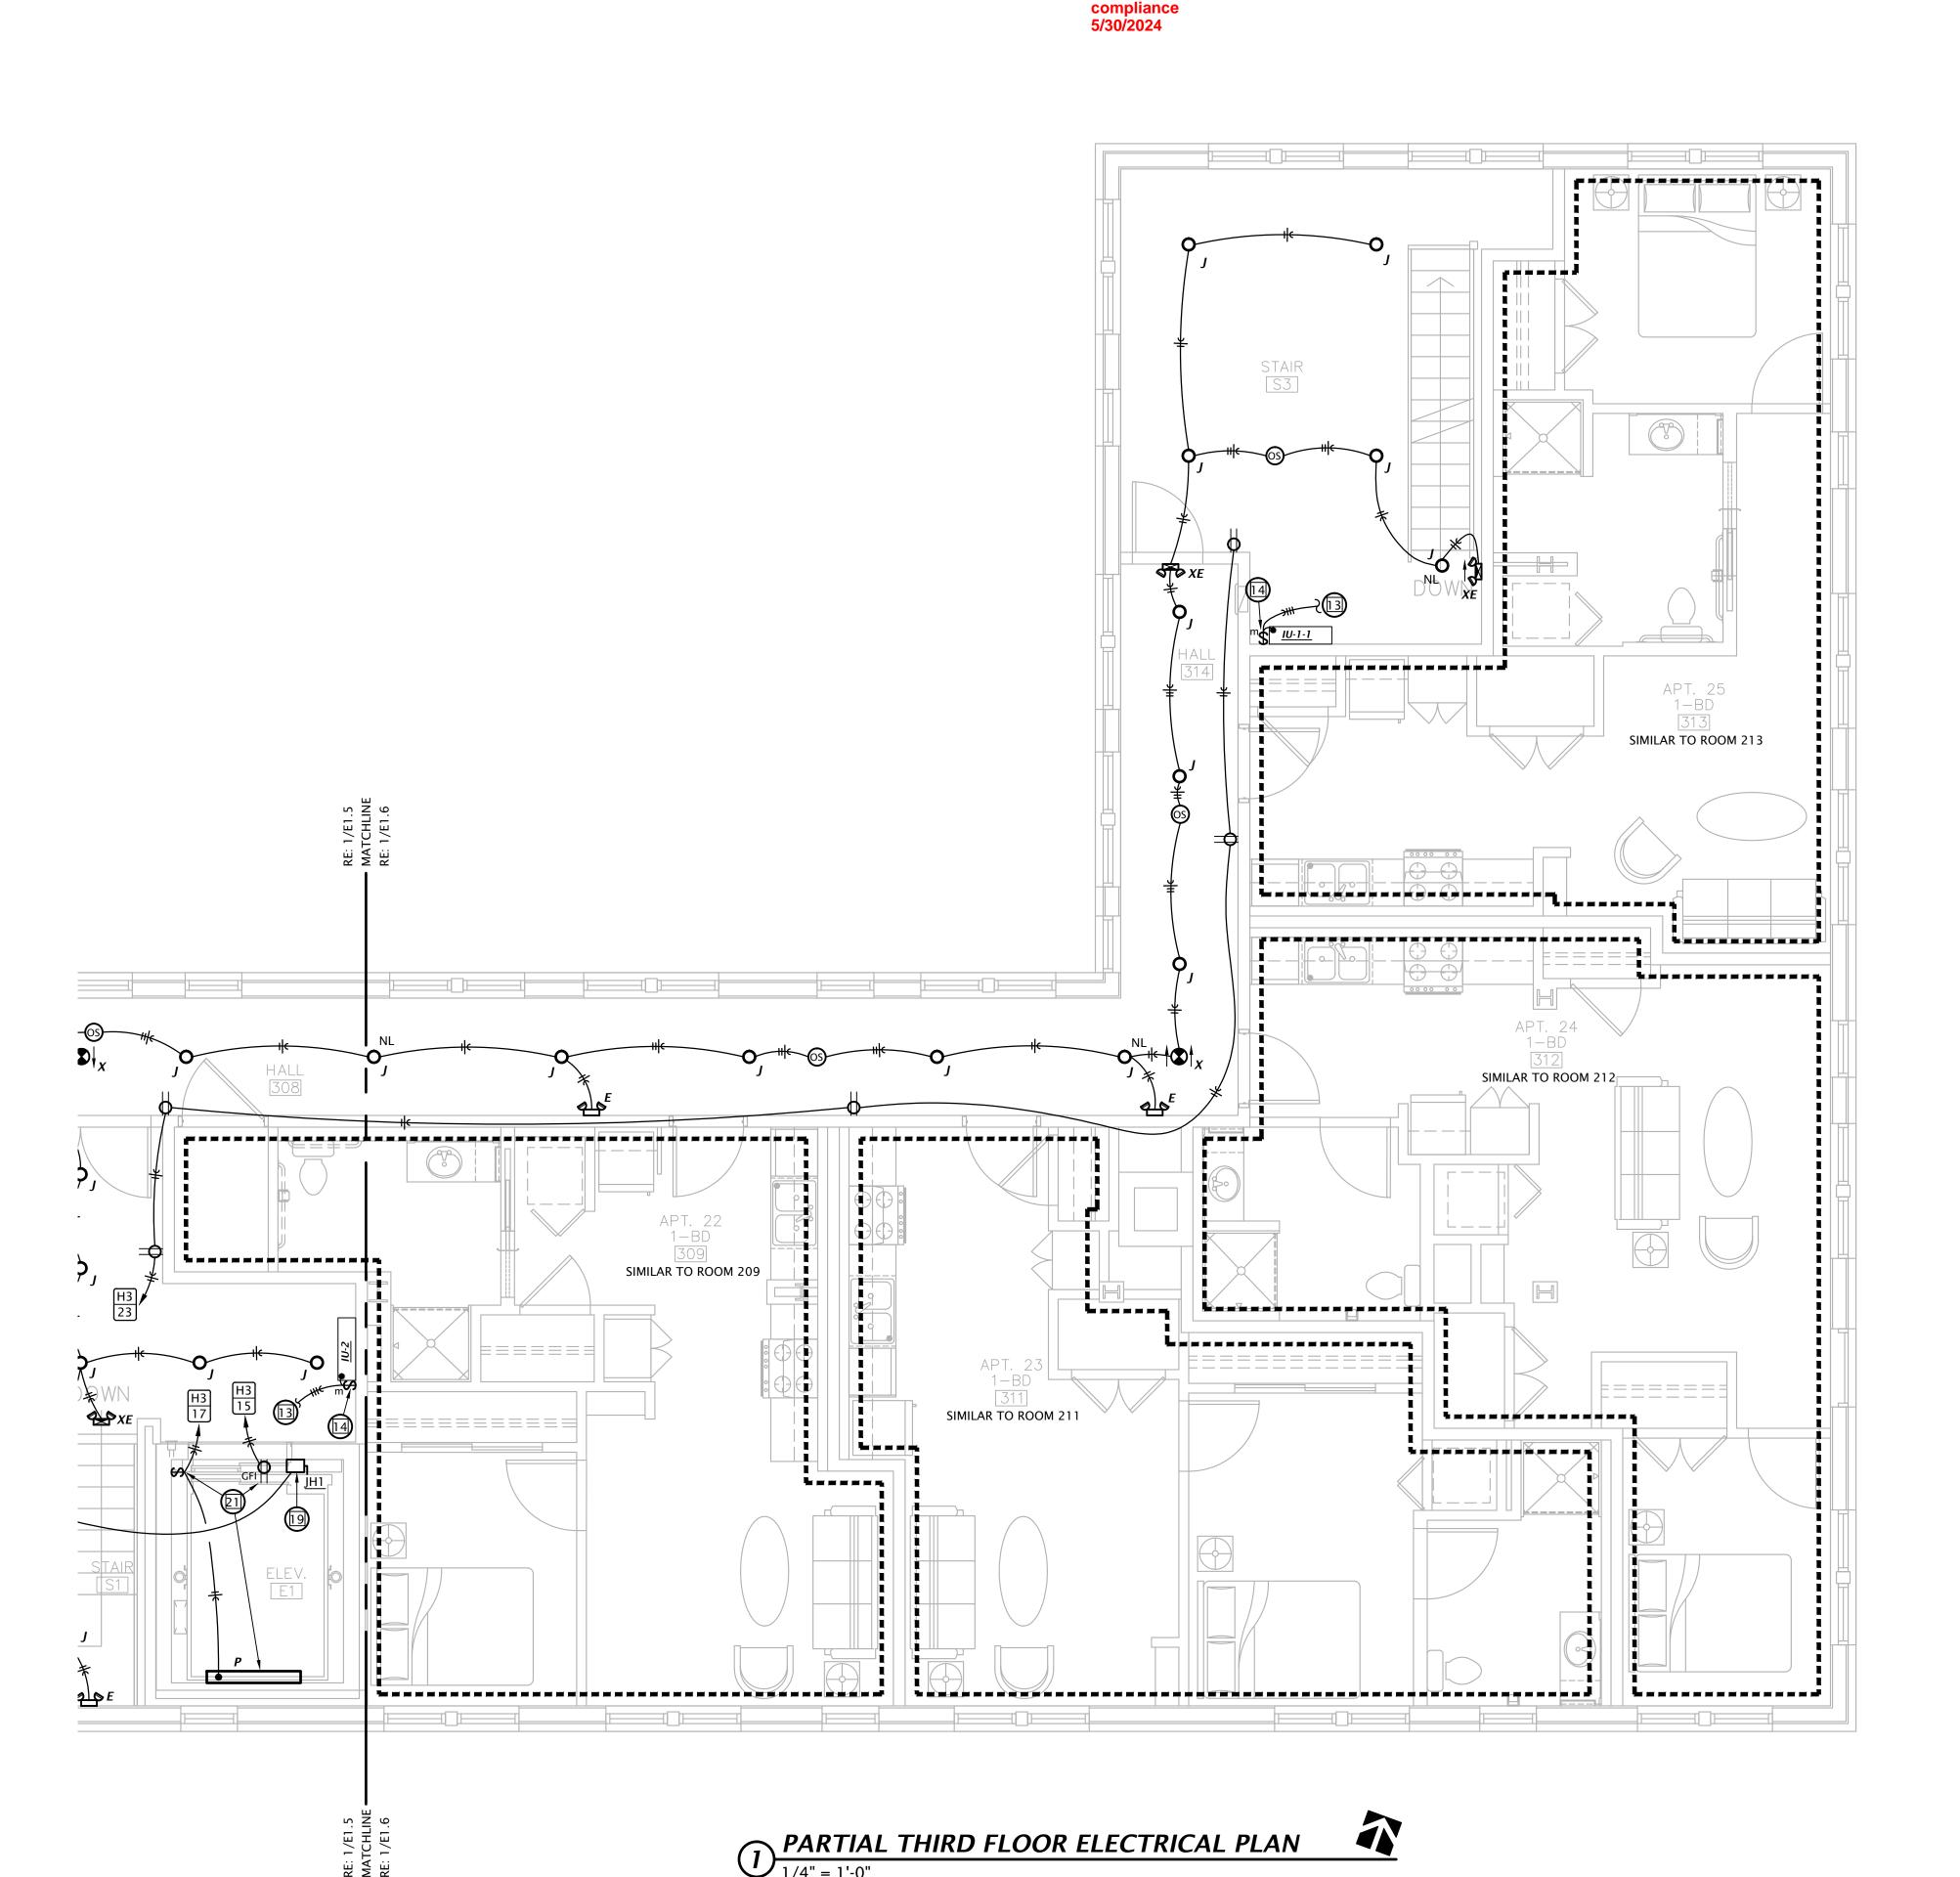


**REVIEWED** for code

### GENERAL ELECTRICAL NOTES

- A. COORDINATE EXACT PANEL OF CIRCUIT ORIGIN FOR RESIDENTIAL TENANT HEAT PUMP UNITS.
- B. ALL CONDUIT PENETRATIONS THROUGH ROOF SHALL OCCUR AT PIPE CURBS ALONG WITH REFRIGERANT PIPING, ETC. COORDINATE CURB LOCATIONS WITH MECHANICAL

### **# ELECTRICAL PLAN NOTES BY SYMBOL**

- 1. 30A/2P NON-FUSED DISCONNECT SWITCH IN NEMA 3R ENCLOSURE. MOUNT SWITCH TO UNISTRUT FRAME SUPPORTED FROM EQUIPMENT SUPPORT RAILS. MAKE FINAL CONNECTION TO EQUIPMENT IN 'LFMC' RACEWAY.
- 2. MOUNT RECEPTACLE TO UNISTRUT FRAME SUPPORTED FROM EQUIPMENT SUPPORT
- 3. PROVIDE (3) #12, #12G, 1/2"C FROM OUTDOOR UNIT TO ASSOCIATED INDOOR UNIT (UNIT ID AND LOCATION NOTED).
- 4. 60A/2P NON-FUSED DISCONNECT SWITCH IN NEMA 3R ENCLOSURE. MOUNT SWITCH TO UNISTRUT FRAME SUPPORTED FROM EQUIPMENT SUPPORT RAILS. MAKE FINAL CONNECTION TO EQUIPMENT IN 'LFMC' RACEWAY.
- 5. CONNECT TO MOTORIZED DAMPER FOR INTAKE HOOD. COORDINATE WITH MECHANICAL CONTRACTOR.
- 6. SWITCHED 120V POWER FROM RELAY IN LAUNDRY ROOM 116. SEE SHEET E1.1 FOR CONTINUATION. SEE DETAIL 2, SHEET E6.2.
- 7. MOUNT FLOOD LIGHT ON STRUCTURAL PLATFORM AND AIM AT SIGN.
- 8. ROUTE CIRCUIT THROUGH CONTACTOR 'C3'. SEE DETAIL 5, SHEET E6.1.

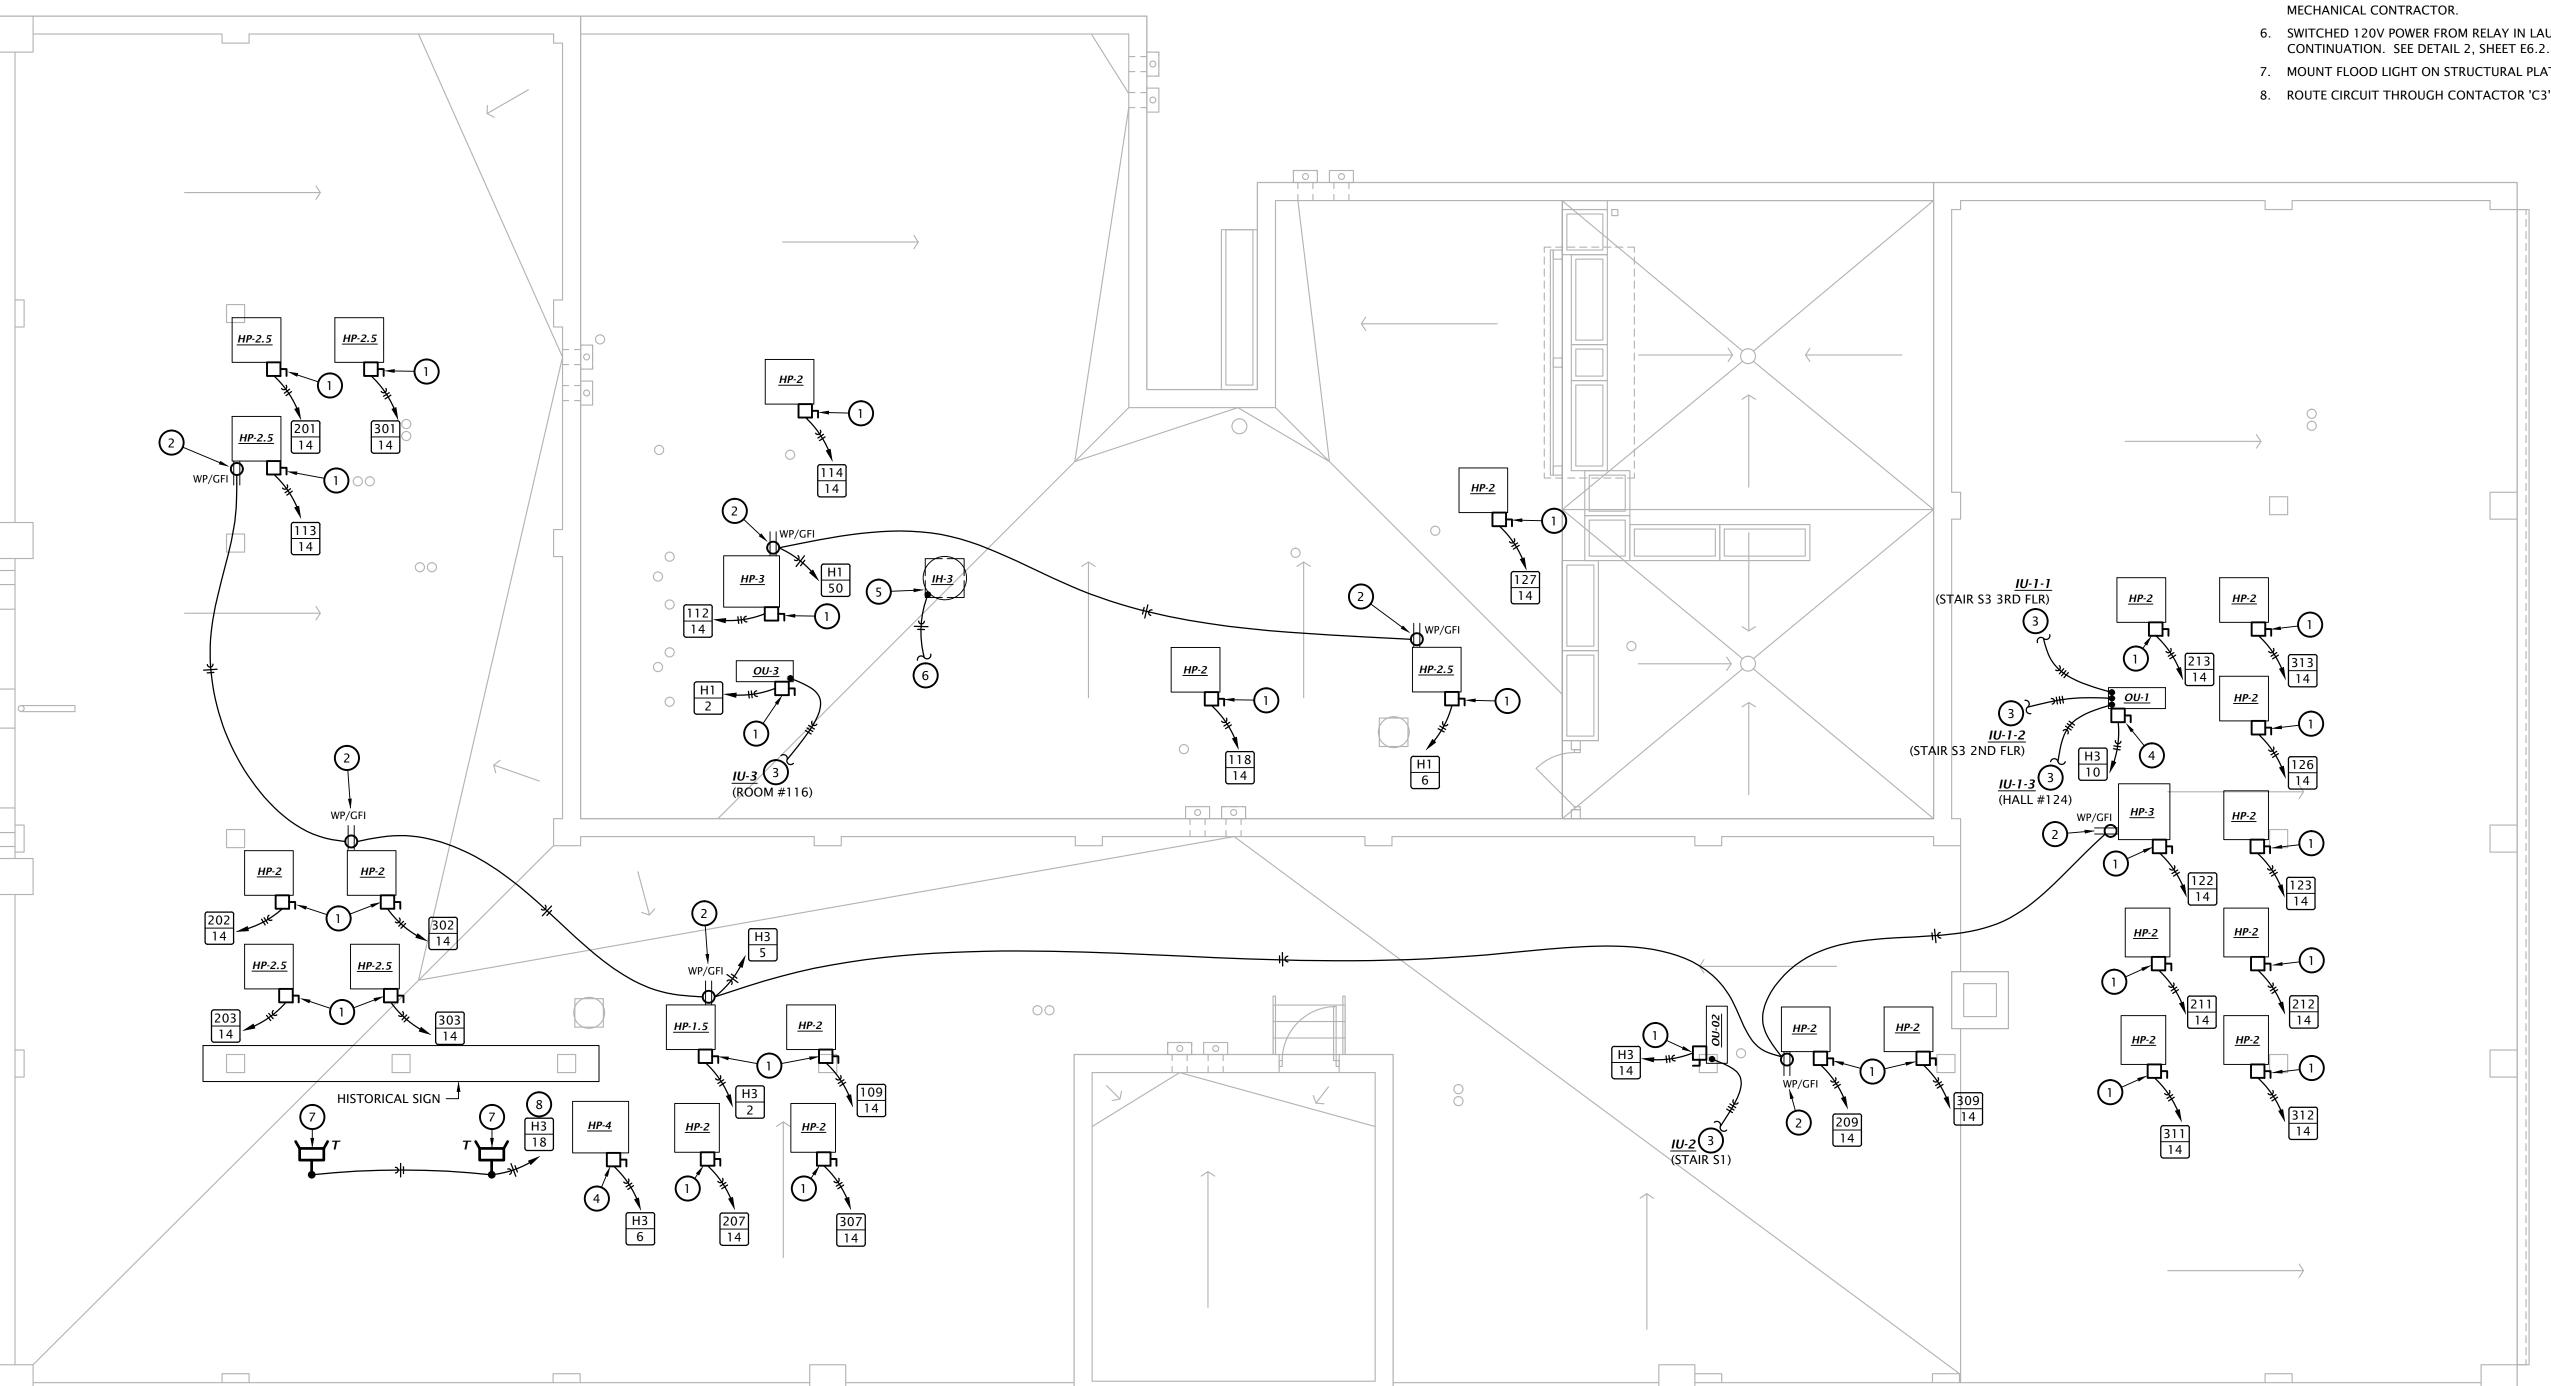

**REVIEWED** for code

compliance 5/30/2024

1 ELECTRICAL ROOF PLAN
3/16" = 1'-0"



1-16-2024 21–3166 <sub>O</sub> SHEET NO.:

E1.7

1. ELEVATOR LOBBY HEAT DETECTOR. SEE DETAIL 4:E6.1.

UNIT. MOUNT FLUSH IN WALL AT 8'-0" AFF.

(WIREMOLD #FS4R-RED) AT BOTH ENDS.

INSTALLER AND G.C. SEE DETAIL 4:E6.1

LOCAL JURISDICTION REQUIREMENTS. SEE DETAIL 4:E6.1. 13. INSTALL HEAT DETECTOR IN ELEVATOR PIT. SEE DETAIL 4:E6.1.

HOMERUN CAT6 AND COAX CABLE TO ROOM INDICATED.

1:E6.2 FOR OUTLET DETAILS.

OVERHEAD AND STUBBED INTO M/E ROOM 108.

ANY EQUIPMENT.

2. FIRE ALARM SYSTEM COMBINATION CO / SMOKE DETECTOR.

3. FIRE ALARM ADDRESSABLE CONTROL MODULE FOR CONTROL OF APARTMENT UNIT'S NOTIFICATION APPLIANCE CIRCUIT. MODULE SHALL BE PROGRAMMED TO ACTIVATE APARTMENT UNIT'S NOTIFICATION APPLIANCES UPON GENERAL BUILDING FIRE ALARM AND UPON ACTIVATION OF ANY SMOKE DETECTOR OR CO DETECTOR WITHIN APARTMENT

4. TELEPHONE TERMINAL BOARD: COVER WALL WITH 4'X8'X3/4" ACX FIRE RETARDANT

PERMANENTLY FASTENED TO THE WALL BY MEANS OF WALL ANCHORS UTILIZING

6. (2) 4" EMT CONDUIT SLEEVES FROM OVERHEAD IN M/E ROOM 108, THROUGH M/E ROOM

9. COORDINATE FINAL LOCATIONS OF ALL CATV AND PHONE OUTLETS WITH OWNER. SEE

10. ADDRESSABLE FIRE ALARM RELAY FOR ELEVATOR POWER SHUNT-TRIP, AND ADDRESSABLE MONITORING MODULE FOR MONITORING OF SHUNT TRIP VOLTAGE. SEE DETAIL 4:E6.1 .

RECALL AND FIREMAN'S HAT. MOUNT ON HOISTWAY WALL ABOVE CEILING AND PROVIDE ACCESS PANEL IN CEILING AS REQUIRED. COORDINATE WITH ELEVATOR EQUIPMENT

11. ADDRESSABLE FIRE ALARM RELAYS FOR ELEVATOR PRIMARY AND ALTERNATE FLOOR

12. INSTALL SMOKE DETECTOR AND HEAT DETECTOR AT TOP OF ELEVATOR HOISTWAY PER

COORDINATE EXACT REQUIREMENTS WITH UTILITY PROVIDER SELECTED BY OWNER.

16. PROVIDE FIRE ALARM RELAYS AND MONITORING MODULES FOR ALL FIRE SPRINKLER FLOW SWITCHES, AND BELL/GONG. SEE E1.1 SITE PLAN FOR LOCATION OF TAMPER SWITCHES. COORDINATE QUANTITIES AND LOCATIONS WITH FIRE SPRINKLER CONTRACTOR PRIOR TO

15. COORDINATE TELECOM OUTLET LOCATION NEAR TOP OF HOISTWAY WITH ELEVATOR

14. TELECOM DISTRIBUTION DEVICE APPROXIMATELY 4'-0" AFF. SEE DETAIL 1:E6.2.

5. TELECOMMUNICATIONS GROUND BAR AT 18" AFF. SEE DETAIL 6, SHEET E6.1.

206, AND STUBBED UP 4" ABOVE FINISHED FLOOR OF M/E ROOM 306 FOR COMMUNICATIONS BACKBONE CABLING. PROVIDE WITH FIRESTOPPING FITTINGS

7. (2) 4" CONDUITS FOR COMMUNICATIONS SERVICE CABLING ROUTED CONCEALED

8. SEAL CONDUIT PENETRATIONS THROUGH EXTERIOR WALL WEATHERTIGHT.


PLYWOOD SHEETS INSTALLED VERTICALLY WITH BOTTOM AT 6" AFF. PLYWOOD SHALL BE

GALVANIZED, ZINC PLATED, OR STAINLESS STEEL HARDWARE WITH A FLAT HEAD. FINISHED INSTALLATION SHALL HAVE FLUSH APPEARANCE WITH COUNTERSUNK SCREW HEADS TO

PREVENT SPLITTING OF THE PLYWOOD. DRYWALL SCREWS ARE NOT ACCEPTABLE. PAINT WITH TWO COATS OF LIGHT GRAY FIRE RETARDANT SEALER PRIOR TO INSTALLATION OF

1-16-2024 21-3166 SHEET NO.:

E1.8

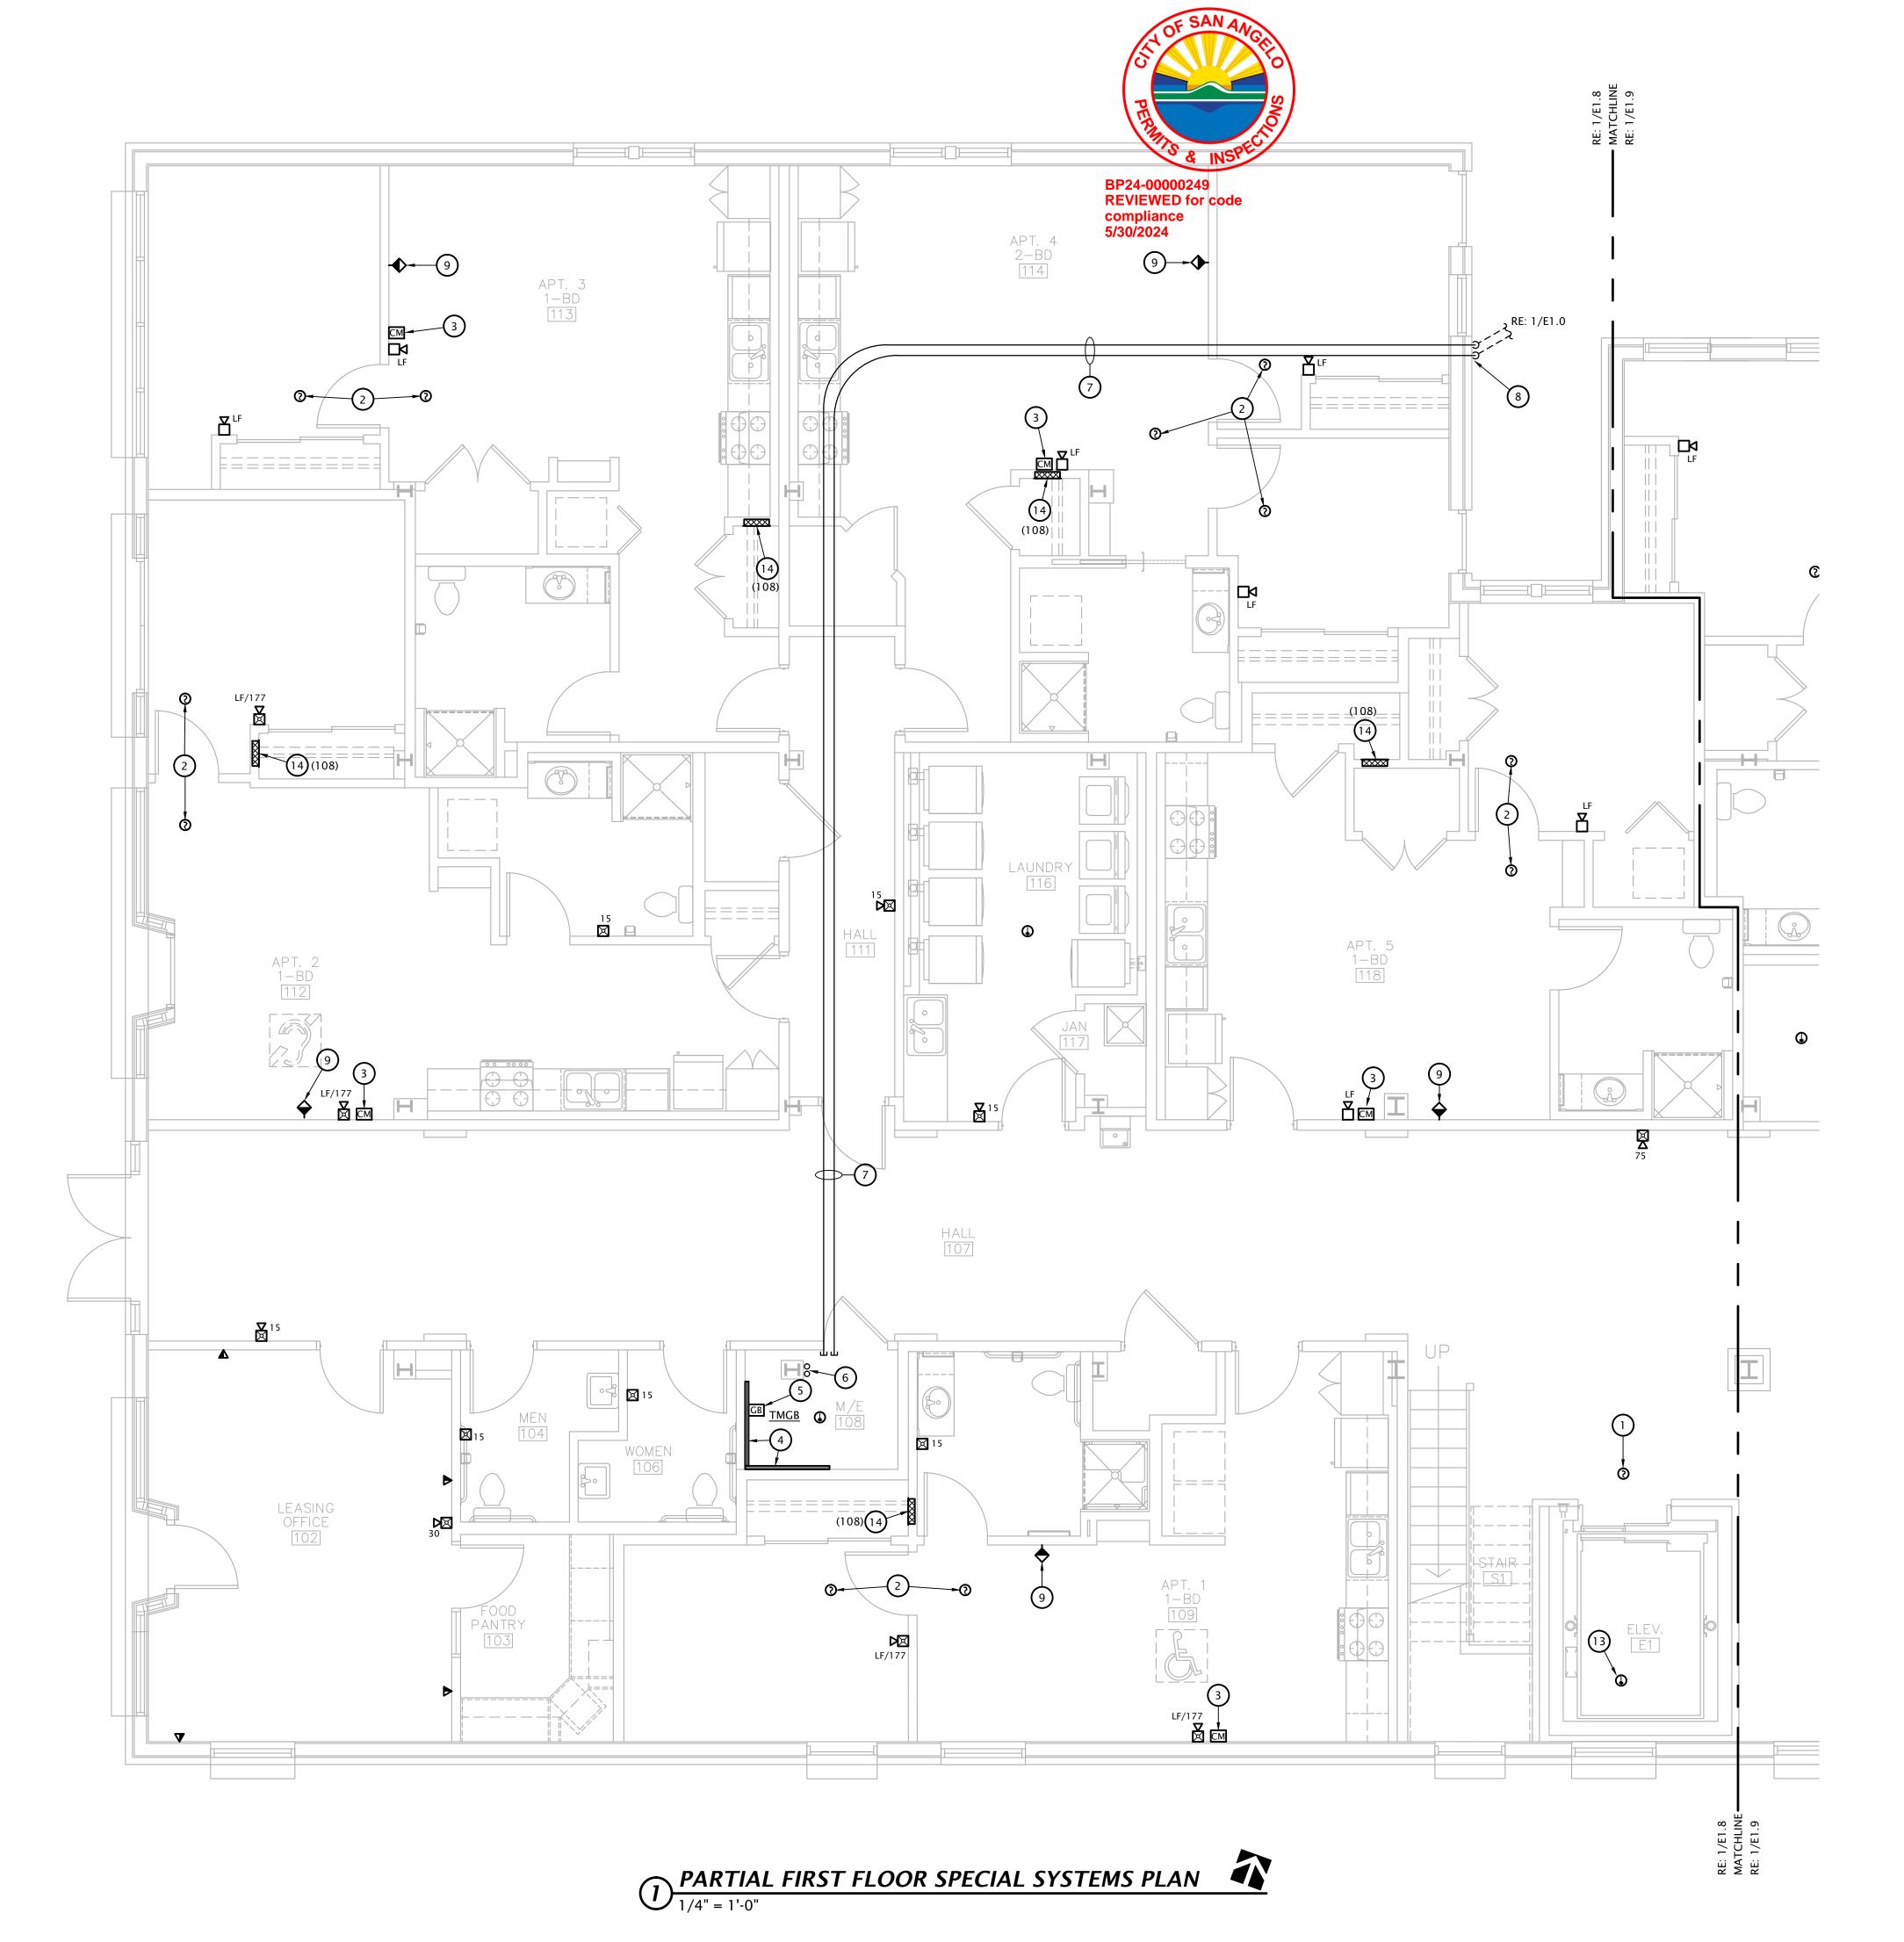

1-16-2024

1-16-2024 21-3166 SHEET NO .:

E1.9




### (#) SPECIAL SYSTEMS PLAN NOTES BY SYMBOL

- 1. ELEVATOR LOBBY HEAT DETECTOR. SEE DETAIL 4:E6.1.
- 2. FIRE ALARM SYSTEM COMBINATION CO / SMOKE DETECTOR.
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- 4. TELEPHONE TERMINAL BOARD: COVER WALL WITH 4'X8'X3/4" ACX FIRE RETARDANT PLYWOOD SHEETS INSTALLED VERTICALLY WITH BOTTOM AT 6" AFF. PLYWOOD SHALL BE PERMANENTLY FASTENED TO THE WALL BY MEANS OF WALL ANCHORS UTILIZING GALVANIZED, ZINC PLATED, OR STAINLESS STEEL HARDWARE WITH A FLAT HEAD. FINISHED INSTALLATION SHALL HAVE FLUSH APPEARANCE WITH COUNTERSUNK SCREW HEADS TO PREVENT SPLITTING OF THE PLYWOOD. DRYWALL SCREWS ARE NOT ACCEPTABLE. PAINT WITH TWO COATS OF LIGHT GRAY FIRE RETARDANT SEALER PRIOR TO INSTALLATION OF ANY EQUIPMENT.

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- 206, AND STUBBED UP 4" ABOVE FINISHED FLOOR OF M/E ROOM 306 FOR COMMUNICATIONS BACKBONE CABLING. PROVIDE WITH FIRESTOPPING FITTINGS (WIREMOLD #FS4R-RED) AT BOTH ENDS.
- 7. (2) 4" CONDUITS FOR COMMUNICATIONS SERVICE CABLING ROUTED CONCEALED OVERHEAD AND STUBBED INTO M/E ROOM 108.
- 8. SEAL CONDUIT PENETRATIONS THROUGH EXTERIOR WALL WEATHERTIGHT.
- 9. COORDINATE FINAL LOCATIONS OF ALL CATV AND PHONE OUTLETS WITH OWNER. SEE 1:E6.2 FOR OUTLET DETAILS.
- 10. ADDRESSABLE FIRE ALARM RELAY FOR ELEVATOR POWER SHUNT-TRIP, AND ADDRESSABLE MONITORING MODULE FOR MONITORING OF SHUNT TRIP VOLTAGE. SEE DETAIL 4:E6.1.
- 11. ADDRESSABLE FIRE ALARM RELAYS FOR ELEVATOR PRIMARY AND ALTERNATE FLOOR RECALL AND FIREMAN'S HAT. MOUNT ON HOISTWAY WALL ABOVE CEILING AND PROVIDE ACCESS PANEL IN CEILING AS REQUIRED. COORDINATE WITH ELEVATOR EQUIPMENT INSTALLER AND G.C. SEE DETAIL 4:E6.1
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- 13. INSTALL HEAT DETECTOR IN ELEVATOR PIT. SEE DETAIL 4:E6.1.
- 14. TELECOM DISTRIBUTION DEVICE APPROXIMATELY 4'-0" AFF. SEE DETAIL 1:E6.2. COORDINATE EXACT REQUIREMENTS WITH UTILITY PROVIDER SELECTED BY OWNER. HOMERUN CAT6 AND COAX CABLE TO ROOM INDICATED.
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NOTE: ALL FIRE PROTECTION WORK MUST BE PROVIDED BY A FIRE PROTECTION COMPANY/INSTALLER LICENSED BY THE TEXAS STATE FIRE MARSHAL'S OFFICE. FIRE PROTECTION PLANS SHALL BE SUBMITTED DIRECTLY TO THE SAN ANGELO FIRE MARSHAL'S OFFICE FOR REVIEW.

BASEMENT SPECIAL SYSTEMS PLAN

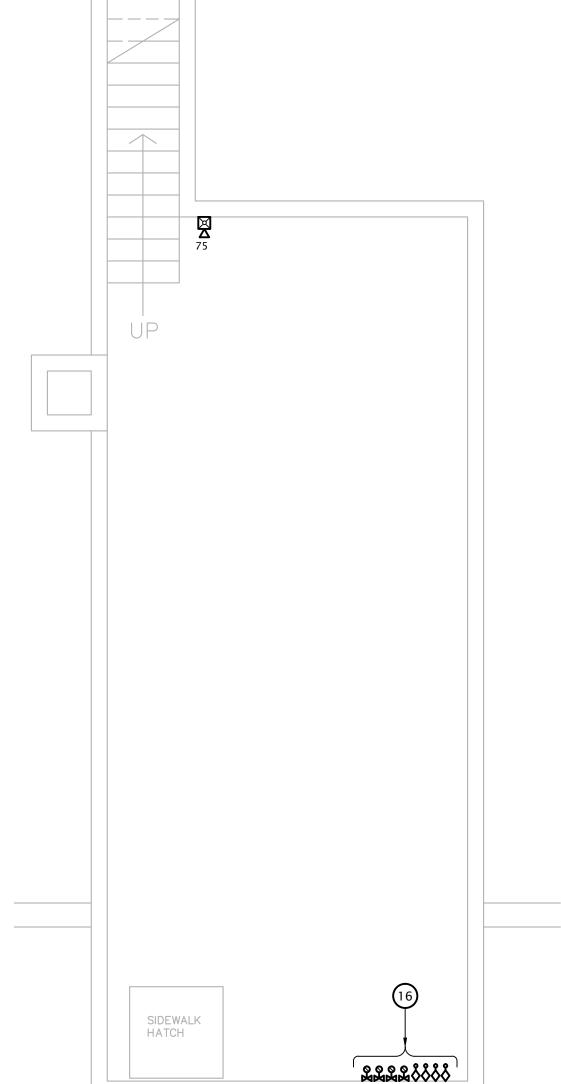1/4" = 1'-0"

PARTIAL FIRST FLOOR SPECIAL SYSTEM PLAN

1/4" = 1'-0"

9-4

COMMUNITY ROOM [121]

**REVIEWED** for code

compliance **5/3**6/2024

DATE: 1–16–2024

JOB: 21–3166


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E1.10



# (#) SPECIAL SYSTEMS PLAN NOTES BY SYMBOL


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- 4. TELEPHONE TERMINAL BOARD: COVER WALL WITH 4'X8'X3/4" ACX FIRE RETARDANT PLYWOOD SHEETS INSTALLED VERTICALLY WITH BOTTOM AT 6" AFF. PLYWOOD SHALL BE PERMANENTLY FASTENED TO THE WALL BY MEANS OF WALL ANCHORS UTILIZING GALVANIZED, ZINC PLATED, OR STAINLESS STEEL HARDWARE WITH A FLAT HEAD. FINISHED INSTALLATION SHALL HAVE FLUSH APPEARANCE WITH COUNTERSUNK SCREW HEADS TO PREVENT SPLITTING OF THE PLYWOOD. DRYWALL SCREWS ARE NOT ACCEPTABLE. PAINT WITH TWO COATS OF LIGHT GRAY FIRE RETARDANT SEALER PRIOR TO INSTALLATION OF ANY EQUIPMENT.
- 5. TELECOMMUNICATIONS GROUND BAR AT 18" AFF. SEE DETAIL 6, SHEET E6.1.
- 6. (2) 4" EMT CONDUIT SLEEVES FROM OVERHEAD IN M/E ROOM 108, THROUGH M/E ROOM 206, AND STUBBED UP 4" ABOVE FINISHED FLOOR OF M/E ROOM 306 FOR COMMUNICATIONS BACKBONE CABLING. PROVIDE WITH FIRESTOPPING FITTINGS (WIREMOLD #FS4R-RED) AT BOTH ENDS.
- (2) 4" CONDUITS FOR COMMUNICATIONS SERVICE CABLING ROUTED CONCEALED OVERHEAD AND STUBBED INTO M/E ROOM 108.
- 8. SEAL CONDUIT PENETRATIONS THROUGH EXTERIOR WALL WEATHERTIGHT.
- 9. COORDINATE FINAL LOCATIONS OF ALL CATV AND PHONE OUTLETS WITH OWNER. SEE 1:E6.2 FOR OUTLET DETAILS.
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- COORDINATE TELECOM OUTLET LOCATION NEAR TOP OF HOISTWAY WITH ELEVATOR INSTALLER.
- 16. PROVIDE FIRE ALARM RELAYS AND MONITORING MODULES FOR ALL FIRE SPRINKLER FLOW SWITCHES, AND BELL/GONG. SEE E1.1 SITE PLAN FOR LOCATION OF TAMPER SWITCHES. COORDINATE QUANTITIES AND LOCATIONS WITH FIRE SPRINKLER CONTRACTOR PRIOR TO BID.

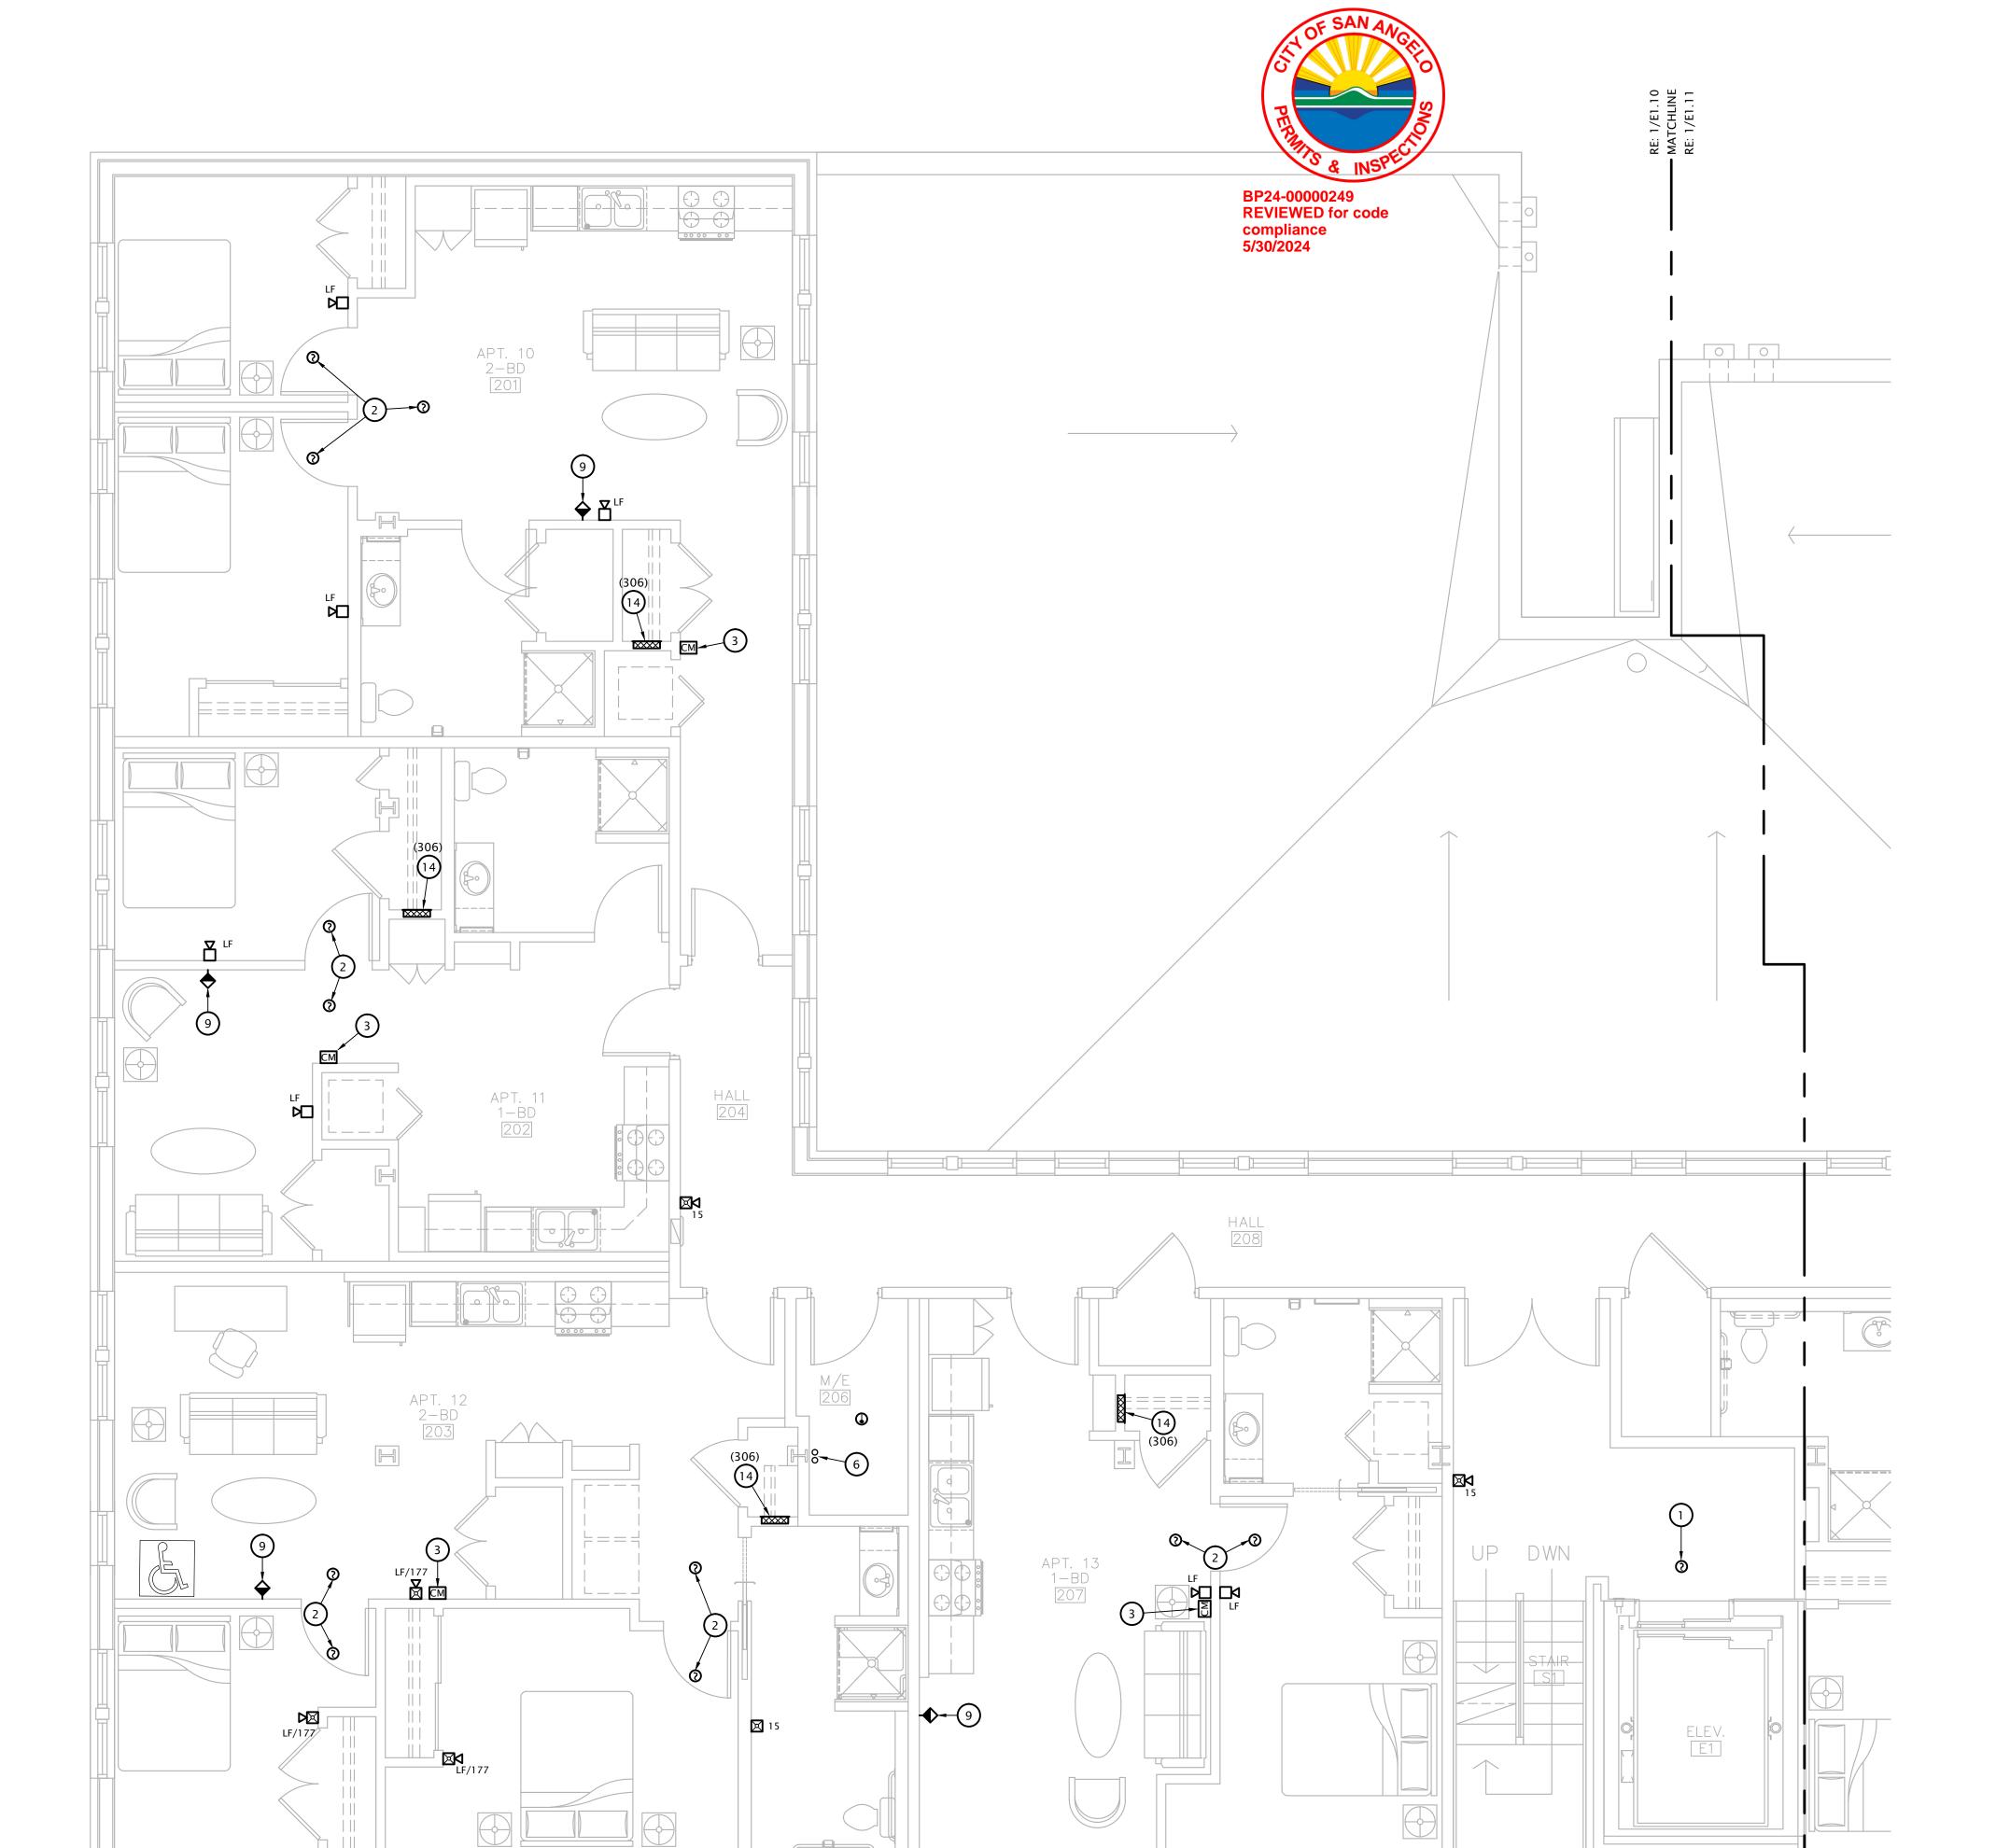

1 PARTIAL SECOND FLOOR SPECIAL SYSTEMS PLAN 1/4" = 1'-0"

SHEET NO.: E1.11



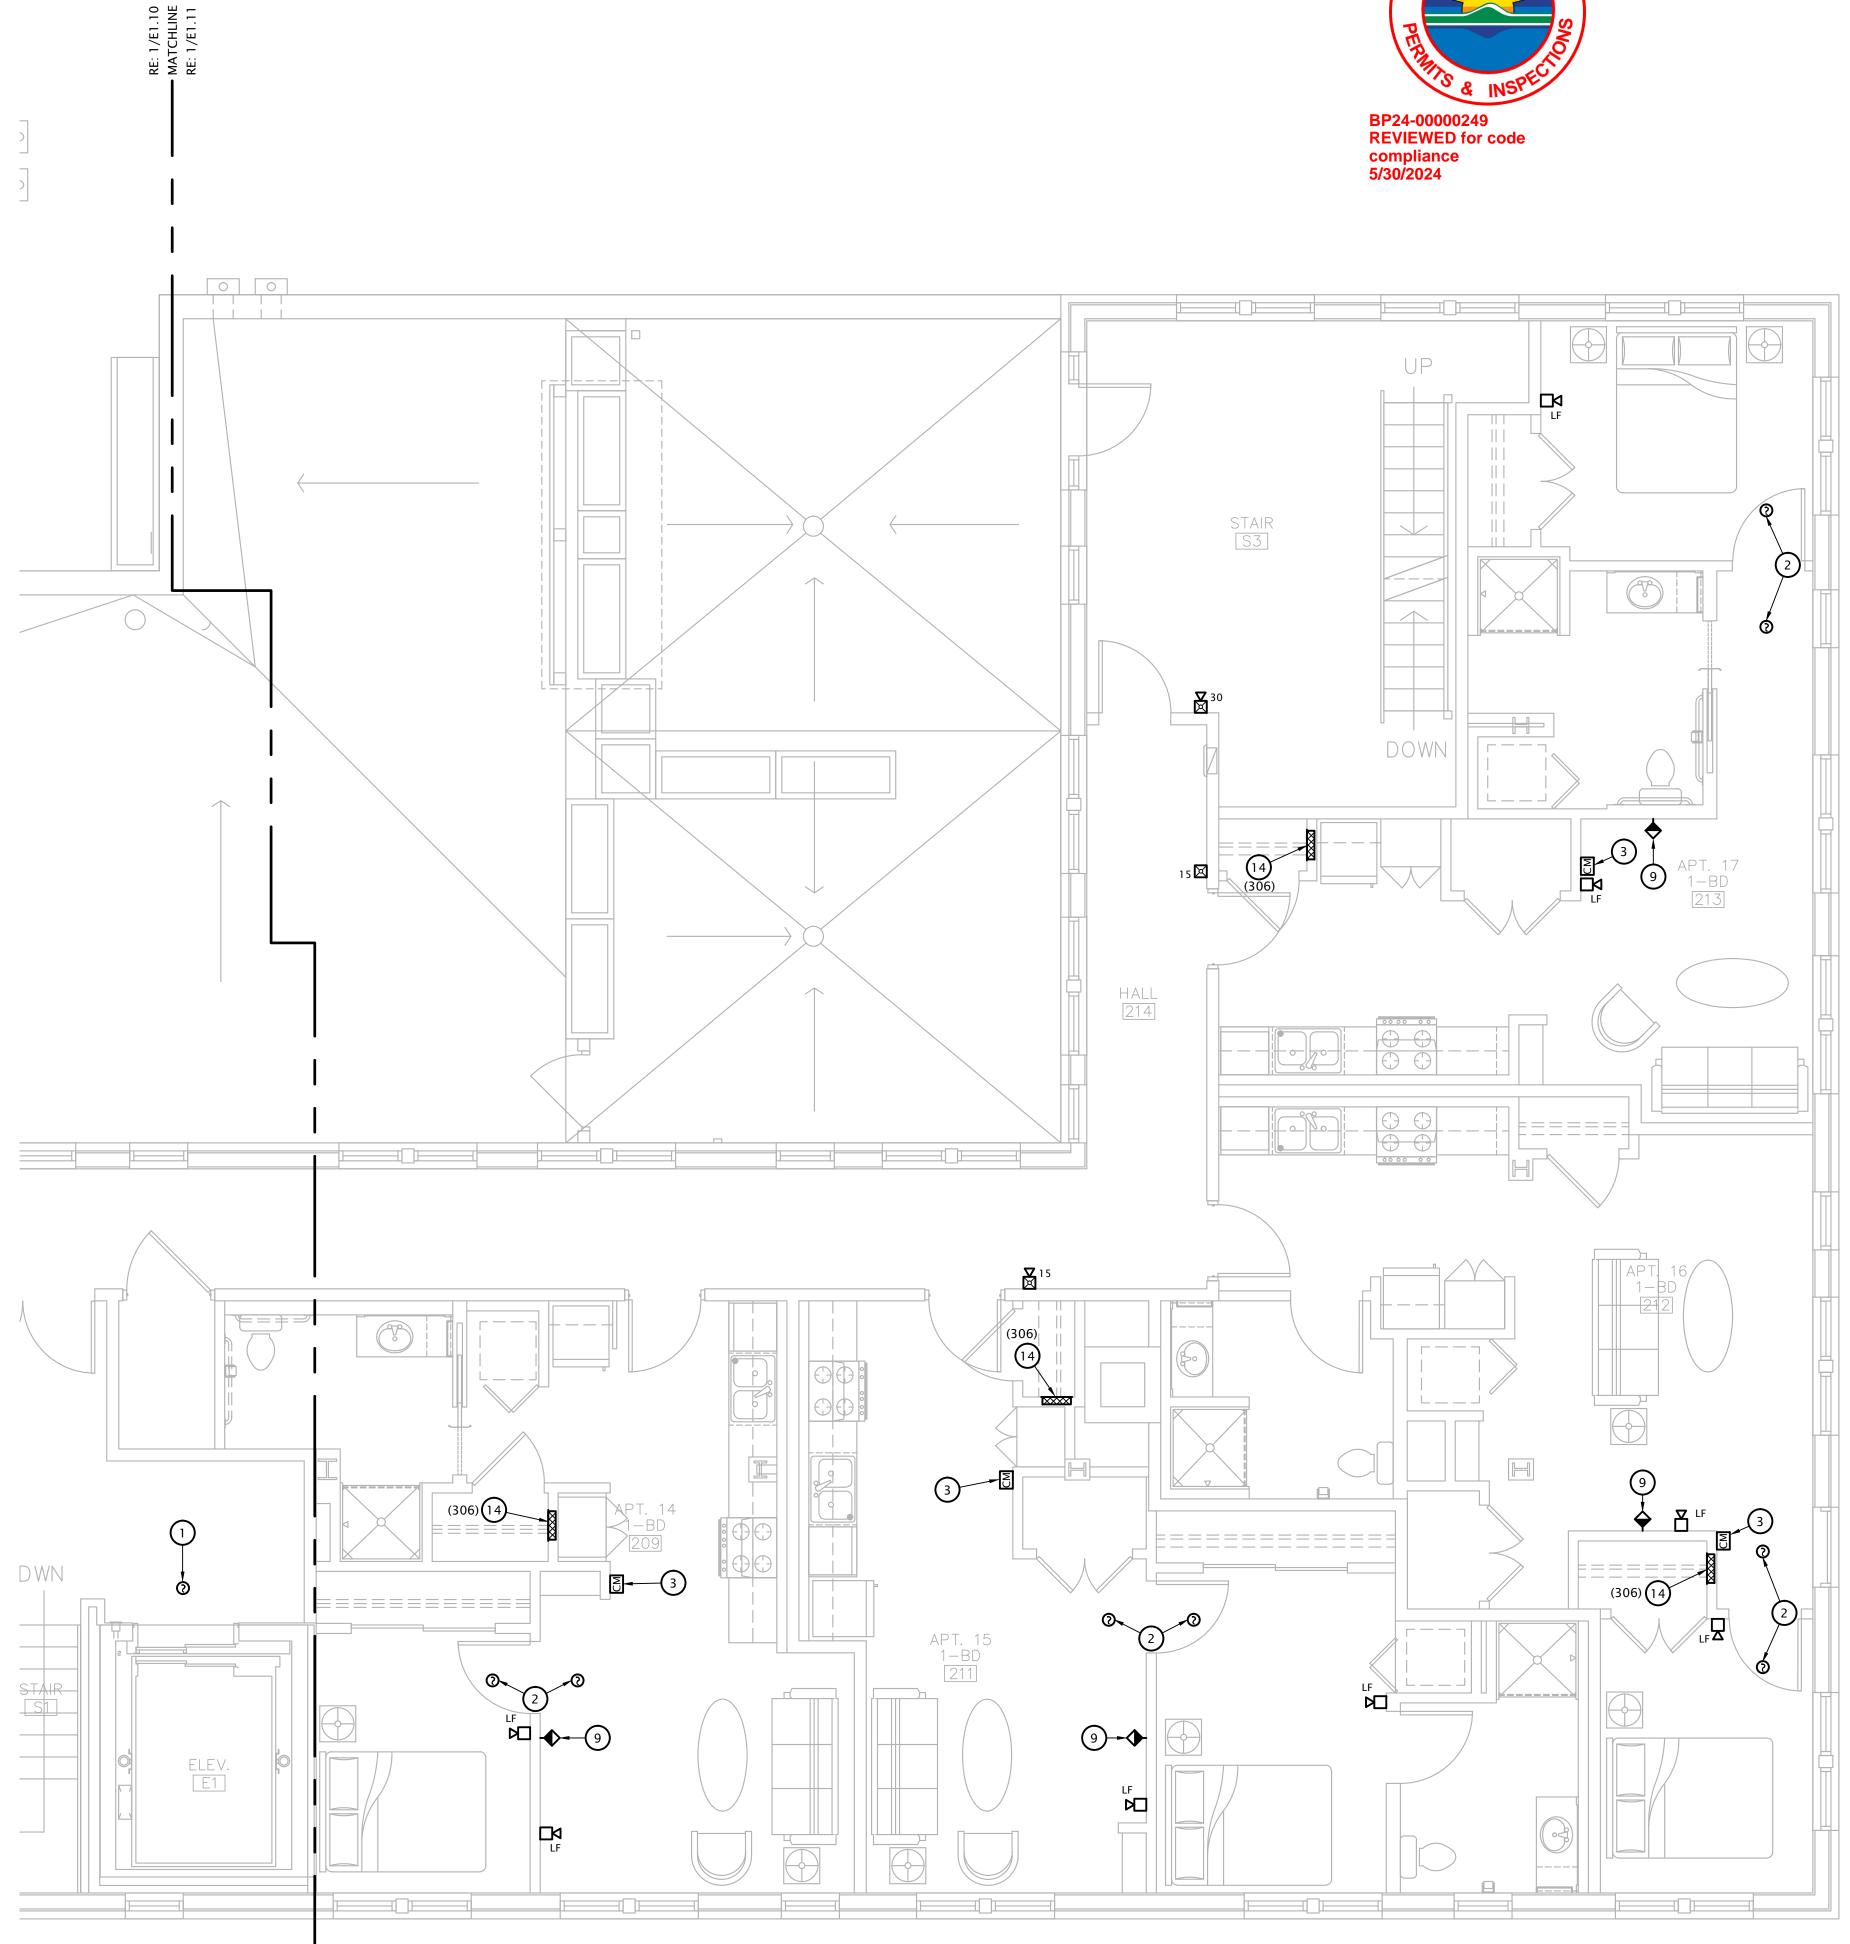

PARTIAL SECOND FLOOR SPECIAL SYSTEMS PLAN

1/4" = 1'-0"

### **\*** SPECIAL SYSTEMS PLAN NOTES BY SYMBOL


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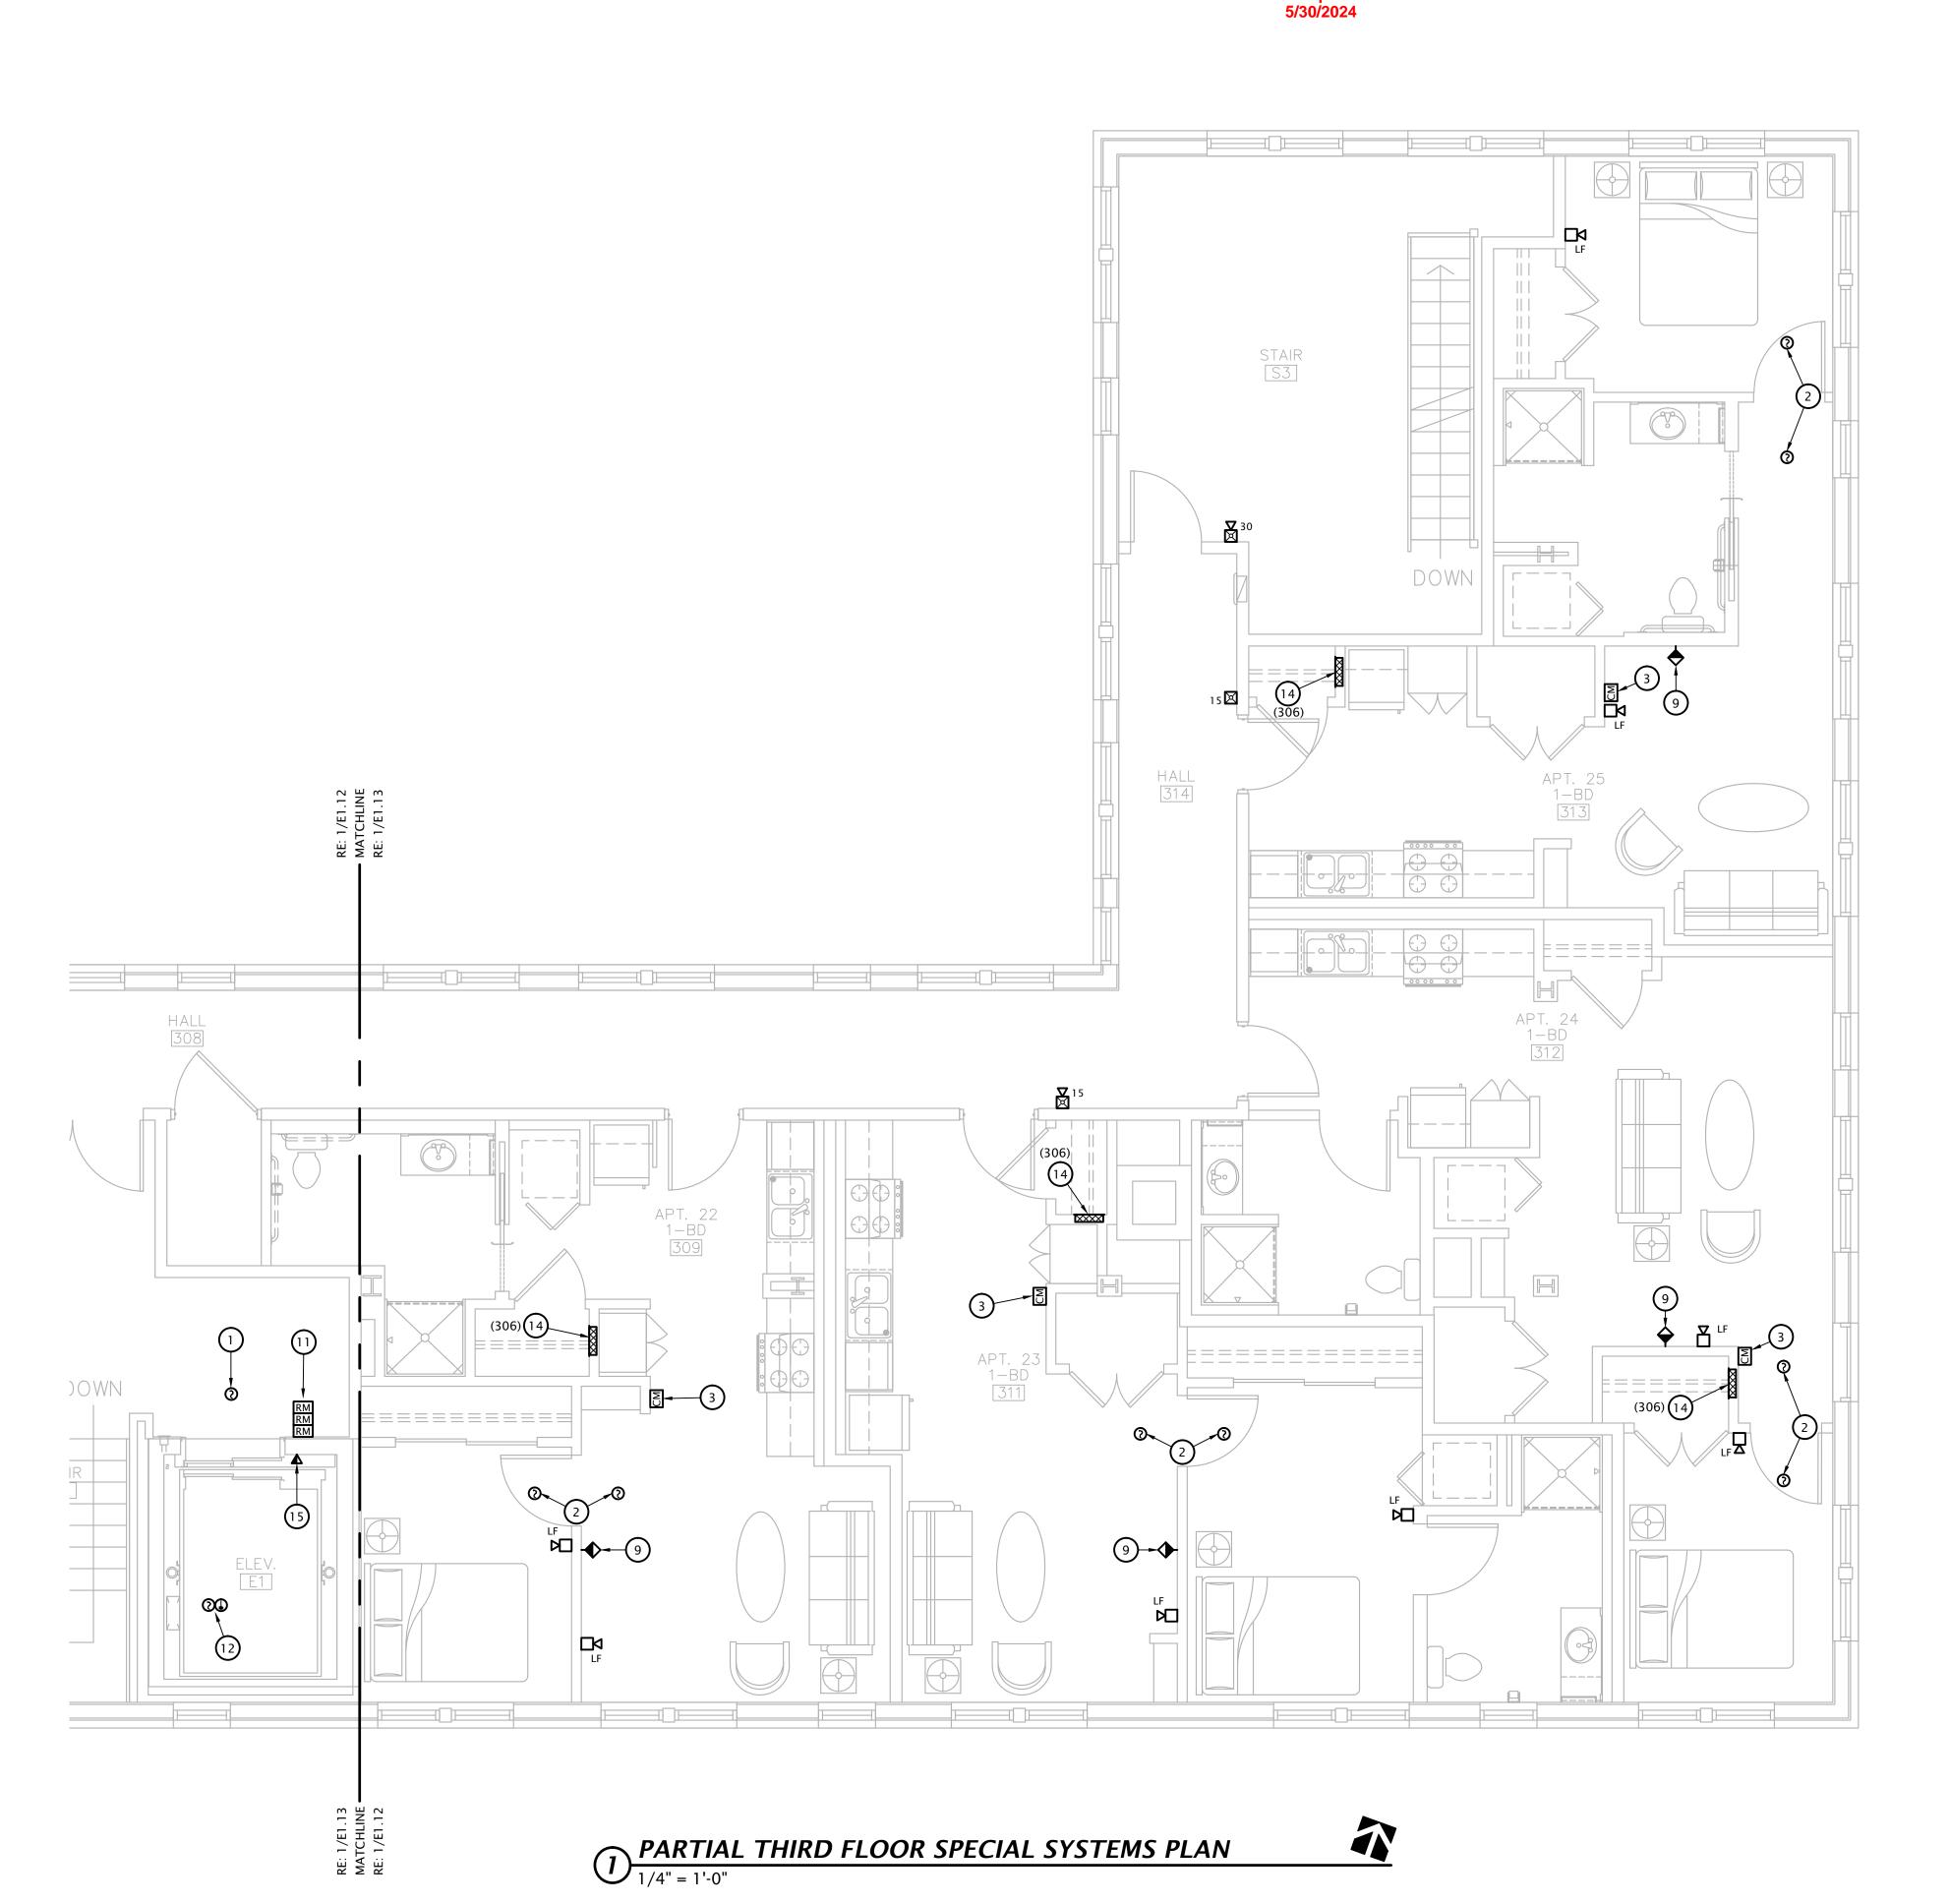






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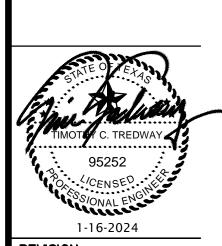
316.285.0696

mail@LSTengineers.com

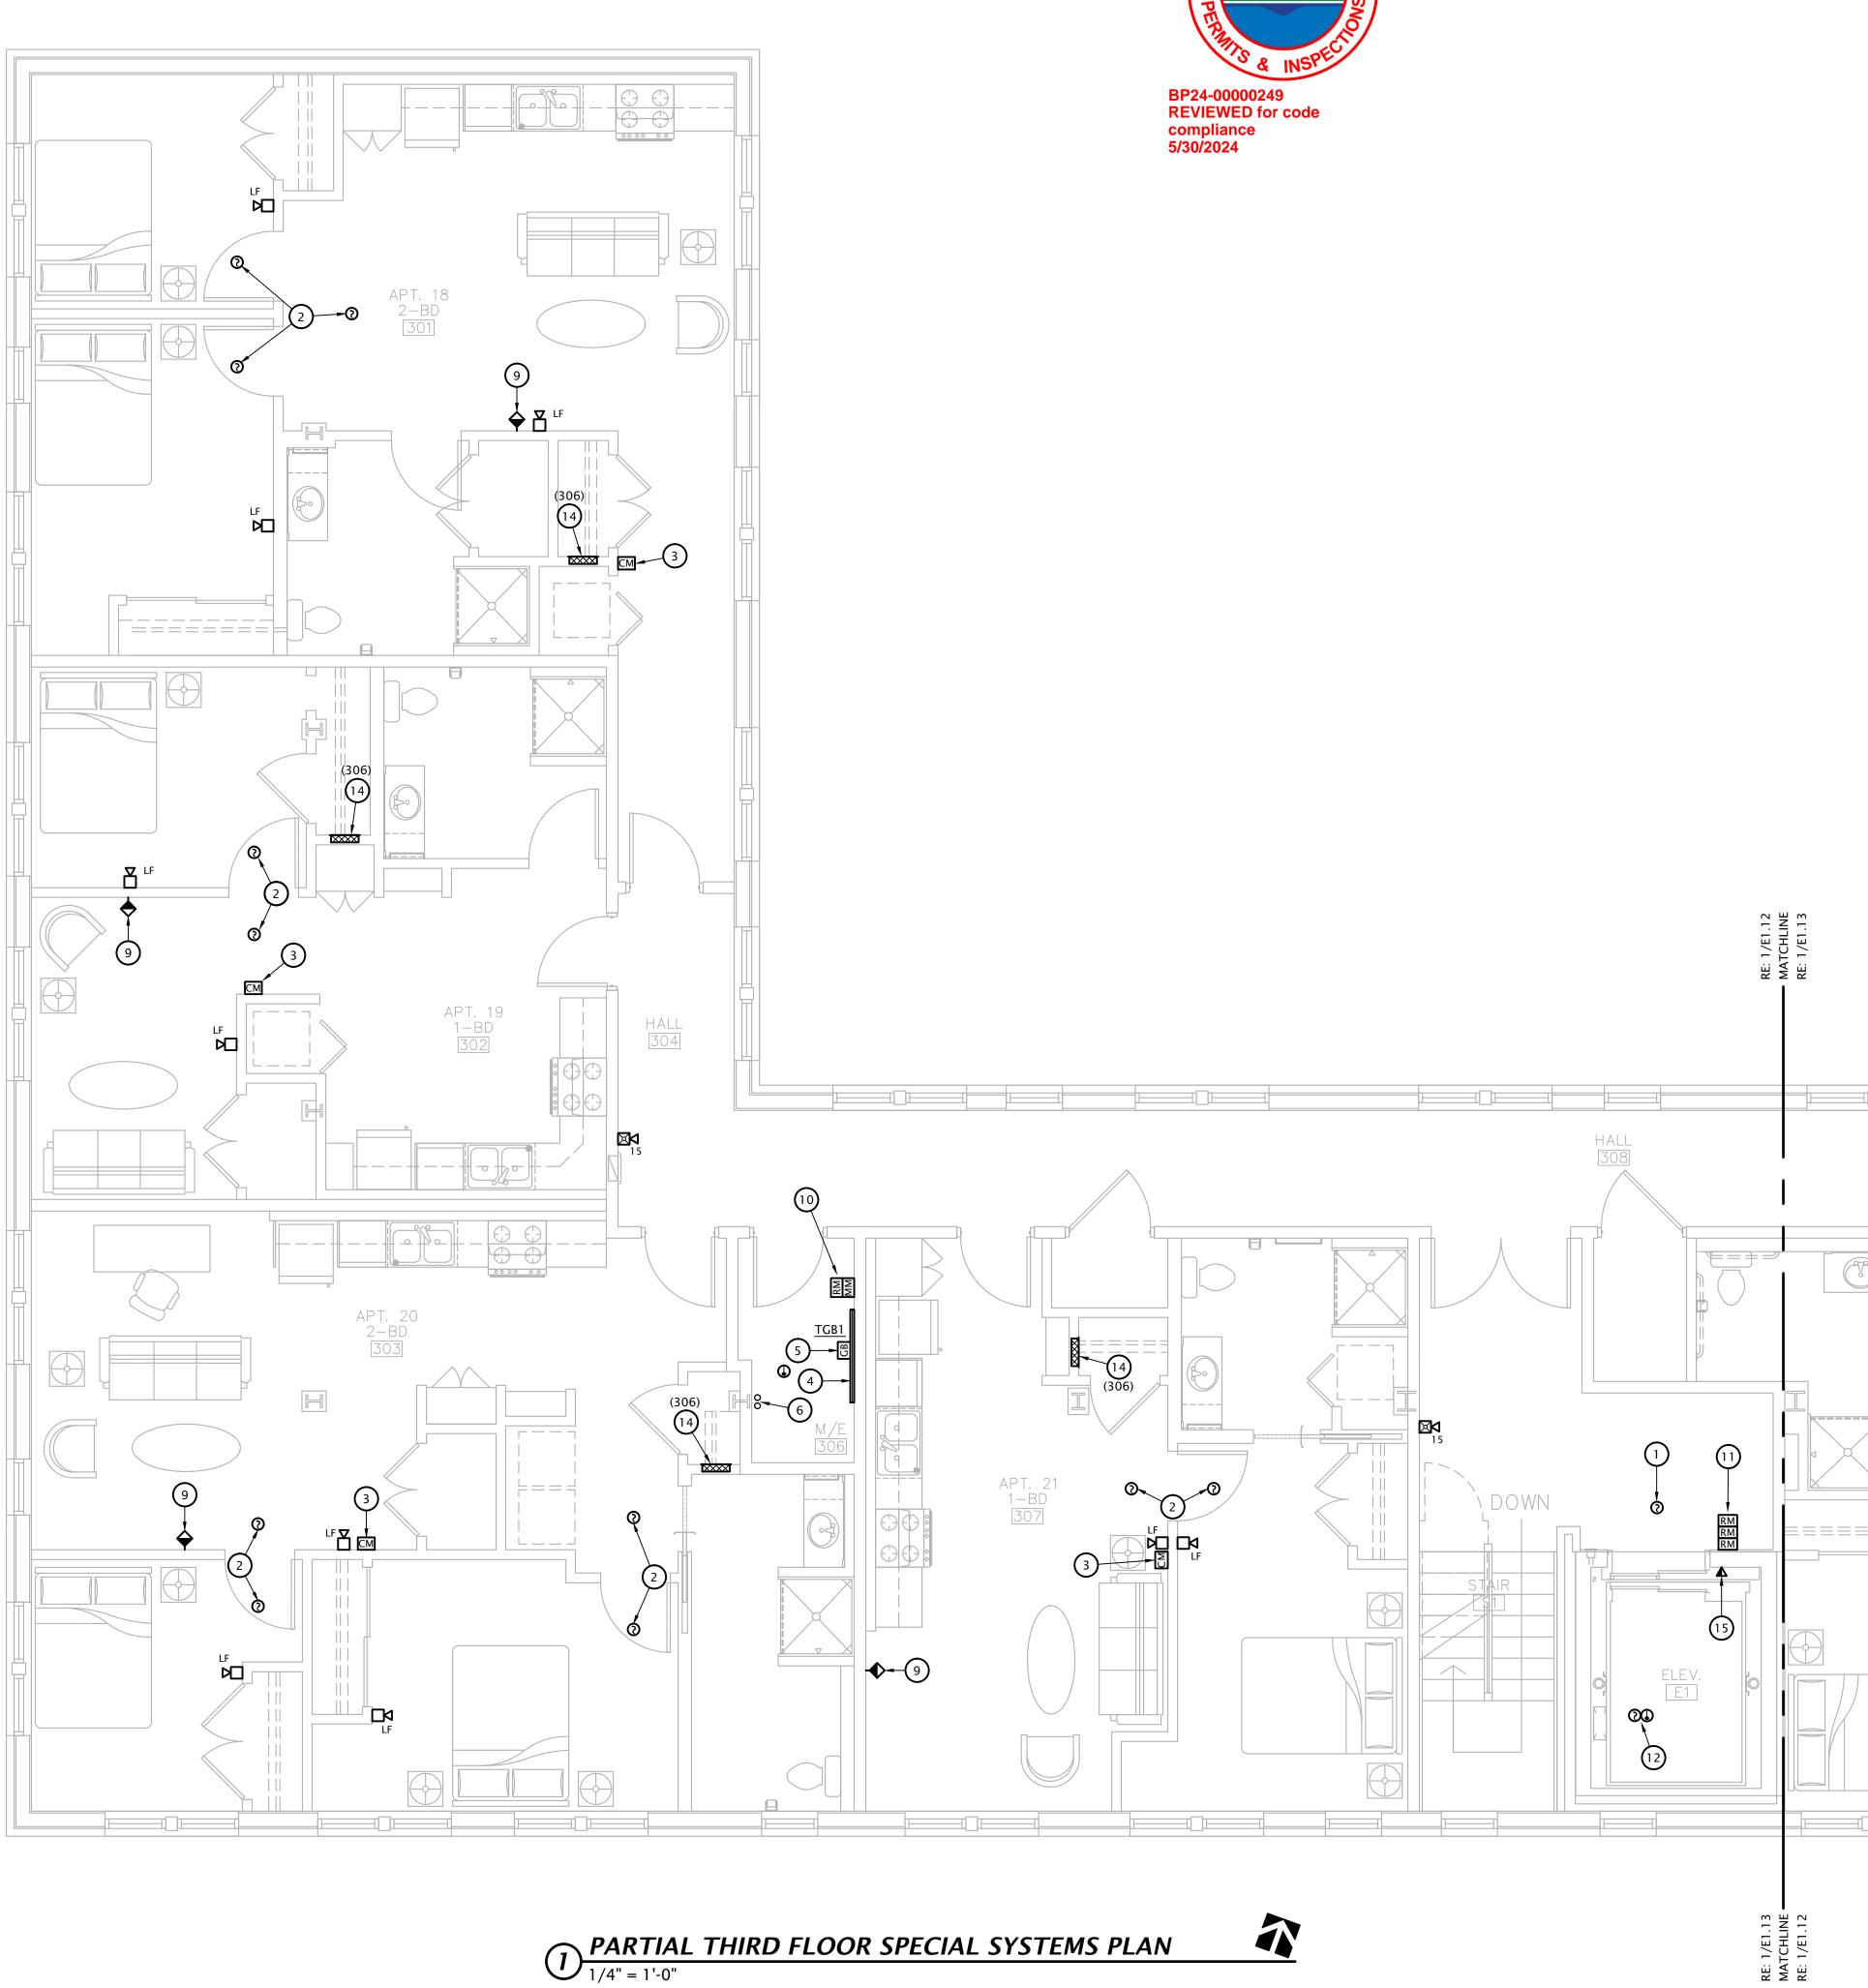January 2024

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- 1. ELEVATOR LOBBY HEAT DETECTOR. SEE DETAIL 4:E6.1.
- 2. FIRE ALARM SYSTEM COMBINATION CO / SMOKE DETECTOR.
- 3. FIRE ALARM ADDRESSABLE CONTROL MODULE FOR CONTROL OF APARTMENT UNIT'S NOTIFICATION APPLIANCE CIRCUIT. MODULE SHALL BE PROGRAMMED TO ACTIVATE APARTMENT UNIT'S NOTIFICATION APPLIANCES UPON GENERAL BUILDING FIRE ALARM AND UPON ACTIVATION OF ANY SMOKE DETECTOR OR CO DETECTOR WITHIN APARTMENT UNIT. MOUNT FLUSH IN WALL AT 8'-0" AFF.
- 4. TELEPHONE TERMINAL BOARD: COVER WALL WITH 4'X8'X3/4" ACX FIRE RETARDANT PLYWOOD SHEETS INSTALLED VERTICALLY WITH BOTTOM AT 6" AFF. PLYWOOD SHALL BE PERMANENTLY FASTENED TO THE WALL BY MEANS OF WALL ANCHORS UTILIZING GALVANIZED, ZINC PLATED, OR STAINLESS STEEL HARDWARE WITH A FLAT HEAD. FINISHED INSTALLATION SHALL HAVE FLUSH APPEARANCE WITH COUNTERSUNK SCREW HEADS TO PREVENT SPLITTING OF THE PLYWOOD. DRYWALL SCREWS ARE NOT ACCEPTABLE. PAINT WITH TWO COATS OF LIGHT GRAY FIRE RETARDANT SEALER PRIOR TO INSTALLATION OF ANY EQUIPMENT.
- 5. TELECOMMUNICATIONS GROUND BAR AT 18" AFF. SEE DETAIL 6, SHEET E6.1.
- 6. (2) 4" EMT CONDUIT SLEEVES FROM OVERHEAD IN M/E ROOM 108, THROUGH M/E ROOM 206, AND STUBBED UP 4" ABOVE FINISHED FLOOR OF M/E ROOM 306 FOR COMMUNICATIONS BACKBONE CABLING. PROVIDE WITH FIRESTOPPING FITTINGS (WIREMOLD #FS4R-RED) AT BOTH ENDS.
- 7. (2) 4" CONDUITS FOR COMMUNICATIONS SERVICE CABLING ROUTED CONCEALED OVERHEAD AND STUBBED INTO M/E ROOM 108.
- 8. SEAL CONDUIT PENETRATIONS THROUGH EXTERIOR WALL WEATHERTIGHT.
- 9. COORDINATE FINAL LOCATIONS OF ALL CATV AND PHONE OUTLETS WITH OWNER. SEE 1:E6.2 FOR OUTLET DETAILS.
- 10. ADDRESSABLE FIRE ALARM RELAY FOR ELEVATOR POWER SHUNT-TRIP, AND ADDRESSABLE MONITORING MODULE FOR MONITORING OF SHUNT TRIP VOLTAGE. SEE DETAIL 4:E6.1.
- 11. ADDRESSABLE FIRE ALARM RELAYS FOR ELEVATOR PRIMARY AND ALTERNATE FLOOR RECALL AND FIREMAN'S HAT. MOUNT ON HOISTWAY WALL ABOVE CEILING AND PROVIDE ACCESS PANEL IN CEILING AS REQUIRED. COORDINATE WITH ELEVATOR EQUIPMENT INSTALLER AND G.C. SEE DETAIL 4:E6.1
- 12. INSTALL SMOKE DETECTOR AND HEAT DETECTOR AT TOP OF ELEVATOR HOISTWAY PER LOCAL JURISDICTION REQUIREMENTS. SEE DETAIL 4:E6.1.
- 13. INSTALL HEAT DETECTOR IN ELEVATOR PIT. SEE DETAIL 4:E6.1.
- 14. TELECOM DISTRIBUTION DEVICE APPROXIMATELY 4'-0" AFF. SEE DETAIL 1:E6.2. COORDINATE EXACT REQUIREMENTS WITH UTILITY PROVIDER SELECTED BY OWNER. HOMERUN CAT6 AND COAX CABLE TO ROOM INDICATED.
- 15. COORDINATE TELECOM OUTLET LOCATION NEAR TOP OF HOISTWAY WITH ELEVATOR
- 16. PROVIDE FIRE ALARM RELAYS AND MONITORING MODULES FOR ALL FIRE SPRINKLER FLOW SWITCHES, AND BELL/GONG. SEE E1.1 SITE PLAN FOR LOCATION OF TAMPER SWITCHES. COORDINATE QUANTITIES AND LOCATIONS WITH FIRE SPRINKLER CONTRACTOR PRIOR TO



1-16-2024 21-3166 SHEET NO.:


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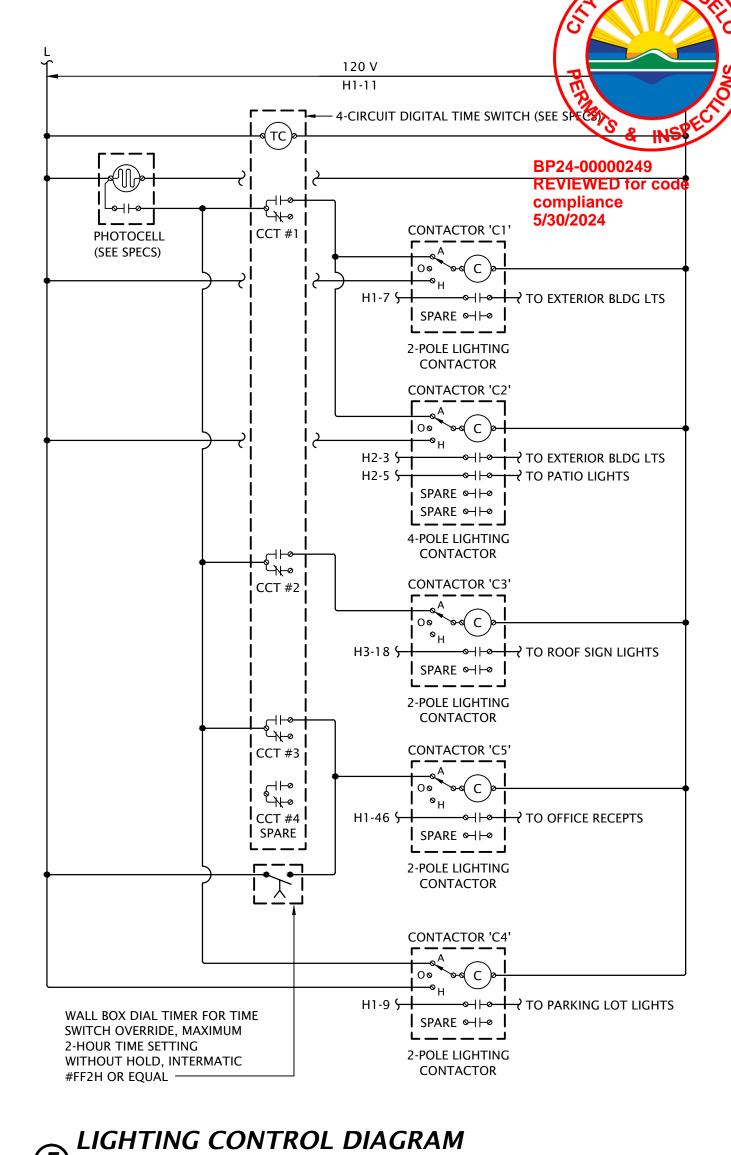
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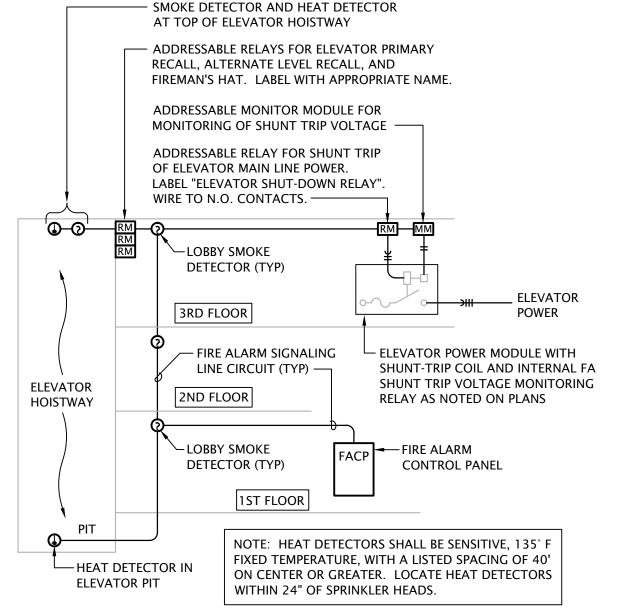


1. TELECOMMUNICATIONS GROUND BARS - BOND TO EQUIPMENT SHALL BE 13-1/4"W x 2"H x 1/4" THICK GROUND BUS (TYPICAL) ELECTRO-TIN PLATED COPPER BUS BAR, COMPLETE WITH INSULATED STAND-OFFS AND STAINLESS STEEL BRACKETS, ERICO #TGBA14L06PT OR EQUAL. 2. ALL GROUNDING / BONDING CONDUCTORS SHALL BE #4 AWG `-----INSULATED STRANDED COPPER. INSTALL IN 3/4" CONDUIT WHERE EXPOSED AND WHERE SUBJECT TO PHYSICAL DAMAGE. ,--------3. ALL CONNECTIONS TO GROUND BAR SHALL BE MADE USING COMPRESSION <u>H1</u> TYPE LUGS (MECHANICAL LUGS ARE NOT ACCEPTABLE). TMGB BOND TO BUILDING STEEL —

# 6 TELECOM GROUNDING & BONDING DIAGRAM No Scale





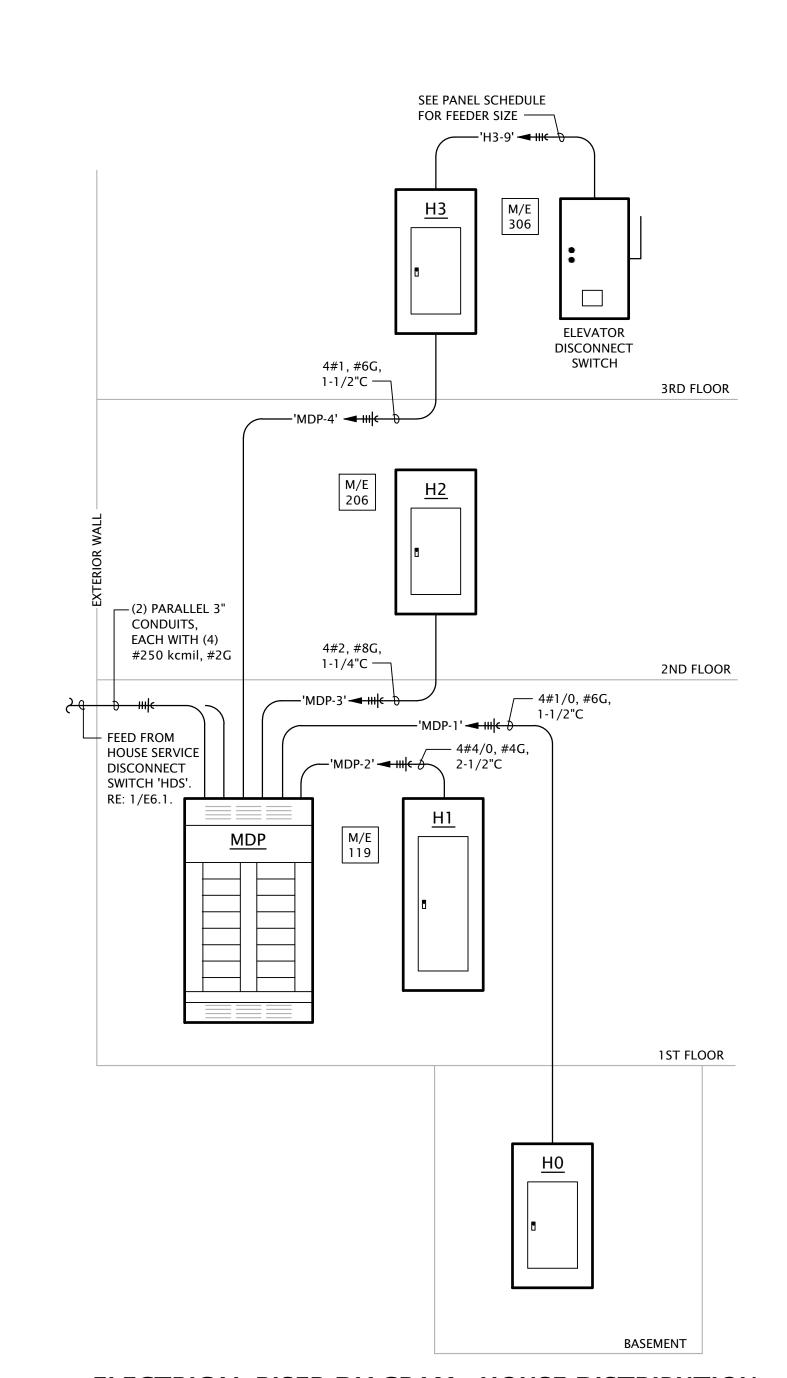

ELEVATOR SEQUENCE OF OPERATION: (DURING SMOKE/HEAT ALARM)

1. UPON SENSING SMOKE FROM ELEVATOR LOBBY(S) OR HOISTWAY, THE SMOKE DETECTOR SHALL SIGNAL THE FACP, WHICH WILL FORWARD THE SIGNAL TO THE ELEVATOR LOGIC CONTROLLER TO RECALL ELEVATOR CAB TO THE DESIGNATED MAIN FLOOR. IF DESIGNATED FLOOR'S LOBBY SMOKE DETECTOR SENSES SMOKE AT THAT FLOOR, THE ELEVATOR CONTROLLER WILL SEND THE ELEVATOR CAB TO THE NEXT FLOOR CLEAR OF SMOKE. ONCE THE ELEVATOR CAB HAS REACHED THE DESIGNATED FLOOR, THE ELEVATOR CAB DOORS WILL OPEN AND THE CONTROLLER WILL LOCK THE ELEVATOR CAB AT THAT FLOOR, DISABLING THE ELEVATOR CAB CONTROLS, UNLESS A FIREMAN'S KEY IS USED TO OVERRIDE AUTOMATIC CONTROLS.

- 2. ALL SMOKE DETECTORS SHALL TRANSMIT A SEPARATE AND DISTINCT VISIBLE ANNUNCIATION AT THE FACP AND ANNUNCIATOR PANEL.
- 3. HEAT DETECTORS IN THE ELEVATOR HOISTWAY WILL SEND A SIGNAL TO THE SHUNT-TRIP SWITCH POWERING THE ELEVATOR SO AS TO SHUT DOWN POWER TO THAT CIRCUIT. (THIS IS A NON-AUTO RESET SWITCH). WHEN THE SPRINKLER HEAD HAS REACHED ITS CRITICAL TEMPERATURE OF 165° F., THE HEAD WILL BEGIN DISCHARGE OF WATER.

# ELEVATOR INTERLOCK WITH FIRE ALARM

APARTMENT FEEDER SCHEDULE Apartment # Feeder Size COPPER (BASE BID): 1 (109), #2 (112), #3 (113), #4 (114), #5 (118), #9 (127) (3)#2, #6G IN 1-1/4" C OR MC-CABLE #10 (201), #11 (202), #12 (203), #13 (207), #14 (209) ALUMINUM (ALTERNATE BID): #18 (301), #19 (302), #21 (307) (3)#1/0, #4G IN 1-1/4" C OR MC-CABLE COPPER (BASE BID): #6 (122), #8 (126) (3)#1, #4G IN 1-1/4" C OR MC-CABLE #15 (211), #17 (213) ALUMINUM (ALTERNATE BID): #20 (303), #22 (309) (3)#2/0, #2G IN 1-1/2" C OR MC-CABLE COPPER (BASE BID): #7 (123) (3)#1/0, #3G IN 1-1/2" C OR MC-CABLE #16 (212) ALUMINUM (ALTERNATE BID): #23 (311), #24 (312), #25 (313) (3)#3/0, #1G IN 2" C OR MC-CABLE

Voltage drop has been accounted for in sizes indicated, further up-sizing of feeders is not necessary . Ensure panel lugs are adequately sized to handle up-sized feeders

Meter Center main circuit breaker shall be 65 kAIC fully rated. Feeder


breakers may be series rated with main breaker for a 65 kAIC rating. All conductor sizes are based on copper, U.N.O.

 Entire installation shall comply with NEC. Coordinate all responsibilities and requirements with power utility company and pay associated fees. Contact Information:

Jacob D Carson Technician Sr. (325) 657-2821 jdcarson@aep.com

- Coordinate final location of meter assemblies with utility company. Provide shop drawings of proposed equipment whether as specified or substituted to utility company for approval.
- All meter center components shall be NEMA 3R.
- All dimensions based on Square D equipment. It is the contractor's responsibility to verify the dimensions of substitute equipment. • For each meter, provide a permanent brass, copper or aluminum tag identifying the apartment served. Tags shall be securely fastened to

the meter base and be stamped with 1/8" letters, minimum.

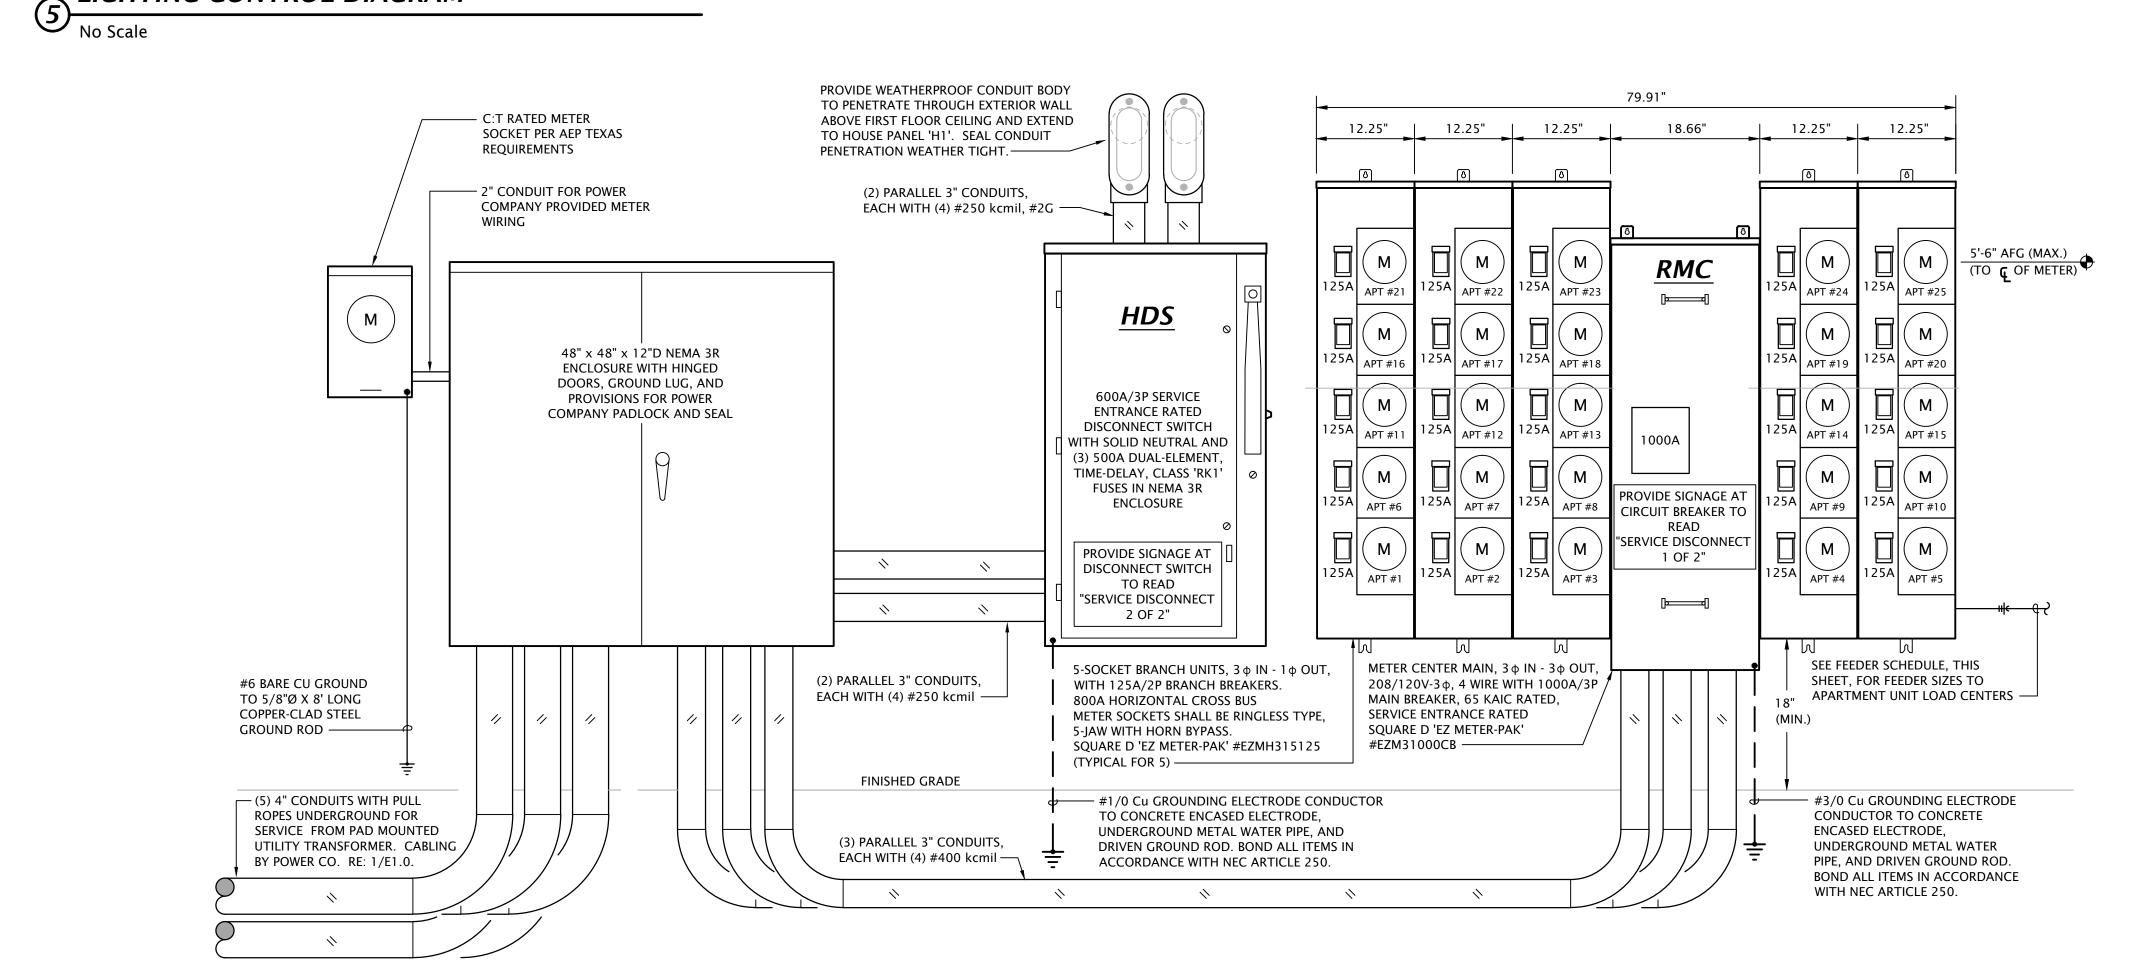

ELECTRICAL RISER DIAGRAM - SERVICE EQUIPMENT

E6.

1-16-2024

21-3166

1-16-2024

**REVISION:** 

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2 ELECTRICAL RISER DIAGRAM - HOUSE DISTRIBUTION

No Scale

CIRCUIT DESIGNATION: TOP INDICATES PANEL OF CIRCUIT ORIGIN BOTTOM INDICATES CIRCUIT NUMBER HOMERUN - WIRING TO PANEL OF CIRCUIT ORIGIN PARTIAL HOMERUN - WIRING TO PANEL OF CIRCUIT ORIGIN CONDUIT CONCEALED IN WALL OR ABOVE CEILING

---- CONDUIT BELOW GRADE OR EMBEDDED IN CONCRETE LINE VOLTAGE CIRCUIT CONDUCTORS SHORT = HOT/TRACER/SWITCH LEG CONDUCTOR LONG = NEUTRAL (GROUNDED) CONDUCTOR

CURVED = GROUNDING (BONDING) CONDUCTOR

——— CONDUIT STUB OUT WITH NYLON END BUSHING CONDUIT TURNED UP ───── CONDUIT TURNED DOWN

GROUNDING CONNECTION

LIGHTING SYMBOLS

CEILING FAN

PENDANT OR SURFACE MOUNTED LINEAR LUMINAIRE STANDARD STRIP LIGHT

SURFACE DOWNLIGHT WALL MOUNTED LUMINAIRE

TWIN HEAD EMERGENCY LIGHTING UNIT

COMBINATION EXIT/TWIN HEAD EMERGENCY LIGHTING UNIT WEATHERPROOF EXTERIOR REMOTE EMERGENCY HEAD - WALL AND CEILING MOUNTED

SINGLE FACE EXIT SIGN - WALL AND CEILING MOUNTED WITH DIRECTIONAL ARROWS AS INDICATED ON PLANS

DOUBLE FACE EXIT SIGN - WALL AND CEILING MOUNTED WITH DIRECTIONAL ARROWS AS INDICATED ON PLANS

**POWER SYMBOLS** 

SINGLE RECEPTACLE DUPLEX RECEPTACLE

DOUBLE DUPLEX RECEPTACLE

SPECIAL RECEPTACLE (# = NEMA CONFIGURATION)

SINGLE POLE TOGGLE SNAP SWITCH DOUBLE POLE TOGGLE SNAP SWITCH

THREE-WAY TOGGLE SNAP SWITCH MOTOR HP RATED SWITCH WITHOUT OVERLOAD PROTECTION

PRESET SLIDE DIMMER WALL SWITCH

TIMER WALL SWITCH

LINE VOLTAGE OCCUPANCY SENSING WALL SWITCH

LINE VOLTAGE CEILING OCCUPANCY SENSOR

TC TIMECLOCK

EXTERIOR PHOTOCELL

С CONTACTOR

POWER RELAY **CURRENT SWITCH** 

PUSH BUTTON OPERATOR

JUNCTION BOX

MOTORIZED DAMPER

DISCONNECT SWITCH

BRANCH CIRCUIT PANELBOARD, SURFACE MOUNTED BRANCH CIRCUIT PANELBOARD, FLUSH MOUNTED

DISTRIBUTION PANELBOARD

SITE ELECTRICAL SYMBOLS

— E UG — UNDERGROUND ELECTRICAL PRIMARY

— T UG — UNDERGROUND TELEPHONE SERVICE POLE MOUNTED AREA LIGHT **←**□

POWER COMPANY PAD MOUNTED UTILITY TRANSFORMER POWER COMPANY UTILITY POLE

### TELECOMMUNICATIONS SYMBOLS

TELECOM VOICE/DATA OUTLET (ROUGH-IN ONLY) LIVING UNIT OUTLET CATV/PHONE OUTLET TELECOMMUNICATIONS GROUND BAR TELECOMMUNICATIONS BOARD

### FIRE ALARM SYMBOLS

FIRE ALARM CONTROL PANEL MANUAL PULL STATION **HEAT DETECTOR** SPOT TYPE AREA SMOKE DETECTOR ADDRESSABLE MONITORING MODULE ADDRESSABLE RELAY MODULE ADDRESSABLE CONTROL MODULE NOTIFICATION HORN, WALL NOTIFICATION STROBE, WALL (CANDELA NOTED)

NOTIFICATION HORN/STROBE, WALL (CANDELA NOTED) NOTIFICATION HORN, LOW FREQUENCY TYPE, WALL

FIRE SPRINKLER SYSTEM FLOW SWITCH FIRE SPRINKLER SYSTEM TAMPER SWITCH FIRE SPRINKLER SYSTEM BELL/GONG

### SYMBOL MODIFYING DESIGNATORS

CEILING MOUNTED FLUSH MOUNTED IN SUSPENDED CEILINGS SURFACE MOUNTED TO STRUCTURE ABOVE IN OPEN CEILINGS MOUNT BOTTOM OF DEVICE AT 6" ABOVE COUNTERTOP GROUND FAULT CIRCUIT INTERRUPTING DEVICE NIGHTLIGHT WIRED TO UNSWITCHED HOT CONDUCTOR PROVIDE WEATHERPROOF ENCLOSURE FOR DEVICE

MOUNTING HEIGHT OF DEVICE ABOVE FINISHED FLOOR **ABBREVIATIONS** AMPERE ALTERNATING CURRENT ABOVE FINISH FLOOR CONDUIT COMMUNITY ANTENNA TELEVISION DIRECT CURRENT ELECTRICAL ELECTRICAL CONTRACTOR ELECTRICAL METALLIC TUBING GROUNDING (BONDING) CONDUCTOR GENERAL CONTRACTOR

GROUND FAULT CIRCUIT INTERRUPTER THOUSAND CIRCULAR MILLS MECHANICAL CONTRACTOR MCB MAIN CIRCUIT BREAKER MAIN LUG ONLY

NATIONAL ELECTRICAL CODE (NFPA 70) NFPA NATIONAL FIRE PROTECTION ASSOCIATION

POLYVINYL CHLORIDE CONDUIT

RCPT RECEPTACLE TYPICAL

UNDERWRITERS LABORATORY UNLESS NOTED OTHERWISE VOLT (ALTERNATING CURRENT)

VOLTAMPERE WATT(S)

### HS 120 VAC 24 VAC HORN/STROBE └ POWER SUPPLY

### DOOR ALARM BUZZER SYSTEM NOTES

1. PROVIDE DOOR ANNUNCIATOR SYSTEM COMPLETE WITH PUSH BUTTON, HORN/STROBE(S), POWER SUPPLIES AND ALL WIRING REQUIRED. HORN/STROBE SHALL ACTIVATE WHEN PUSH BUTTON IS DEPRESSED.

2. HORN/STROBE SHALL OPERATE AT 24VAC, HAVE A CLEAR LENS WITH 50cd STROBE AND HORN WITH 82dB AT 10', UL 1638 LISTED, EDWARDS #6536-G5. FLUSH MOUNT IN WALL AT 6'-8" AFF. 3. PUSH BUTTON SHALL BE WHITE WITH CHROME RIM, NON-ILLUMINATED, WITH N.O.

MOMENTARY CONTACTS, RATED FOR 0.67 AMPS AT 24VAC, EDWARDS #620. PROVIDE WITH STAINLESS STEEL COVER PLATE, EDWARDS #147-10. MOUNT AT 4. POWER SUPPLY SHALL BE A LOW VOLTAGE CLASS 2 TRANSFORMER WITH 120VAC

2-GANG WALL BOX WITH BLANK COVER PLATE, DIRECTLY ABOVE HORN/STROBE. 5. LOW VOLTAGE CLASS 2 CABLING SHALL BE MINIMUM 18 AWG UNSHIELDED.

PRIMARY AND 24VAC SECONDARY, 20VA, EDWARDS #598. FLUSH MOUNT IN

3 APARTMENT DOORBELL WIRING SCHEMATIC
No Scale





LST Consulting Engineers, PA MANHATTAN

4809 Vue Du Lac Place, Suite 201

125 S. Washington, Suite 150 January 2024

3P24-00 <b>007</b> REVIEWED fo	RTMENT L	IGHT FIXTURE SCHEDUL	E						
compliance 5/30/2024RK	MANUFACTURER	MODEL NUMBER	#	LAMP DATA	BALLAST/LED DRIVER	MOUNTING	FINISH	DESCRIPTION	NOTES
А	KICHLER	45650NBR	5	4W LED E12	STANDARD	WALL AT 88" AFF TO CENTER	NATURAL BRASS	32" 5 LIGHT LINEAR VANITY LIGHT	
В	SEAGULL	4423003EN3-710	3	9.5W LED	STANDARD	WALL AT 7'-0" AFF TO CENTER	BURNT SIENNA	3 LAMP VANITY LIGHT	
С	JESCO	DL-AC-FLEX2-NPX-FR-3090		6W/FT LED 312 LUMENS/FT	STANDARD	COVE	WHITE	LINEAR LINE VOLTAGE LED STRIP LIGHT, LENGTH AS NOTED ON DRAWINGS	
D	SHADES OF LIGHT	CH23110 AB	6	5W LED E12	STANDARD	PENDANT	AGED BRASS	6 LIGHT CHANDELIER	
E	DUAL-LITE	EV2I	2	1W LED	N/A	WALL AT 7'-6" AFF	WHITE	TWIN HEAD EMERGENCY LIGHT	3
F	ELEGANT LIGHTING	LD5027	4	4W LED E12	STANDARD	PENDANT	ANTIQUE BRONZE	4 LIGHT CLEAR CRYSTAL PENDANT	
G	WAC LIGHTING	F-060-MB		N/A	N/A	SURFACE	MATTE BLACK	52"Ø, 3-BLADE CEILING FAN	
Н	METALUX	4WNLED-LD4-40SL-F-UNV-L835-CD1		30W LED 4,000 LUMENS	0-10V DIMMING (10%-100%)	SURFACE	WHITE	4' UTILITY WRAPAROUND WITH FROSTED ACRYLIC PRISMATIC LENS	-
J	HALO	SMD6R-12-930-WH		15W LED 1,200 LUMENS	PHASE DIMMING	SURFACE	WHITE	6" ROUND SURFACE MOUNT DOWNLIGHT	4
JI	HALO	SMD6R-12-930-WH-E		15W LED 1,200 LUMENS	0-10V DIMMING (10%-100%)	SURFACE	WHITE	6" ROUND SURFACE MOUNT DOWNLIGHT	
К	METALUX	4SNLED-LD5-50SL-LW-UNV-L835-CD1		46W LED 5,251 LUMENS	0-10V DIMMING (10%-100%)	SURFACE	WHITE	4' LED STRIP WITH FROSTED LENS, WIDE DISTRIBUTION	
L	METALUX	2SNLED-LD5-23SL-LW-UNV-L835-CD1		21W LED 2,453 LUMENS	0-10V DIMMING (10%-100%)	SURFACE	WHITE	2' LED STRIP WITH FROSTED LENS, WIDE DISTRIBUTION	
М	VISUAL COMFORT & CO	EW1151BBS	1	8W LED A19	INTEGRAL TO LAMP	WALL AT 78" AFF	BURNISHED BRASS	DECORATIVE WALL SCONCE	
N	VISUAL COMFORT & CO	7000WWND-B-LED		20W LED 184 LUMENS	STANDARD	WALL AT 78" AFF	BLACK	EXTERIOR WALL SCONCE	4
P	METALUX	4APVTLD-SL3C3		32W LED 4600 LUMENS	STANDARD	SURFACE	WHITE	4' FULLY ENCLOSED AND GASKETED INDUSTRIAL VAPORTITE WITH IMPACT RESISTANT DIFFUSE POLYCARBONATE LENS	4
Q1	GARDCO	GBS-A02-830-T2M GF-WS-BK		17W LED 1,467 LUMEN	STANDARD	WALL AT 9'-6" AFF	BLACK	IES TYPE 2 EXTERIOR WALL SCONCE, SURFACE MOUNT BOX	4
Q2	GARDCO	GBS-B02-830-PEN GF-WS-BK		18W LED 1,467 LUMEN	STANDARD	WALL AT 4'-0" AFF	BLACK	PENCIL BEAM EXTERIOR WALL SCONCE AIMED UPWARD, SURFACE MOUNT BOX	4
R	GARDCO	PWS-48L-300-WW-G2-3-120-BK PWS-WS-G2		47W LED 5,667 LUMENS	STANDARD	WALL AT 10'-0" AFF	BLACK	DIE-CAST ALUMINUM WALL PACK, IES TYPE III DISTRIBUTION, SURFACE MOUNT BOX	4
S	GARDCO	ECF-S-32L-1A-NW-G2-AR-2-UNV-BL-IMRI7-HIS-BZ		106W LED 13,685 LUMENS	0-10V DIMMING	20' RSS POLE	BRONZE	DIE CAST ALUMINUM AREA LIGHT, IES TYPE II DISTRIBUTION, HOUSE SIDE SHIELD	4, 5, 6
τ	GARDCO	FLDS-A01-740-7x6-YOK-UNV-BZ		29 W LED 3,400 LUMENS	STANDARD	YOKE	BRONZE	DIE CAST ALUMINUM FLOOD LIGHT, NEMA 7x6 WIDE FLOOD DISTRIBUTION	4
х	MULE	MXBRU-SD		RED LED LETTERS	N/A	WALL/CEILING/END	WHITE	UNIVERSAL SINGLE/DOUBLE FACE THERMOPLASTIC EXIT SIGN WITH BREAK-OUT CHEVRONS AND INTEGRAL BATTERY BACKUP	1, 2
XE	MULE	SQC-LED-U-R-WW-SD	(2)	RED LED LETTERS 1W LED HEADS	N/A	WALL/CEILING	WHITE	UNIVERSAL SINGLE/DOUBLE FACE COMBO EXIT SIGN/TWIN HEAD EMERGENCY LIGHT WITH CHEVRONS AND BATTERY BACKUP	1, 2
XER	MULE	SQC-LED-U-R-WW-SD/REM R-ASRLED-1-WP-BL	(2)	RED LED LETTERS 1W LED HEADS 1W REMOTE HEAD	N/A	WALL/CEILING	WHITE	UNIVERSAL SINGLE/DOUBLE FACE COMBO EXIT SIGN/TWIN HEAD EMERGENCY LIGHT WITH CHEVRONS AND REMOTE BATTERY CAPACITY FOR EXTERIOR REMOTE HEAD	1, 2, 7

### **GENERAL**:

All LED fixtures shall be provided with drivers capable of operating at 120V.

All exterior fixtures shall be 4000°K color temperature.

 All interior fixtures shall be 3000°K color temperature. • All apartment light fixtures and ceiling fans shall be Energy Star rated.

1. Fixture shall have self-diagnostic/self-testing electronics.


2. Provide with emergency battery integral charger

3. Provide with test switch, status indicator and rechargeable nickel-cadmium battery for 90 minutes of emergency power.


4. Fixture shall be U.L. listed for wet locations.

5. Provide luminaire with integral PIR motion sensor to dim fixture to 50% output when motion has not been detected for 15 minutes or more.

6. Provide with 20' square straight steel pole with vibration isolation damper, bronze to match fixture. Assembly shall be rated for 110 mph wind loads. 7. Provide direct current power wiring from combo unit to exterior remote head. Wiring shall be 2#10 in 1/2"C.

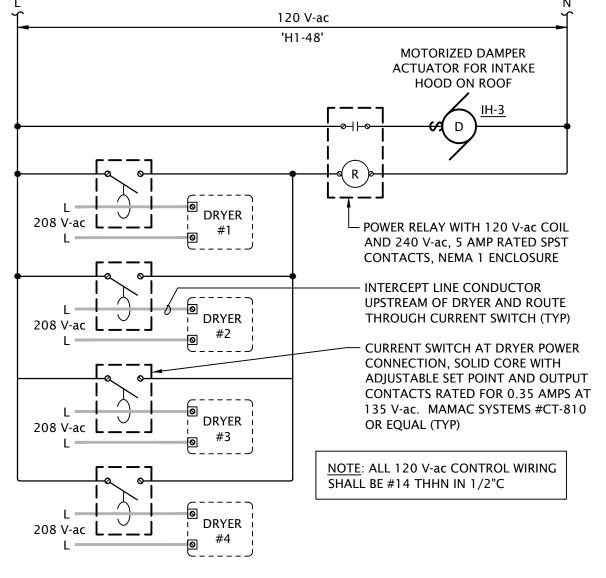



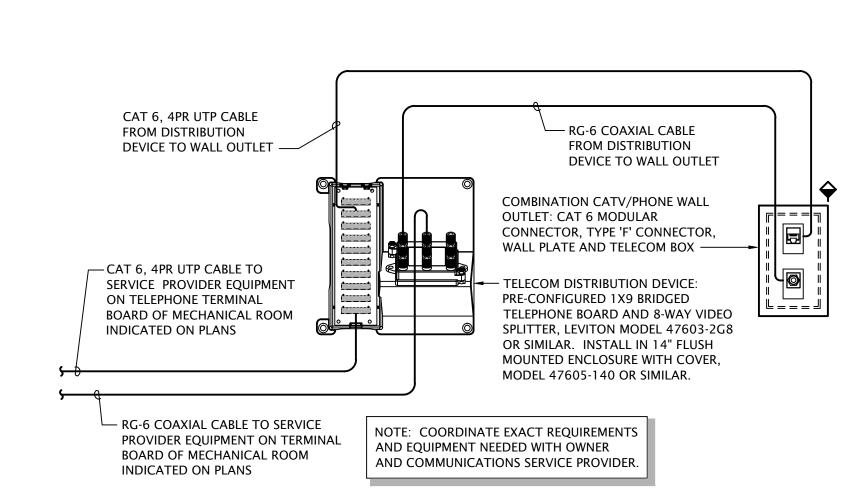

# 1 APARTMENT TELECOM WIRING SCHEMATIC NO SCALE

E6.2

1-16-2024

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1-16-2024

**REVISION:** 

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		1 Bedroom Apartn 208/120V-1Ph-3W		Mounting: Flush Bus Amps: 125 MCB Amps: MLO Other: 10 KAIC Panel is typical for 1BR units				
Circuit	# Load Description	Conductors	C/B Size	C/B Size	Conductors	Load Description	Circuit #	
1	CLOSET RCPT (TELECOM)	2#12,#12G,1/2"C	20 / 1	20 / 1	2#12, #12G, 1/2"C	KITCHEN/LIVING/HALL LTS	2	
3	DIS HWAS HER/DIS POS AL	2#12,#12G,1/2"C	20 / 1	20 / 1	2#12, #12G, 1/2"C	CLOTHES WASHER RCPT	4	
5	HOOD/MICROWAVE	2#12,#12G,1/2"C	20 / 1	30 / 2	3#10, #10G, 3/4"C	CLOTHES DRYER	6	
7	REFRIGERATOR	2#12,#12G,1/2"C	20 / 1				8	
9	COUNTER TOP RCPTS	2#12,#12G,1/2"C	20 / 1	40 / 2	3#8, #10G, 1"C	RANGE	10	
11	COUNTER TOP RCPTS	2#12,#12G,1/2"C	20 / 1				12	
13	LIVING ROOM RCPTS	2#12,#12G,1/2"C	20 / 1	25 / 2	2#10, #10G, 3/4"C	HEAT PUMP 'HP'	14	
15	BATHROOM	2#12,#12G,1/2"C	20 / 1				16	
17	BEDROOM	2#12,#12G,1/2"C	20 / 1	45 / 2	2#6,#10G,3/4"C	BLOWER COIL 'BC'	18	
19	SPACE ONLY						20	
21	SPACE ONLY			30 / 2	2#10,#10G,3/4"C	WATER HEATER 'HWH'	22	
23	SPACE ONLY						24	

		2 Bedroom Apartn 208/120V-1Ph-3W		Mounting: Flush  Bus Amps: 125  MCB Amps: MLO  Other: 10 KAIC  Panel is typical for 2BR units				
Circuit #	Load Description	Conductors	C/B Size	C/B Size	Conductors	Load Description	Circuit #	
] 1	CLOSET RCPT (TELECOM)	2#12, #12G, 1/2"C	20 / 1	20 / 1	2#12,#12G,1/2"C	KITCHEN/LIVING/HALL LTS	2	
3	DIS HWAS HER/DIS POS AL	2#12, #12G, 1/2"C	20 / 1	20 / 1	2#12,#12G,1/2"C	CLOTHES WASHER RCPT	4	
5	HOOD/MICROWAVE	2#12, #12G, 1/2"C	20 / 1	30 / 2	3#10, #10G, 3/4"C	CLOTHES DRYER	6	
7	REFRIGERATOR	2#12, #12G, 1/2"C	20 / 1				8	
9	COUNTER TOP RCPTS	2#12, #12G, 1/2"C	20 / 1	40 / 2	3#8, #10G, 1"C	RANGE	10	
11	COUNTER TOP RCPTS	2#12, #12G, 1/2"C	20 / 1				12	
13	LIVING ROOM RCPTS	2#12, #12G, 1/2"C	20 / 1	25 / 2	2#10, #10G, 3/4"C	HEAT PUMP 'HP'	14	
15	BATHROOM	2#12, #12G, 1/2"C	20 / 1				16	
17	BEDROOM	2#12, #12G, 1/2"C	20 / 1	45 / 2	2#6,#10G,3/4"C	BLOWER COIL 'BC'	18	
19	BEDROOM	2#12, #12G, 1/2"C	20 / 1				20	
21	SPACE ONLY			30 / 2	2#10,#10G, 3/4"C	WATER HEATER 'HWH'	22	
23	S PACE ONLY						24	

	ignation: MDP .ocation: M/E 119 Voltage: 208Y/120V-3Ph-4W	Enclosure: NEMA 1  Mounting: Wall  Manufacturer: Square D 'I-LINE'	Bus Amps: 6 MCB Amps: N AIC Rating: 3	<b>ILO</b>
Circuit #	Equipment Served	Feeder Size	C/B Size	Remarks
1	PANEL 'HO'	SEE RISER DIAGRAM 2/E6.1	150/3	
2	PANEL 'H1'	SEE RISER DIAGRAM 2/E6.1	225/3	
3	PANEL 'H2'	SEE RISER DIAGRAM 2/E6.1	100/3	
4	PANEL 'H3'	SEE RISER DIAGRAM 2/E6.1	125/3	
5	BUSSED SPACE		225A	PROVISIONAL SPACE
6	BUSSED SPACE		225A	PROVISIONAL SPACE
7	BUSSED SPACE		225A	PROVISIONAL SPACE

	Designation:	24-00000249 VIEWED for code	)		Manufacturer:	Square D 'NO'				
	Location Location	mpliance			Bus Amps: MCB Amps:	100				
	Enclosure: Mounting:	NEMA 1		AIC Rating: 10 kAIC Other:						
Circuit #	Load Description	Conductors	C/B Size	C/B Size	Conductors	Load Description	Circuit #			
1	LTG: HALL/STAIR	2#12, #12G, 1/2"C	20 / 1	60 / 2	2#4, #10G, 3/4"C	'BC-4' (CIRCUIT #1)	2			
3	LTG: EXTERIOR UPLIGHTS	2#12, #12G, 1/2"C	20 / 1				4			
5	LTG: PATIO LIGHTS	2#12, #12G, 1/2"C	20 / 1	45 / 2	2#6, #10G, 3/4"C	'BC-4' (CIRCUIT #2)	6			
7	RCPT: HALL W	2#12, #12G, 1/2"C	20 / 1				8			
9	RCPT: HALL E	2#12, #12G, 1/2"C	20 / 1	20 / 1		S PARE BREAKER	10			
11	RCPT: PATIO	2#12, #12G, 1/2"C	20 / 1	20 / 1		S PARE BREAKER	12			
13	SPACE ONLY					SPACE ONLY	14			
15	S PACE ONLY					SPACE ONLY	16			
17	S PACE ONLY					SPACE ONLY	18			
19	SPACE ONLY					SPACE ONLY	20			
21	SPACE ONLY					SPACE ONLY	22			
23	SPACE ONLY					SPACE ONLY	24			
25	SPACE ONLY					SPACE ONLY	26			
27	SPACE ONLY					SPACE ONLY	28			
29	SPACE ONLY					SPACE ONLY	30			

	Designation: Location: Voltage: Enclosure: Mounting:	208Y/120V-3Ph-4W NEMA 1		Manufacturer: Square D 'NQ'  Bus Amps: 225  MCB Amps: MLO  AIC Rating: 10 kAIC  Other:					
Circuit #	Load Description	Conductors	C/B Size	C/B Size	Conductors	Load Description	Circuit #		
1	LTG: HALL/STAIR	2#12, #12G, 1/2"C	20 / 1	20 / 2	2#12, #12G, 1/2"C	HEAT PUMP 'HP-1.5'	2		
3	ROOFTOP SIGN LIGHTS	2#12, #12G, 1/2"C	20 / 1				4		
5	RCPT: ROOF	2#10, #10G, 1/2"C	20 / 1	40 / 2	2#8, #10G, 3/4"C	HEAT PUMP 'HP-4'	6		
7							8		
9	ELEVATOR	3#4, #8G, 1"C	70 / 3	40 / 2	2#8, #10G, 3/4"C	OUTDOOR A/C UNIT 'OU-1'	10		
11							12		
13	ELEVATOR CAB LTS/EXH.	2#12, #12G, 1/2"C	20 / 1	15 / 2	2#12, #12G, 1/2"C	OUTDOOR A/C UNIT 'OU-2'	14		
15	ELEV. HOISTWAY RCPT	2#12, #12G, 1/2"C	20 / 1				16		
17	ELEV. HOISTWAY LIGHT	2#12, #12G, 1/2"C	20 / 1	20 / 1	2#12, #12G, 1/2"C	ROOF SIGN LIGHTING	18		
19	RCPT: TELECOM BD	2#12, #12G, 1/2"C	20 / 1	20 / 1		S PARE BREAKER	20		
21	RCPT: HALL W	2#12, #12G, 1/2"C	20 / 1	20 / 1		SPARE BREAKER	22		
23	RCPT: HALL E	2#12, #12G, 1/2"C	20 / 1	20 / 1		S PARE BREAKER	24		
25	SPACE ONLY					S PACE ONLY	26		
27	SPACE ONLY					SPACE ONLY	28		
29	SPACE ONLY					SPACE ONLY	30		

### **FANEL SCHEDULE NOTES BY SYMBOL**

- 1. CLASS 'A', 5mA RATED, GROUND FAULT CIRCUIT INTERRUPTING (GFCI) TYPE BREAKER.
- 2. ARC FAULT CIRCUIT INTERRUPTING (AFCI) TYPE BREAKER.
- 3. COMBINATION AFCI/GFCI BREAKER.

		Basement 208Y/120V-3Ph-4W NEMA 1		Manufacturer: Square D 'NQ'  Bus Amps: 225  MCB Amps: MLO  AIC Rating: 10 kAIC  Other:						
Circuit #	Load Description	Conductors	C/B Size	C/B Size	Conductors	Load Description	Circuit #			
1				20 / 1	2#12, #12G, 1/2"C	BAS EMENT LIGHTS	2			
3	'HWH-B' (NORTH)	3#6, #10G, 3/4"C	60 / 3	20 / 1	2#12, #12G, 1/2"C	BASEMENT HEATER 'EWH-4'	4			
5				20 / 1	2#12, #12G, 1/2"C	HW RECIRC PUMP 'HWP'	6			
7				20 / 1	2#12, #12G, 1/2"C	BASEMENT RCPTS	8			
9	'HWH-B' (MID)	3#6, #10G, 3/4"C	60 / 3	20 / 1	2#12, #12G, 1/2"C	FIRE SPRINKLER FLOW/BELL	10			
11				20 / 1	2#12, #12G, 1/2"C	SEWAGE EJECTOR CONTROL	12			
13				20 / 1	2#12, #12G, 1/2"C	SEWAGE EJECTOR PUMP	14			
15	'HWH-B' (SOUTH)	3#6, #10G, 3/4"C	60 / 3			SPACE ONLY	16			
17						SPACE ONLY	18			
19	SPACE ONLY					SPACE ONLY	20			
21	SPACE ONLY					SPACE ONLY	22			
23	SPACE ONLY					SPACE ONLY	24			
25	SPACE ONLY					SPACE ONLY	26			
27	SPACE ONLY					SPACE ONLY	28			
29	SPACE ONLY					SPACE ONLY	30			

Designation: H1 Location: M/E 119 Voltage: 208Y/120V-3Ph-4W Enclosure: NEMA 1 Mounting: Surface			Manufacturer: Square D 'NQ'  Bus Amps: 225  MCB Amps: MLO  AIC Rating: 25 kAIC  Other:				
Circuit #	Load Description	Conductors	C/B Size	C/B Size	Conductors	Load Description	Circuit #
1	LTG: OFFICE/RESTRMS	2#12, #12G, 1/2"C	20 / 1	15 / 2	2#12, #12G, 1/2"C	OUTDOOR A/C UNIT 'OU-3'	2
3	LTG: HALL/LAUNDRY	2#12, #12G, 1/2"C	20 / 1				4
5	LTG: COMMUNITY RM/HALL	2#12, #12G, 1/2"C	20 / 1	25 / 2	2#10, #10G, 1/2"C	HEAT PUMP 'HP-2.5'	6
7	EXTERIOR WALL LTS	2#12, #12G, 1/2"C	20 / 1				8
9	PARKING LOT POLE LTS	2#10, #10G, 3/4"C	20 / 1	50 / 2	2#6, #10G, 3/4"C	'BC-2.5b' (CIRCUIT #1)	10
11	EXTERIOR LTG CONTROLS	2#12, #12G, 1/2"C	20 / 1				12
13	CLOTHES DRYER	3#10, #10G, 3/4"C	30 / 2	25 / 2	2#10, #10G, 1/2"C	'BC-2.5b' (CIRCUIT #2)	14
15							16
17	CLOTHES DRYER	3#10, #10G, 3/4"C	30 / 2	40 / 2	2#8, #10G, 3/4"C	'BC-1.5'	18
19							20
21	CLOTHES DRYER	3#10, #10G, 3/4"C	30 / 2	20 / 1	2#12, #12G, 1/2"C	WALL HEATER 'EWH-1'	22
23				20 / 1	2#12, #12G, 1/2"C	WALL HEATER 'EWH-2'	24
25	CLOTHES DRYER	3#10, #10G, 3/4"C	30 / 2	20 / 1	2#12, #12G, 1/2"C	WALL HEATER 'EWH-3'	26
27				20 / 1	2#12, #12G, 1/2"C	DRINKING FOUNTAIN	28
29	WASHER	2#12, #12G, 1/2"C	20 / 1	20 / 1	2#12, #12G, 1/2"C	RCPT: TELECOM BOARD	30
31	WASHER	2#12, #12G, 1/2"C	20 / 1	20 / 1	2#12, #12G, 1/2"C	RCPT: PANTRY MICROWAVE	32
33	WASHER	2#12, #12G, 1/2"C	20 / 1	20 / 1	2#12, #12G, 1/2"C	RCPT: HALL W	34
35	WASHER	2#12, #12G, 1/2"C	20 / 1	20 / 1	2#12, #12G, 1/2"C	RCPT: COMMUNITY RM	36
37	EV CHARGING STATION	2#8, #10G, 3/4"C	40 / 2	20 / 1	2#12, #12G, 1/2"C	RCPT: LAUNDRY/JAN	38
39				20 / 1	2#12, #12G, 1/2"C	RCPT: HALL E	40
41	EV CHARGING MAINT. RCPT	2#10, #10G, 3/4"C	20 / 1	20 / 1	2#12, #12G, 1/2"C	FIRE ALARM CONTROL PNL	42
43	ELEVATOR PIT RCPT	2#12, #12G, 1/2"C	20 / 1	20 / 1	2#12, #12G, 1/2"C	RCPT: OFFICE UNSWITCHED	44
45	ELEVATOR PIT LIGHT	2#12, #12G, 1/2"C	20 / 1	20 / 1	2#12, #12G, 1/2"C	RCPT: OFFICE SWTCHED	46
47	ELEVATOR SUMP PUMP ALARM PANEL	2#12, #12G, 1/2"C	20 / 1	20 / 1	2#12, #12G, 1/2"C	DRYER MAKE-UP AIR CNTL	48
49	ELEVATOR SUMP PUMP RCPT	2#12, #12G, 1/2"C	20 / 1	20 / 1	2#12, #12G, 1/2"C	RCPT: ROOFTOP	50
51	SPARE BREAKER		20 / 1	20 / 1		SPARE BREAKER	52
53	SPARE BREAKER		20 / 1	20 / 1		SPARE BREAKER	54
55	S PACE ONLY					SPACE ONLY	56
57	SPACE ONLY					SPACE ONLY	58
59	S PACE ONLY					SPACE ONLY	60

1-16-2024 21-3166 SHEET NO.:

**E6.3**