


REVISION:	1-16-2024
DATE:	1-16-2024
JOB:	21-3166
SHEET NO.:	

#

MECHANICAL NOTES BY SYMBOL

- TRANSITION FROM 8"Ø TO 12/4 DUCT AND ROUTE BELOW BEAM IN SOFFIT. INSTALL DUCT AS HIGH AS POSSIBLE TO BEAM. COORDINATE EXACT ROUTING AND SOFFIT LOCATION WITH G.C. AND ARCHITECT.
- DUCT TO BE ROUTED IN SOFFIT, INSTALL AS HIGH AS POSSIBLE TO STRUCTURE. COORDINATE EXACT ROUTING AND SOFFIT LOCATION WITH G.C. AND ARCHITECT.
- PROVIDE UL LISTED DRYER BOX EQUAL TO IN-O-VATE TECHNOLOGIES IN WALL INSTALLED IN ACCORDANCE WITH MANUFACTURER'S RECOMMENDATIONS, AND ROUTE 4"Ø DRYER EXHAUST DUCT TO ROOF JACK WITH BACKDRAFT DAMPER. MAXIMUM ALLOWABLE EQUIVALENT DUCT LENGTH = 35'. COORDINATE EXACT REQUIREMENTS WITH EQUIPMENT PROVIDED. PROVIDE PERMANENT LABEL IDENTIFYING EQUIVALENT LENGTH OF DRYER DUCT INSTALLED PER IMC 504.  
NOTE: ANNULAR SPACE AROUND DUCT IS TO BE SEALED AT ALL PENETRATIONS OF FLOORS AND CEILINGS WITH U.L. LISTED FIRE STOPPING SYSTEM.
- ROUTE REFRIGERANT PIPING FROM BLOWER COIL TO MATCHING HEAT PUMP CONCEALED ABOVE CEILINGS AND IN WALLS. SEE M1.4 FOR HEAT PUMP LOCATIONS.
- MOUNT TRANSFER GRILLE IN BEDROOM 6" BELOW CEILING AND MOUNT TRANSFER GRILLE ON OPPOSITE SIDE OF WALL 6" ABOVE FINISHED FLOOR. LINE STUD CAVITY WITH SHEET METAL.
- PROVIDE AUXILIARY DRAIN PAN BELOW BLOWER COIL AND PIPE OVERFLOW DRAIN TO FLOOR DRAIN.
- ROUTE 4" EXHAUST UP IN WALL TO ROOF. DUCTS SHALL BE RUN IN WALLS CONTINUOUS FROM EXHAUST FAN TO EXTERIOR OF BUILDING WITHOUT BEING COMBINED. COORDINATE EXACT ROUTING AND WALL LOCATIONS WITH G.C. AND EXISTING CONDITIONS.
- ROUTE DUCTWORK UP TO SUPPLY GRILLE AT FLOOR ABOVE.
- CONNECT OUTDOOR AIR DUCT TO RETURN DUCT AT BLOWER COIL AND BALANCE AS INDICATED ON PLANS.
- 8"Ø OUTDOOR AIR DUCT FROM FLOOR ABOVE, SEE M1.3 FOR CONTINUATION.
- TRANSITION TO 16/10 RETURN DUCT AND ROUTE UP TO 3RD FLOOR, SEE M1.3 FOR CONTINUATION.
- ROUTE OPEN ENDED TRANSFER DUCT FROM MECHANICAL CLOSET THROUGH LOWERED CEILING, TRANSITION TO WALL MOUNTED RETURN GRILLE IN APARTMENT.
- MOUNT RETURN GRILLE LOW IN WALL.
- SEE ROOF PLAN ON M1.4 FOR MORE INFORMATION.
- ROUTE REFRIGERANT PIPING. CONCEALED IN WALLS AND ABOVE CEILING FROM INDOOR UNIT TO MATCHING HEAT PUMP UNIT ON ROOF. FIELD COORDINATE EXACT ROUTING WITH EXISTING CONDITIONS AND OTHER TRADES.
- ROUTE CONDENSATE PIPING FROM INDOOR UNIT CONCEALED IN WALL TO FLOOR DRAIN IN MECHANICAL CLOSET. FIELD COORDINATE ROUTING WITH OTHER TRADES.
- ROUTE CONDENSATE PIPING FORM INDOOR UNIT ABOVE CONCEALED ABOVE CEILING TO FLOOR DRAIN IN MECHANICAL CLOSET. FIELD COORDINATE EXACT ROUTING WITH EXISTING CONDITIONS AND OTHER TRADES.
- THERMOSTAT SHALL BE CONFIGURED TO PROVIDE A TEMPERATURE RANGE OR DEADBAND OF NOT LESS THAN 5°F BETWEEN CHANGEOVER FROM HEATING TO COOLING MODES.

- NOTES:
- ALL DUCTWORK SHALL BE SEALED PER 2021 IECC REQUIREMENTS. COORDINATE REQUIREMENTS WITH G.C.
  - DUCTWORK AT SUPPLY, RETURN, AND TRANSFER AIR REGISTERS SHALL BE SEALED TO FLOOR, WALL, OR CEILING USING HVAC TAPE.

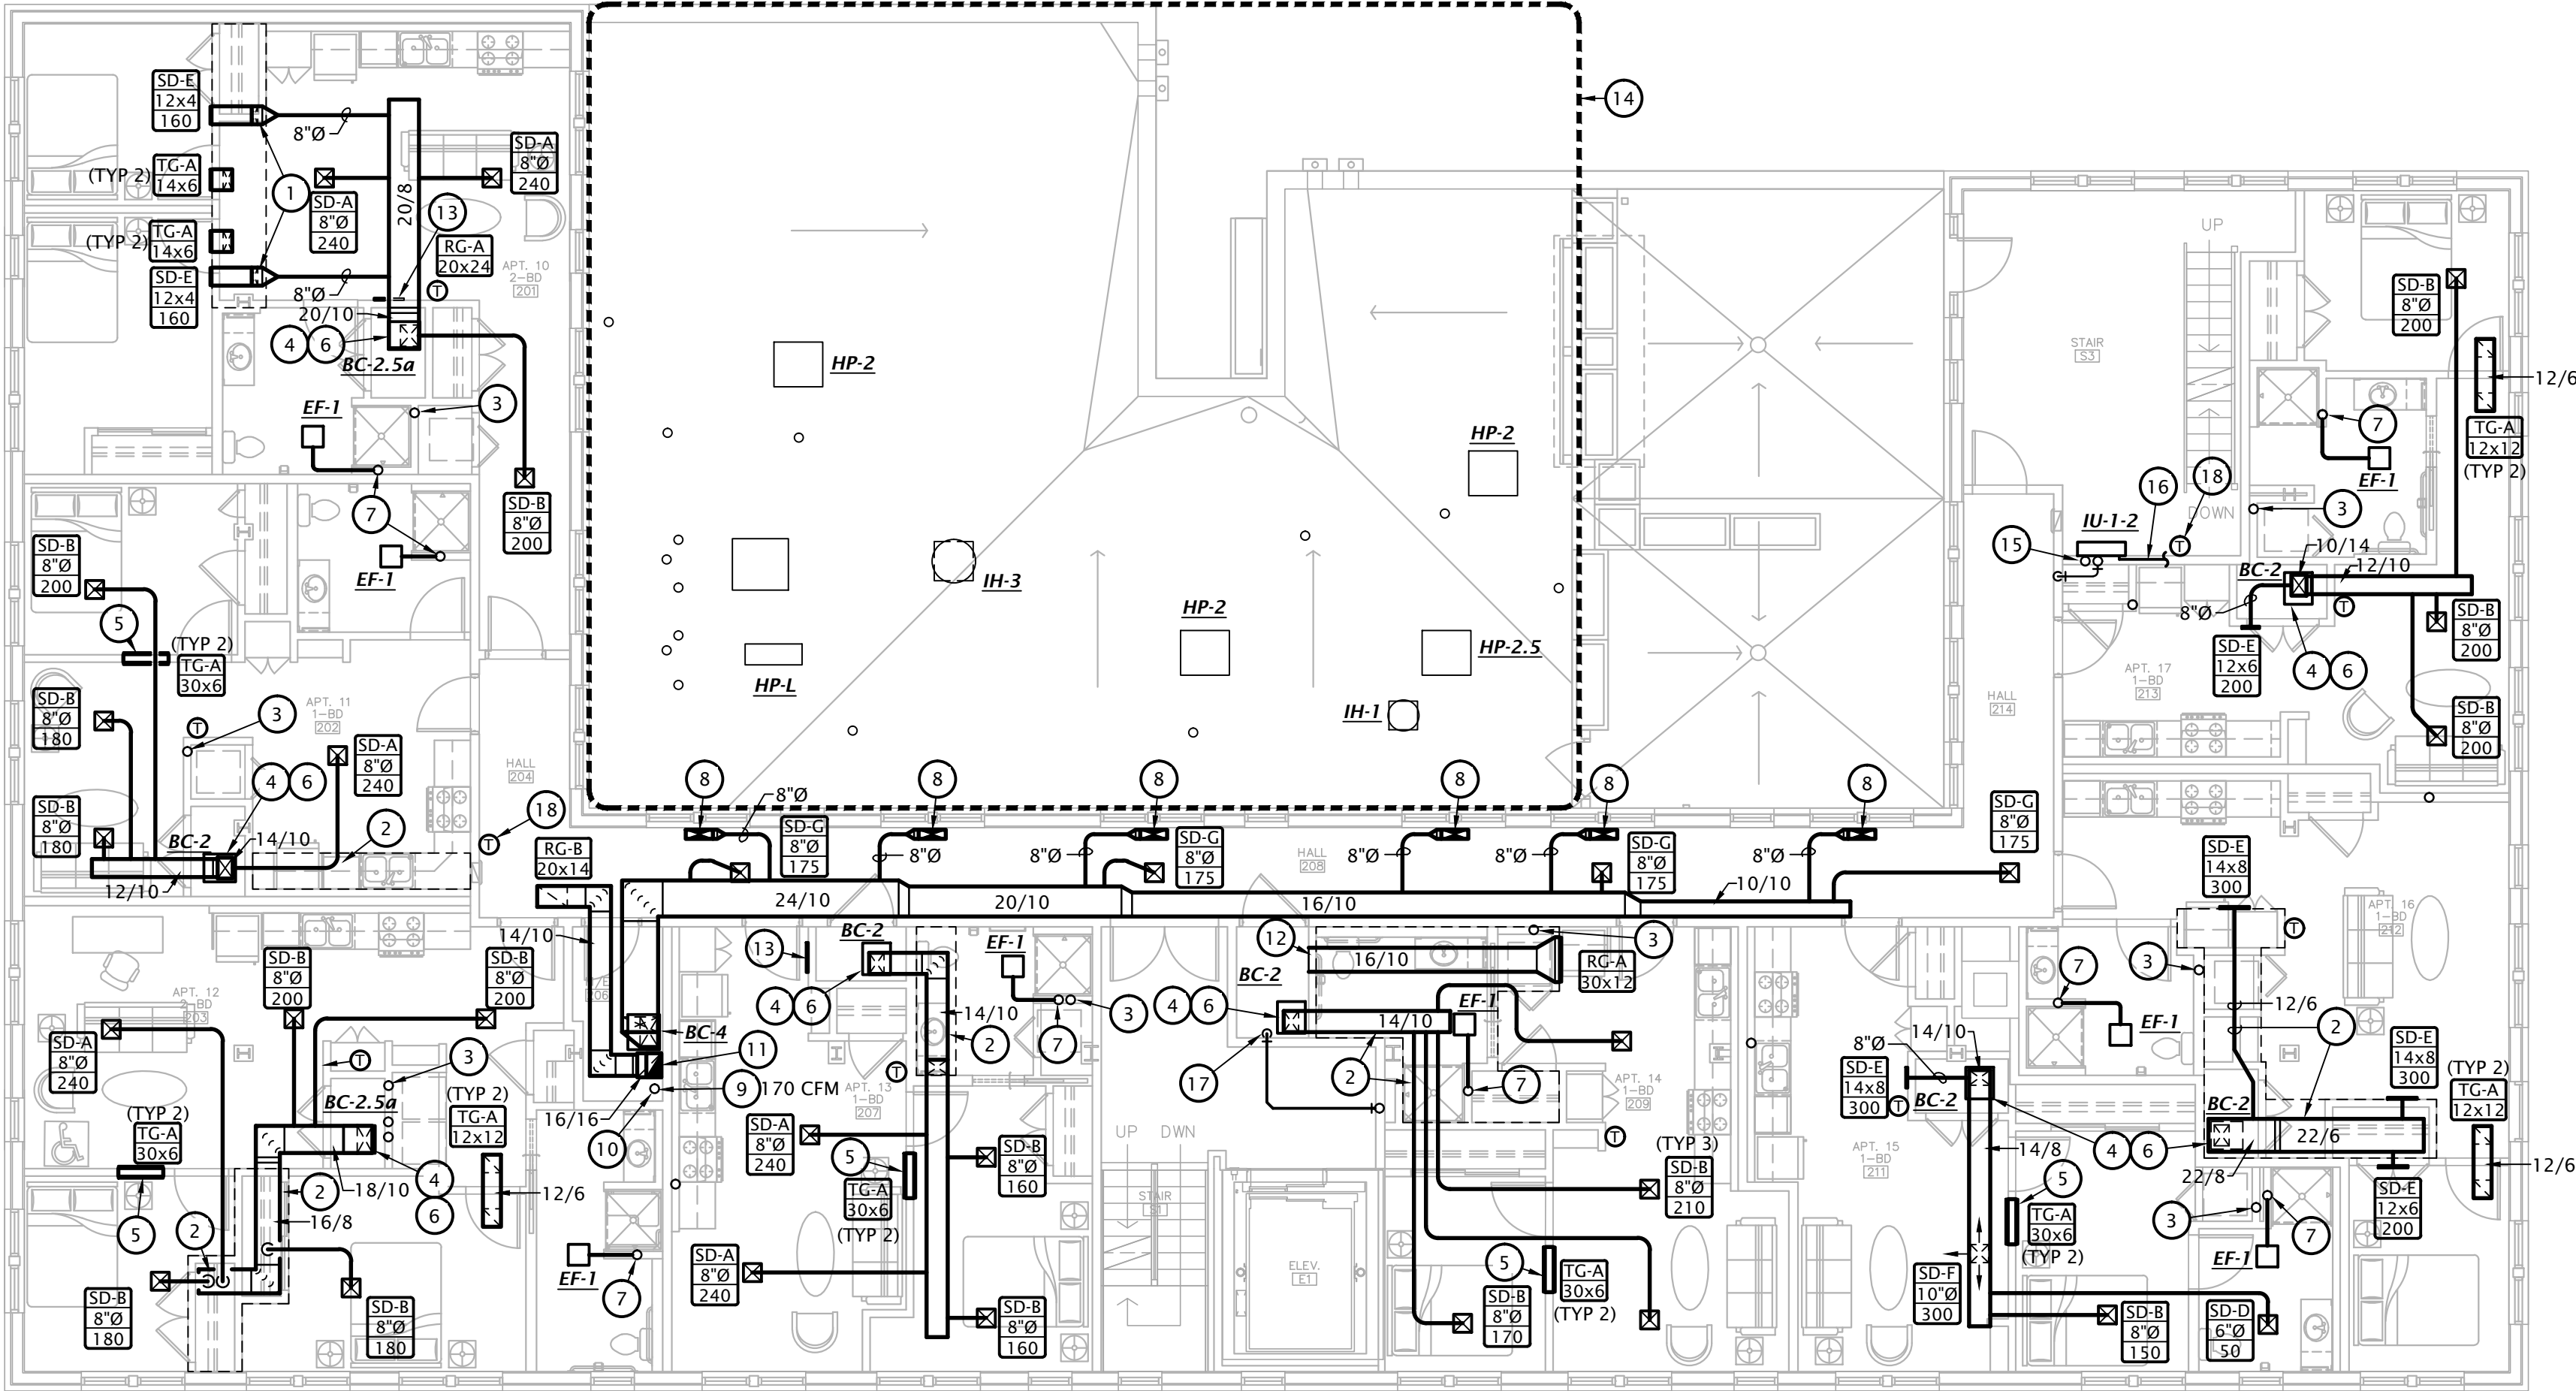


NOTE: ALL EXHAUST FANS AND AIR DEVICES THAT PENETRATE A CEILING ASSEMBLY SHALL BE PROVIDED WITH A U.L. LISTED RADIATION DAMPER, GREENHECK CRD OR EQUIVALENT.

1

SECOND FLOOR HVAC PLAN

1/8" = 1'-0"

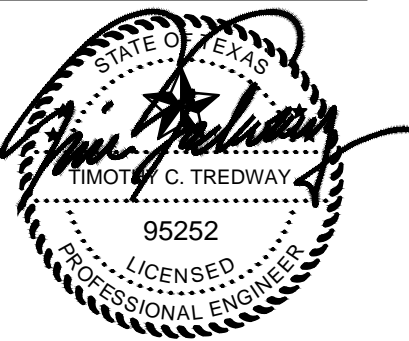


REVISION:	1-16-2024
DATE:	1-16-2024
JOB:	21-3166
SHEET NO.:	

#MECHANICAL NOTES BY SYMBOL

- DUCT TO BE ROUTED IN LOWERED CEILING/SOFFIT, INSTALL AS HIGH AS POSSIBLE TO STRUCTURE. COORDINATE EXACT ROUTING AND SOFFIT LOCATION WITH G.C. AND ARCHITECT.
- PROVIDE UL LISTED DRYER BOX EQUAL TO IN-O-VATE TECHNOLOGIES IN WALL INSTALLED IN ACCORDANCE WITH MANUFACTURER'S RECOMMENDATIONS, AND ROUTE 4"Ø DRYER EXHAUST DUCT TO ROOF JACK WITH BACKDRAFT DAMPER. MAXIMUM ALLOWABLE EQUIVALENT DUCT LENGTH = 35'. COORDINATE EXACT REQUIREMENTS WITH EQUIPMENT PROVIDED. PROVIDE PERMANENT LABEL IDENTIFYING EQUIVALENT LENGTH OF DRYER DUCT INSTALLED PER IMC 504.  
**NOTE:** ANNULAR SPACE AROUND DUCT IS TO BE SEALED AT ALL PENETRATIONS OF FLOORS AND CEILINGS WITH U.L. LISTED FIRE STOPPING SYSTEM.
- ROUTE REFRIGERANT PIPING FROM BLOWER COIL TO MATCHING HEAT PUMP CONCEALED ABOVE CEILINGS AND IN WALLS. SEE M1.4 FOR HEAT PUMP LOCATIONS.
- MOUNT TRANSFER GRILLE IN BEDROOM 6" BELOW CEILING AND MOUNT TRANSFER GRILLE ON OPPOSITE SIDE OF WALL 6" ABOVE FINISHED FLOOR. LINE STUD CAVITY WITH SHEET METAL.
- PROVIDE AUXILIARY DRAIN PAN BELOW BLOWER COIL AND PIPE OVERFLOW DRAIN TO FLOOR DRAIN.
- ROUTE 4" EXHAUST UP IN WALL TO ROOF. DUCTS SHALL BE RUN IN WALLS CONTINUOUS FROM EXHAUST FAN TO EXTERIOR OF BUILDING WITHOUT BEING COMBINED. COORDINATE EXACT ROUTING AND WALL LOCATIONS WITH G.C. AND EXISTING CONDITIONS.
- MOUNT TRANSFER GRILLE IN BEDROOM WALL AND DUCT TO GRILLE IN SOFFIT.
- MOUNT RETURN GRILLE LOW IN WALL.
- ROUTE DUCT BELOW BEAM IN SOFFIT, TRANSITION UP TO ABOVE BEDROOM CEILING.
- ROUTE OPEN ENDED TRANSFER DUCT FROM MECHANICAL CLOSET THROUGH LOWERED CEILING, TRANSITION TO WALL MOUNTED RETURN GRILLE IN APARTMENT.
- OUTDOOR AIR DUCT UP TO INTAKE HOOD ON ROOF, SEE ROOF PLAN ON M1.4 FOR MORE INFORMATION.
- ROUTE REFRIGERANT PIPING CONCEALED IN WALLS AND ABOVE CEILING FROM INDOOR UNIT TO MATCHING HEAT PUMP UNIT ON ROOF. FIELD COORDINATE EXACT ROUTING WITH EXISTING CONDITIONS AND OTHER TRADES.
- ROUTE CONDENSATE PIPING FROM INDOOR UNIT DOWN CONCEALED IN WALL AND ROUTE TO ABOVE FLOOR DRAIN IN MECHANICAL ROOM AT FLOOR BELOW.
- ROUTE CONDENSATE PIPING FROM INDOOR UNIT CONCEALED IN WALL TO FLOOR DRAIN IN MECHANICAL CLOSET. FIELD COORDINATE ROUTING WITH OTHER TRADES.
- THERMOSTAT SHALL BE CONFIGURED TO PROVIDE A TEMPERATURE RANGE OR DEADBAND OF NOT LESS THAN 5°F BETWEEN CHANGEOVER FROM HEATING TO COOLING MODES.


- NOTES:
- ALL DUCTWORK SHALL BE SEALED PER 2021 IECC REQUIREMENTS. COORDINATE REQUIREMENTS WITH G.C.
  - DUCTWORK AT SUPPLY, RETURN, AND TRANSFER AIR REGISTERS SHALL BE SEALED TO FLOOR, WALL, OR CEILING USING HVAC TAPE.

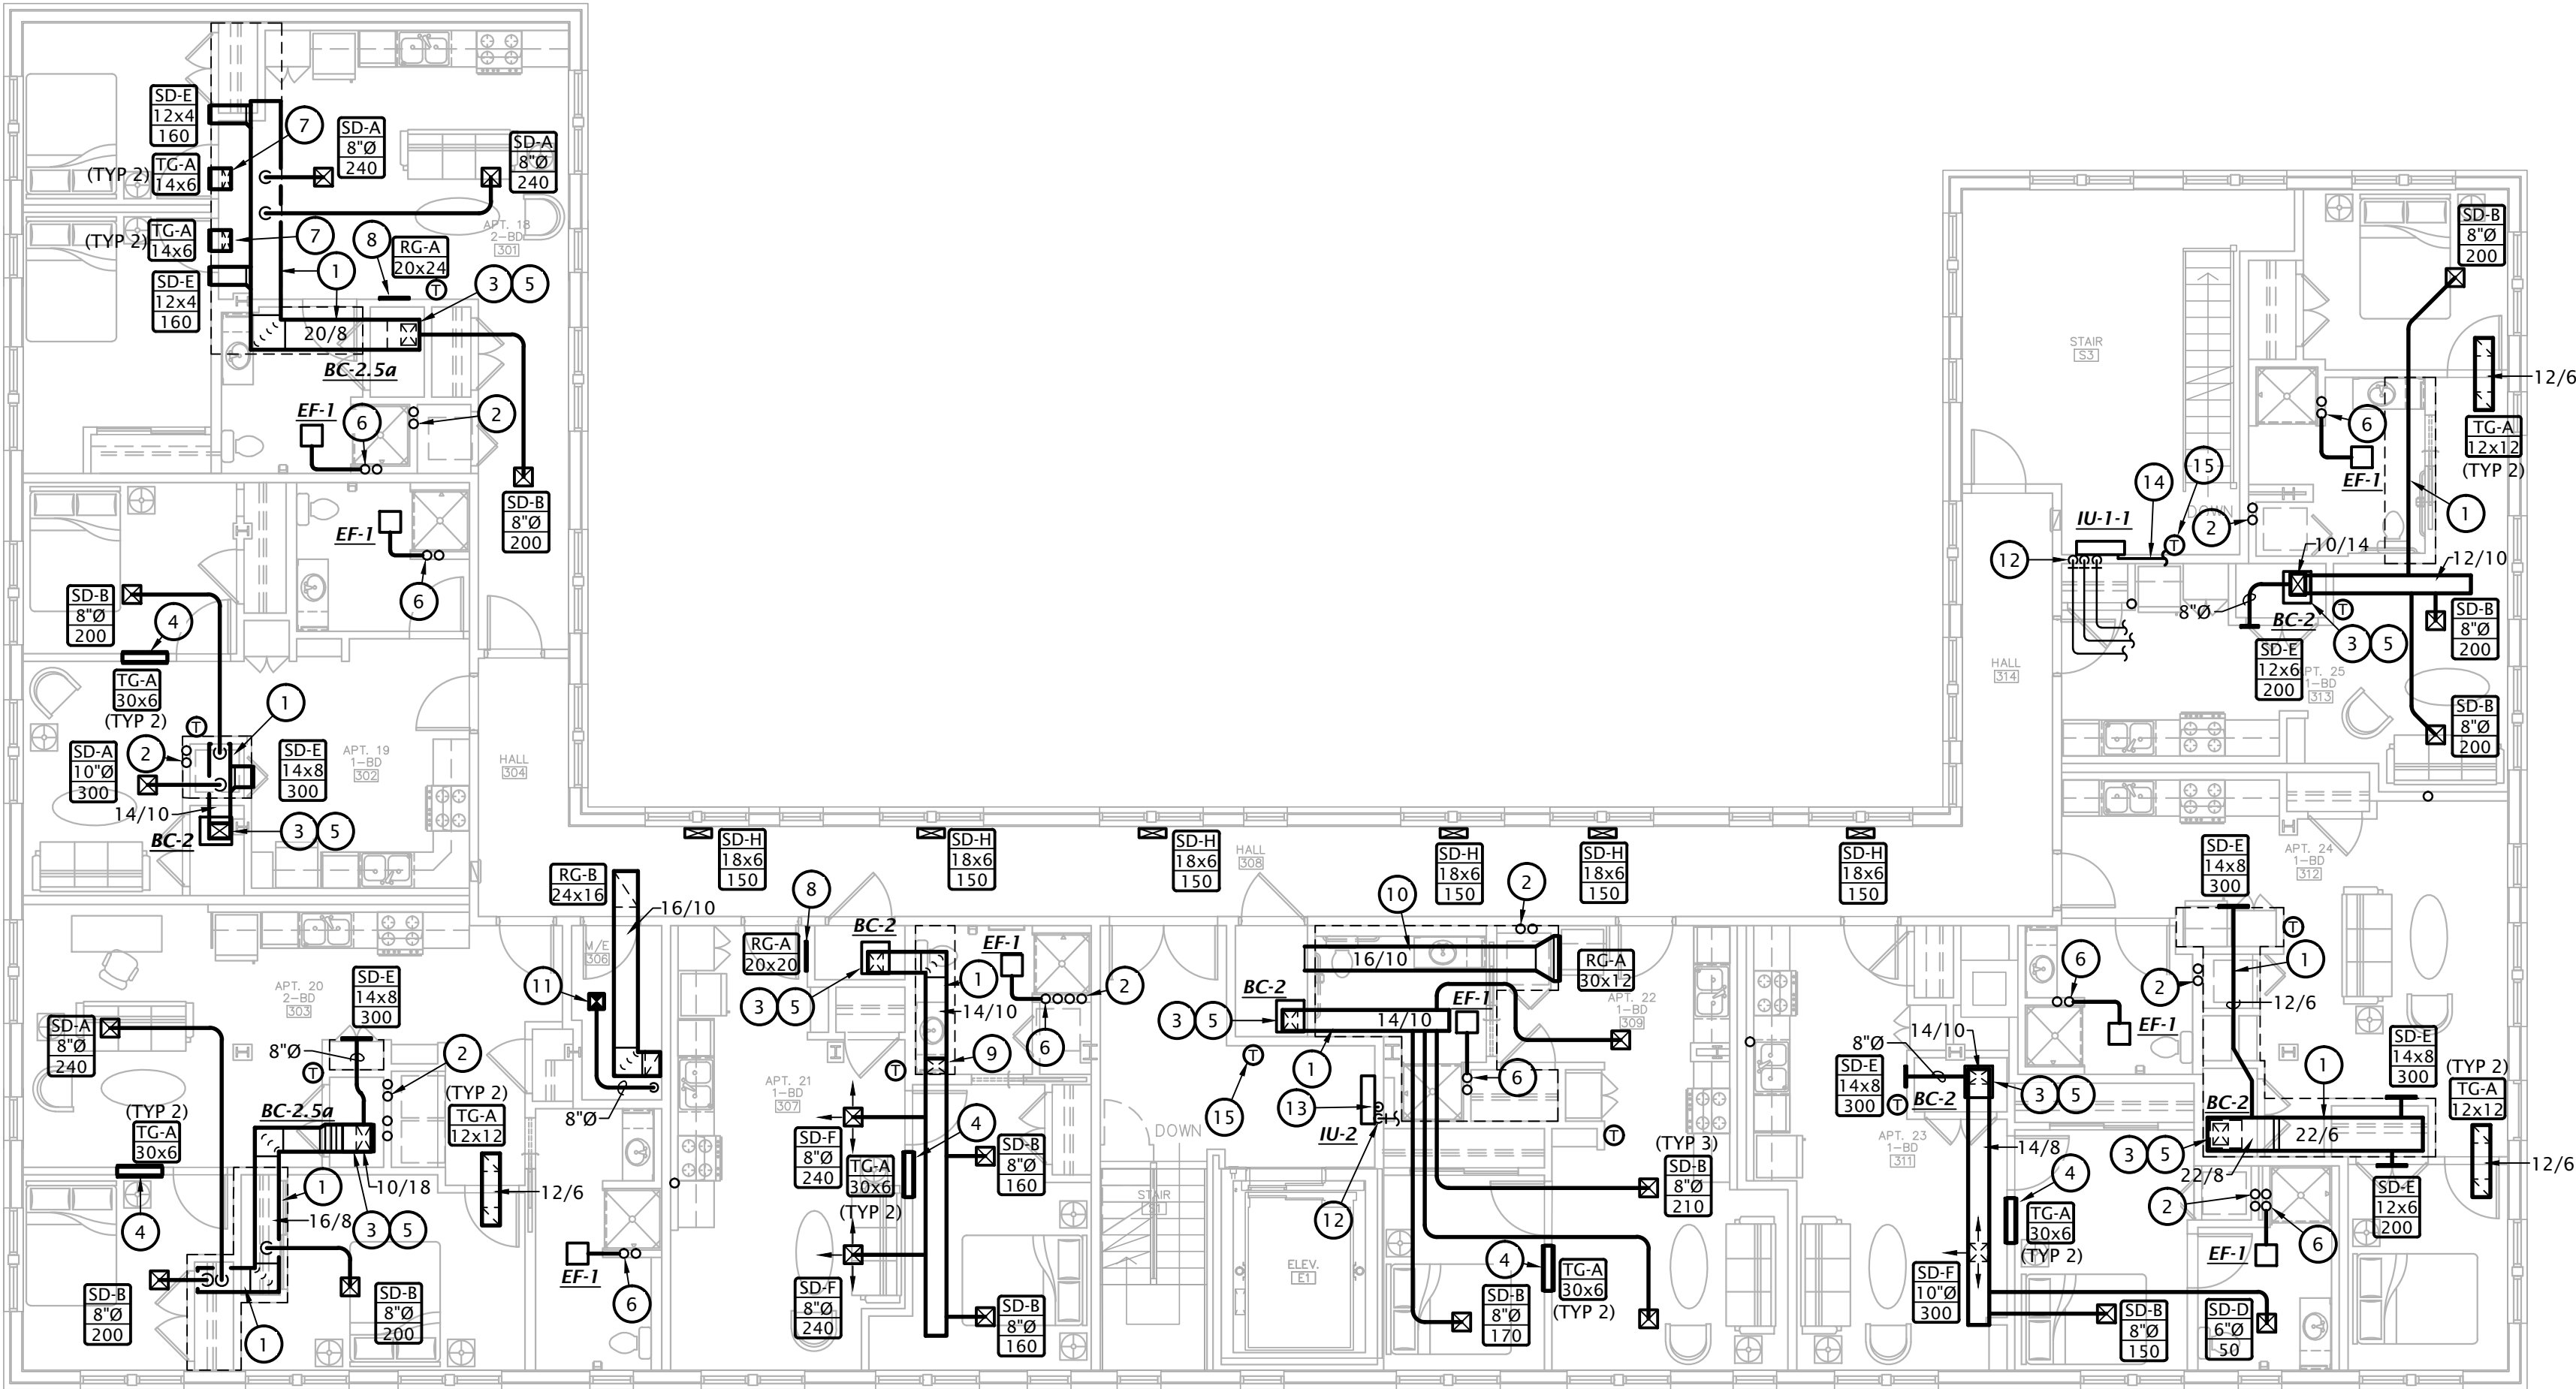

NOTE: ALL EXHAUST FANS AND AIR DEVICES THAT PENETRATE A CEILING ASSEMBLY SHALL BE PROVIDED WITH A U.L. LISTED RADIATION DAMPER, GREENHECK CRD OR EQUIVALENT.

1THIRD FLOOR HVAC PLAN

1/8" = 1'-0"

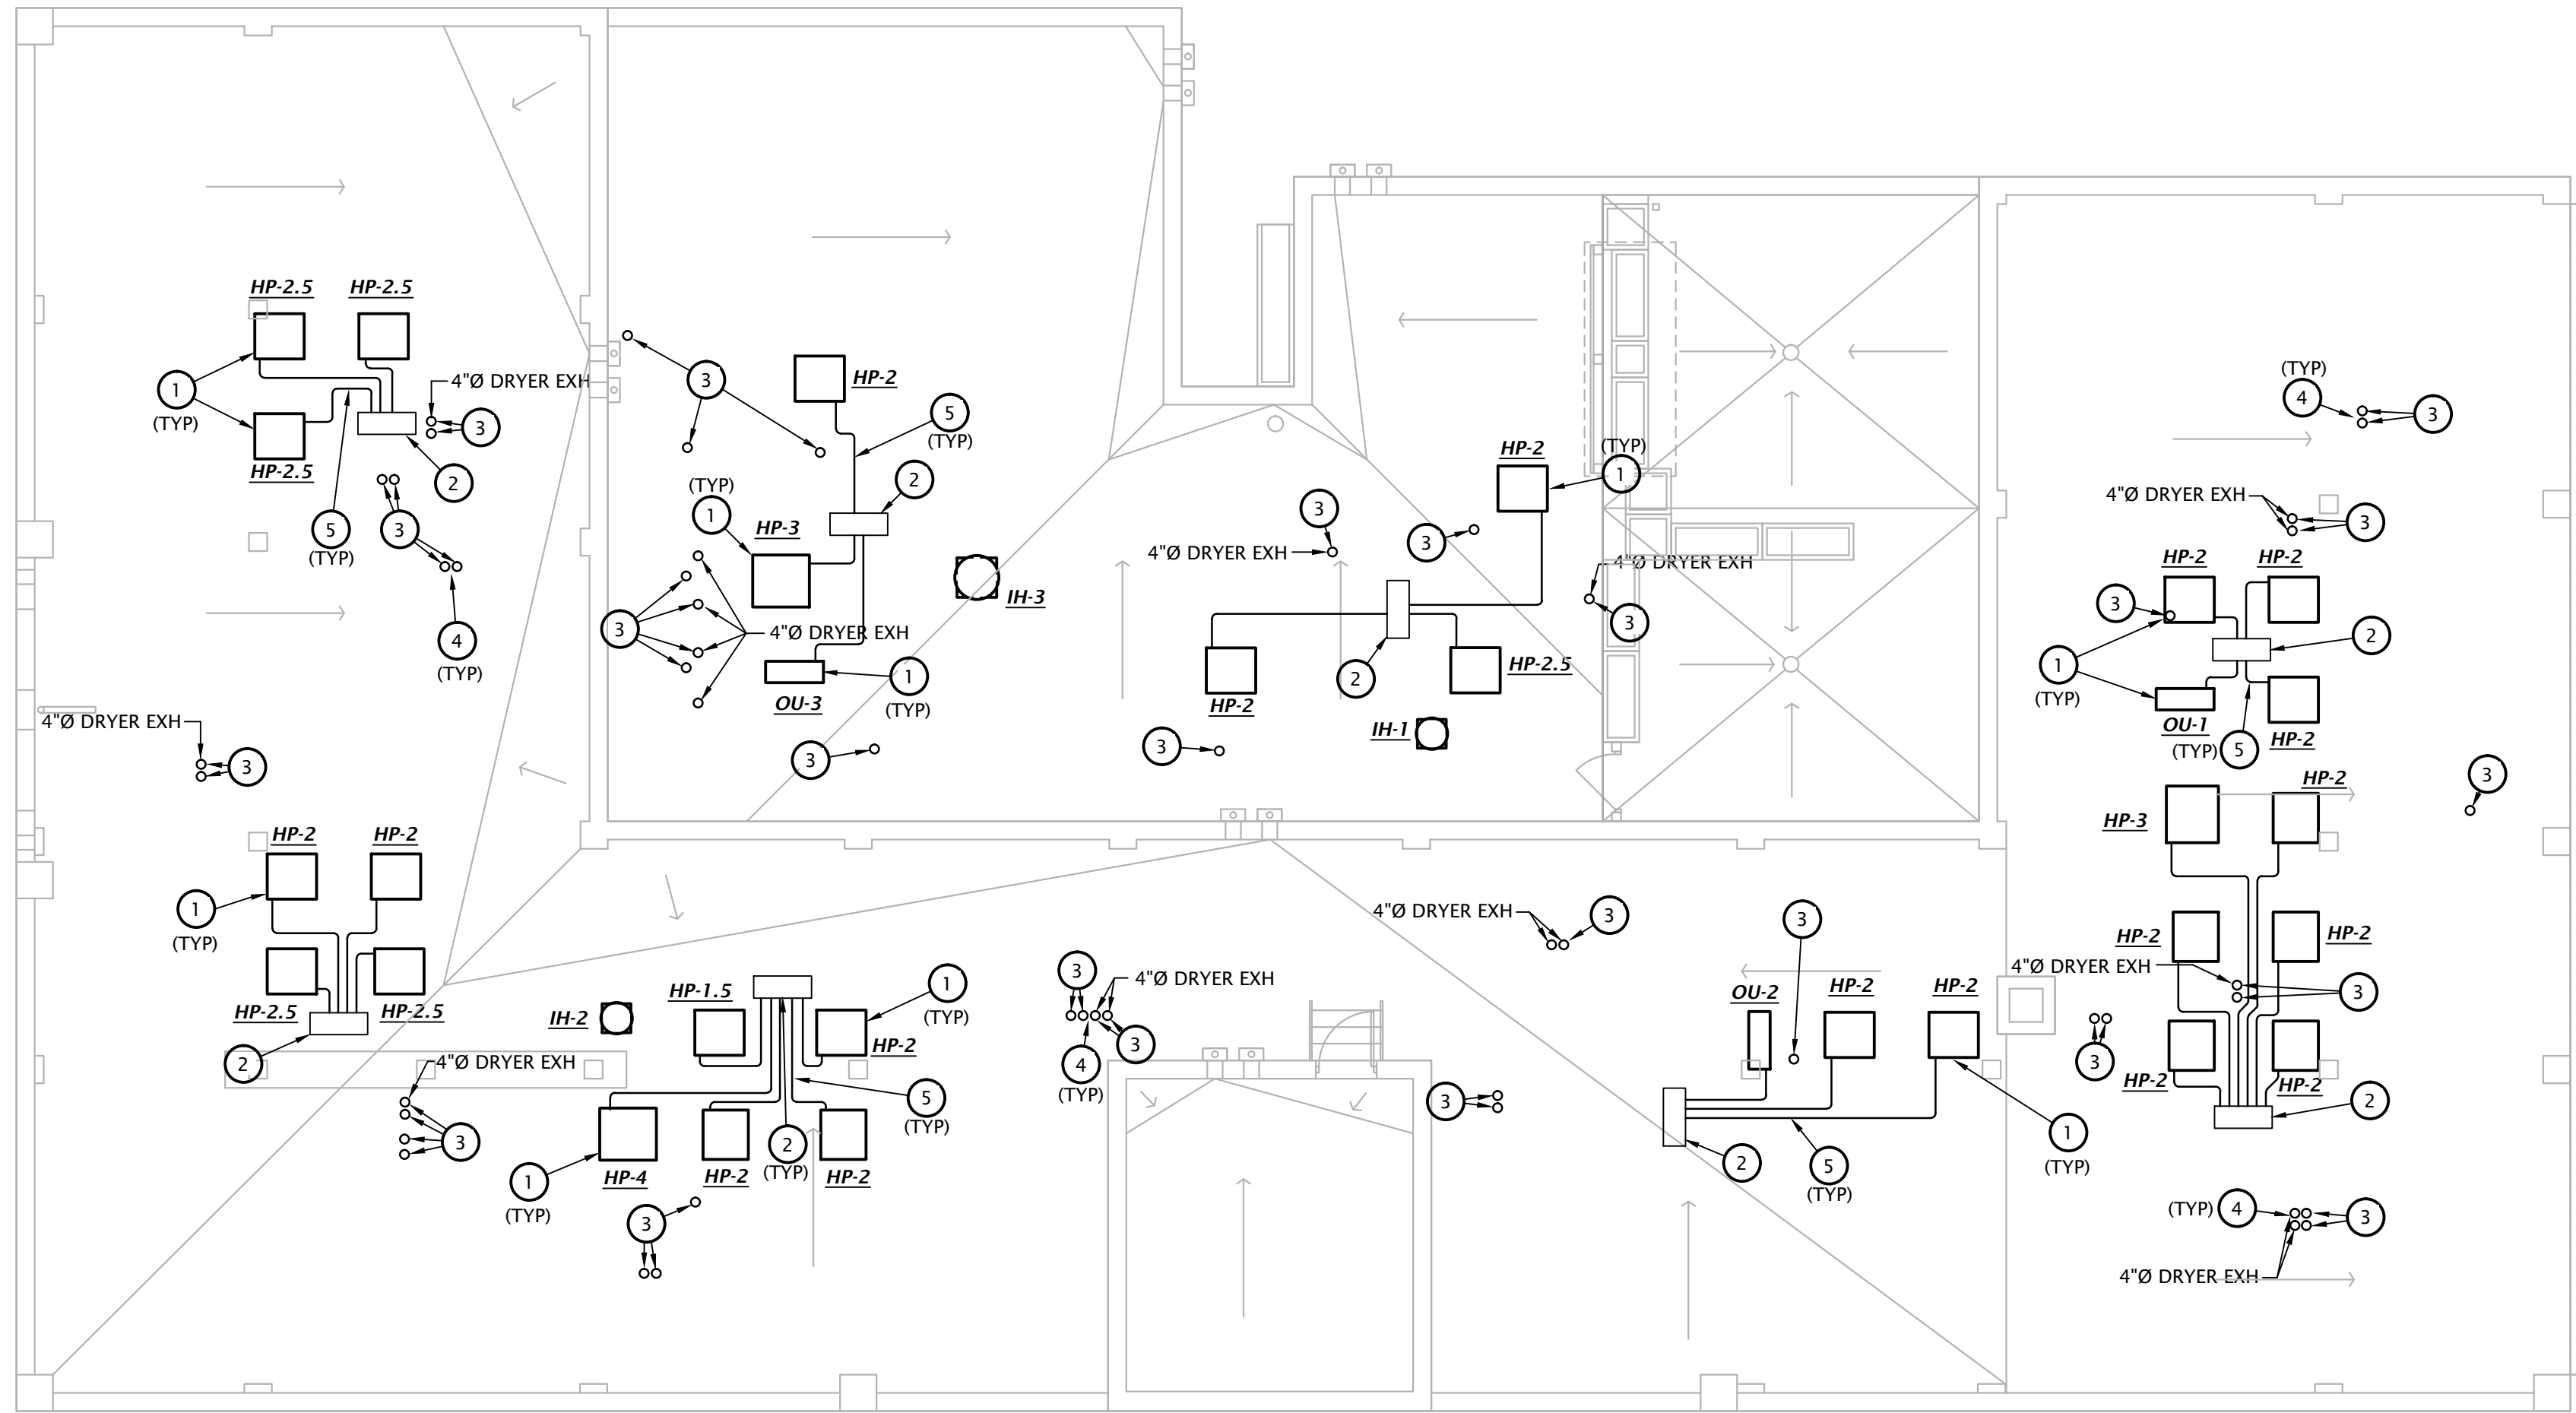


1 ROOF HVAC PLAN  
1/8" = 1'-0"

# MECHANICAL NOTES

1. MOUNT HEAT PUMP ON METAL SUPPORT FRAME. COORDINATE REQUIREMENTS STRUCTURAL ENGINEER AND G.C.
2. ROUTE REFRIGERANT PIPING FROM HEAT PUMP TO INDOOR UNIT BELOW. PROVIDE ROOF CURB WITH PIPING PENETRATION ASSEMBLY EQUAL TO ALTA PRODUCTS SIGRIS PIPE CHASE HOUSING. PROVIDE WITH EXIT SEALS FOR REFRIGERANT PIPING AND ELECTRICAL CONDUIT FOR EACH HEAT PUMP AND ONE ADDITIONAL SPARE EXIT SEAL. FIELD LOCATE PIPE CHASE LOCATIONS AND COORDINATE WITH EXISTING CONDITIONS AND OTHER TRADES. COORDINATE CURB REQUIREMENTS WITH G.C.
3. PROVIDE PIPE CURB EQUAL TO PATE AT DUCT PENETRATIONS OF ROOF. COORDINATE REQUIREMENTS WITH G.C. DO NOT USE PITCH POCKETS. TERMINATE WITH GOOSE NECK, SEE DETAIL 1:M6.3 FOR MORE INFORMATION.
4. PROVIDE PIPE CURB FOR MULTIPLE EXHAUST TERMINATIONS ON ROOF WHERE PENETRATIONS ARE GROUPED TOGETHER.
5. SEE DETAIL 2:M6.3 FOR REFRIGERANT PIPING ROUTED ALONG ROOF.

IST Consulting Engineers, PA  
MANHATTAN  
4809 Van Dyke Plaza, Suite 301  
Manhattan, KS 66503  
www.istengineers.com  
mail@istengineers.com  
WICHITA  
122 S. Washington, Suite 150  
Wichita, Kansas 67202  
316.265.0696

ROOSEVELT LOFTS  
HISTORIC REHABILITATION - APARTMENTS  
SAN ANGELO, TEXAS

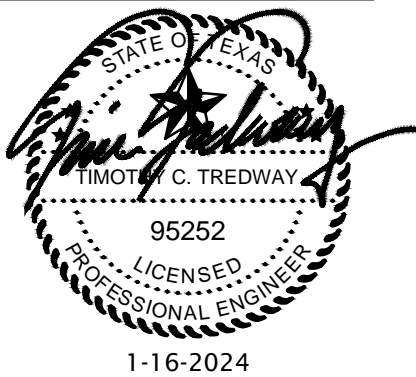

REVISION:

DATE: 1-16-2024

JOB: 21-3166

SHEET NO.:

M1.4

COPYRIGHTED ©

JGR  
JonesGillamRenz  
730 N. Ninth  
Salina, KS 67401  
1881 Main Street, Suite 301  
Kansas City, MO 64108  
785.827.0386  
jgr@jgarchitects.com



REVISION:

DATE: 1-16-2024

JOB: 21-3166

SHEET NO.:

M1.5

COPYRIGHTED ©

- NOTES:  
 • SEE ROUGH-IN REQUIREMENTS IN PLUMBING SCHEDULE ON SHEET M6.1 FOR ADDITIONAL INFORMATION.  
 • PIPING SHALL NOT BE ROUTED VERTICALLY IN FIREWALLS SEPARATING UNITS. ALL PIPING SHALL BE ROUTED VERTICALLY IN FURRED OUT WALL AS INDICATED ON PLANS.  
 • WHERE PIPING PENETRATES FIRE RATED ASSEMBLIES, INSTALL PER ARCH. DETAILS.


PLUMBING SIZING SYMBOLS

$\bigcirc$ X"	DRAIN (X = SIZE)
$\square$ X"	VENT (X = SIZE)
$\hexagon$ X"	WASTE STACK VENT (X = SIZE)


WASTE STACK VENT NOTE:  
 ALL OFFSETS ARE PROHIBITED BETWEEN LOWEST AND HIGHEST FIXTURE DRAIN CONNECTION TO WASTE STACK VENT (IPC 913.2)

# WASTE AND VENT NOTES BY SYMBOL

1. PROVIDE LINT INTERCEPTOR EQUAL TO SMITH MFG. CO. 8910-50, RATED FOR 50 GPM FLOW RATE, PRIMARY AND SECONDARY LINT SCREENS, SECURED AND GASKETED STEEL COVER, 3" INLET AND OUTLET. PROVIDE WITH EXTENSIONS AS REQUIRED.
2. PROVIDE DRAIN BOX IN LAUNDRY CLOSET FOR INDIRECT CONNECTION OF CONDENSATE DRAIN FROM INDOOR UNIT LOCATED IN HALLWAY. COORDINATE EXACT LOCATION AND REQUIREMENTS WITH M.C.
3. PROVIDE DRAIN BOX IN WALL OF LAUNDRY ROOM FOR INDIRECT CONNECTION OF CONDENSATE DRAIN FROM INDOOR UNIT LOCATED IN HALLWAY. COORDINATE EXACT LOCATION AND REQUIREMENTS WITH M.C.
4. ELEVATOR SUMP PUMP. SEE DETAIL 3-M6.3.
5. ELEVATOR SUMP PUMP CONTROL PANEL. COORDINATE WITH E.C.
6. EXTEND ELEVATOR SUMP PUMP DISCHARGE TO DAYLIGHT. COORDINATE WITH CIVIL ENGINEER.

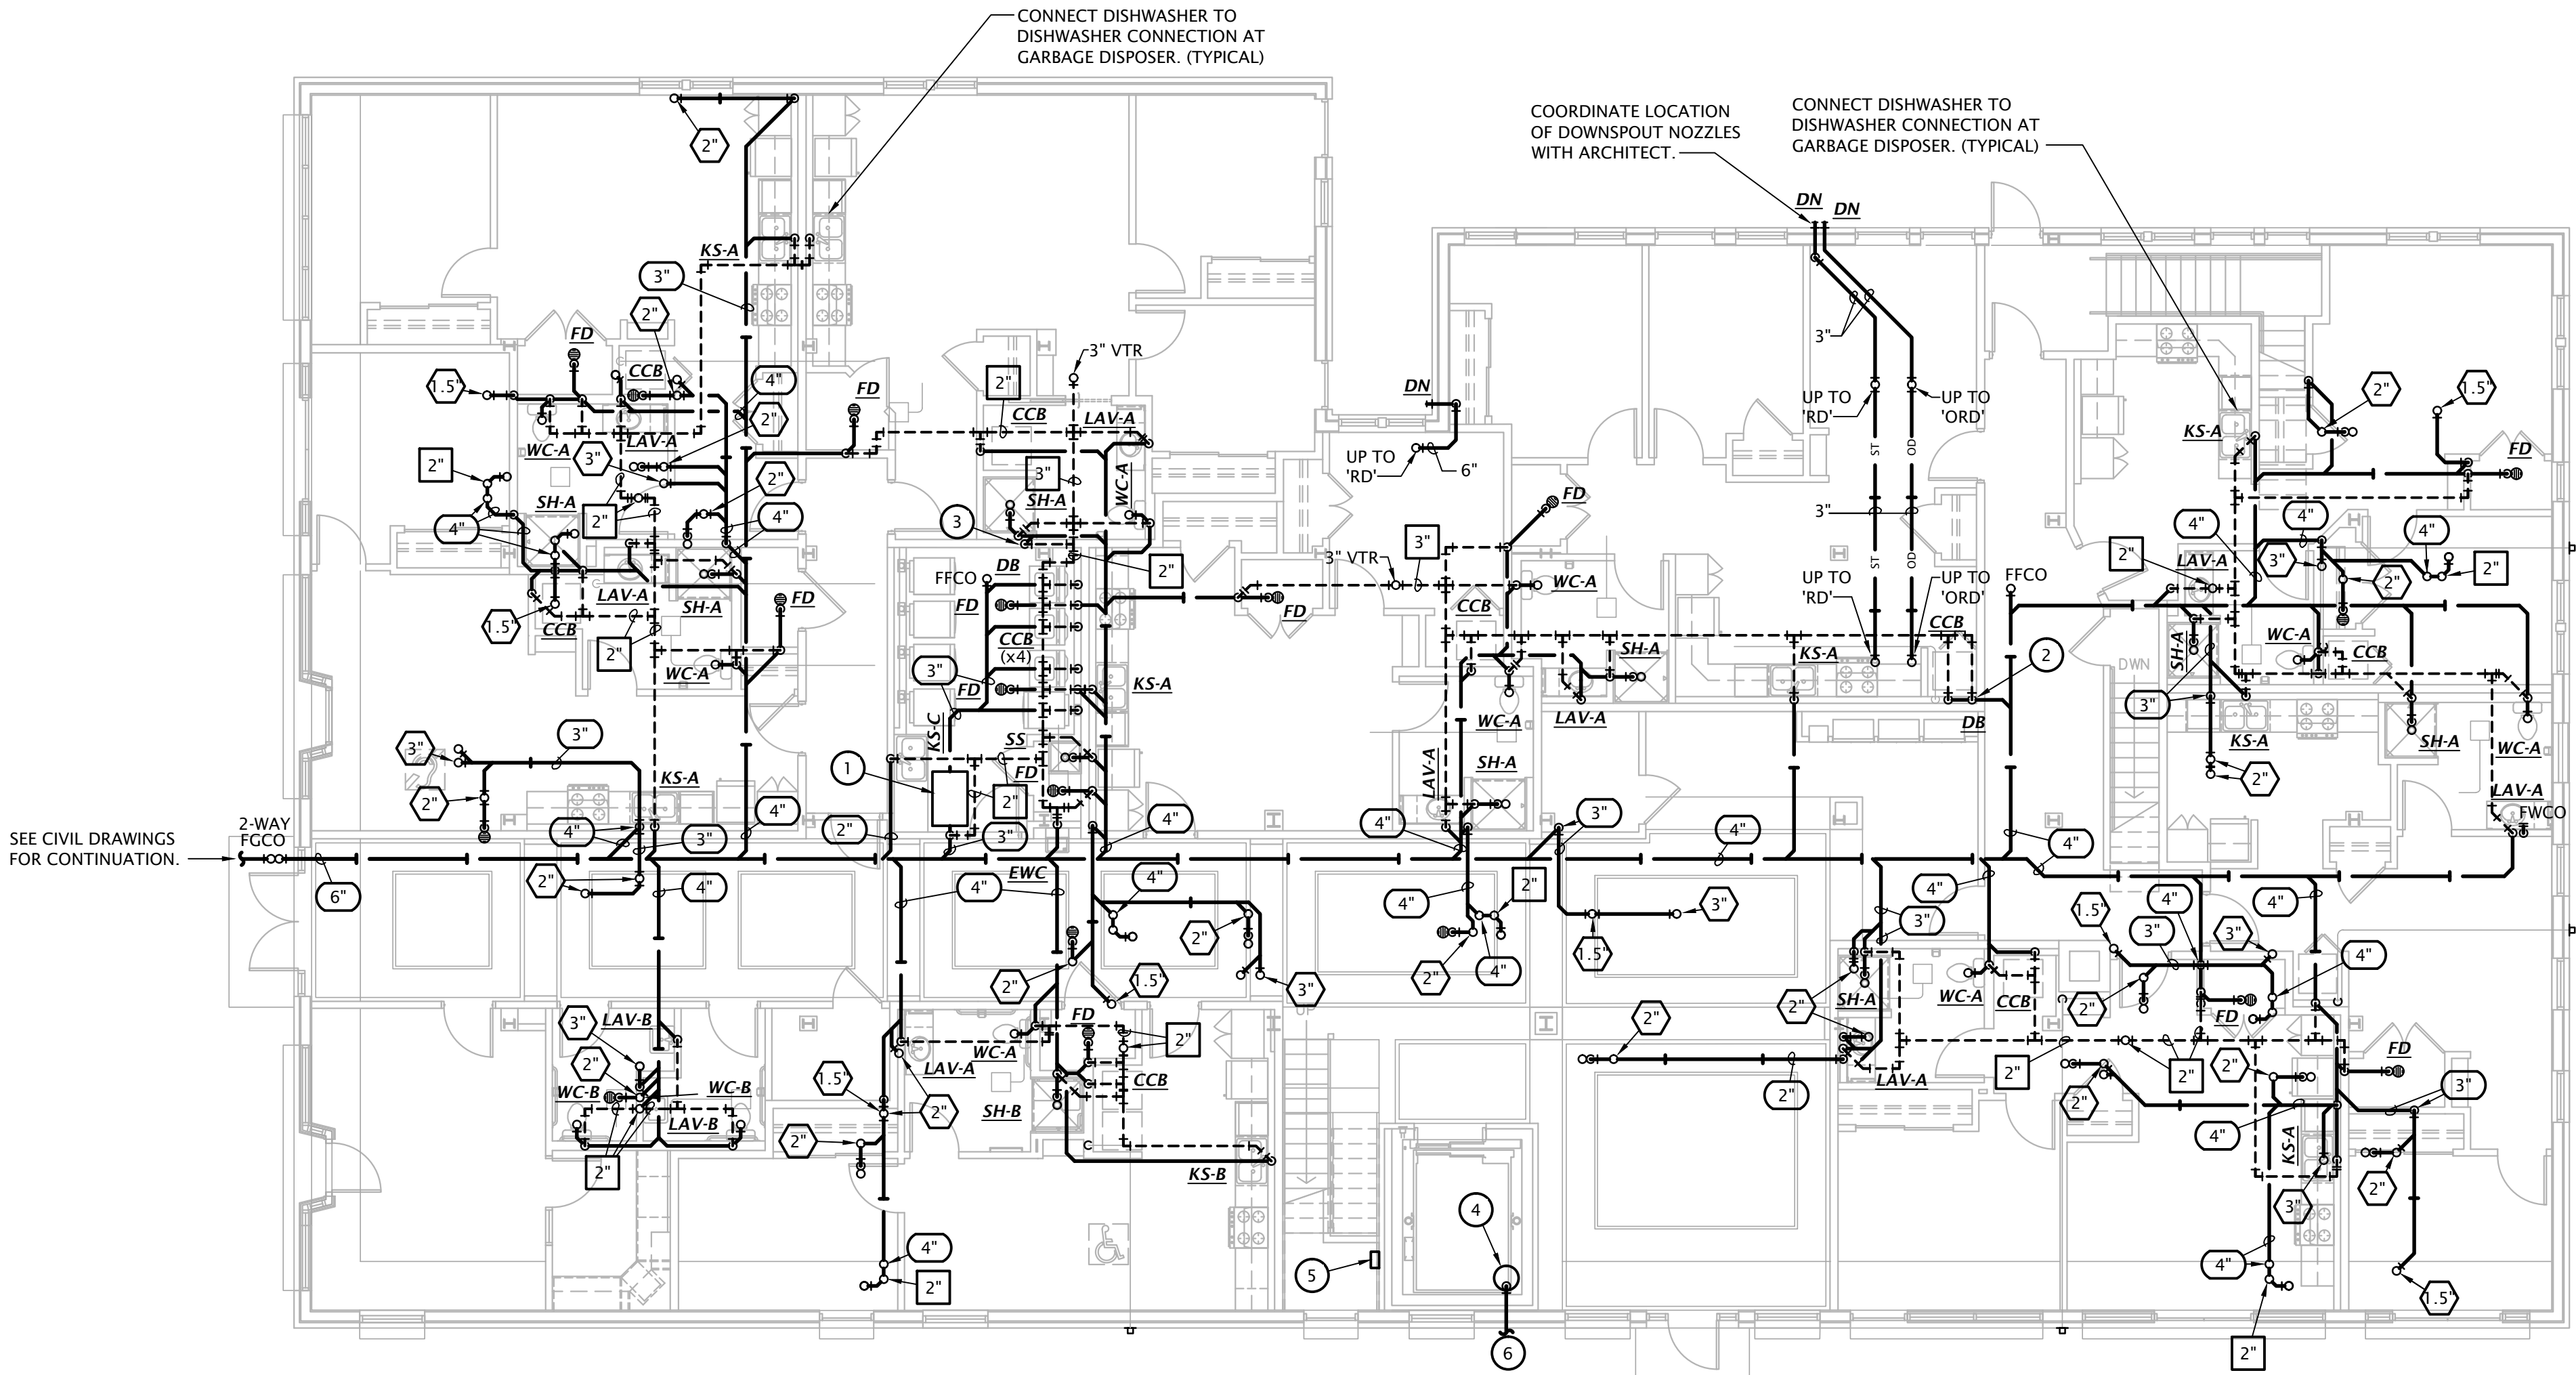

1 FIRST FLOOR WASTE AND VENT PLAN  
 1/8" = 1'-0"

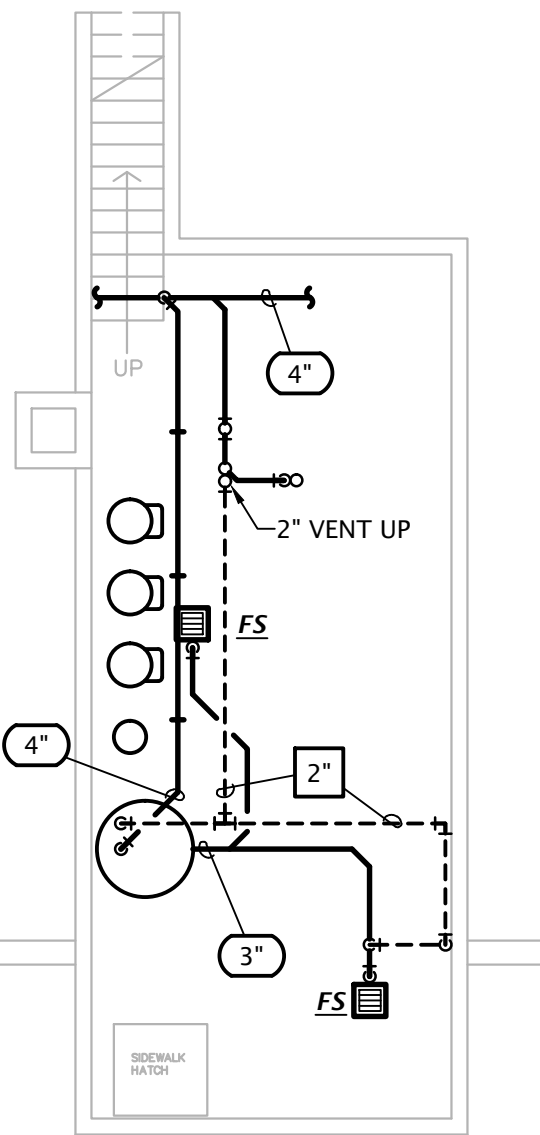

1 BASEMENT WASTE AND VENT PLAN  
 1/8" = 1'-0"




REVISION:	
DATE:	1-16-2024
JOB:	21-3166
SHEET NO.:	

- NOTES:
- SEE ROUGH-IN REQUIREMENTS IN PLUMBING SCHEDULE ON SHEET M6.1 FOR ADDITIONAL INFORMATION.
  - PIPING SHALL NOT BE ROUTED VERTICALLY IN FIREWALLS SEPARATING UNITS. ALL PIPING SHALL BE ROUTED VERTICALLY IN FURRED OUT WALL AS INDICATED ON PLANS.
  - WHERE PIPING PENETRATES FIRE RATED ASSEMBLIES, INSTALL PER ARCH. DETAILS.

PLUMBING SIZING SYMBOLS




○ X"	DRAIN (X = SIZE)
□ X"	VENT (X = SIZE)
⬡ X"	WASTE STACK VENT (X = SIZE)

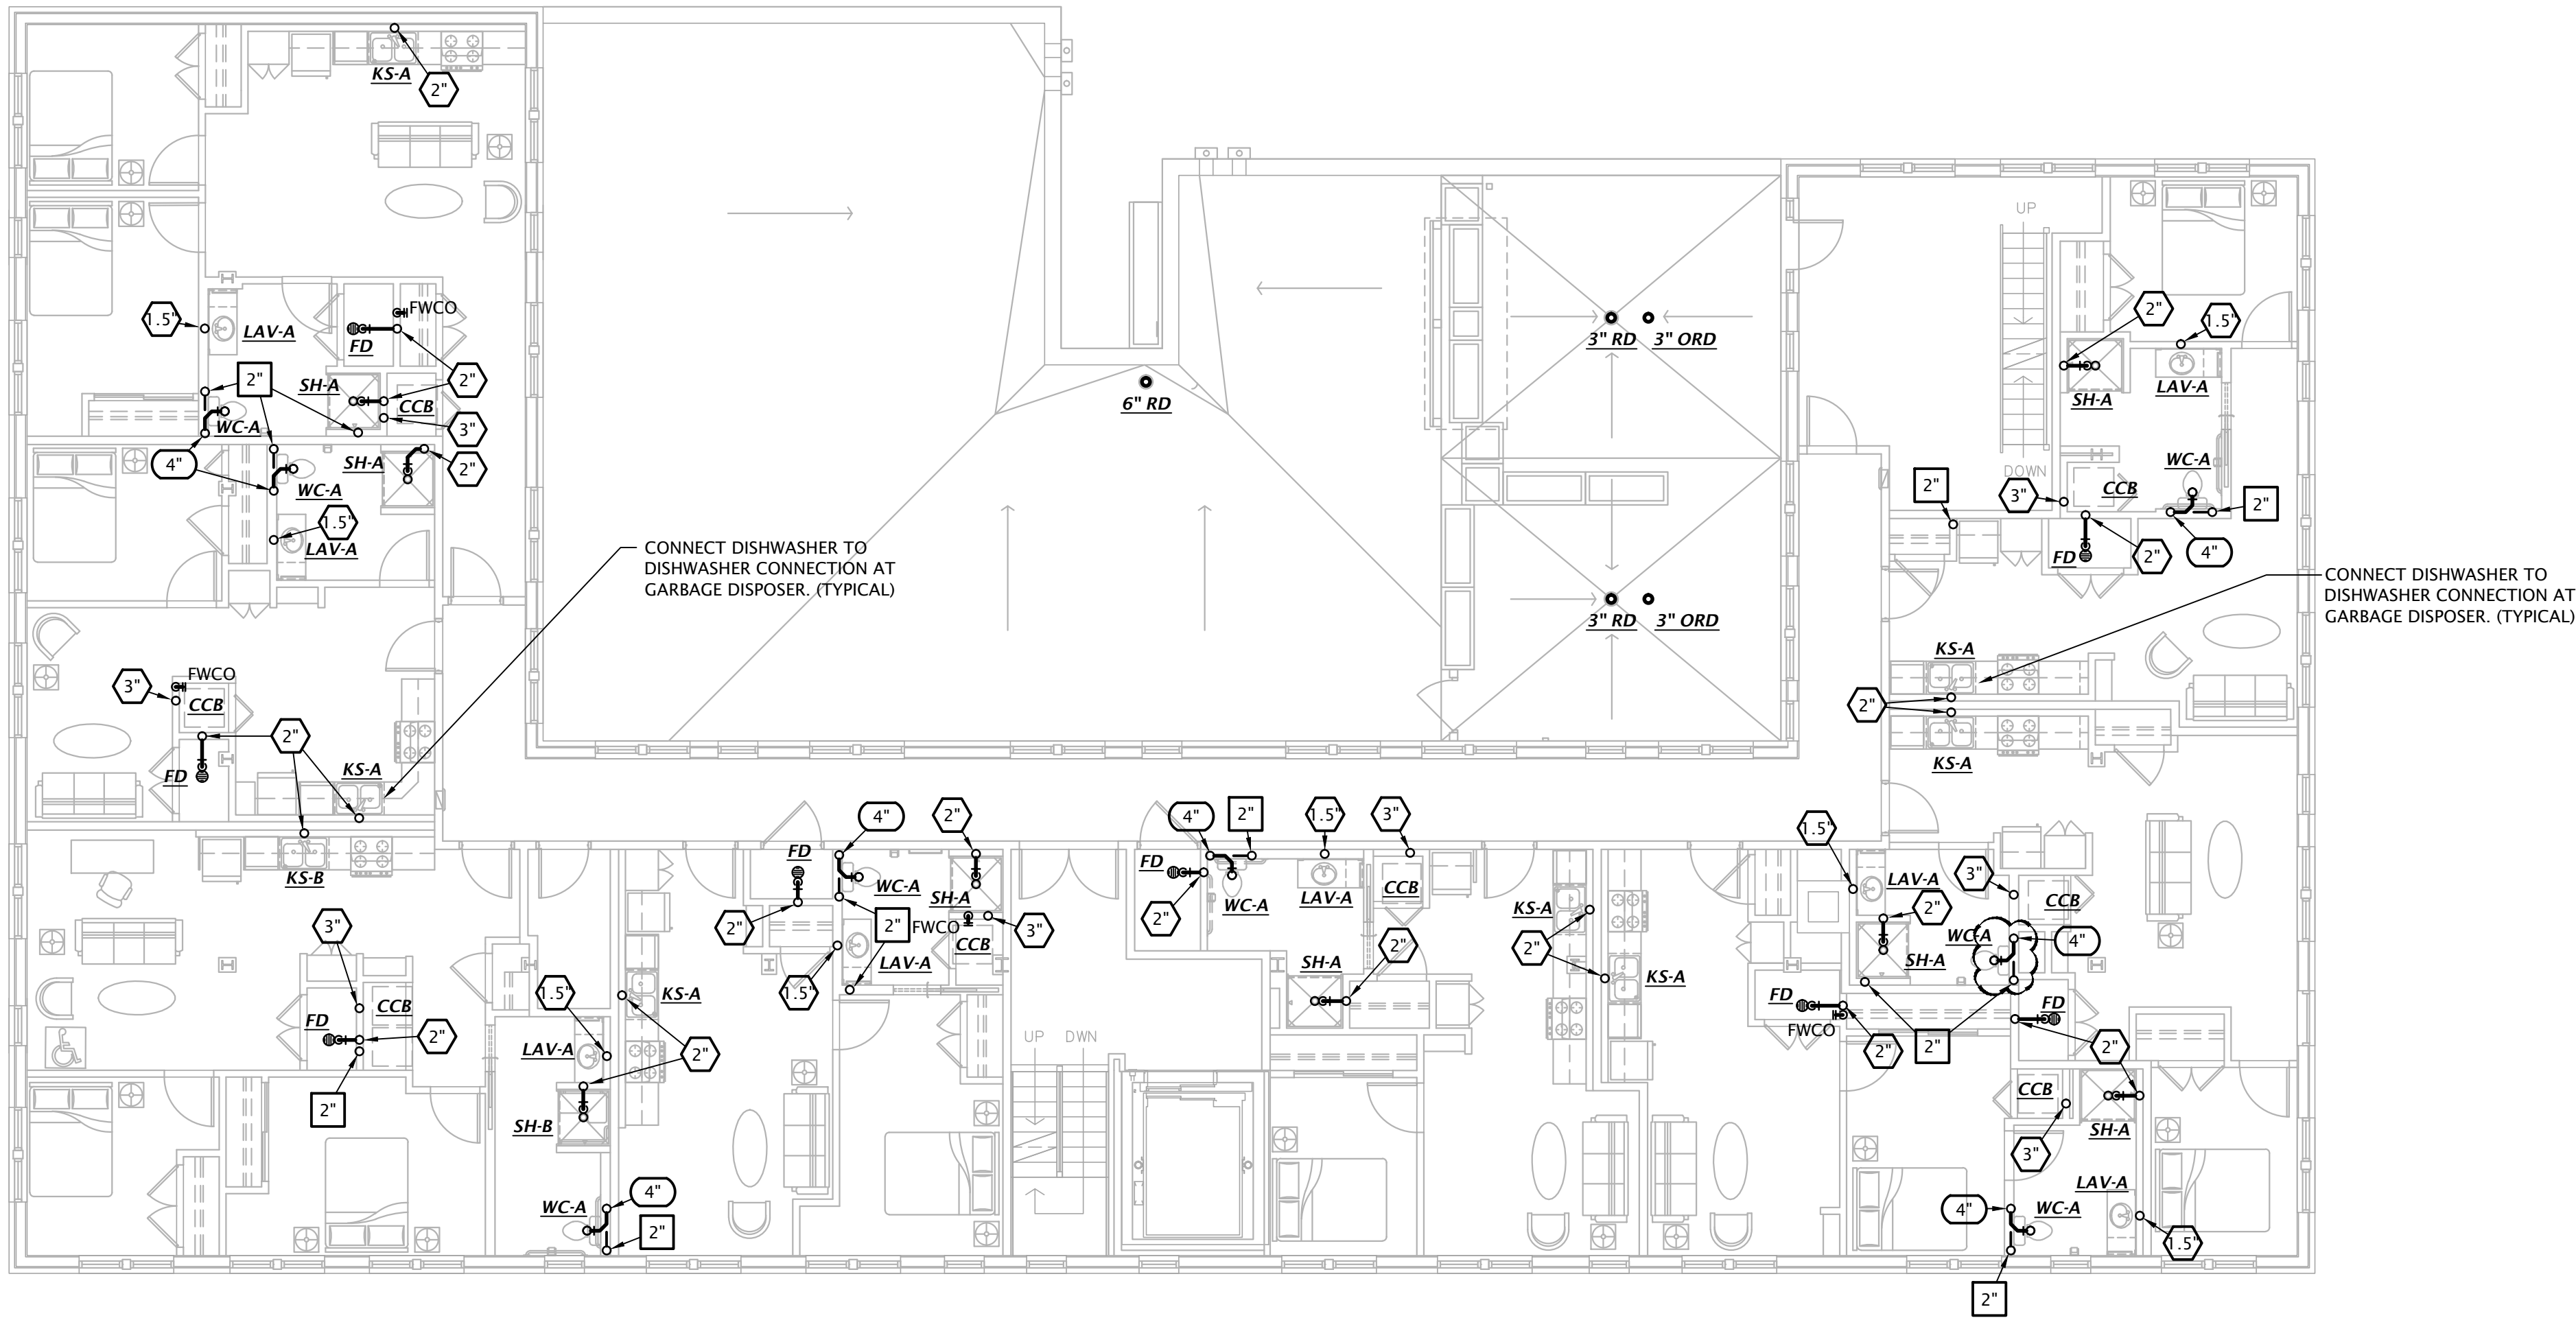
WASTE STACK VENT NOTE:  
ALL OFFSETS ARE PROHIBITED BETWEEN LOWEST AND HIGHEST  
FIXTURE DRAIN CONNECTION TO WASTE STACK VENT (IPC 913.2)



1 SECOND FLOOR WASTE AND VENT PLAN  
1/8" = 1'-0"

- NOTES:
- SEE ROUGH-IN REQUIREMENTS IN PLUMBING SCHEDULE ON SHEET M6.1 FOR ADDITIONAL INFORMATION.
  - PIPING SHALL NOT BE ROUTED VERTICALLY IN FIREWALLS SEPARATING UNITS. ALL PIPING SHALL BE ROUTED VERTICALLY IN FURRED OUT WALL AS INDICATED ON PLANS.
  - WHERE PIPING PENETRATES FIRE RATED ASSEMBLIES, INSTALL PER ARCH. DETAILS.

PLUMBING SIZING SYMBOLS	
	DRAIN (X = SIZE)
	VENT (X = SIZE)
	WASTE STACK VENT (X = SIZE)
WASTE STACK VENT NOTE: ALL OFFSETS ARE PROHIBITED BETWEEN LOWEST AND HIGHEST FIXTURE DRAIN CONNECTION TO WASTE STACK VENT (IPC 913.2)	

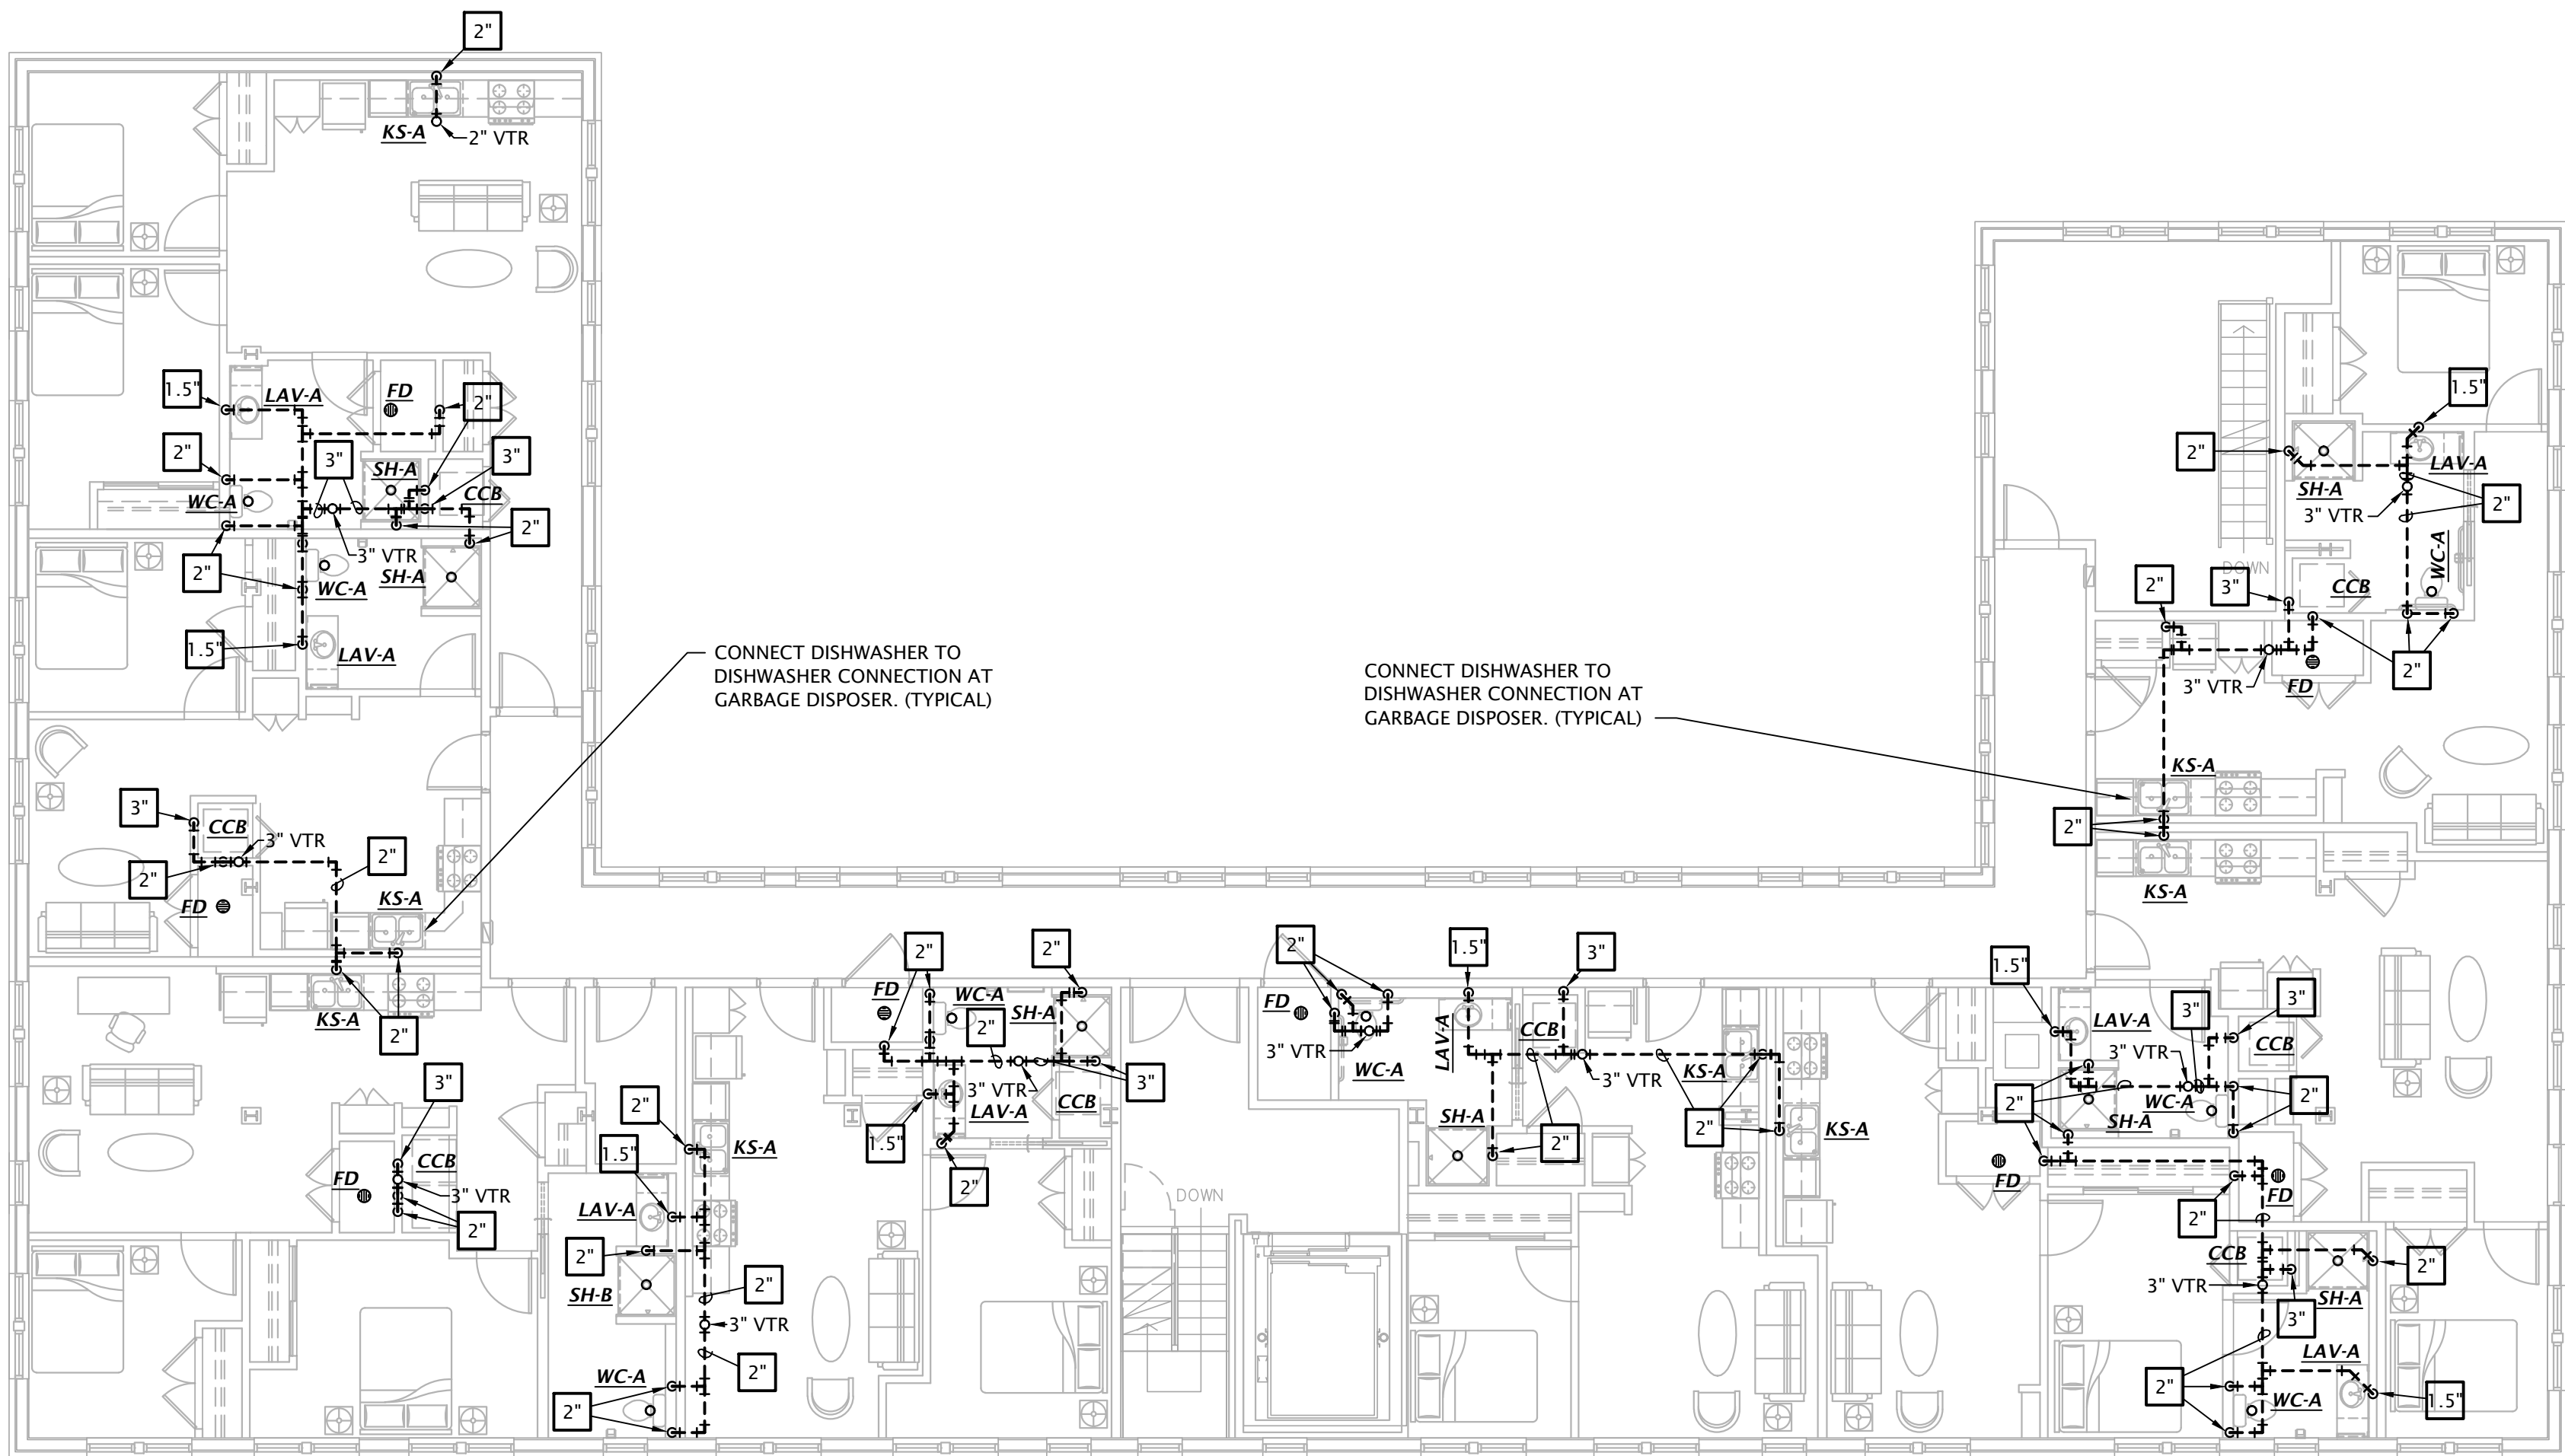

**1 THIRD FLOOR WASTE AND VENT PLAN**  
1/8" = 1'-0"



REVISION:

DATE: 1-16-2024

JOB: 21-3166

SHEET NO.:


COPPER PIPE SIZE INDICATED	ALTERNATE MATERIAL/SIZE	
	Cross-linked polyethylene (PEX)	Polypropylene (PP)
	1/2"	3/4"
	3/4"	1"
	1"	1-1/4"
	1-1/4"	1-1/2"
	1-1/2"	2"
	2"	2-1/2"
2-1/2"	3"	3"
	3"	3-1/2"

Note: Pipe sizes indicated on drawings are for Type L copper pipe. If alternate materials are used, sizes shall be as indicated above. Where no pipe size is shown, use of indicated material in design pipe size is prohibited. Do not use materials other than those listed.


- NOTES:
- PIPING SHALL NOT BE INSTALLED ABOVE ELECTRICAL PANELS.
  - COORDINATE INSTALLATION OF PIPING IN MECHANICAL CLOSET W/ M.C. & E.C.
  - SEE PLUMBING FIXTURE SCHEDULE ON SHEET P6.1 FOR FIXTURE ROUGH-IN INFORMATION.
  - INSULATE ALL HW PIPING PER SPECIFICATIONS.

DOMESTIC WATER PLAN NOTES BY SYMBOL

- FIRE PROTECTION SERVICE ENTRANCE. INSTALL IN ACCORDANCE WITH NFPA 13. COORDINATE LOCATION OF ALL VALVES AND APPURTENANCES WITH AHJ.
- PROVIDE SHUT-OFF VALVE AT WATER SERVICE ENTRANCE WITH PRESSURE REDUCING VALVE SET TO 80 PSI IF REQUIRED. COORDINATE REQUIREMENTS WITH CITY OF SAN ANGELO.
- PROVIDE 1" WATER SERVICE TO APARTMENT WITH SHUT-OFF VALVE. SEE TYPICAL APARTMENT RISER DIAGRAM ON SHEET M6.2 FOR ADDITIONAL INFO.
- PROVIDE 1/2" VALVED BRANCH BELOW SINK AND CONNECT DISHWASHER. ROUTE PIPING ALONG BACK OF CABINTRY, COORDINATE EXACT ROUTING WITH G.C. COORDINATE EXACT REQUIREMENTS WITH DISHWASHER PROVIDED.
- ROUTE 2" CW, 1-1/4" HW, AND 3/4" HW RECIRC. DOWN TO BASEMENT.
- HOT WATER RECIRC LOOP SHALL DROP IN WALL TO LIMIT HOT WATER BRANCH TO PUBLIC LAVATORY TO 2 FT MAX.

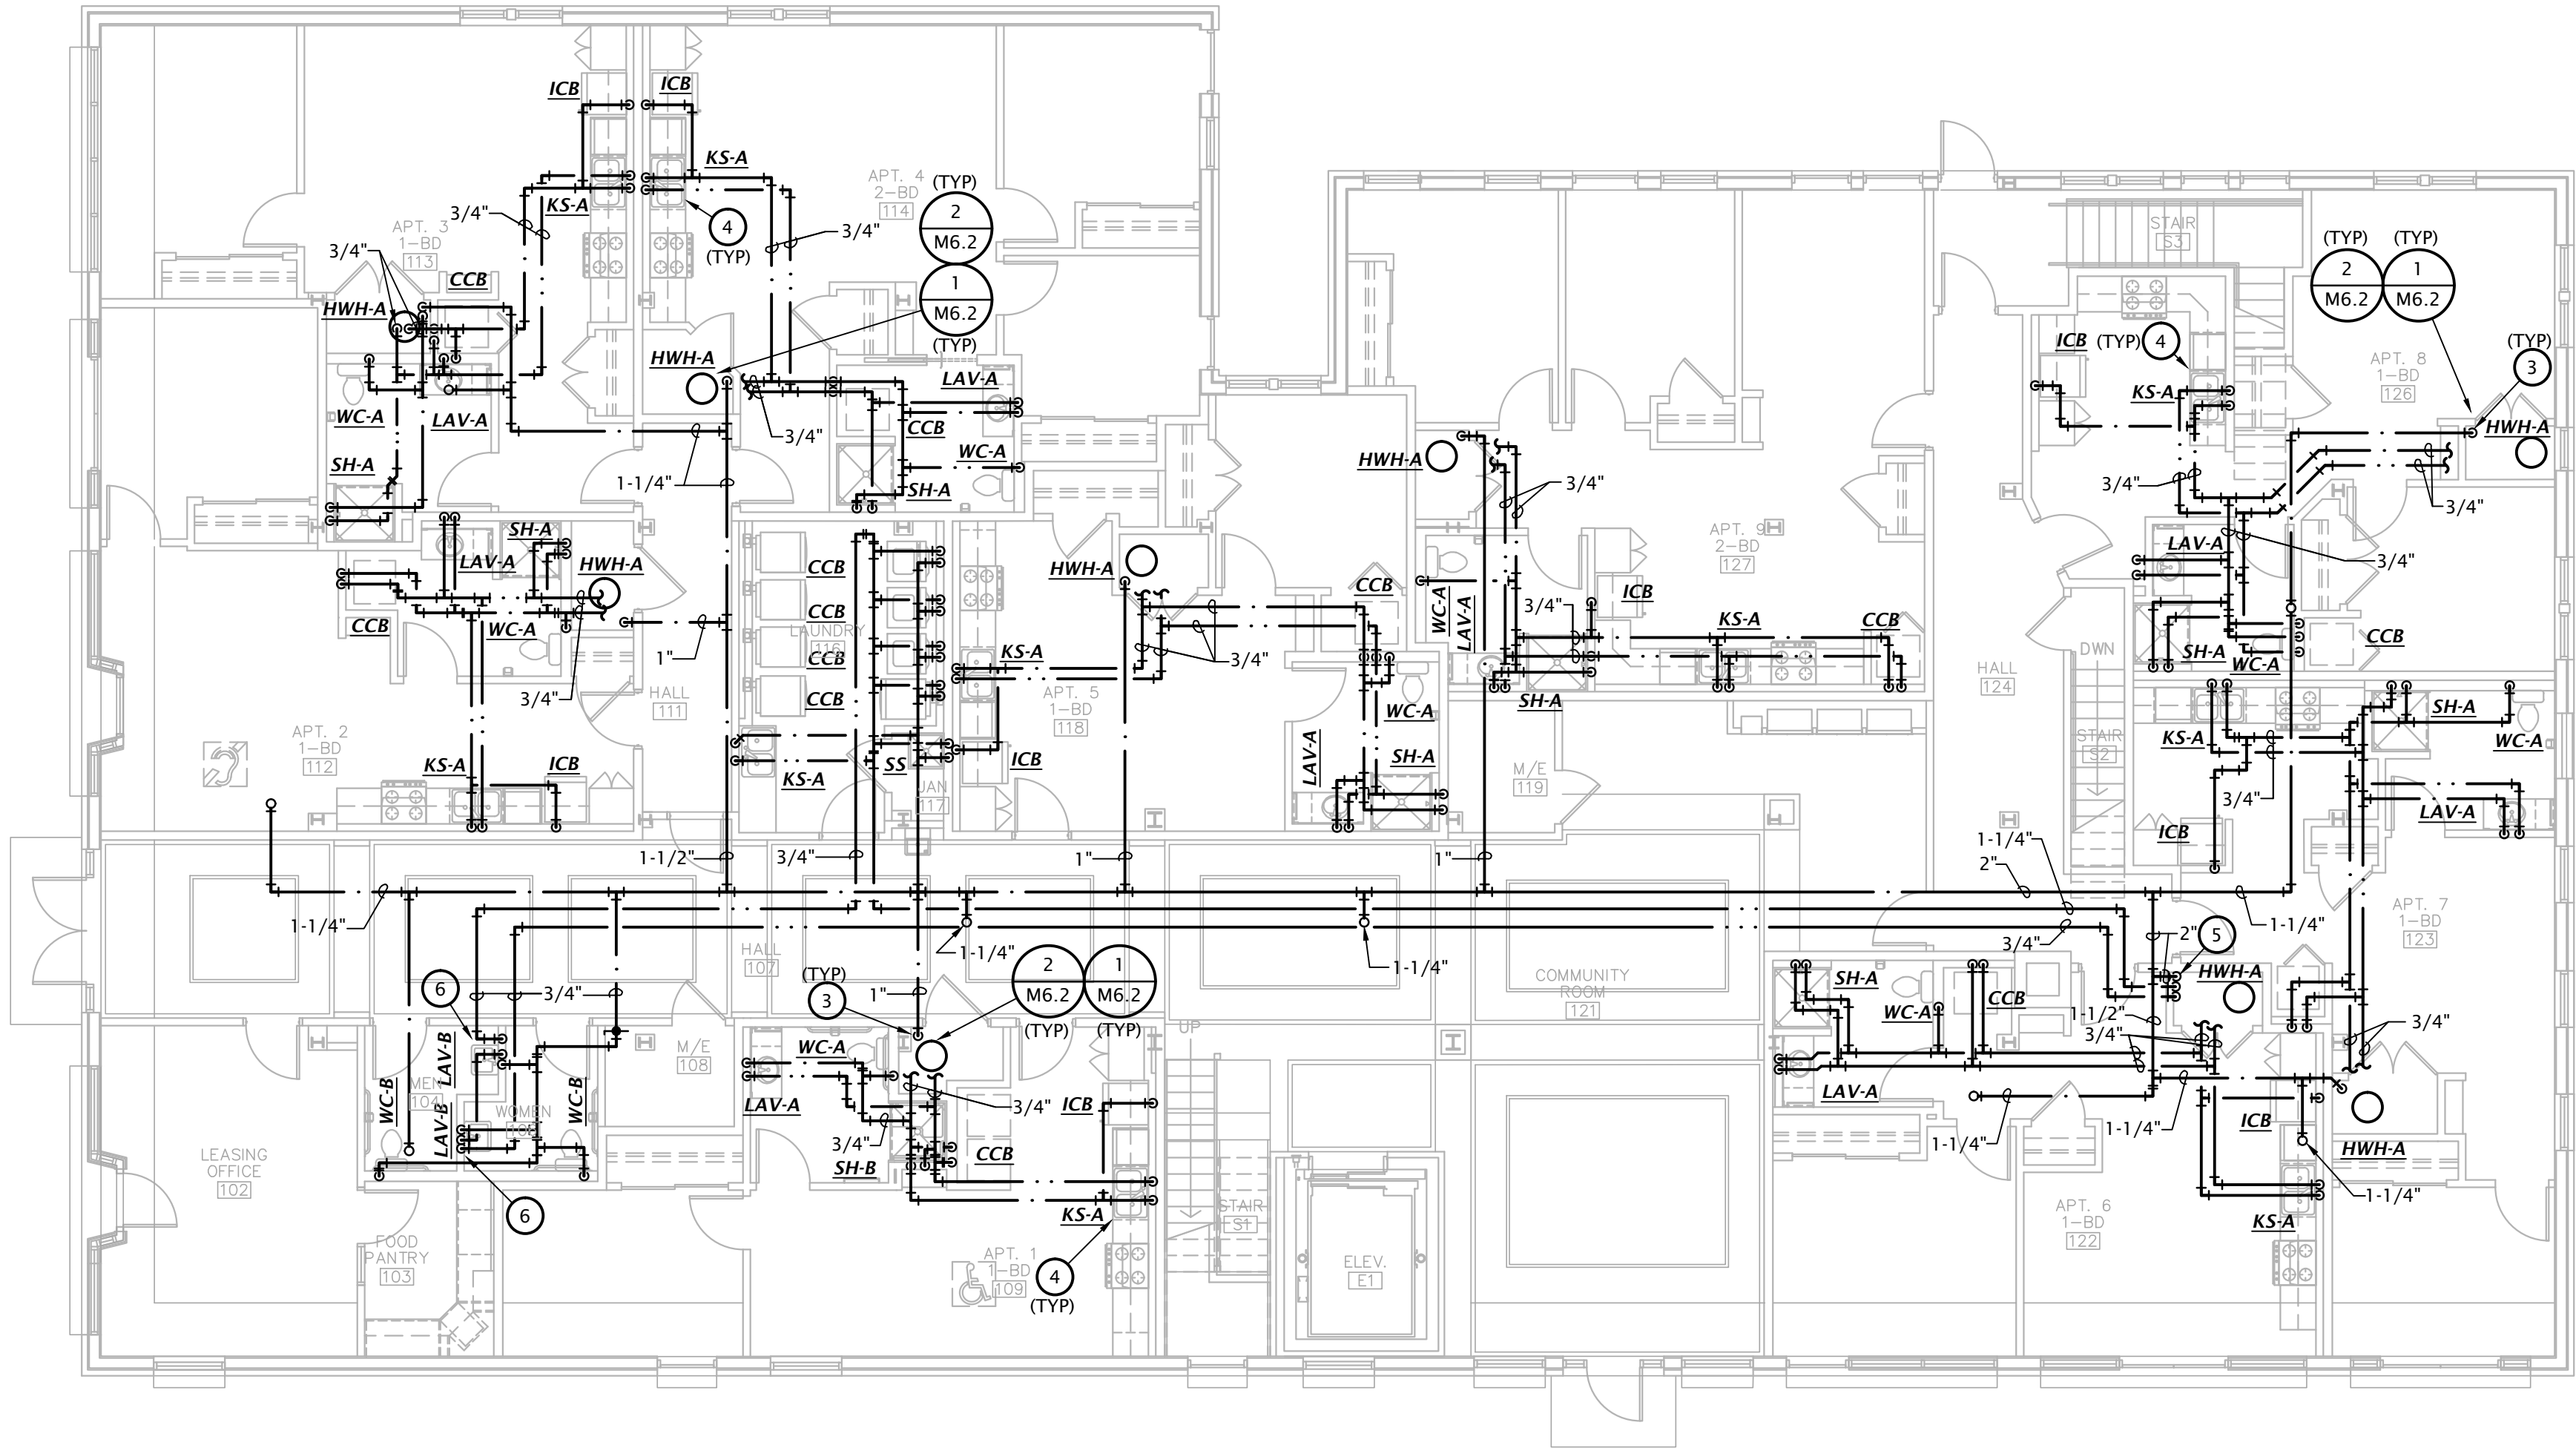


FIRST FLOOR DOMESTIC WATER PLAN  
 1/8" = 1'-0"

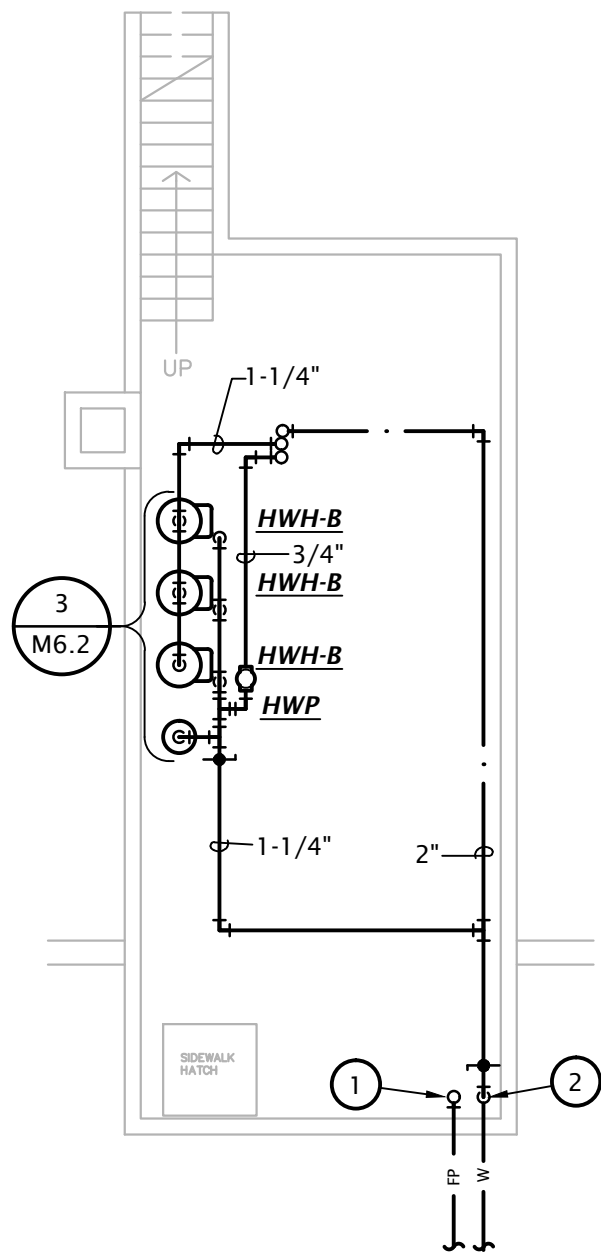

BASEMENT DOMESTIC WATER PLAN  
 1/8" = 1'-0"



REVISION:	
DATE:	1-16-2024
JOB:	21-3166
SHEET NO.:	

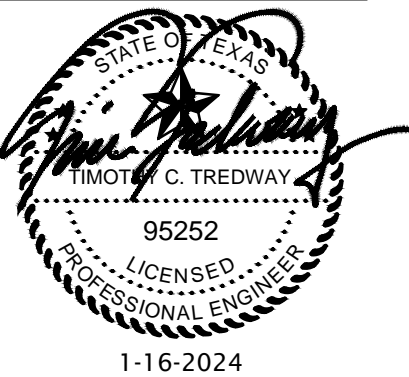

REVISION:

DATE: 1-16-2024

JOB: 21-3166

SHEET NO.:

M1.9

COPYRIGHTED ©


		ALTERNATE MATERIAL/SIZE	
		Cross-linked polyethylene (PEX)	Polypropylene (PP)
COPPER PIPE SIZE INDICATED	1/2"	3/4"	1/2"
	3/4"	1"	1"
	1"		1-1/4"
	1-1/4"		1-1/2"
	1-1/2"		2"
	2"		2-1/2"
	2-1/2"		3"
	3"		3-1/2"

Note: Pipe sizes indicated on drawings are for Type L copper pipe. If alternate materials are used, sizes shall be as indicated above. Where no pipe size is shown, use of indicated material in design pipe size is prohibited. Do not use materials other than those listed.

- NOTES:
- PIPING SHALL NOT BE INSTALLED ABOVE ELECTRICAL PANELS.
  - COORDINATE INSTALLATION OF PIPING IN MECHANICAL CLOSET W/ M.C. & E.C.
  - SEE PLUMBING FIXTURE SCHEDULE ON SHEET P6.1 FOR FIXTURE ROUGH-IN INFORMATION.
  - INSULATE ALL HW PIPING PER SPECIFICATIONS.

# DOMESTIC WATER PLAN NOTES BY SYMBOL

- PROVIDE 1" WATER SERVICE TO APARTMENT WITH SHUT-OFF VALVE. SEE TYPICAL APARTMENT DOMESTIC WATER RISER DIAGRAM ON SHEET M6.2 FOR ADDITIONAL INFO.
- PROVIDE 1/2" VALVED BRANCH BELOW SINK AND CONNECT DISHWASHER. ROUTE PIPING ALONG BACK OF CABINETRY, COORDINATE EXACT ROUTING WITH G.C. COORDINATE EXACT REQUIREMENTS WITH DISHWASHER PROVIDED.

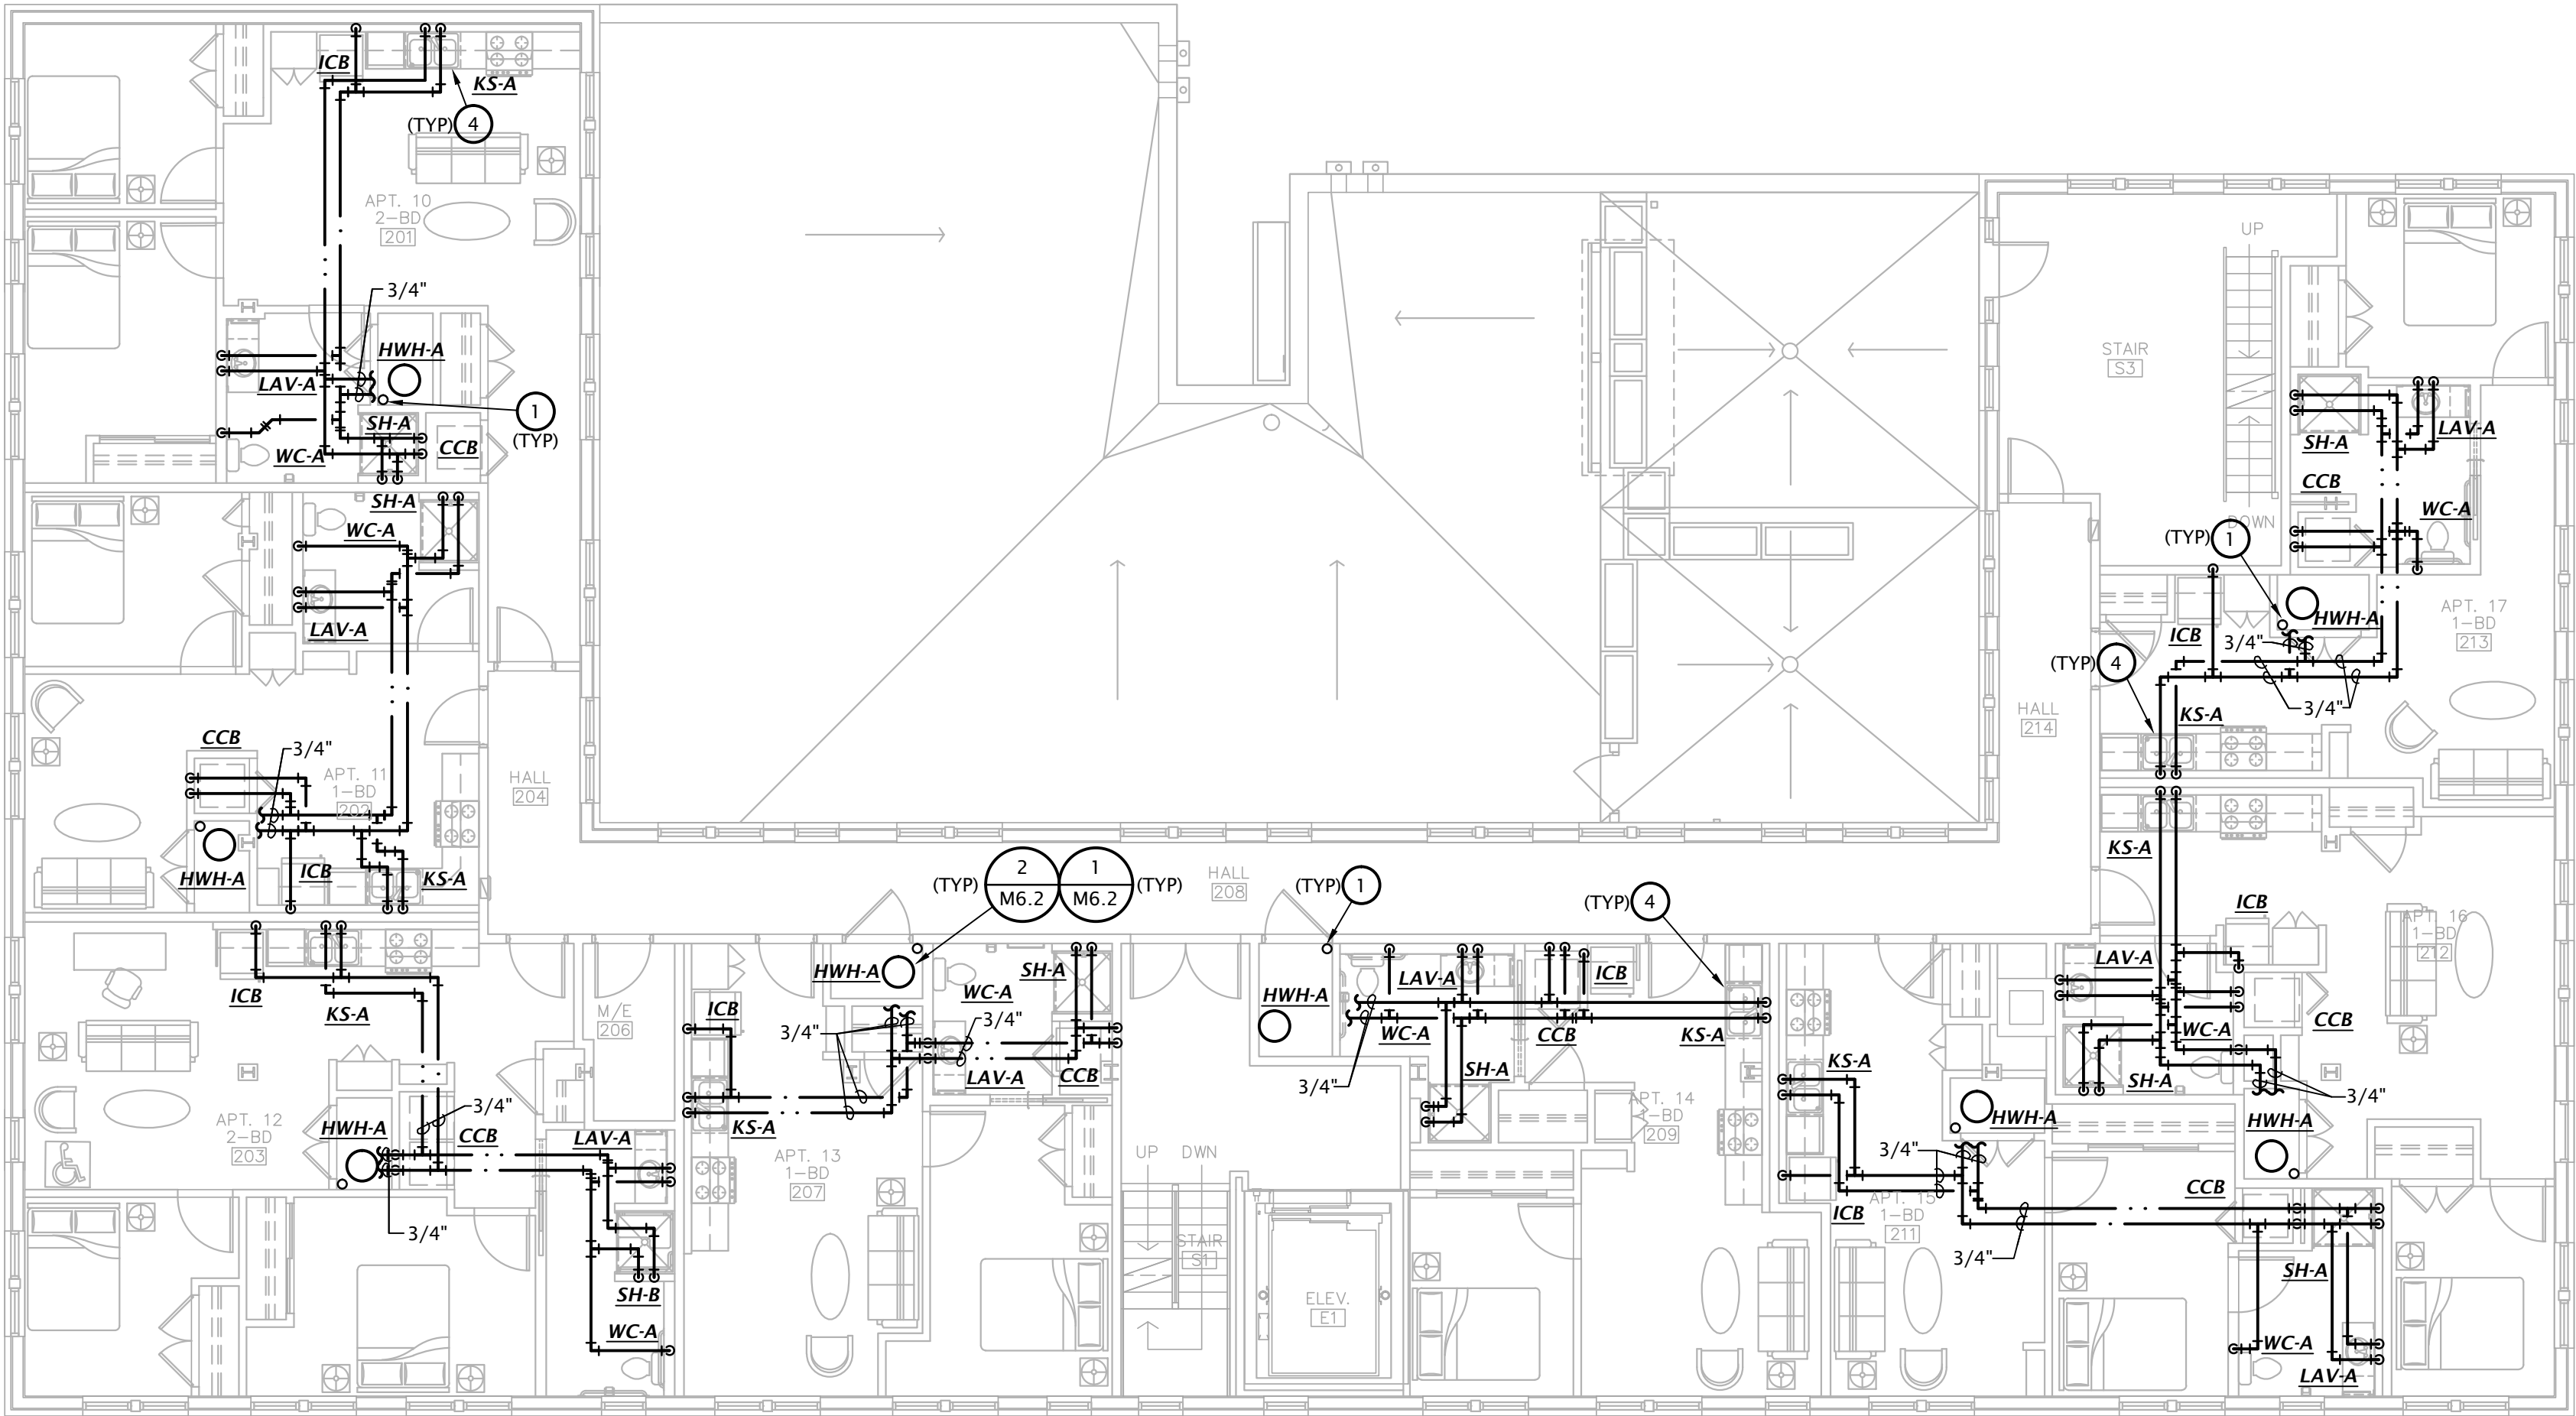

1 SECOND FLOOR DOMESTIC WATER PLAN  
 1/8" = 1'-0"



REVISION:

DATE: 1-16-2024

JOB: 21-3166

SHEET NO.:

M1.10

COPYRIGHTED ©


		ALTERNATE MATERIAL/SIZE	
		Cross-linked polyethylene (PEX)	Polypropylene (PP)
COPPER PIPE SIZE INDICATED	1/2"	3/4"	1/2"
	3/4"	1"	1"
	1"		1-1/4"
	1-1/4"		1-1/2"
	1-1/2"		2"
	2"		2-1/2"
	2-1/2"		3"
	3"		3-1/2"

Note: Pipe sizes indicated on drawings are for Type L copper pipe. If alternate materials are used, sizes shall be as indicated above. Where no pipe size is shown, use of indicated material in design pipe size is prohibited. Do not use materials other than those listed.

- NOTES:
- PIPING SHALL NOT BE INSTALLED ABOVE ELECTRICAL PANELS.
  - COORDINATE INSTALLATION OF PIPING IN MECHANICAL CLOSET W/ M.C. & E.C.
  - SEE PLUMBING FIXTURE SCHEDULE ON SHEET P6.1 FOR FIXTURE ROUGH-IN INFORMATION.
  - INSULATE ALL HW PIPING PER SPECIFICATIONS.

# DOMESTIC WATER PLAN NOTES BY SYMBOL

1. PROVIDE 1" WATER SERVICE TO APARTMENT WITH SHUT-OFF VALVE. SEE TYPICAL APARTMENT DOMESTIC WATER RISER DIAGRAM ON SHEET M6.2 FOR ADDITIONAL INFO.
2. PROVIDE 1/2" VALVED BRANCH BELOW SINK AND CONNECT DISHWASHER. ROUTE PIPING ALONG BACK OF CABINETRY. COORDINATE EXACT ROUTING WITH G.C. COORDINATE EXACT REQUIREMENTS WITH DISHWASHER PROVIDED.

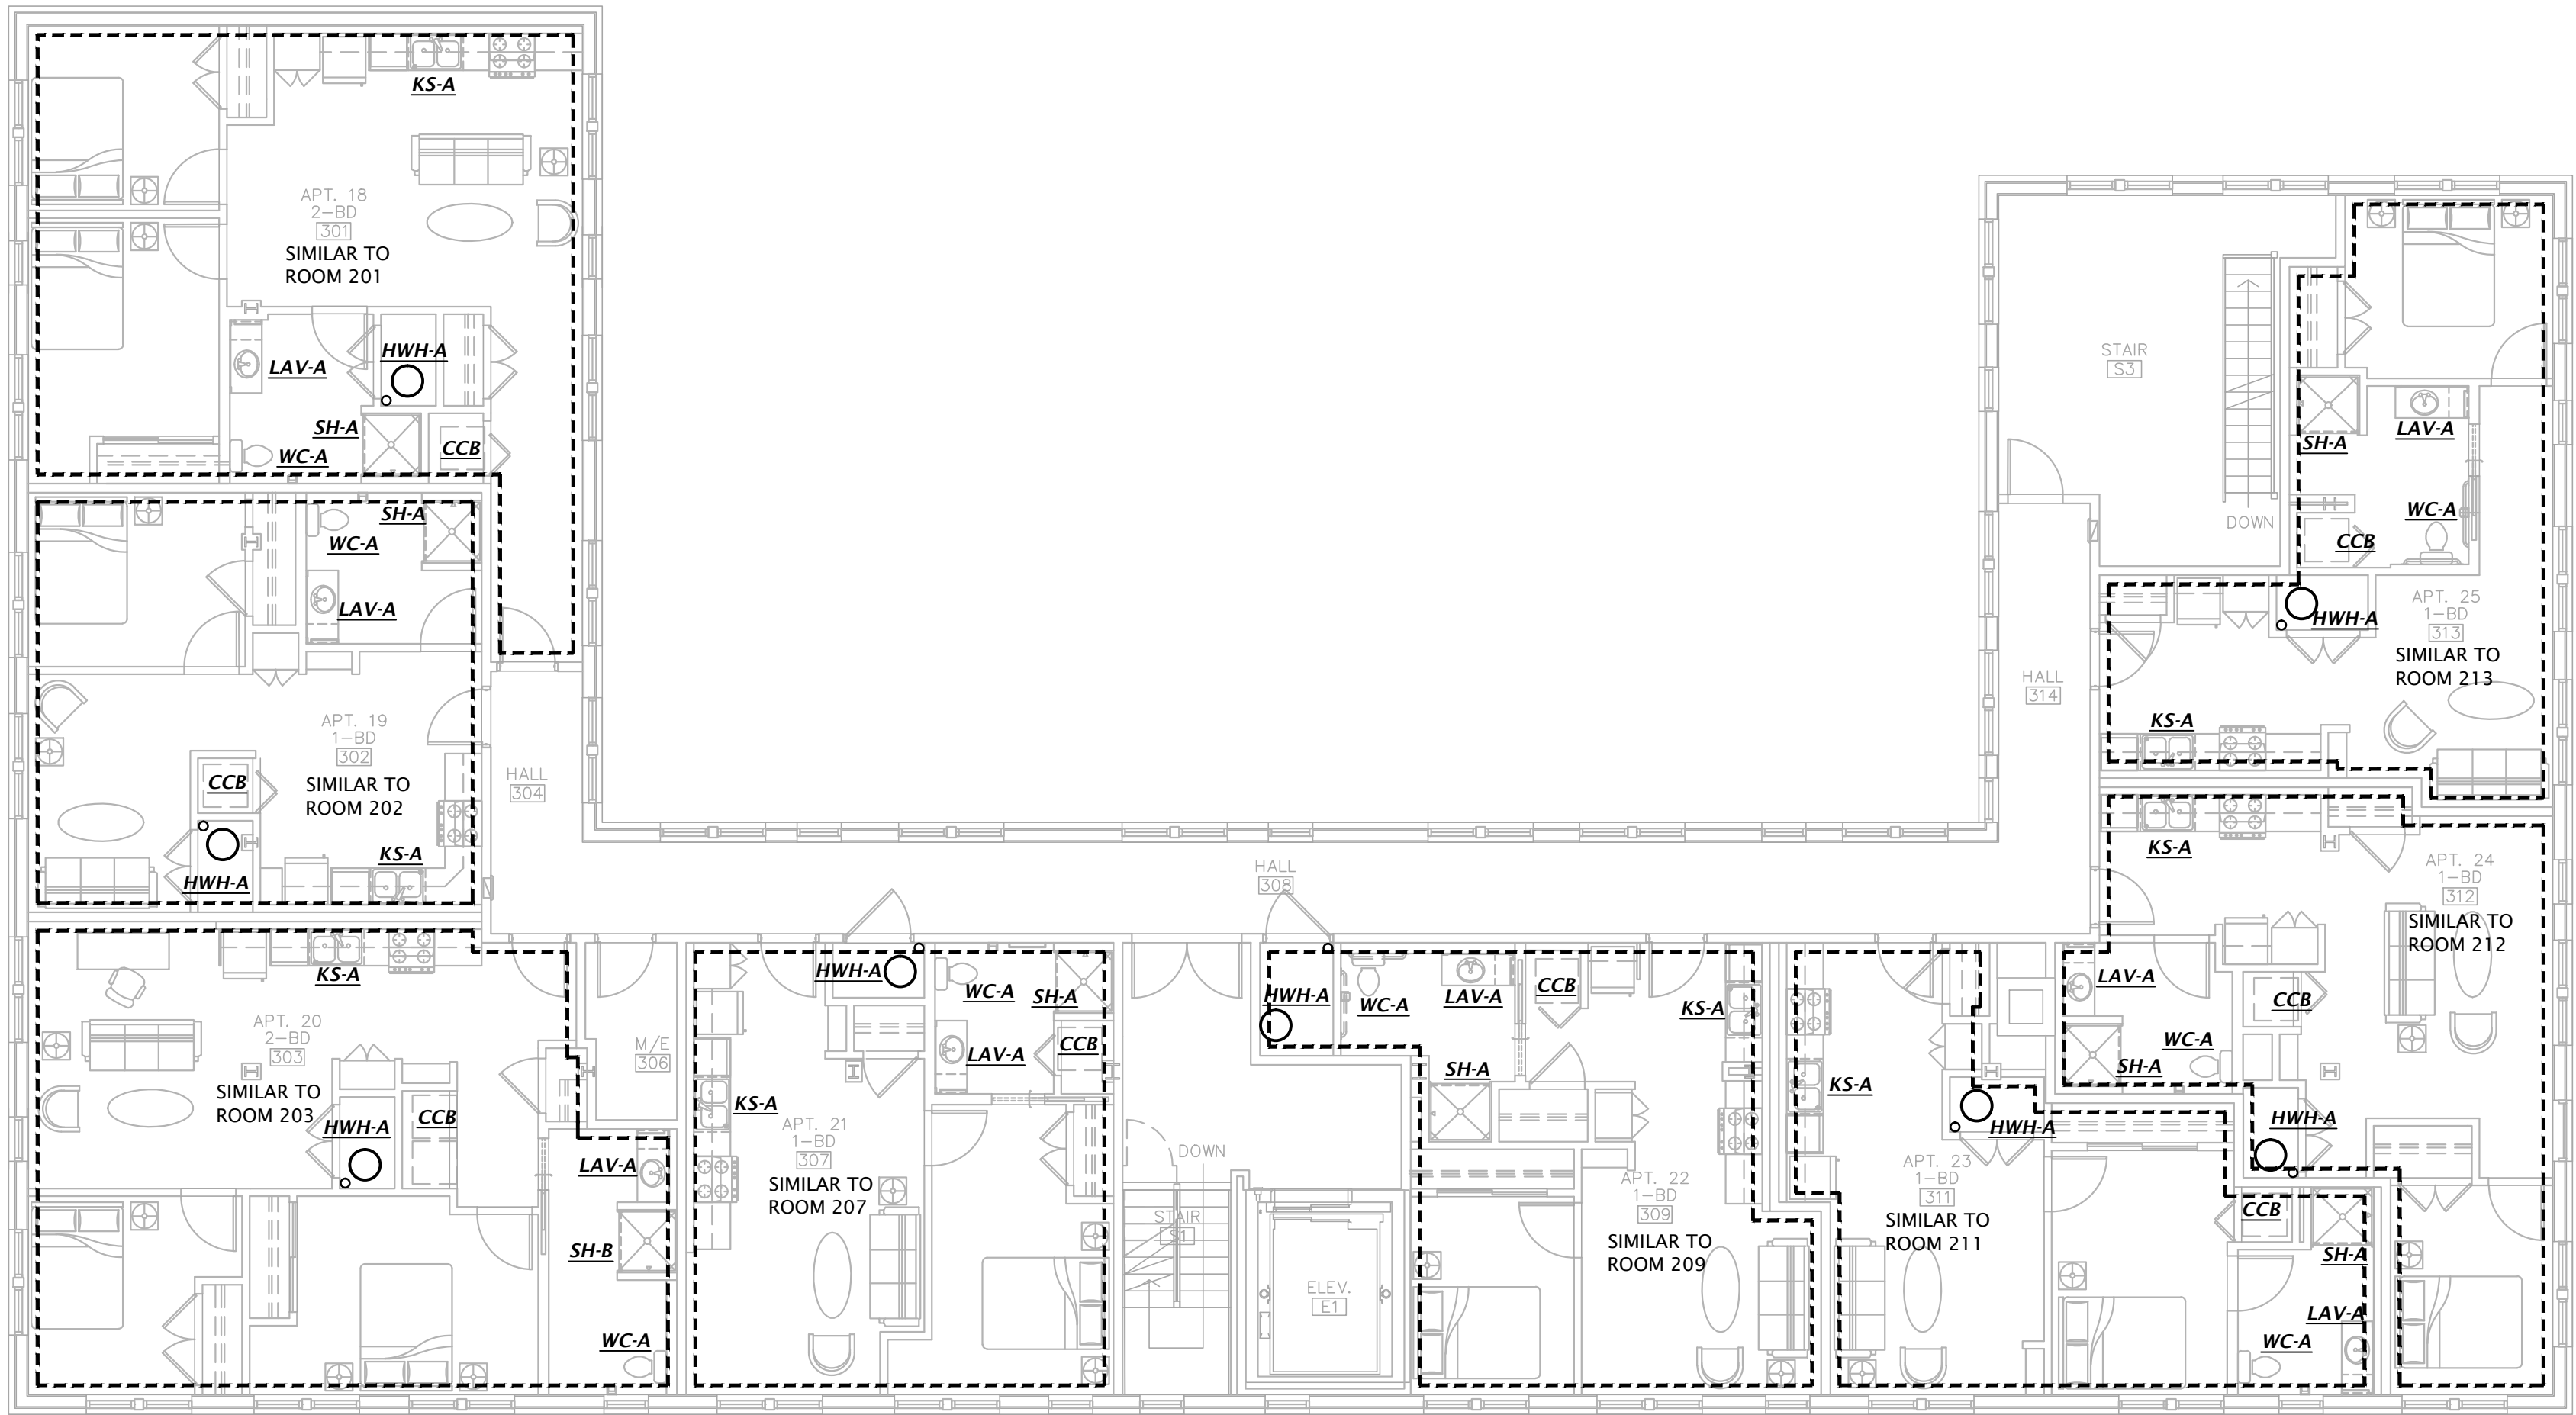

1 THIRD FLOOR DOMESTIC WATER PLAN

1/8" = 1'-0"

MITSUBISHI ELECTRIC TRANE HVAC US: CITY MULTI VRF INDOOR UNIT SCHEDULE

Room Name	Tag Reference	Model	Type	Nominal Cooling Capacity (BTU/h)	Nominal Heating Capacity (BTU/h)	Cooling Design Entering Temp DB/WB (°F) / [Water in temp]	Heating Design Entering Temp DB/WB (°F) / [Water in temp]	Corrected Capacity			Estimated Cooling Coil LAT (°F) / [LWT]	Estimated Heating Coil LAT (°F) / [LWT]	Voltage / Phase	Electrical MCA/MFS
								Cooling Total Capacity (BTU/h)	Cooling Sensible Capacity (BTU/h)	Heating Capacity (BTU/h)				
3rd Floor Stair	IU-1-1	NTXWST09B112AA	Wall -Mounted	8,000	8,300	80.0/67.0	70	7,158.3	7,146.3	7,280.3	61.4	88.6	208/230V/1-phase	Powered by Outdoor
2nd Floor Stair	IU-1-2	NTXWST09B112AA	Wall -Mounted	8,000	8,300	80.0/67.0	70	7,111.8	7,111.8	7,266.9	61.5	88.6	208/230V/1-phase	Powered by Outdoor
1st Floor Hall	IU-1-3	MSZ-EF09NAW-U2	Wall -Mounted	8,000	8,300	80.0/67.0	70	7,041.9	7,041.9	7,246.8	63.0	87.2	208/230V/1-phase	Powered by Outdoor
3rd Elevator Lobby	IU-2	NTXWMT09A112AA	Wall -Mounted	9,000	10,900	80.0/67.0	70	8,130.9	7,071.4	6,931.7	62.3	87.0	208/230V/1-phase	Powered by Outdoor
Laundry	IU-3	NTXWMT12A112AA	Wall -Mounted	12,000	12,200	80.0/67.0	70	10,841.2	8,814.5	8,472.1	57.9	90.8	208/230V/1-phase	Powered by Outdoor

MITSUBISHI ELECTRIC TRANE HVAC US: OUTDOOR UNIT SCHEDULE

Tag Reference	Model Number	Nominal Cooling Capacity (BTU/h)	Nominal Heating Capacity (BTU/h)	Cooling Efficiency IEER/EER [SEER]	Heating COP @ 47°F [HSPF]	Design Cooling Outdoor Temp DB (°F)	Design Heating Outdoor Temp WB (°F)	Corrected Cooling Total Capacity (BTU/h)	Corrected Heating Capacity (BTU/h)	Electrical-Per Module			
										208/230 or [460V]	208/230	RFS	MOCP
OU-1	NTXMPH24A132CA	22,000	25,000	11.75 [17.25]	[9.5]	101.0	16.5	21,312.0	21,794.1	208/230V / 1-phase	31.5	40	40
OU-2	NTXSMT09A112AB	9,000	10,900	12 [18]	3.549564 [10]	101.0	16.5	8,130.9	6,931.7	208/230V / 1-phase	9	15	15
OU-3	NTXSMT12A112AB	12,000	12,200	9.9 [18]	3.611733 [10]	101.0	16.5	10,841.2	8,472.1	208/230V / 1-phase	9	15	15

PLUMBING FIXTURE SCHEDULE

MARK	MANUFACTURER	DESCRIPTION	TRIM		ROUGH-IN SIZES				NOTES
			MANUFACTURER	DESCRIPTION	WASTE	VENT	CW	HW	
WC-A	KOHLER	Model 3999-0 "Highline" ADA compliant flush tank water closet, white vitreous china, two piece, 12" rough-in, elongated 16-1/2" high bowl, siphon jet flushing action, 1.28 GPF, polished chrome actuator located on open side of room.	KOHLER	#K-4636-0 white, closed front plastic seat with slow closing lid.	4"	2"	1/2"	---	1
WC-B	KOHLER	Model 3999-0 "Highline" ADA compliant flush tank water closet, white vitreous china, two piece, 12" rough-in, elongated 16-1/2" high bowl, siphon jet flushing action, 1.28 GPF, polished chrome actuator located on open side of room.	KOHLER	#4650-0 Lustra white, open front, plastic seat with cover	4"	2"	1/2"	---	1
LAV-A	AMERICAN STANDARD	Model 0610.0.000 under counter mounted lavatory, white vitreous china, 20-1/4"W x 16"	KOHLER	Model 15182-4RA single handle faucet. Provide pop-up drain.	2"	1-1/2"	1/2"	1/2"	1,2,4
LAV-B	KOHLER	Model K-2035-1 wall hung, white vitreous china, 22"W x 18", single hole faucet.	DELTA	Model 597LF-PNMPU single handle faucet, with polished nickel finish. Provide with pop-up drain.	2"	1-1/2"	1/2"	1/2"	1,2,3
KS-A	JUST	Model DL-ADA-2233-A-GR two compartment 18 GA stainless steel sink, self rimming, 14"x16"x5"D inside, fully undercoated, faucet holes as req., and drain holes center rear.	IN-SINK-ERATOR	Model 400-HDF single handle kitchen sink faucet with hose spray attachment. Chrome finish. Provide basket strainer.	2"	1-1/2"	1/2"	1/2"	1,3,2,4
KS-B	BLANCO	Model Liven Silgranit single compartment granite composite sink, 22-1/4"x16-15/16"x12"D inside, faucet holes as req., metallic gray finish. Coordinate mounting type with Arch.	MOEN	Model 87194 single handle high arc kitchen sink faucet with spring pulldown sprayer. Stainless finish. Provide basket strainer.	2"	1-1/2"	1/2"	1/2"	2
SH-A	AQUARIUS	Model "G-3600-BF-1S" reinforced fiberglass ADA shower, 36"W x36"D x77"H, with integral soap/toiletry shelves, integral seat and grab bars in accordance with ADA requirements. Right or left hand rough-in as required, center drain, white finish.	KOHLER	#K-304 pressure balancing valve with integral temperature limits and stops, #K-TS10584-4 valve trim, #K-355 wall supply elbow, #K-9514 60" hose, #K-10549 hand shower, and #K-8524/K-349 slide bar. Entire assembly shall have rubbed bronze finish.	2"	1-1/2"	1/2"	1/2"	1
SH-B	AQUARIUS	Model "G-3600-BF-1S" reinforced fiberglass ADA shower, 36"W x36"D x77"H, with integral soap/toiletry shelves, integral seat and grab bars in accordance with ADA requirements. Right or left hand rough-in as required, center drain, white finish.	KOHLER	#K-304 pressure balancing valve with integral temperature limits and stops, #K-TS10584-4 valve trim, #K-355 wall supply elbow, #K-9514 60" hose, #K-10549 hand shower, and #K-8524/K-349 slide bar. Entire assembly shall have rubbed bronze finish.	2"	1-1/2"	1/2"	1/2"	1
SS	FIAT	Model MSB-2424 one piece molded stone mop basin, 24" square, stainless steel integral drain body with caulk connection, stainless steel wall guards.	DELTA	Model 28T9 faucet with hose thread outlet, vacuum breaker, pail hook, wall brace, metal lever handles.	3"	1-1/2"	3/4"	3/4"	4
EWC	ELKAY	Model EZS8WSLK ADA compliant , self-contained water cooler with stainless steel basin, front push bar actuator, bottle filler, lead-free cooling system capable of cooling 8.0 GPH, 120 volts.			2"	1-1/2"	1/2"	---	
WH	WOODFORD	Model 25 frost proof wall hydrant with anti-siphon vacuum breaker, metal handle.			---	---	3/4"	---	
RH	WOODFORD	Model RHY2-MS frost proof roof hydrant with ASSE 1052 double check backflow preventer that is field testable, integral vent that allows drainage with 1/8" drain hole drilled and tapped in body of hydrant. Provide with manufacturers roof mounting system consisting of cast iron hydrant support, under deck flange, well seal, EPDM boot, and shims as required. Coordinate installation with G.C..			---	---	3/4"	---	
CCB	WATER TITE	Model W4700 recessed washing machine box with 2"PVC/ABS drain coupling and knockout test cap. Two, 1/4 turn adaptor ball valves, sweat connection.			2"	2"	1/2"	1/2"	
ICB	WATER TITE	Model W9700 ice maker connection box with 1/4 turn ball valve and 1/2" sweat copper connection.			---	---	1/2"	---	
DB	SIOUX CHIEF	Model 696-3 drainage box box with 2" drain connection and solid cover. Provide with Proset Trapguard trap protection device.			2"	---	---	---	
FD	SIOUX CHIEF	Series 833 adjustable floor drain with nickel bronze strainer. Provide Proset Trapguard trap protection device.			2"	---	---	---	
FS	WADE	Model 9140 floor sink with 8" deep body, enameled interior, sediment bucket, nickel bronze trim and grate with openings as required.			3"	1-1/2"	---	---	
RD	WADE	Model 3000 cast iron side outlet body roof drain with flange, flashing ring with gravel stop, underdeck clamp and cast iron dome strainer.							
ORD	WADE	Model 3000 cast iron side outlet body overflow roof drain with 2" cast iron dam/ flashing ring, flange, underdeck clamp and cast iron dome strainer.							
DN	WADE	Model 3940 nickel bronze downspout nozzle with threaded outlet and flange to secure nozzle to wall.							
HWH-A	A.O. SMITH	Model ENT-40, 40 gallon electric water heater, (2) non simultaneous 4500 watts, 208 volt / 1-phase heating elements, 21 GPH recovery @ 90°F temp rise. Minimum 0.95 Energy Factor. Supplied with temperature & pressure relief valve and brass drain valve.							5
HWH-B	RHEEM	Model ELD52-TB, 50 gallon electric water heater, (2) 4500 watt, 208 volt / 3-phase heating elements, 41 GPH recovery @ 90°F temp rise. Supplied with temperature & pressure relief valve and brass drain valve.							
HWP	BELL & GOSSETT	Model NBF-33 circulation pump, bronze body, 10 GPM @ 10' head, 120 VAC. Provide clamp-on aquastat for pump control.							

GENERAL:

- Provide fixtures with all trim necessary for complete installation

NOTES:

- Fixture and installation to meet accessibility requirements of the Fair Housing Act.
- Provide Dearborn supplies with stops and escutcheon plate, 1-1/4" cast brass p-trap.
- Insulate water and waste piping below lavatory. Utilize insulation kit equivalent to LaGuard by Truebro.
- Trim shall be provided with polished chrome finish.
- Mount water heater on stand equivalent to Oatey water heater stand.

BLOWER COIL SCHEDULE

MARK	MANUF.	MODEL	FAN			HEATING KW	V/Ph	MOTOR FLA	MCA	MOCP	NOTES
			CFM	ESP	SPEED						
BC-1.5	TRANE	TEM4A0B18	600	0.6	HIGH	5.8	208/1	1.2	36	40	
BC-2	TRANE	TEM4A0B31	800	0.6	HIGH	5.8	208/1	4.1	42	45	
BC-2.5a	TRANE	TEM4A0B36	1000	0.6	HIGH	7.2	208/1	2.0	46	50	
BC-2.5b	TRANE	TEM4A0B36	1000	0.6	HIGH	7.2/3.6	208/1	2.0	46/22	50/25	1
BC-3	TRANE	TEM4A0C42	1200	0.6	MED	7.2	208/1	4.1	48	50	
BC-4	TRANE	TEM4A0C49	1380	0.6	HIGH	7.2/7.2	208/1	6.0	51/43	60/45	1

General Notes:

- Single point connection required, coordinate the exact electrical requirements of equipment provided with E.C., UNO
- Electric heater shall not operate simultaneously with heat pump. Electric heater shall be used as back-up heat only.

Notes:

- Blower coil heat has two circuits, first circuit indicated includes fan motor.

HEAT PUMP SCHEDULE

MARK	MANUF.	MODEL	NOMINAL TONS	COOLING CAPACITY				HEATING CAPACITY			MIN HSPF2	ELECTRICAL		
				OA DB	ENT AIR DB/WB	SENS MBH	TOT MBH	MIN SEER2	OA DB	ENT AIR DB	TOT MBH	MCA	MOCP	V/PH
HP-1.5	TRANE	4TWR4018	1.5	105	75/63	10.5	13.1	14.3	47	70	18.9	7.5	12	20 208/1
HP-2	TRANE	4TWR4024	2	105	75/63	16.6	20.7	14.3	47	70	22.5	7.5	13	25 208/1
HP-2.5	TRANE	4TWR4030	2.5	105	75/63	20.0	25.1	14.3	47	70	27.7	7.5	17	25 208/1
HP-3	TRANE	4TWR4036	3	105	75/63	24.5	29.9	14.3	47	70	33.9	7.5	18	30 208/1
HP-4	TRANE	4TWR4048	4	105	75/63	32.1	41.7	14.3	47	70	45.3	7.5	24	40 208/1

Notes:


- Refrigerant lines shall be field fabricated. Coordinate line sizing requirements with equipment manufacturer for length of run for each apartment. Provide suction accumulators, etc. as required.
- Note not used
- Provide 7-day programmable thermostat.
- Provide with R140a refrigerant.
- Provide 2 sets of MERV-7 filters.

ELECTRIC HEATER SCHEDULE

MARK	MANUF.	MODEL	MOUNTING	WATTS	VOLTAGE/PHASE	DESCRIPTION	NOTES
EWH-1,2,3	TRANE	UHWA	WALL	1,500	120/1	Architectural fan forced wall heater	1,2,3

NOTES:

- Provide with high temp. thermal cutout and fan delay.
- Provide with integral thermostat and unit mounted disconnect switch.
- Provide with manufacturer's surface mounting adapter sleeve. Coordinate exact mounting requirements and locations with Arch. and rated construction.

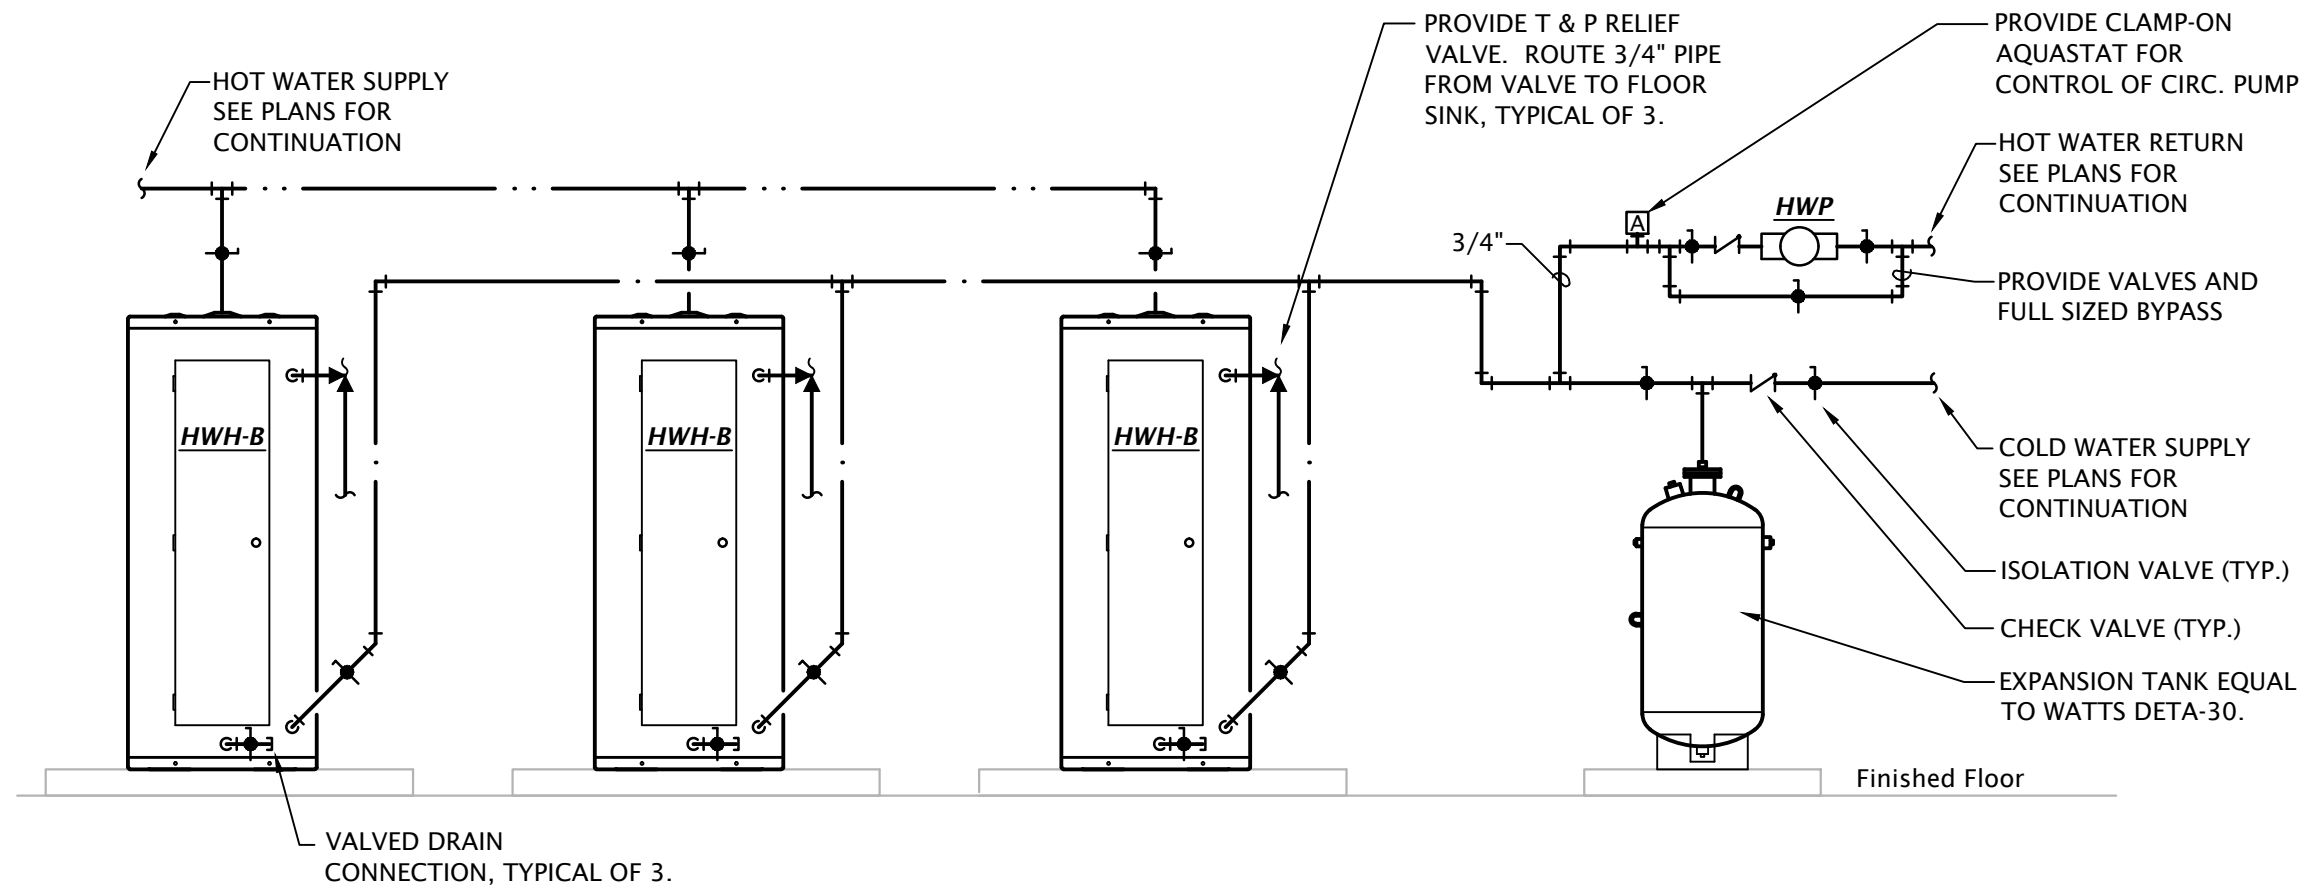


③ COMMON AREA WATER HEATER PIPING DIAGRAM  
NO SCALE

REVISION:

AIR DEVICE SCHEDULE

MARK	MANUFACTURER	MODEL	APPLICATION				FINISH	MOUNTING	DAMPER	DESCRIPTION	NOTES
			SUPPLY	RETURN	EXHAUST	TRANSFER					
SD-A	HART & COOLEY	684	•				WHITE	SURFACE	YES	12"x12" steel 4-way ceiling register with damper	1,2
SD-B	HART & COOLEY	684	•				WHITE	SURFACE	YES	10"x10" steel 4-way ceiling register with damper	1,2
SD-C	HART & COOLEY	684	•				WHITE	SURFACE	YES	8"x8" steel 4-way ceiling register with damper	1,2
SD-D	HART & COOLEY	684	•				WHITE	SURFACE	YES	6"x6" steel 4-way ceiling register with damper	1,2
SD-E	HART & COOLEY	618	•				WHITE	SURFACE	YES	Aluminum, straight blade vertical fin register with opposed blade damper	1
SD-F	HART & COOLEY	683	•				WHITE	SURFACE	YES	12"x12" steel 3-way ceiling register with damper	1,2
SD-G	PRICE	SPD	•				WHITE	SURFACE	YES	12"x12" steel square louvered diffuser, neck size as indicated on drawings	
SD-H	PRICE	LBMH-26C	•				MILL	FLOOR	YES	Heavy duty aluminum bar grille with 3/16" bars spaced at 7/16" with 15' deflection, size as indicated on drawings	1
RG-A	HART & COOLEY	650		•			WHITE	SURFACE	NO	Single deflection, steel, louvered face return grille, size as indicated on drawings	1
RG-B	PRICE	530		•			WHITE	SURFACE	NO	Steel louvered return grille, size as indicated on drawings	1
TG-A	HART & COOLEY	650			•		WHITE	SURFACE	NO	Single deflection, steel, louvered face return grill	1

- GENERAL NOTES:
- Provide mounting frame as required for ceiling type.
  - Maximum NC shall be 25.
  - Paint objects visible through grilles with flat black paint.
  - Provide ceiling radiation damper for all devices located in a rated ceiling.
- NOTES:
- Neck size shall be same as face.
  - Provide runout as indicated in tag on plans and transition to square neck or provide plenum and tap with runout.

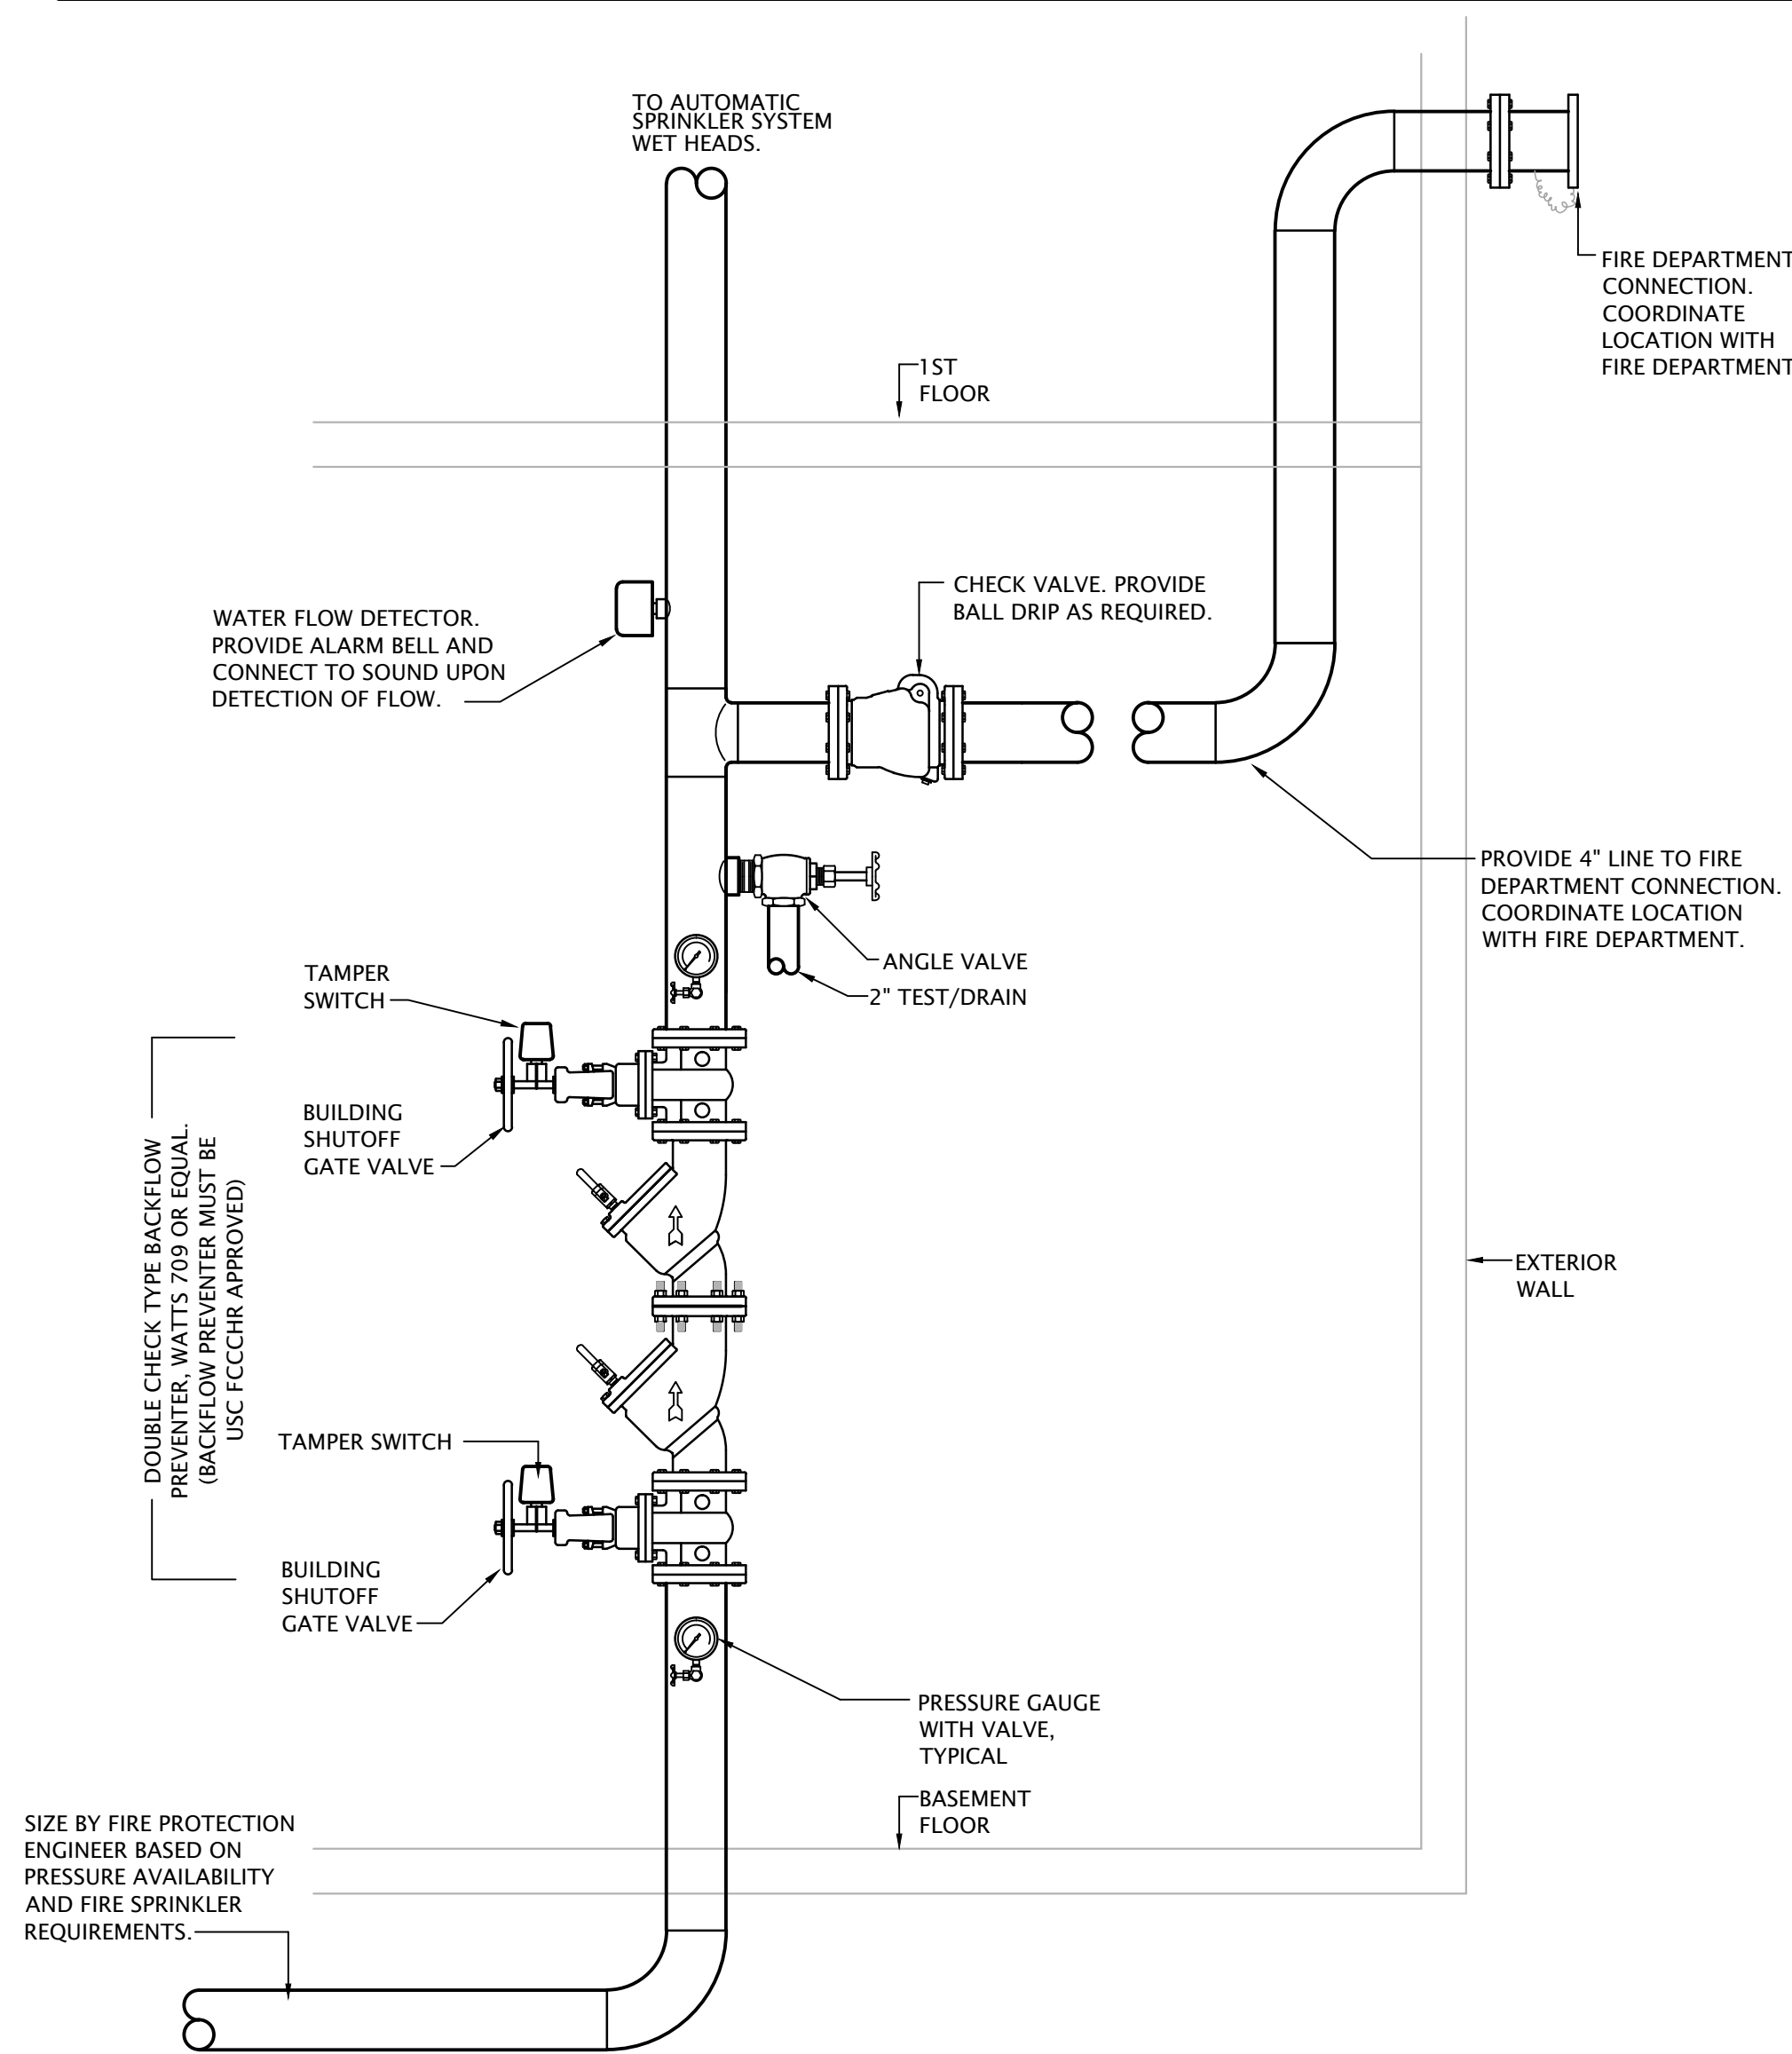

3 FIRE PROTECTION RISER DIAGRAM  
NO SCALE

GRAVITY ROOF HOOD SCHEDULE


MARK	MANUFACTURER	MODEL	SIZE	THROAT AREA (SF)	FINISH	SCREEN	DAMPER	SERVICE	DESCRIPTION	NOTES
IH-1,2	GREENHECK	GRSI-10	10"x10" DAMPER	0.57	GALVANIZED STEEL	BIRD	GRAVITY	INTAKE	GALVANIZED STEEL GRAVITY INTAKE HOOD	1
IH-3	GREENHECK	GRSI-16	16"x16" DAMPER	1.45	GALVANIZED STEEL	BIRD	120V	INTAKE	GALVANIZED STEEL GRAVITY INTAKE HOOD	1

- NOTES:
- Provide with roof curb compatible with roof slope and construction.


EXHAUST FAN SCHEDULE

MARK	MANUFACTURER	MODEL	CFM	ESP (" wg)	POWER	VOLTS/ PHASE
EF-1	BROAN	XB80	80	0.25"	36 W	120 / 1
EF-2	BROAN	XB50	50	0.25"	5.1 W	120 / 1


- NOTES:
- Fixture shall be Energy Star listed.
  - Fixture shall operate at <1 SONE
  - Provide with integral disconnect.
  - Provide manufacturer's wall cap or roof jack, see plans.
  - Provide integral backdraft damper.
  - Provide with manufacturer's ceiling radiation damper.

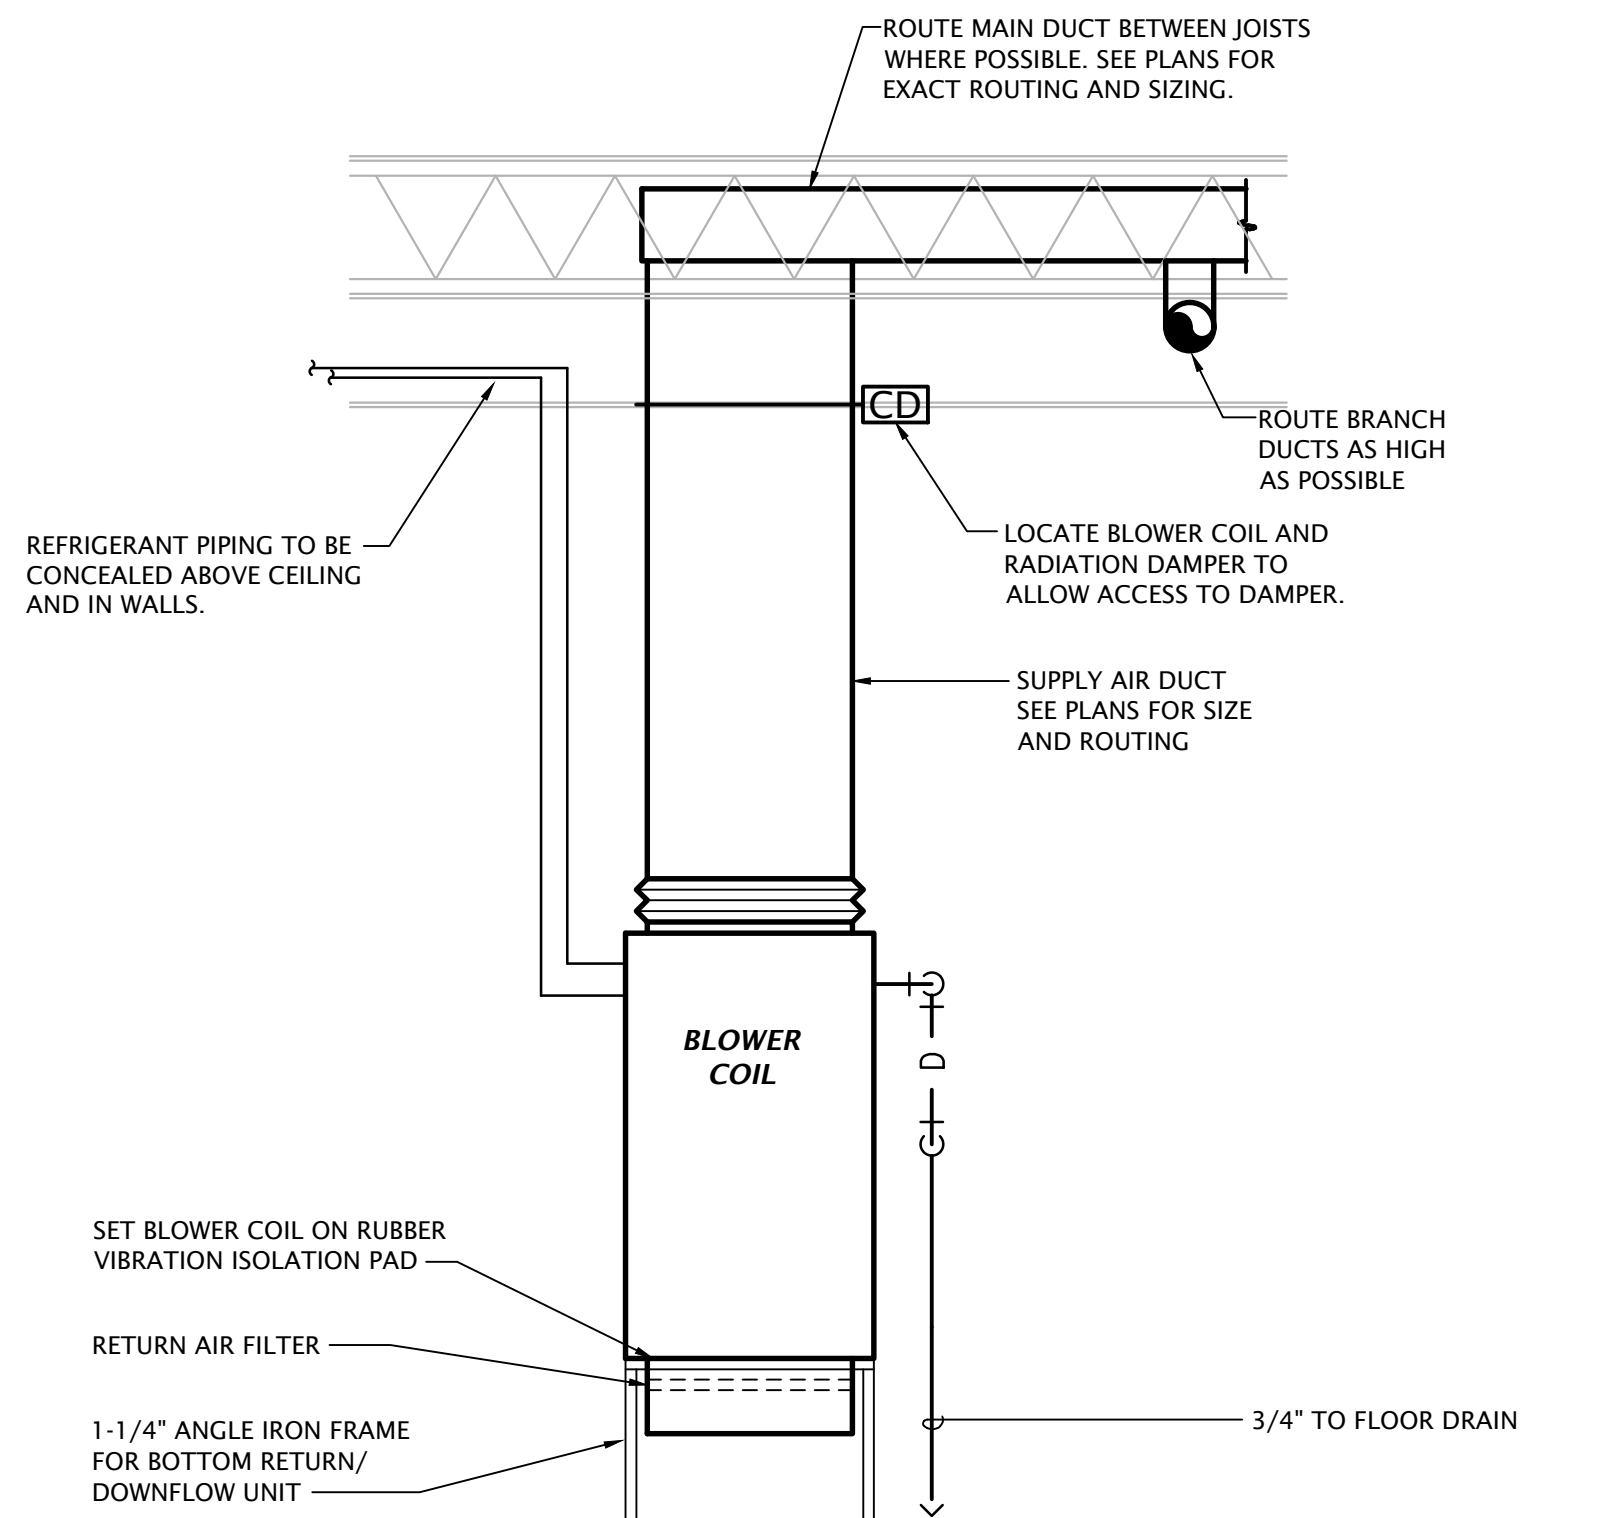

1 TYPICAL BLOWER COIL DETAIL  
NO SCALE

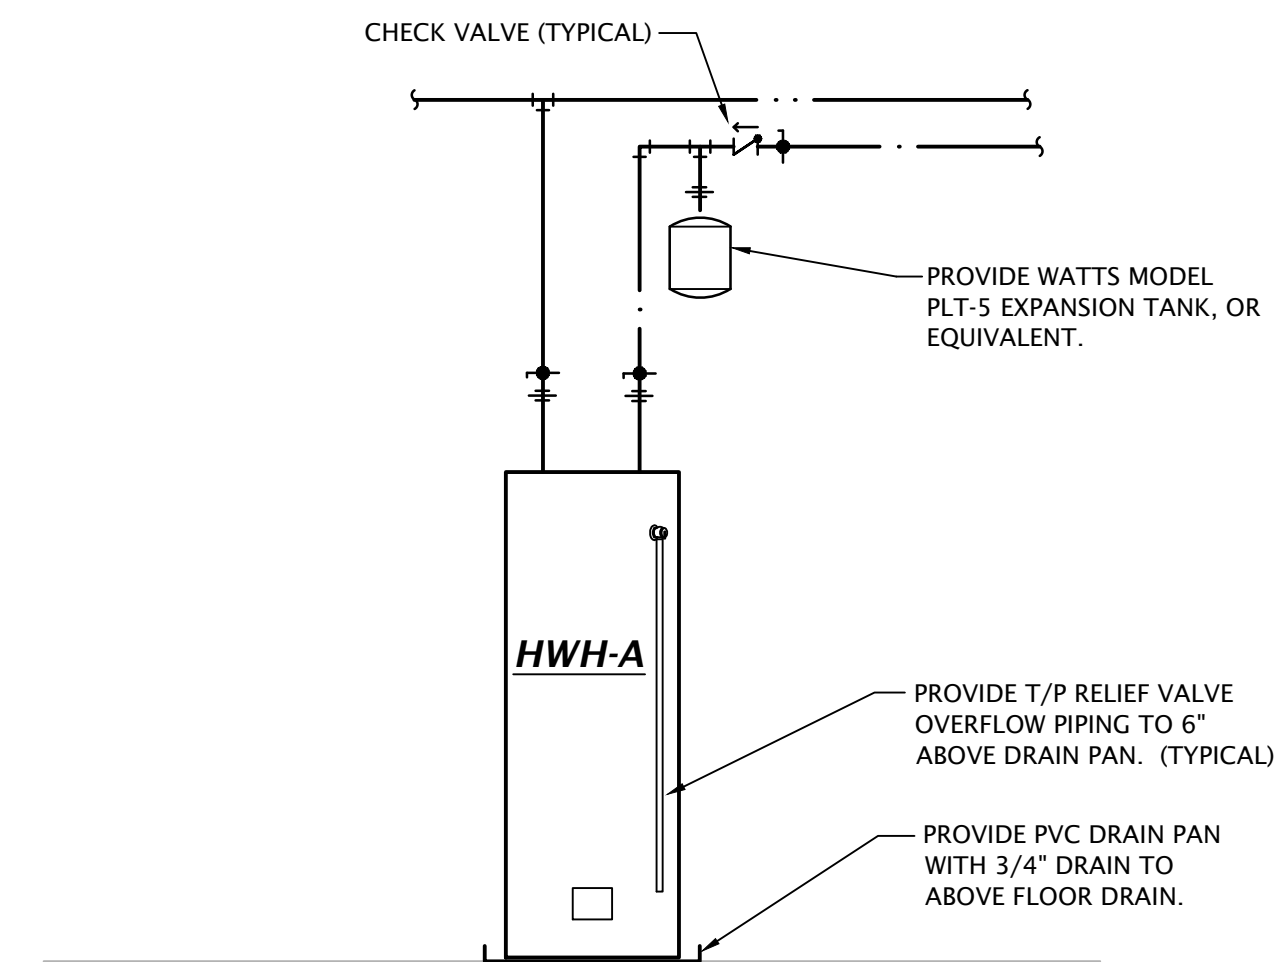

2 APARTMENT WATER HEATER DETAIL  
Not to Scale

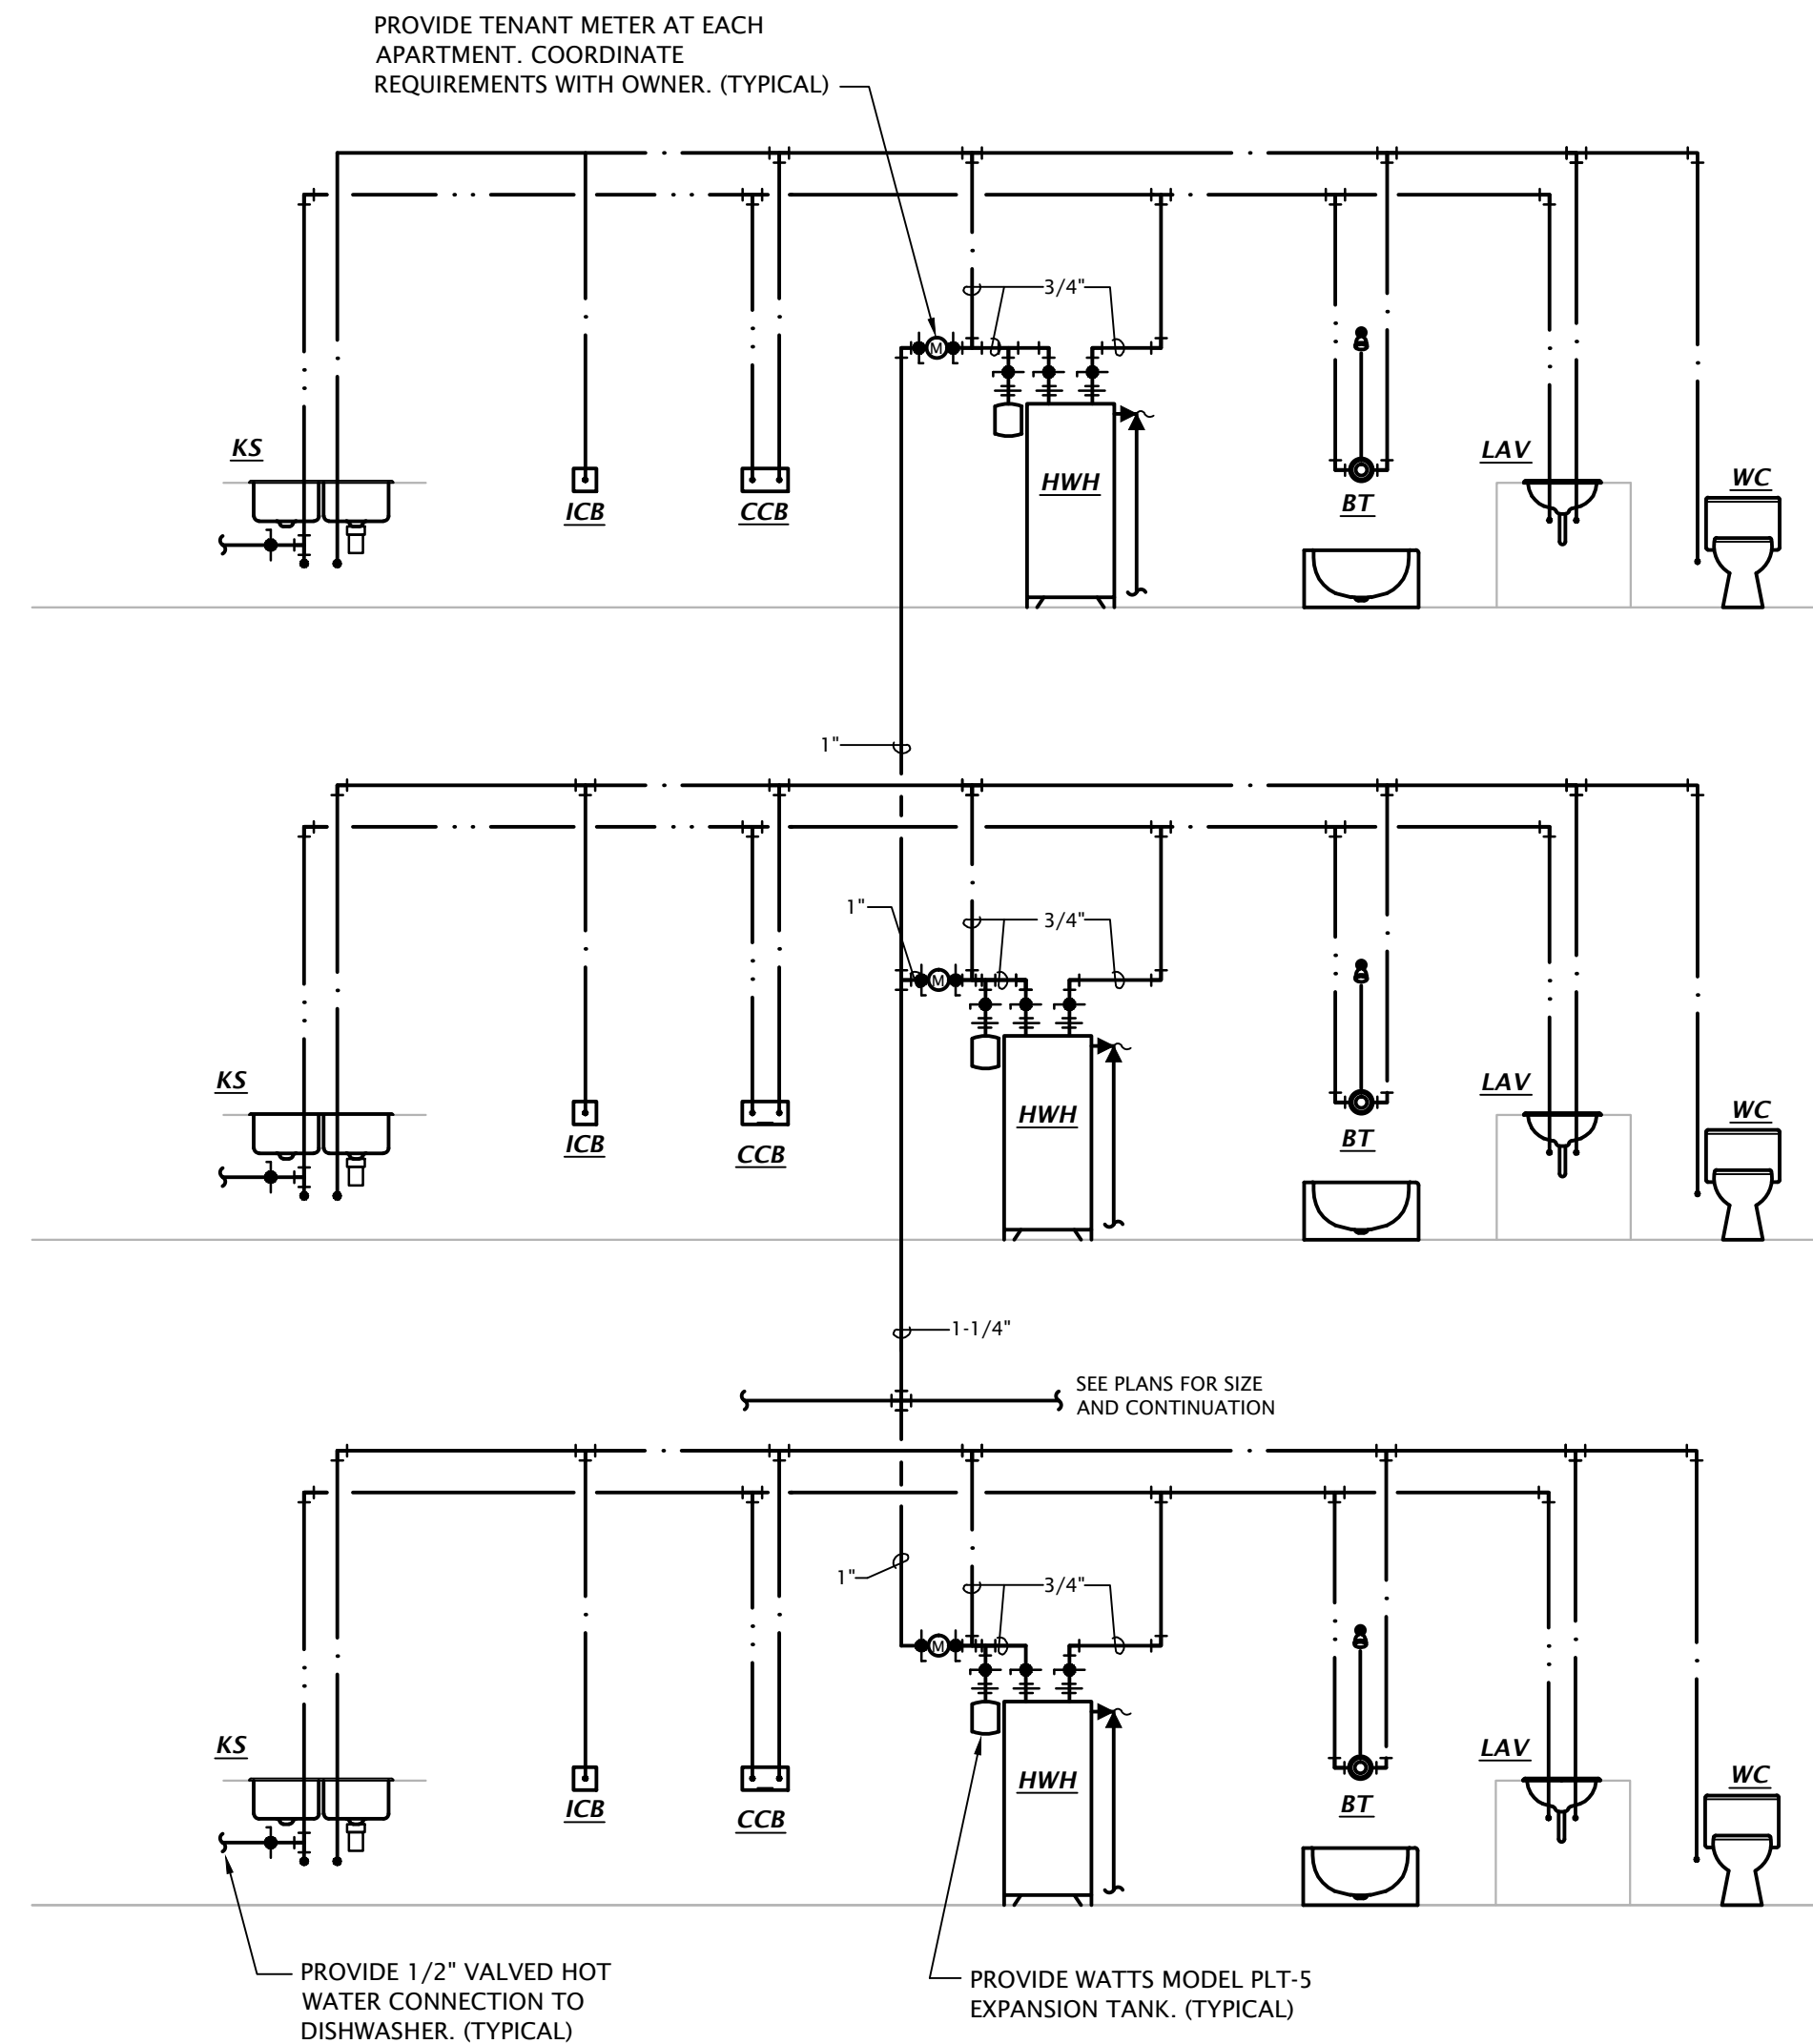


4 TYPICAL APARTMENT DOMESTIC WATER RISER DIAGRAM  
Not to Scale

	THERMOSTAT
	CONTROL CABLE, VERIFY TYPE WITH EQUIPMENT MANUFACTURER
	SQUARE SUPPLY DIFFUSER - TYPE AND AIRFLOW INDICATED
	SQUARE RETURN GRILLE - TYPE INDICATED
	WALL DIFFUSER
	GRILLE/DIFFUSER TAG TOP: DEVICE TAG (SEE SCHEDULE) MIDDLE: NECK SIZE BOTTOM: AIRFLOW
	MANUAL BALANCING DAMPER
	RECTANGULAR RETURN OR RELIEF AIR DUCT UP
	RECTANGULAR RETURN OR RELIEF AIR DUCT UP
	RECTANGULAR SUPPLY AIR DUCT UP
	RECTANGULAR SUPPLY AIR DUCT DOWN
	RECTANGULAR RETURN OR EXHAUST AIR DUCT DOWN
	ROUND DUCT UP
	ROUND DUCT DOWN
	FLEXIBLE DUCTWORK - MAX 5'
	RIGID DUCT RUNOUT
	90° ELBOW WITH TURNING VANES
	VERTICAL FIRE DAMPER
	PIPE TURNING UP
	PIPE TURNING DOWN
	90° ELBOW
	45° ELBOW
	TEE
	TEE UP
	TEE DOWN
	CONDENSATE DRAIN LINE
	SANITARY DRAIN BELOW GRADE
	STORM DRAIN BELOW GRADE
	OVERFLOW DRAIN BELOW GRADE
	SANITARY DRAIN ABOVE GRADE
	STORM DRAIN ABOVE GRADE
	OVERFLOW DRAIN ABOVE GRADE
	SANITARY VENT
	DOMESTIC COLD WATER
	DOMESTIC HOT WATER
	DOMESTIC HOT WATER RECIRC
	WATER SERVICE PIPING
	FIRE PROTECTION PIPING
	UNION
	BALL VALVE
	CHECK VALVE

OA	OUTDOOR AIR
RA	RETURN AIR
SA	SUPPLY AIR
MC	MECHANICAL CONTRACTOR
EC	ELECTRICAL CONTRACTOR
GC	GENERAL CONTRACTOR
AFF	ABOVE FINISHED FLOOR
AFG	ABOVE FINISHED GRADE
BG	BELOW GRADE
FG	FINISHED GRADE
FFCO	FINISH FLOOR CLEAN OUT
FWCO	FINISH WALL CLEAN OUT
FGCO	FINISH GRADE CLEAN OUT
UNO	UNLESS NOTED OTHERWISE



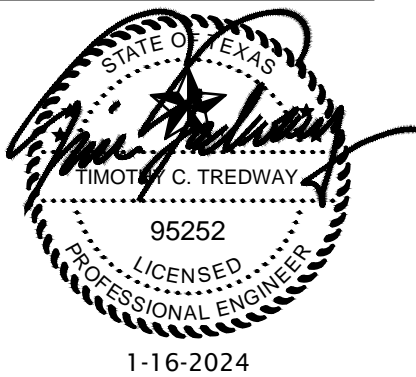


REVISION:

DATE: 1-16-2024  
 JOB: 21-3166  
 SHEET NO.:

E1.0

COPYRIGHTED ©

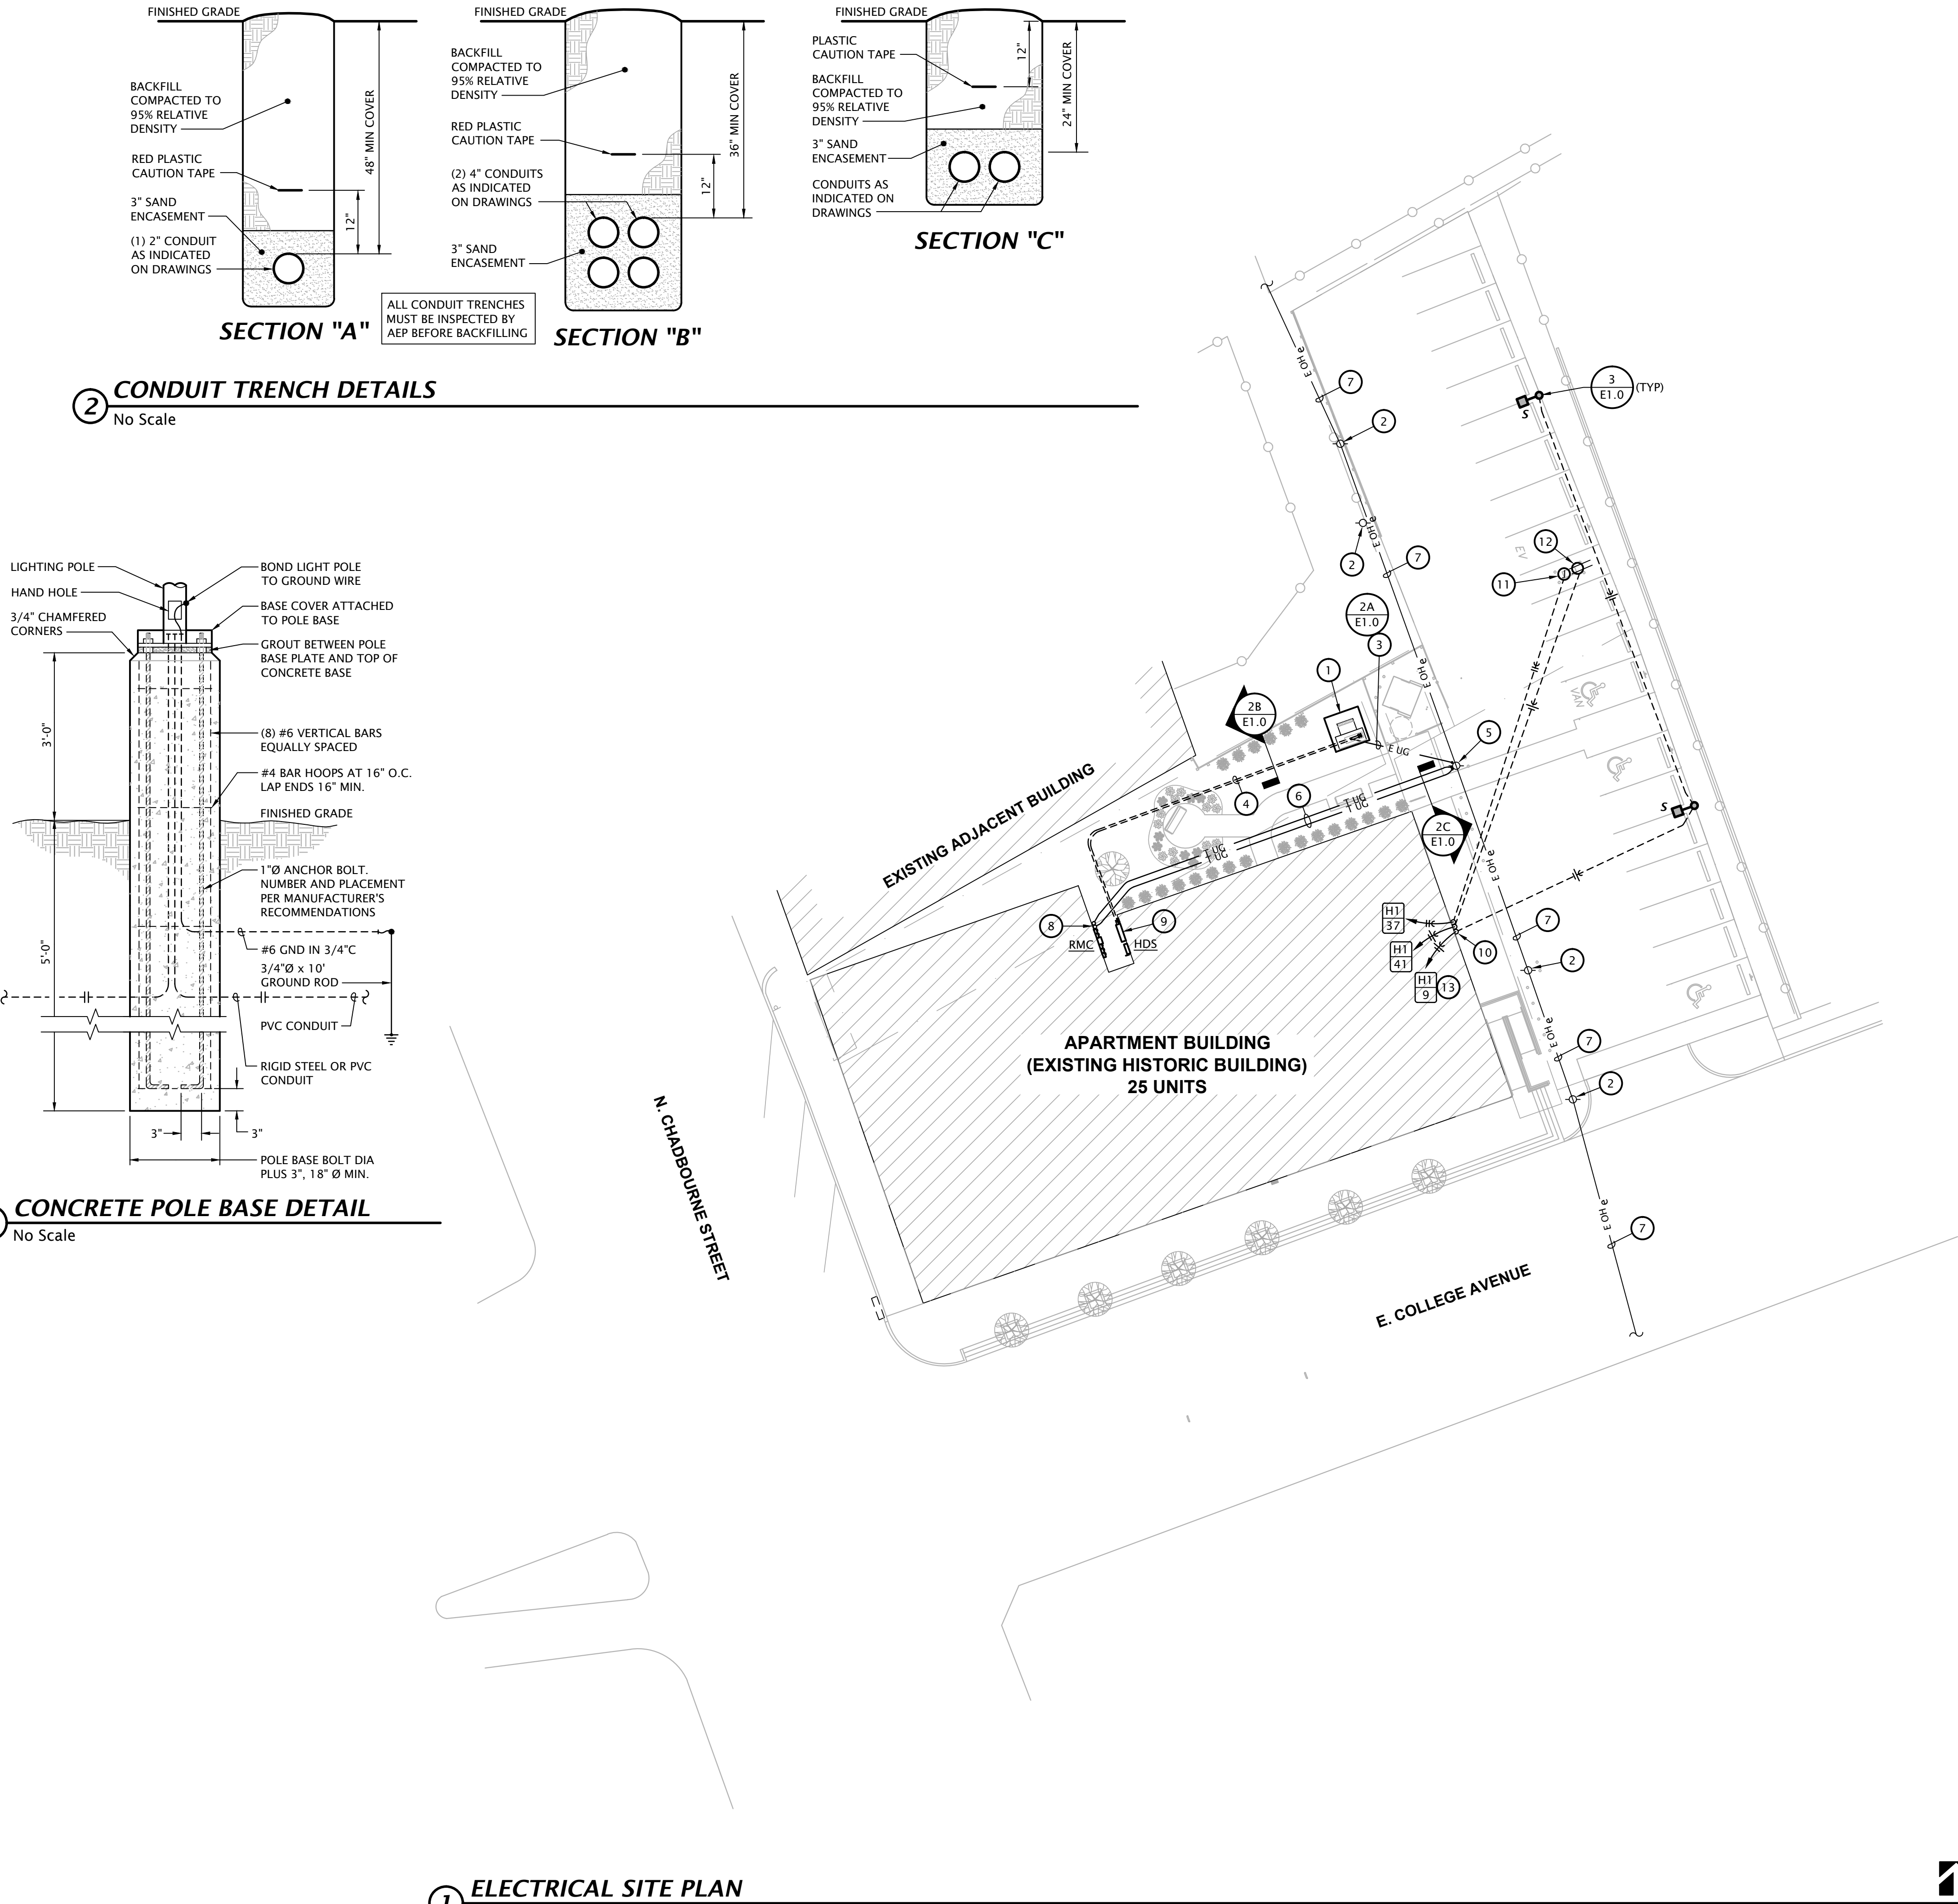

GENERAL SITE POWER NOTES

- CONTRACTOR SHALL BE RESPONSIBLE FOR ALL CONDUIT AND ASSOCIATED TRENCHING AND BACKFILL REQUIRED FOR UNDERGROUND ELECTRICAL UTILITY PRIMARY CABLE. POWER COMPANY SHALL FURNISH, INSTALL, AND TERMINATE ALL CONDUCTORS.
- CONTRACTOR SHALL BE RESPONSIBLE FOR ALL CONDUIT AND ASSOCIATED TRENCHING AND BACKFILL REQUIRED FOR UNDERGROUND ELECTRICAL SERVICE LATERALS FROM UTILITY TRANSFORMERS TO SERVICE EQUIPMENT AT BUILDING EXTERIORS. POWER COMPANY SHALL FURNISH, INSTALL, AND TERMINATE ALL CONDUCTORS.
- ALL CONDUIT BELOW GRADE SHALL BE SCHEDULE 40 PVC. ALL CONDUIT ABOVE GRADE SHALL BE SCHEDULE 80 PVC.
- ALL CONDUIT TRENCHES MUST BE INSPECTED BY AEP BEFORE BACKFILLING.

# ELECTRICAL SITE PLAN NOTES BY SYMBOL

- POWER COMPANY PAD MOUNTED TRANSFORMER. PROVIDE 8' W x 8' L x 6" D CONCRETE PAD PER AEP TEXAS SERVICE STANDARDS. COORDINATE EXACT LOCATION AND REQUIREMENTS WITH AEP TEXAS PRIOR TO COMMENCING WORK.
- EXISTING UTILITY POLE TO REMAIN, SHOWN FOR REFERENCE ONLY.
- 4" CONDUIT WITH PULL ROPE BELOW GRADE FOR POWER COMPANY PROVIDED PRIMARY CABLING. COORDINATE ROUTING WITH AEP TEXAS.
- (4) 4" CONDUITS WITH PULL ROPE BELOW GRADE FOR POWER COMPANY PROVIDED SERVICE LATERAL CABLING. COORDINATE ROUTING WITH AEP TEXAS.
- EXISTING UTILITY POLE TO BE UTILIZED FOR NEW PRIMARY SERVICE DROP. COORDINATE PRIMARY CONDUIT STUB-UP WITH POWER COMPANY.
- (2) 4" CONDUITS BELOW GRADE FOR COMMUNICATIONS SERVICES. PROVIDE PULLSTRING IN EACH RACEWAY.
- EXISTING ELECTRIC UTILITY 3-PHASE OVERHEAD PRIMARY DISTRIBUTION TO REMAIN.
- SEE SHEET E1.7 FOR CONTINUATION INSIDE BUILDING.
- ELECTRICAL UTILITY SERVICE TAP BOX. SEE RISER DIAGRAM, SHEET E6.1.
- PENETRATE EXTERIOR WALL WITH WEATHERPROOF CONDUIT BODIES AS LOW TO GROUND AS POSSIBLE. COORDINATE LOCATION WITH G.C. SEAL WEATHER TIGHT.
- MAKE FINAL CONNECTION TO OWNER PROVIDED SINGLE PORT EV CHARGING STATION EQUIPMENT. VERIFY EXACT REQUIREMENTS WITH MANUFACTURER'S INSTRUCTIONS.
- MOUNT RECEPTACLE ON BOLLARD 18" AFG. COORDINATE EXACT LOCATION AND REQUIREMENTS WITH G.C.
- ROUTE CIRCUIT THROUGH CONTACTOR 'C4', RE: 5/E6.1.

SEE SHEET E1.5 FOR GENERAL ELECTRICAL NOTES.


ELECTRICAL PLAN NOTES BY SYMBOL

- CONNECT EXHAUST FAN PROVIDED BY MECHANICAL CONTRACTOR.
- PROVIDE 30A/2P SNAP SWITCH AND CONNECT WATER HEATER.
- PROVIDE 60A/2P DISCONNECT SWITCH AND CONNECT TO BLOWER COIL WITH ELECTRIC HEAT. SEE EQUIPMENT SCHEDULE FOR MORE INFORMATION. COORDINATE REQUIREMENTS WITH M.C.
- SPLIT-WIRE DUPLEX RECEPTACLE BELOW COUNTER. TOP HALF OF RECEPTACLE TO BE SWITCHED FOR CONTROL OF GARBAGE DISPOSAL. BOTTOM HALF OF RECEPTACLE TO BE WIRED UNSWITCHED FOR DISHWASHER. RECEPTACLE SHALL BE LOCATED IN BACK OF BASE CABINET ADJACENT TO DISHWASHER TO ALLOW ACCESS. PROVIDE CORDS AND GROUNDING PLUGS AS REQUIRED FOR DISPOSER AND DISHWASHER.
- PROVIDE 120V CONNECTION TO MICROWAVE/RANGE HOOD. STANDARD AND ADAPTABLE UNITS WILL HAVE MICROWAVE ABOVE RANGE. ACCESSIBLE UNITS WILL HAVE RANGE HOOD. COORDINATE EXACT ELECTRICAL ROUGH-IN REQUIREMENTS WITH EQUIPMENT PROVIDED. IF EQUIPMENT IS CORD AND PLUG, PROVIDE RECEPTACLE INSIDE CABINET ABOVE RANGE.
- PROVIDE SWITCH IN ACCESSIBLE UNITS FOR CONTROL OF RANGE HOOD.
- IN ACCESSIBLE UNITS, INSTALL COUNTERTOP RECEPTACLES A MINIMUM 36" AWAY FROM CORNER PER FAIR HOUSING ACT DESIGN MANUAL CHAPTER 5 'SIDE REACH OVER AN OBSTRUCTION' REQUIREMENTS. WHERE AN OBSTRUCTION PREVENTS 36" DISTANCE REQUIREMENT, INSTALL RECEPTACLE AS FAR FROM CORNER AS POSSIBLE. PROVIDE ADDITIONAL OUTLETS WITHIN 36" OF CORNER TO ENSURE COMPLIANCE WITH NEC SPACING REQUIREMENTS.
- SWITCH CLOSEST TO DOOR SHALL CONTROL ALL LIGHTS IN BATHROOM, AND THE OTHER SWITCH SHALL CONTROL THE EXHAUST FAN.
- PROVIDE PRESET SLIDE DIMMER COMPATIBLE WITH ASSOCIATED LIGHT FIXTURES.
- PROVIDE TIMER SWITCH EQUAL TO AIR CYCLER 'SMART EXHAUST' FOR CONTROL OF EXHAUST FAN. SET SWITCH PER MANUFACTURER'S INSTRUCTIONS TO OPERATE FAN AS INDICATED BELOW:  
1 BEDROOM: 20 MINUTES PER HOUR  
2 BEDROOM: 35 MINUTES PER HOUR
- ROUTE 120V CIRCUIT FOR HOT WATER RECIRCULATION PUMP (HWP) THROUGH ADJACENT AQUASTAT. PROVIDE 20A/1P SNAP SWITCH ADJACENT TO PUMP AND MAKE FINAL FLEXIBLE CONNECTION. COORDINATE WITH PLUMBING CONTRACTOR.
- CONNECT UNBALANCED PORTION OF WATER HEATER LOAD TO PHASE LEG INDICATED.
- (3) #12, #12G, 1/2" C FROM ASSOCIATED OUTDOOR UNIT ON ROOF. SEE SHEET E1.7.
- 30A/3P MANUAL MOTOR CONTROLLER SNAP SWITCH (WITHOUT OVERLOAD PROTECTION) IN NEMA 1 ENCLOSURE, P&S #7803W OR EQUAL. MOUNT ADJACENT TO UNIT AND MAKE FINAL FLEXIBLE CONNECTION TO EQUIPMENT.
- AT RECEPTACLES ABOVE KITCHEN COUNTERS IN ACCESSIBLE UNITS (#109 & #203, PROVIDE 1" DEEP FLUSH TYPE EXTENSION ADAPTER, WIREMOLD #V5751WH, TO BRING RECEPTACLE CLOSER TO COUNTERTOP EDGE TO COMPLY WITH 24" SIDE REACH REQUIREMENT.
- 30A/2P DISCONNECT SWITCH WITH SOLID NEUTRAL AND (1) 20A DUAL-ELEMENT, TIME DELAY FUSE IN NEMA 1 ENCLOSURE FOR ELEVATOR CAB LIGHTS & EXHAUST. SWITCH SHALL BE CAPABLE OF BEING LOCKED 'OFF' AFF TO TOP AND LABEL WITH CIRCUIT NUMBER. COORDINATE EXACT MOUNTING LOCATION AND REQUIREMENTS WITH ELEVATOR EQUIPMENT INSTALLER. PROVIDE FINAL ELECTRICAL CONNECTION TO INSPECTION AND TEST PANEL (LDU) AT TOP OF 3RD FLOOR WITHIN ELEVATOR DOOR JAMB.
- ELEVATOR POWER MODULE SWITCH: 100A/208V/3P SWITCH COMPLETE WITH 70A DUAL ELEMENT, TIME DELAY CLASS 'J' FUSES, 120V CONTROL TRANSFORMER, FIRE ALARM SAFETY INTERFACE RELAY, KEY TEST SWITCH, GREEN PILOT LIGHT, AUXILIARY CONTACTS FOR ELEVATOR RECALL, AND FIRE ALARM VOLTAGE MONITORING RELAY. COOPER BUSSMAN #PS-1-T20-R1-K-G-B-F1 OR EQUAL. COORDINATE EXACT MOUNTING LOCATION AND REQUIREMENTS WITH ELEVATOR EQUIPMENT INSTALLER.
- 3-PHASE POWER FEEDER AND (2) #18 STRANDED CU CONDUCTORS FROM ELEVATOR POWER MODULE SWITCH TO 'JH1' DISCONNECT SWITCH.
- 100A/3P NON-FUSED DISCONNECT SWITCH (JH1) IN NEMA 1 ENCLOSURE. PROVIDE WITH SPST AUXILIARY CONTACTS RATED FOR MIN 2A AT 24VDC. MAKE FINAL CONNECTION TO ELEVATOR FUSE BOX. COORDINATE MOUNTING LOCATION AT TOP OF HOISTWAY AND REQUIREMENTS WITH ELEVATOR EQUIPMENT INSTALLER.
- INSTALL LIGHT AND RECEPTACLE ON WALL OF ELEVATOR PIT. VERIFY EXACT LOCATION WITH ELEVATOR EQUIPMENT INSTALLER. INSTALL LIGHT SWITCH ADJACENT TO PIT LADDER AT 48" ABOVE FLOOR LANDING.
- INSTALL LIGHT AND RECEPTACLE ON WALL NEAR TOP OF ELEVATOR HOISTWAY. VERIFY EXACT LOCATION WITH ELEVATOR EQUIPMENT INSTALLER. INSTALL LIGHT SWITCH ADJACENT ENTRY AT 48" ABOVE FLOOR LANDING.
- SWITCH EXHAUST FAN WITH ROOM LIGHTS.
- ROUTE CIRCUIT THROUGH CONTACTOR INDICATED. SEE 5/E6.1.
- SIMPLEX RECEPTACLE IN ELEVATOR PIT FOR ELEVATOR SUMP PUMP. COORDINATE EXACT MOUNTING LOCATION WITH PLUMBING CONTRACTOR AND ELEVATOR EQUIPMENT INSTALLER.
- ELEVATOR SUMP PUMP ALARM PANEL IN CLOSET BELOW STAIR LANDING. PROVIDE 120V POWER CONNECTION AND 1" CONDUIT WITH PULL STRING STUBBED INTO ELEVATOR PIT FOR CONTROL CABLING. COORDINATE ALL WORK WITH PLUMBING CONTRACTOR.
- MOUNT LIGHT FIXTURE FOR CLOSET BELOW STAIR LANDING. MOUNT TO STRUCTURE.
- ROUTE DRYER CIRCUIT THROUGH CURRENT SWITCH FOR OPERATION OF OUTSIDE AIR INTAKE HOOD. HOOD DAMPER SHALL OPEN WHEN ANY DRYER IS OPERATING. SEE DETAIL 2/E6.2.
- COORDINATE EXACT MOUNTING LOCATION OF DRINKING FOUNTAIN RECEPTACLE WITH PLUMBING CONTRACTOR.
- PROVIDE 120V POWER CONNECTION TO SEWAGE EJECTOR ALARM PANEL AND SIMPLEX RECEPTACLE FOR POWER TO SEWAGE EJECTOR PUMP. COORDINATE REQUIREMENTS WITH G.C. AND PLUMBING CONTRACTOR.
- PROVIDE DOOR ANNUNCIATOR SYSTEM A/V HORN/STROBE DEVICE AND LOW VOLTAGE TRANSFORMER AT ALL ACCESSIBLE APARTMENTS AND ALSO AT APARTMENTS DESIGNATED HEARING-IMPAIRED. INSTALL HORN/STROBE APPLIANCE AT 80" AFF. INSTALL TRANSFORMER IN DOUBLE GANG JUNCTION BOX ABOVE HORN/STROBE WITH BLANK COVER PLATE AND PROVIDE LOW VOLTAGE CONTROL WIRING. SEE DETAIL 3, SHEET E6.2. PROVIDE ENGRAVED SIGN AT THE HORN/STROBE DEVICE TO READ "DOOR".
- PROVIDE PUSH BUTTON AT 48" AFF FOR ANNUNCIATOR SYSTEM AT ALL ACCESSIBLE APARTMENTS AND ALSO AT APARTMENTS DESIGNATED FOR HEARING-IMPAIRED. REFER TO ARCH DRAWINGS FOR APPLICABLE ROOMS. SEE DETAIL 3, SHEET E6.2.
- IN ADA/ACCESSIBLE UNITS, DISPOSER SWITCH SHALL BE COUNTERTOP MOUNTED, AIR ACTIVATED PUSH BUTTON TYPE, FINISH TO MATCH SINK. COORDINATE EXACT LOCATION OF PUSH BUTTON WITH ARCHITECT.
- RELAY FOR CONTROL OF MOTORIZED INTAKE HOOD ON ROOF. SEE 2/E6.2.
- TIMECLOCK AND CONTACTORS FOR LIGHTING AND RECEPTACLE CONTROL. RE: 5/E6.1.
- 2-HOUR DIAL TIMER OVERRIDE SWITCH FOR SWITCHED RECEPTACLES. SEE 5/E6.1.
- LINE VOLTAGE CEILING OCCUPANCY SENSOR/PHOTOCELL WITH DAYLIGHT HARVESTING CAPABILITY. SENSOR SHALL DIM 0-10V LIGHTS WHEN ADEQUATE DAYLIGHT IS PRESENT. SENSORWORX #SWX-2-3-1-2-D OR EQUAL.
- PRESET SLIDE DIMMER, 0-10V, LEVITON #HP710-DLZ OR EQUAL. COORDINATE DEVICE COLOR WITH ARCHITECT.
- ONE RECEPTACLE SHALL BE CONNECTED TO CIRCUIT #44 (UNCONTROLLED) AND THE OTHER RECEPTACLES SHALL BE CONNECTED TO CIRCUIT #46 (CONTROLLED). CONTROLLED RECEPTACLE SHALL BE MARKED IN ACCORDANCE WITH NEC 406.3(E).

JonesGillamRenz  
730 N. Ninth  
Salina, KS 67401  
785.827.0386  
jgr@jarchitects.com

JGR

ROOSEVELT LOFTS  
HISTORIC REHABILITATION - APARTMENTS  
SAN ANGELO, TEXAS

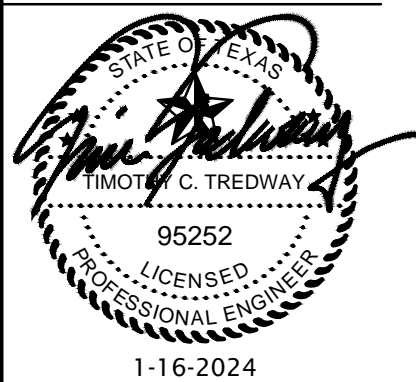

1-16-2024

REVISION:


DATE: 1-16-2024

JOB: 21-3166

SHEET NO.:



E1.1

COPYRIGHTED ©

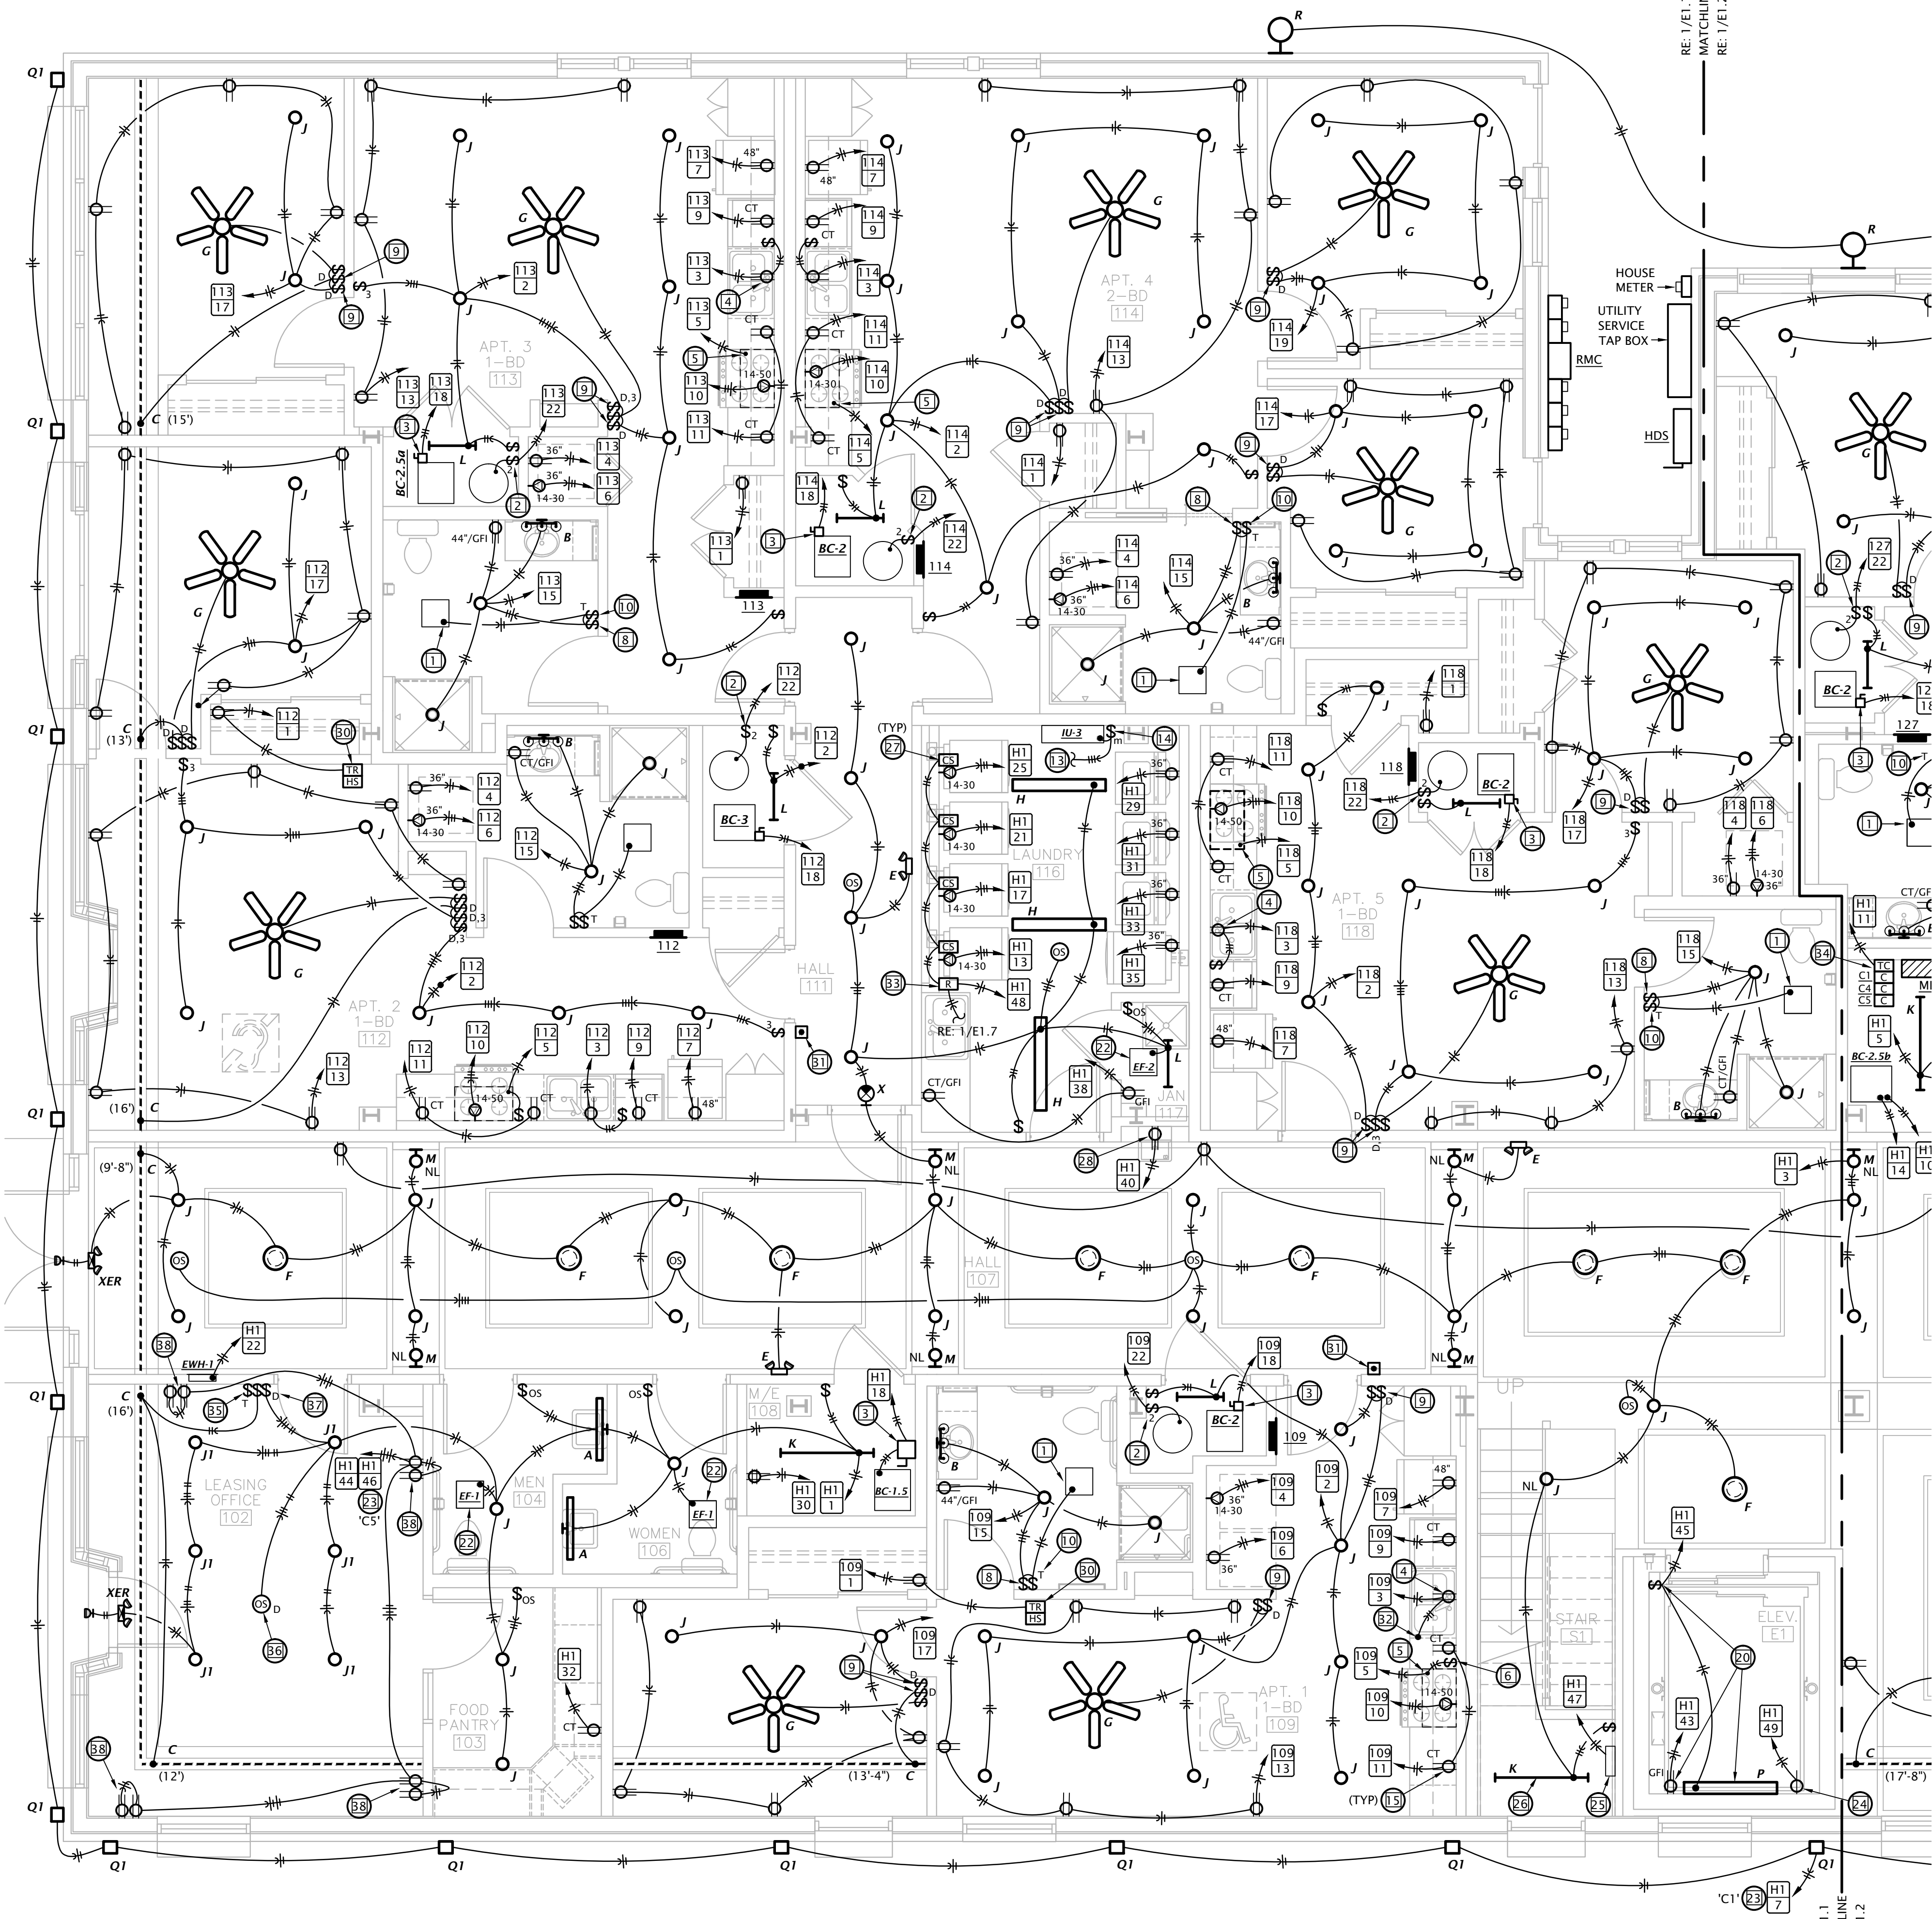


1 PARTIAL FIRST FLOOR ELECTRICAL PLAN  
1/4" = 1'-0"



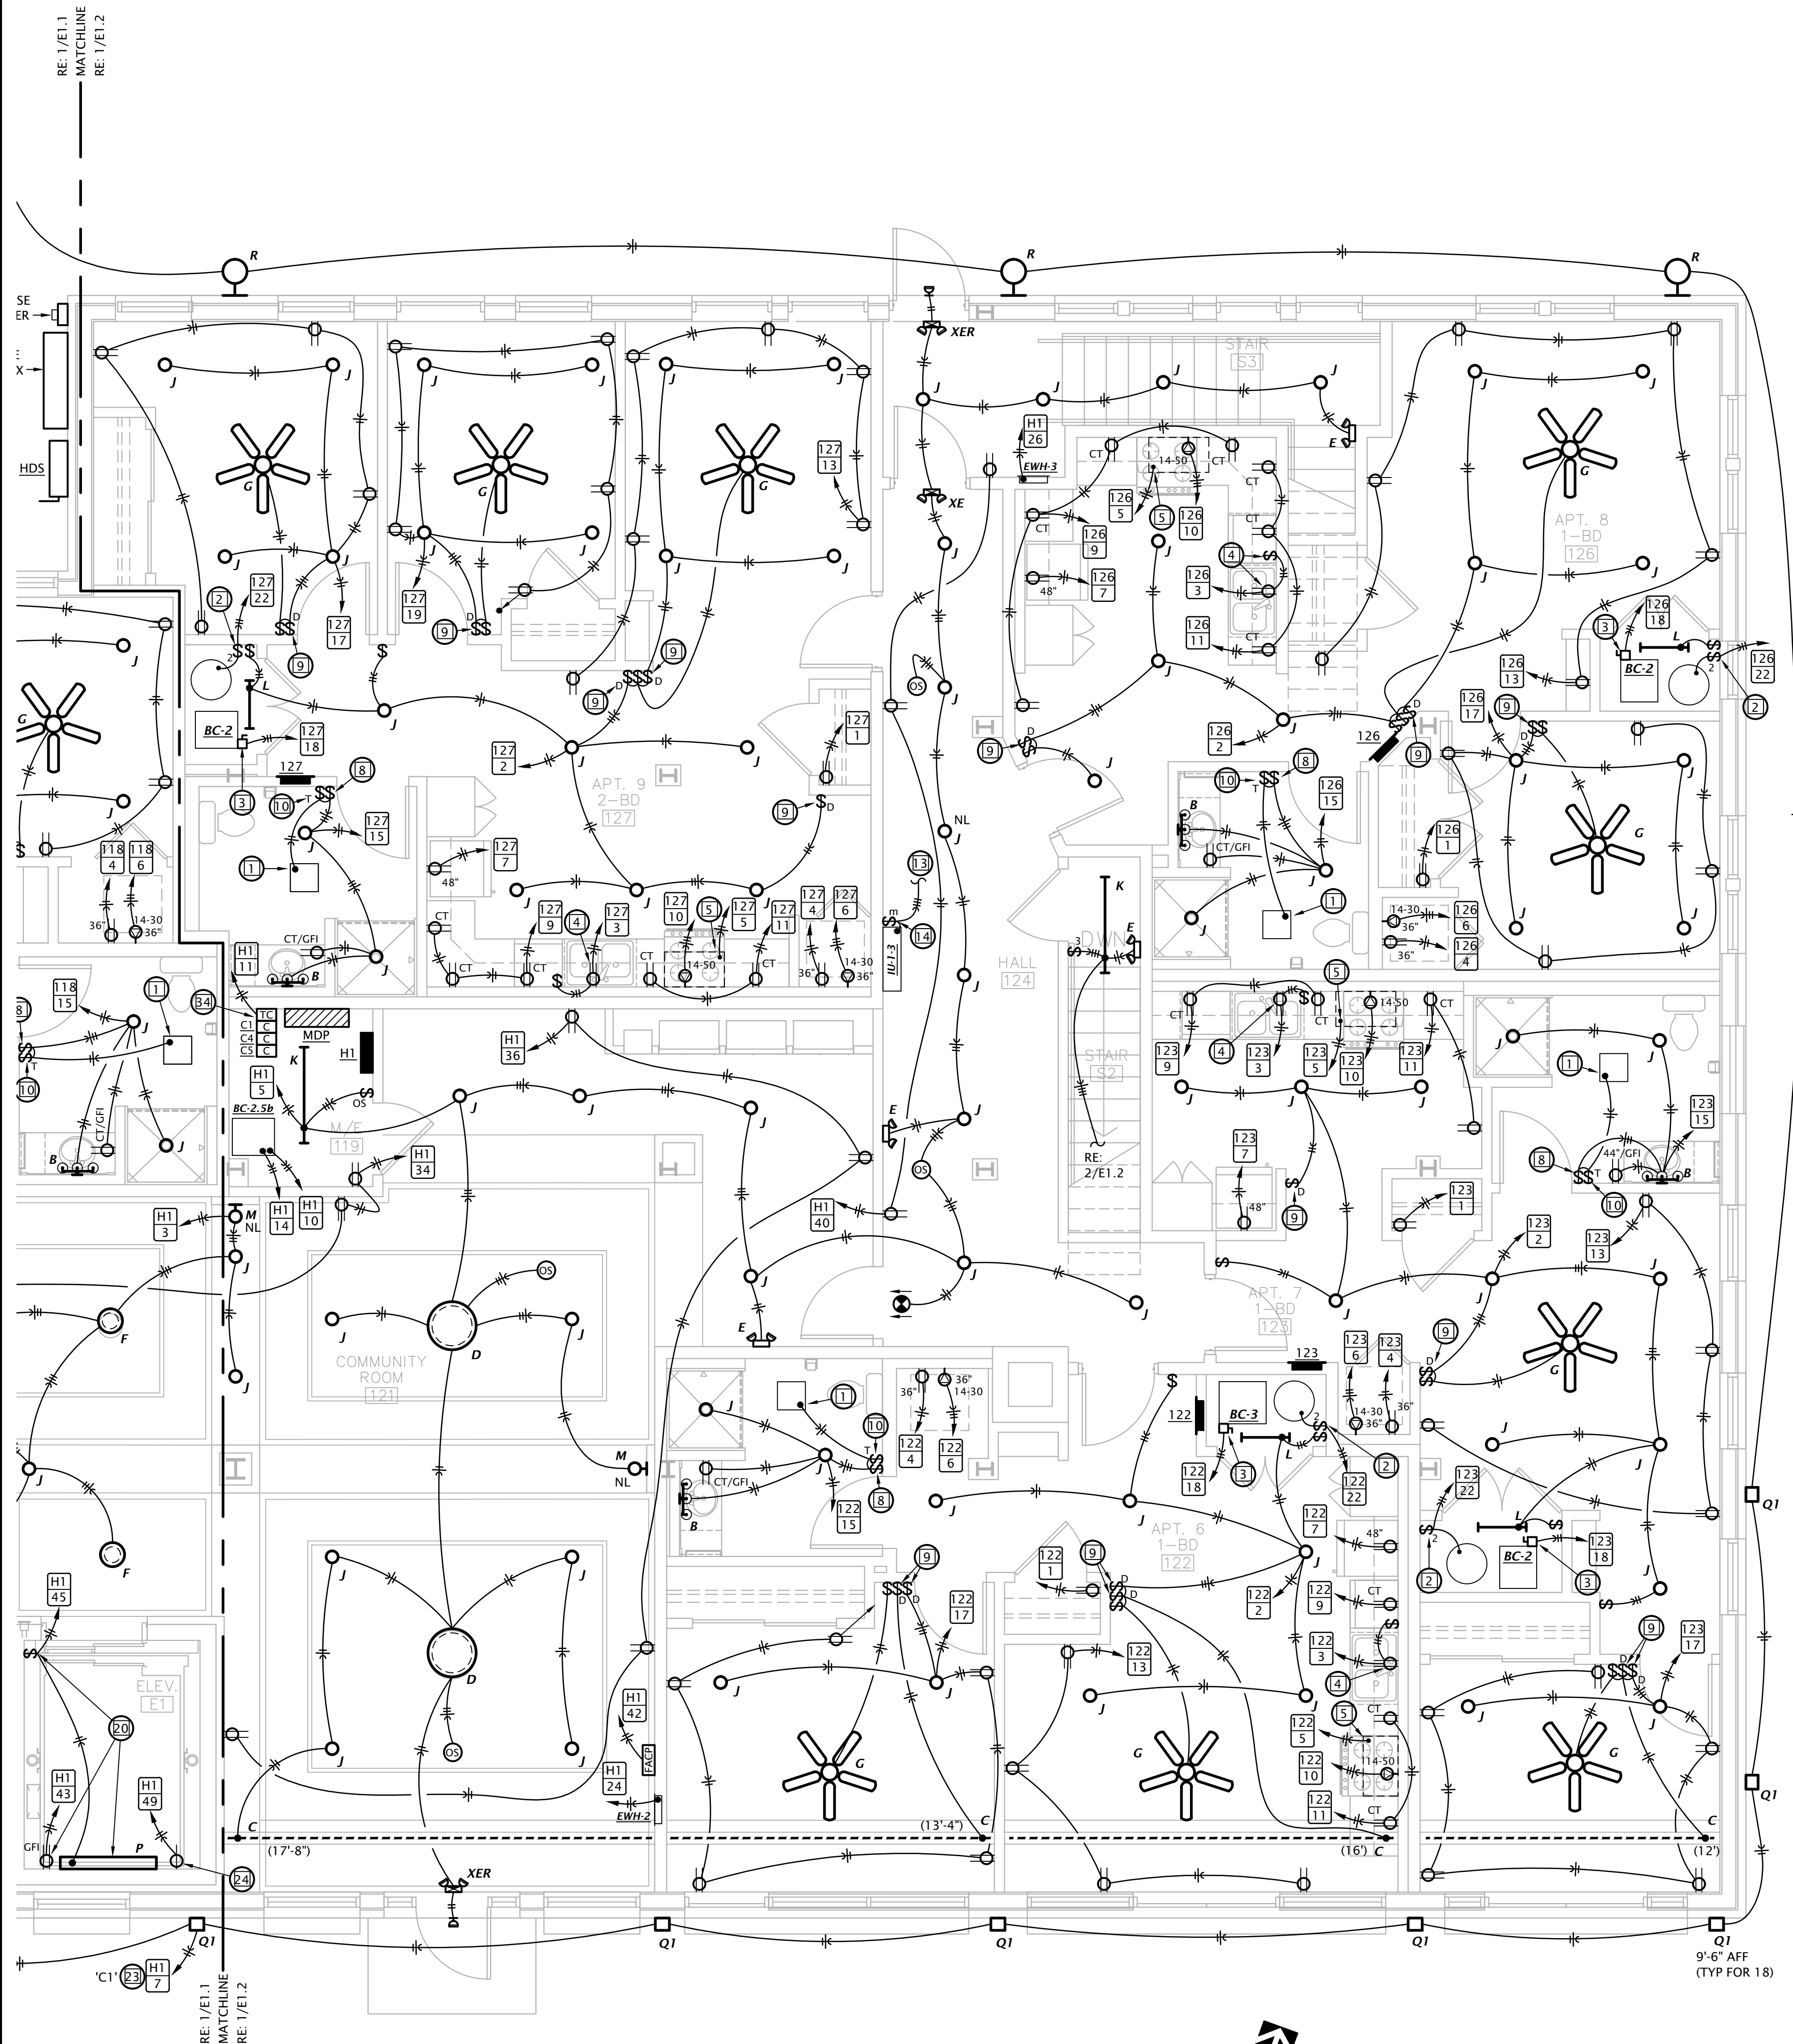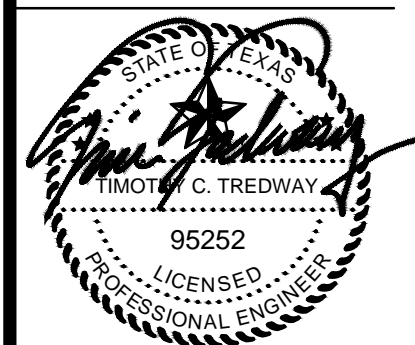

**1 PARTIAL FIRST FLOOR ELECTRICAL PLAN**  
1/4" = 1'-0"

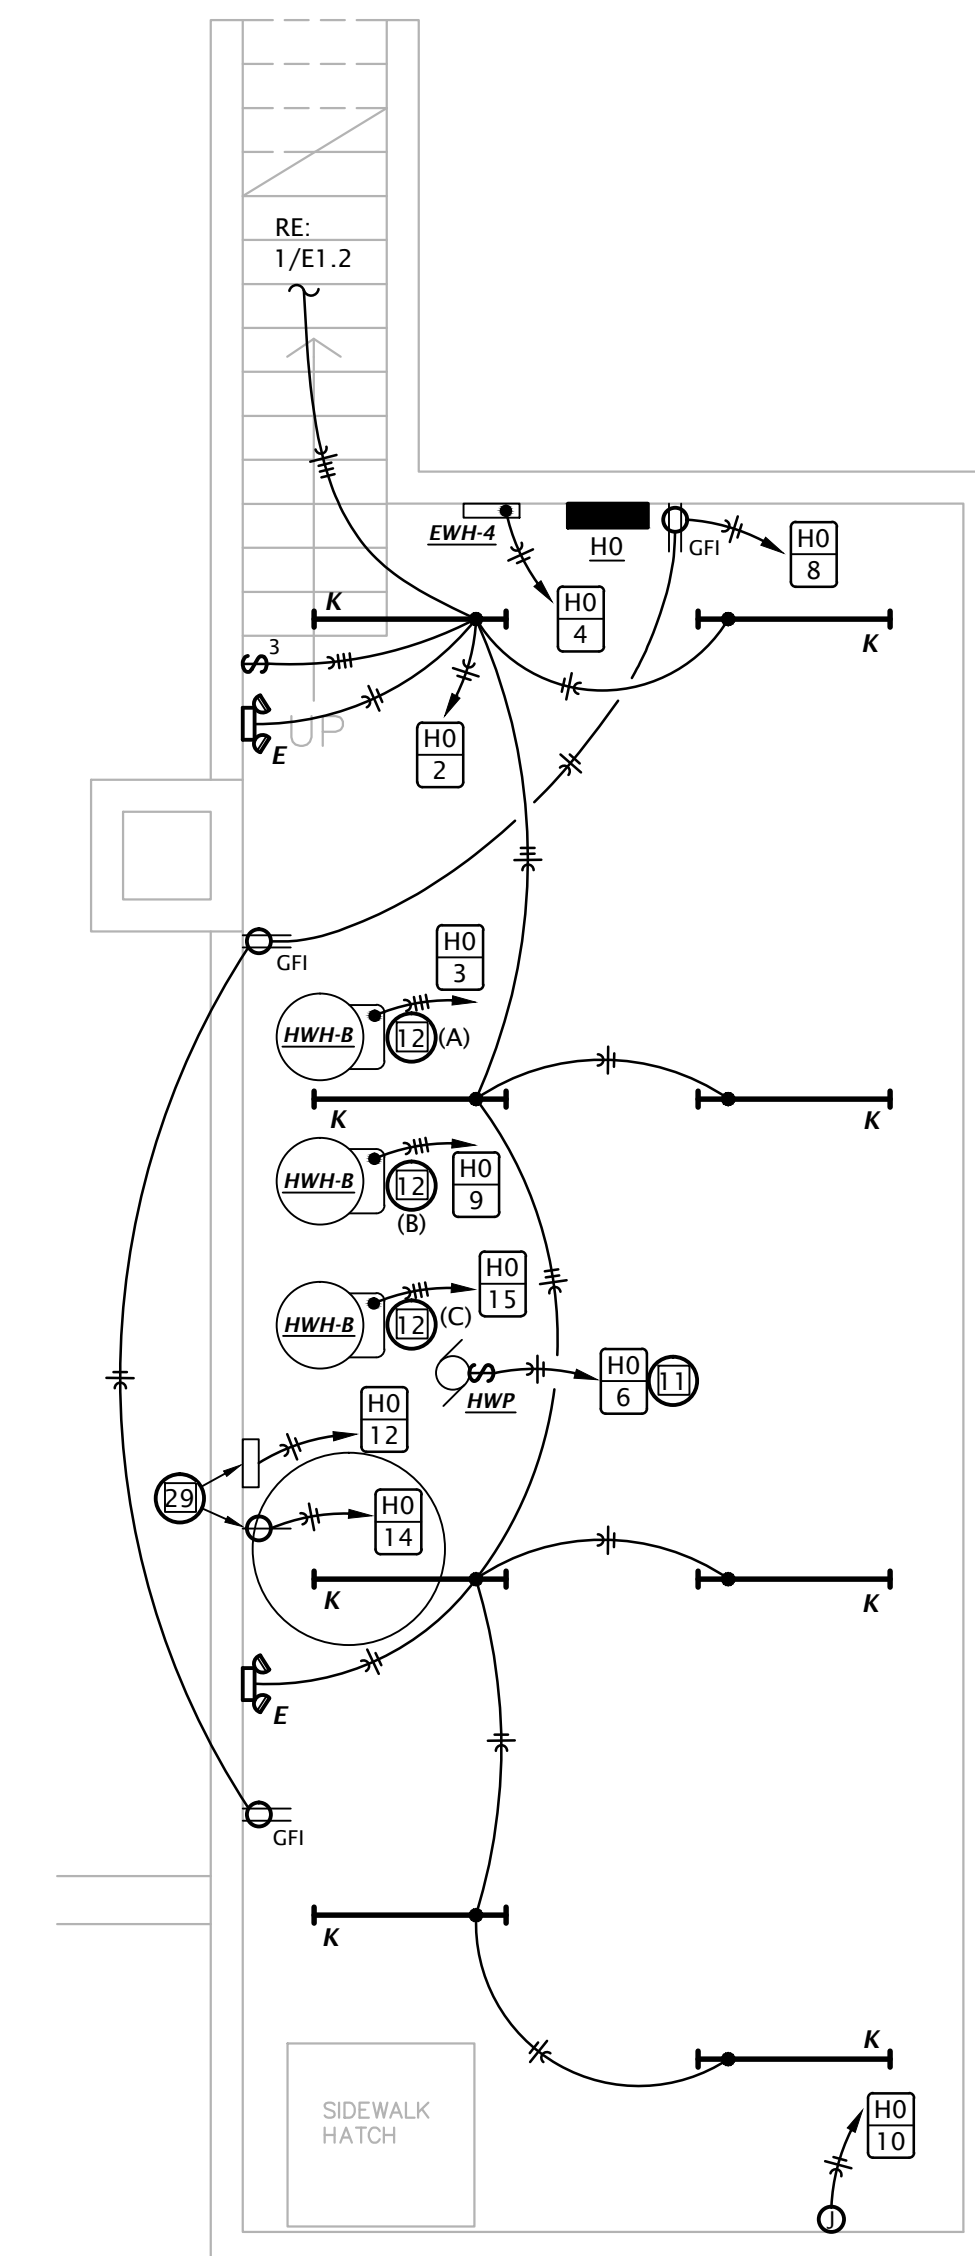

**1 BASEMENT ELECTRICAL PLAN**  
1/4" = 1'-0"

- # ELECTRICAL PLAN NOTES BY SYMBOL
- CONNECT EXHAUST FAN PROVIDED BY MECHANICAL CONTRACTOR.
  - PROVIDE 30A/2P SNAP SWITCH AND CONNECT WATER HEATER.
  - PROVIDE 60A/2P DISCONNECT SWITCH AND CONNECT TO BLOWER COIL WITH ELECTRIC HEAT. SEE EQUIPMENT SCHEDULE FOR MORE INFORMATION. COORDINATE REQUIREMENTS WITH M.C.
  - SPLIT-WIRE DUPLEX RECEPTACLE BELOW COUNTER. TOP HALF OF RECEPTACLE TO BE SWITCHED FOR CONTROL OF GARBAGE DISPOSAL. BOTTOM HALF OF RECEPTACLE TO BE WIRE UNSWITCHED FOR DISHWASHER. RECEPTACLE SHALL BE LOCATED IN BACK OF BASE CABINET ADJACENT TO DISHWASHER TO ALLOW ACCESS. PROVIDE CORDS AND GROUNDING PLUGS AS REQUIRED FOR DISPOSER AND DISHWASHER.
  - PROVIDE 120V CONNECTION TO MICROWAVE/RANGE HOOD. STANDARD AND ADJUSTABLE UNITS WILL HAVE MICROWAVE ABOVE RANGE. ACCESSIBLE UNITS WILL HAVE RANGE HOOD. COORDINATE EXACT ELECTRICAL ROUGH-IN REQUIREMENTS WITH EQUIPMENT PROVIDED. IF EQUIPMENT IS CORD AND PLUG, PROVIDE RECEPTACLE INSIDE CABINET ABOVE RANGE.
  - PROVIDE SWITCH IN ACCESSIBLE UNITS FOR CONTROL OF RANGE HOOD.
  - IN ACCESSIBLE UNITS, INSTALL COUNTERTOP RECEPTACLES A MINIMUM 36" AWAY FROM CORNER PER FAIR HOUSING ACT DESIGN MANUAL CHAPTER 5 "SIDE REACH OVER AN OBSTRUCTION" REQUIREMENTS. WHERE AN OBSTRUCTION PREVENTS 36" DISTANCE REQUIREMENT, INSTALL RECEPTACLE AS FAR FROM CORNER AS POSSIBLE. PROVIDE ADDITIONAL OUTLETS WITHIN 36" OF CORNER TO ENSURE COMPLIANCE WITH NEC SPACING REQUIREMENTS.
  - SWITCH CLOSEST TO DOOR SHALL CONTROL ALL LIGHTS IN BATHROOM, AND THE OTHER SWITCH SHALL CONTROL THE EXHAUST FAN.
  - PROVIDE PRESET SLIDE DIMMER COMPATIBLE WITH ASSOCIATED LIGHT FIXTURES.
  - PROVIDE TIMER SWITCH EQUAL TO AIR CYCLER "SMART EXHAUST" FOR CONTROL OF EXHAUST FAN. SET SWITCH PER MANUFACTURER'S INSTRUCTIONS TO OPERATE FAN AS INDICATED BELOW:  
1 BEDROOM: 20 MINUTES PER HOUR  
2 BEDROOM: 35 MINUTES PER HOUR
  - ROUTE 120V CIRCUIT FOR HOT WATER RECIRCULATION PUMP ("HWP") THROUGH ADJACENT AQUASTAT. PROVIDE 20A/1P SNAP SWITCH ADJACENT TO PUMP AND MAKE FINAL FLEXIBLE CONNECTION. COORDINATE WITH PLUMBING CONTRACTOR.
  - CONNECT UNBALANCED PORTION OF WATER HEATER LOAD TO PHASE LEG INDICATED.
  - (#12, #12G, 1/2" C) FROM ASSOCIATED OUTDOOR UNIT ON ROOF. SEE SHEET E1.7.
  - 30A/3P MANUAL MOTOR CONTROLLER SNAP SWITCH (WITHOUT OVERLOAD PROTECTION) IN NEMA 1 ENCLOSURE, P65 #7830V OR EQUAL. MOUNT ADJACENT TO UNIT AND MAKE FINAL FLEXIBLE CONNECTION TO EQUIPMENT.
  - AT RECEPTABLES ABOVE KITCHEN COUNTERS IN ACCESSIBLE UNITS (#109 & #203, PROVIDE 1" DEEP FLUSH TYPE EXTENSION ADAPTER, WIREMOLD #V5751WH, TO BRING RECEPTACLE CLOSER TO COUNTERTOP EDGE TO COMPLY WITH 24" SIDE REACH REQUIREMENT.
  - 30A/2P DISCONNECT SWITCH WITH SOLID NEUTRAL AND (1) 20A DUAL-ELEMENT, TIME TRIP TYPE B NEMA 1 ENCLOSURE FOR ELEVATOR CAB LIGHTS & EXHAUST. SWITCH SHALL BE CAPABLE OF BEING LOCKED "OFF". MOUNT AT 6'-0" AFF TO TOP AND LABEL WITH CIRCUIT NUMBER. COORDINATE EXACT MOUNTING LOCATION AND REQUIREMENTS WITH ELEVATOR EQUIPMENT INSTALLER. PROVIDE FINAL ELECTRICAL CONNECTION TO INSPECTION AND TEST PANEL (LJU) AT TOP OF 3RD FLOOR WITHIN ELEVATOR DOOR JAMB.
  - ELEVATOR POWER MODULE SWITCH: 100A/208V/3P SWITCH COMPLETE WITH 70A DUAL ELEMENT, TIME DELAY CLASS 5 FUSES, 120V CONTROL TRANSFORMER, FIRE ALARM SAFETY INTERFACE RELAY, KEY TEST SWITCH, GREEN PILOT LIGHT, AUXILIARY CONTACTS FOR ELEVATOR RECALL, AND FIRE ALARM VOLTAGE MONITORING RELAY. REFER TO ELEVATOR MANUFACTURER'S INSTRUCTIONS FOR WIRING. COORDINATE EXACT MOUNTING LOCATION AND REQUIREMENTS WITH ELEVATOR EQUIPMENT INSTALLER.
  - 3-PHASE POWER FEEDER AND (2) #18 STRANDED CU CONDUCTORS FROM ELEVATOR POWER MODULE SWITCH TO JH11 DISCONNECT SWITCH.
  - 100A/3P NON-FUSED DISCONNECT SWITCH (JH11) IN NEMA 1 ENCLOSURE. PROVIDE WITH FIRST AUXILIARY CONTACTS AND TEST FOR M1-A AND 24VDC. MAKE FINAL CONNECTION TO ELEVATOR FUSE BOX #8-F1 OR EQUAL. COORDINATE EXACT MOUNTING LOCATION AND REQUIREMENTS WITH ELEVATOR EQUIPMENT INSTALLER.
  - INSTALL LIGHT AND RECEPTACLE ON WALL OF ELEVATOR PIT. VERIFY EXACT LOCATION WITH ELEVATOR EQUIPMENT INSTALLER. INSTALL LIGHT SWITCH ADJACENT TO PIT LADDER AT 48" ABOVE FLOOR LANDING.
  - INSTALL LIGHT AND RECEPTACLE ON WALL NEAR TOP OF ELEVATOR HOISTWAY. VERIFY EXACT LOCATION WITH ELEVATOR EQUIPMENT INSTALLER. INSTALL LIGHT SWITCH ADJACENT ENTRY AT 48" ABOVE FLOOR LANDING.
  - SWITCH EXHAUST FAN WITH ROOM LIGHTS.
  - ROUTE CIRCUIT THROUGH CONTRACTOR INDICATED. SEE 5/E6.1.
  - SIMPLEX RECEPTACLE IN ELEVATOR PIT FOR ELEVATOR SUMP PUMP. COORDINATE EXACT MOUNTING LOCATION WITH PLUMBING CONTRACTOR AND ELEVATOR EQUIPMENT INSTALLER.
  - ELEVATOR SUMP PUMP ALARM PANEL IN CLOSET BELOW STAIR LANDING. PROVIDE 120V POWER CONNECTION AND 1" CONDUIT WITH PULL STRING STUBBED INTO ELEVATOR PIT FOR CONTRACTOR CABLING. COORDINATE ALL WORK WITH PLUMBING CONTRACTOR.
  - MOUNT LIGHT FIXTURE FOR CLOSET BELOW STAIR LANDING. MOUNT TO STRUCTURE.
  - ROUTE DRYER CIRCUIT THROUGH CURRENT SWITCH FOR OPERATION OF OUTSIDE AIR INTAKE HOOD. HOOD DAMPER SHALL OPEN WHEN ANY DRYER IS OPERATING. SEE DETAIL 2/E6.2.
  - COORDINATE EXACT MOUNTING LOCATION OF DRINKING FOUNTAIN RECEPTACLE WITH PLUMBING CONTRACTOR.
  - PROVIDE 120V POWER CONNECTION TO SEWAGE EJECTOR ALARM PANEL AND SIMPLEX RECEPTACLE FOR POWER TO SEWAGE EJECTOR PUMP. COORDINATE REQUIREMENTS WITH G.C. AND PLUMBING CONTRACTOR.
  - PROVIDE DOR ANNUNCIATOR SYSTEM A/V HORN/STROBE DEVICE AND LOW VOLTAGE TRANSFORMER AT ALL ACCESSIBLE APARTMENTS AND ALSO AT APARTMENTS DESIGNATED HEARING-IMPAIRED. INSTALL HORN/STROBE APPLIANCE AT 80" AFF. INSTALLED TRANSFORMER IN DOUBLE GANG JUNCTION BOX ABOVE HORN/STROBE WITH BLANK COVER PLATE AND PROVIDE LOW VOLTAGE CABLE CORD WIRING. SEE DETAIL 3, SHEET E6.2. PROVIDE ENGRAVED SIGN AT THE HORN/STROBE DEVICE TO READ "DOR".
  - PROVIDE PUSH BUTTON AT 48" AFF FOR ANNUNCIATOR SYSTEM AT ALL ACCESSIBLE APARTMENTS AND ALSO AT APARTMENTS DESIGNATED FOR HEARING-IMPAIRED. REFER TO ARCH DRAWINGS FOR APPLICABLE ROOMS. SEE DETAIL 3, SHEET E6.2.
  - IN ADA/ACCESSIBLE UNITS, DISPOSER SWITCH SHALL BE COUNTERTOP MOUNTED, AIR ACTIVATED PUSH BUTTON TYPE, FINISH TO MATCH SINK. COORDINATE EXACT LOCATION OF PUSH BUTTON WITH ARCHITECT.
  - RELAY FOR CONTROL OF MOTORIZED INTAKE HOOD ON ROOF. SEE 2/E6.2.
  - TIME-LOCK AND CONTACTORS FOR LIGHTING AND RECEPTACLE CONTROL. RE: 5/E6.1.
  - 2-HOUR DIAL TIMER OVERRIDE SWITCH FOR SWITCHED RECEPTABLES. SEE 5/E6.1.
  - LINE VOLTAGE CEILING OCCUPANCY SENSOR/PHOTOCELL WITH DAYLIGHT HARVESTING CAPABILITY. SENSING SHALL DIM 0-10V LIGHTS WHEN ADEQUATE DAYLIGHT IS PRESENT. SENSORWORM #SWX-2-3-1-2-0 OR EQUAL.
  - PRESET SLIDE DIMMER, 0-10V, LEVITON #P710-DLZ OR EQUAL. COORDINATE DEVICE COLOR WITH ARCHITECT.
  - ONE RECEPTACLE SHALL BE CONNECTED TO CIRCUIT #44 (UNCONTROLLED) AND THE OTHER RECEPTABLES SHALL BE CONNECTED TO CIRCUIT #46 (CONTROLLED). CONTROLLED RECEPTACLE SHALL BE MARKED IN ACCORDANCE WITH NEC 406.3(B).



1 PARTIAL SECOND FLOOR ELECTRICAL PLAN  
1/4" = 1'-0"

SEE SHEET E1.5 FOR GENERAL ELECTRICAL NOTES.

ELECTRICAL PLAN NOTES BY SYMBOL

- CONNECT EXHAUST FAN PROVIDED BY MECHANICAL CONTRACTOR.
- PROVIDE 30A/2P SNAP SWITCH AND CONNECT WATER HEATER.
- PROVIDE 60A/2P DISCONNECT SWITCH AND CONNECT TO BLOWER COIL WITH ELECTRIC HEAT. SEE EQUIPMENT SCHEDULE FOR MORE INFORMATION. COORDINATE REQUIREMENTS WITH M.C.
- SPLIT-WIRE DUPLEX RECEPTACLE BELOW COUNTER. TOP HALF OF RECEPTACLE TO BE SWITCHED FOR CONTROL OF GARBAGE DISPOSAL. BOTTOM HALF OF RECEPTACLE TO BE WIRED UNSWITCHED FOR DISHWASHER. RECEPTACLE SHALL BE LOCATED IN BACK OF BASE CABINET ADJACENT TO DISHWASHER TO ALLOW ACCESS. PROVIDE CORDS AND GROUNDING PLUGS AS REQUIRED FOR DISPOSER AND DISHWASHER.
- PROVIDE 120V CONNECTION TO MICROWAVE/RANGE HOOD. STANDARD AND ADAPTABLE UNITS WILL HAVE MICROWAVE ABOVE RANGE. ACCESSIBLE UNITS WILL HAVE RANGE HOOD. COORDINATE EXACT ELECTRICAL ROUGH-IN REQUIREMENTS WITH EQUIPMENT PROVIDED. IF EQUIPMENT IS CORD AND PLUG, PROVIDE RECEPTACLE INSIDE CABINET ABOVE RANGE.
- PROVIDE SWITCH IN ACCESSIBLE UNITS FOR CONTROL OF RANGE HOOD.
- IN ACCESSIBLE UNITS, INSTALL COUNTERTOP RECEPTACLES A MINIMUM 36" AWAY FROM CORNER PER FAIR HOUSING ACT DESIGN MANUAL CHAPTER 5 'SIDE REACH OVER AN OBSTRUCTION' REQUIREMENTS. WHERE AN OBSTRUCTION PREVENTS 36" DISTANCE REQUIREMENT, INSTALL RECEPTACLE AS FAR FROM CORNER AS POSSIBLE. PROVIDE ADDITIONAL OUTLETS WITHIN 36" OF CORNER TO ENSURE COMPLIANCE WITH NEC SPACING REQUIREMENTS.
- SWITCH CLOSEST TO DOOR SHALL CONTROL ALL LIGHTS IN BATHROOM, AND THE OTHER SWITCH SHALL CONTROL THE EXHAUST FAN.
- PROVIDE PRESET SLIDE DIMMER COMPATIBLE WITH ASSOCIATED LIGHT FIXTURES.
- PROVIDE TIMER SWITCH EQUAL TO AIR CYCLER 'SMART EXHAUST' FOR CONTROL OF EXHAUST FAN. SET SWITCH PER MANUFACTURER'S INSTRUCTIONS TO OPERATE FAN AS INDICATED BELOW:  
1 BEDROOM: 20 MINUTES PER HOUR  
2 BEDROOM: 35 MINUTES PER HOUR
- ROUTE 120V CIRCUIT FOR HOT WATER RECIRCULATION PUMP (HWRP) THROUGH ADJACENT AQUASTAT. PROVIDE 20A/1P SNAP SWITCH ADJACENT TO PUMP AND MAKE FINAL FLEXIBLE CONNECTION. COORDINATE WITH PLUMBING CONTRACTOR.
- CONNECT UNBALANCED PORTION OF WATER HEATER LOAD TO PHASE LEG INDICATED.
- (3) #12, 1/2" C FROM ASSOCIATED OUTDOOR UNIT ON ROOF. SEE SHEET E1.7.
- 30A/3P MANUAL MOTOR CONTROLLER SNAP SWITCH (WITHOUT OVERLOAD PROTECTION) IN NEMA 1 ENCLOSURE, P&S #7803W OR EQUAL. MOUNT ADJACENT TO UNIT AND MAKE FINAL FLEXIBLE CONNECTION TO EQUIPMENT.
- AT RECEPTACLES ABOVE KITCHEN COUNTERS IN ACCESSIBLE UNITS (#109 & #203, PROVIDE 1" DEEP FLUSH TYPE EXTENSION ADAPTER, WIREMOLD #V5751WH, TO BRING RECEPTACLE CLOSER TO COUNTERTOP EDGE TO COMPLY WITH 24" SIDE REACH REQUIREMENT.
- 30A/2P DISCONNECT SWITCH WITH SOLID NEUTRAL AND (1) 20A DUAL-ELEMENT, TIME DELAY FUSE IN NEMA 1 ENCLOSURE FOR ELEVATOR CAB LIGHTS & EXHAUST. SWITCH SHALL BE CAPABLE OF BEING LOCKED 'OFF'. MOUNT AT 6'-0" AFF TO TOP AND LABEL WITH CIRCUIT NUMBER. COORDINATE EXACT MOUNTING LOCATION AND REQUIREMENTS WITH ELEVATOR EQUIPMENT INSTALLER. PROVIDE FINAL ELECTRICAL CONNECTION TO INSPECTION AND TEST PANEL (LDU) AT TOP OF 3RD FLOOR WITHIN ELEVATOR DOOR JAMB.
- ELEVATOR POWER MODULE SWITCH: 100A/208V/3P SWITCH COMPLETE WITH 70A DUAL ELEMENT, TIME DELAY CLASS 'J' FUSES, 120V CONTROL TRANSFORMER, FIRE ALARM SAFETY INTERFACE RELAY, KEY TEST SWITCH, GREEN PILOT LIGHT, AUXILIARY CONTACTS FOR ELEVATOR RECALL, AND FIRE ALARM VOLTAGE MONITORING RELAY. COOPER BUSSMAN #PS-1-T20-R1-K-G-B-F1 OR EQUAL. COORDINATE EXACT MOUNTING LOCATION AND REQUIREMENTS WITH ELEVATOR EQUIPMENT INSTALLER.
- 3-PHASE POWER FEEDER AND (2) #18 STRANDED CU CONDUCTORS FROM ELEVATOR POWER MODULE SWITCH TO 'JH1' DISCONNECT SWITCH.
- 100A/3P NON-FUSED DISCONNECT SWITCH (JH1) IN NEMA 1 ENCLOSURE. PROVIDE WITH SPST AUXILIARY CONTACTS RATED FOR MIN 2A AT 24VDC. MAKE FINAL CONNECTION TO ELEVATOR FUSE BOX. COORDINATE MOUNTING LOCATION AT TOP OF HOISTWAY AND REQUIREMENTS WITH ELEVATOR EQUIPMENT INSTALLER.
- INSTALL LIGHT AND RECEPTACLE ON WALL OF ELEVATOR PIT. VERIFY EXACT LOCATION WITH ELEVATOR EQUIPMENT INSTALLER. INSTALL LIGHT SWITCH ADJACENT TO PIT LADDER AT 48" ABOVE FLOOR LANDING.
- INSTALL LIGHT AND RECEPTACLE ON WALL NEAR TOP OF ELEVATOR HOISTWAY. VERIFY EXACT LOCATION WITH ELEVATOR EQUIPMENT INSTALLER. INSTALL LIGHT SWITCH ADJACENT ENTRY AT 48" ABOVE FLOOR LANDING.
- SWITCH EXHAUST FAN WITH ROOM LIGHTS.
- ROUTE CIRCUIT THROUGH CONTACTOR INDICATED. SEE 5/E6.1.
- SIMPLEX RECEPTACLE IN ELEVATOR PIT FOR ELEVATOR SUMP PUMP. COORDINATE EXACT MOUNTING LOCATION WITH PLUMBING CONTRACTOR AND ELEVATOR EQUIPMENT INSTALLER.
- ELEVATOR SUMP PUMP ALARM PANEL IN CLOSET BELOW STAIR LANDING. PROVIDE 120V POWER CONNECTION AND 1" CONDUIT WITH PULL STRING STUBBED INTO ELEVATOR PIT FOR CONTROL CABLING. COORDINATE ALL WORK WITH PLUMBING CONTRACTOR.
- MOUNT LIGHT FIXTURE FOR CLOSET BELOW STAIR LANDING. MOUNT TO STRUCTURE.
- ROUTE DRYER CIRCUIT THROUGH CURRENT SWITCH FOR OPERATION OF OUTSIDE AIR INTAKE HOOD. HOOD DAMPER SHALL OPEN WHEN ANY DRYER IS OPERATING. SEE DETAIL 2/E6.2.
- COORDINATE EXACT MOUNTING LOCATION OF DRINKING FOUNTAIN RECEPTACLE WITH PLUMBING CONTRACTOR.
- PROVIDE 120V POWER CONNECTION TO SEWAGE EJECTOR ALARM PANEL AND SIMPLEX RECEPTACLE FOR POWER TO SEWAGE EJECTOR PUMP. COORDINATE REQUIREMENTS WITH G.C. AND PLUMBING CONTRACTOR.
- PROVIDE DOOR ANNUNCIATOR SYSTEM A/V HORN/STROBE DEVICE AND LOW VOLTAGE TRANSFORMER AT ALL ACCESSIBLE APARTMENTS AND ALSO AT APARTMENTS DESIGNATED HEARING-IMPAIRED. INSTALL HORN/STROBE APPLIANCE AT 80" AFF. INSTALL TRANSFORMER IN DOUBLE GANG JUNCTION BOX ABOVE HORN/STROBE WITH BLANK COVER PLATE AND PROVIDE LOW VOLTAGE CONTROL WIRING. SEE DETAIL 3, SHEET E6.2. PROVIDE ENGRAVED SIGN AT THE HORN/STROBE DEVICE TO READ "DOOR".
- PROVIDE PUSH BUTTON AT 48" AFF FOR ANNUNCIATOR SYSTEM AT ALL ACCESSIBLE APARTMENTS AND ALSO AT APARTMENTS DESIGNATED FOR HEARING-IMPAIRED. REFER TO ARCH DRAWINGS FOR APPLICABLE ROOMS. SEE DETAIL 3, SHEET E6.2.
- RELAY FOR CONTROL OF MOTORIZED INTAKE HOOD ON ROOF. SEE 2/E6.2.
- TIMECLOCK AND CONTACTORS FOR LIGHTING AND RECEPTACLE CONTROL. RE: 5/E6.1.
- 2-HOUR DIAL TIMER OVERRIDE SWITCH FOR SWITCHED RECEPTACLES. SEE 5/E6.1.
- LINE VOLTAGE CEILING OCCUPANCY SENSOR/PHOTOCELL WITH DAYLIGHT HARVESTING CAPABILITY. SENSOR SHALL DIM 0-10V LIGHTS WHEN ADEQUATE DAYLIGHT IS PRESENT. SENSORWORX #5WX-2-3-1-2-D OR EQUAL.
- PRESET SLIDE DIMMER, 0-10V, LEVITON #P710-DLZ OR EQUAL. COORDINATE DEVICE COLOR WITH ARCHITECT.
- ONE RECEPTACLE SHALL BE CONNECTED TO CIRCUIT #44 (UNCONTROLLED) AND THE OTHER RECEPTACLES SHALL BE CONNECTED TO CIRCUIT #46 (CONTROLLED). CONTROLLED RECEPTACLE SHALL BE MARKED IN ACCORDANCE WITH NEC 406.3(E).




REVISION:

DATE: 1-16-2024

JOB: 21-3166

SHEET NO.:

E1.3

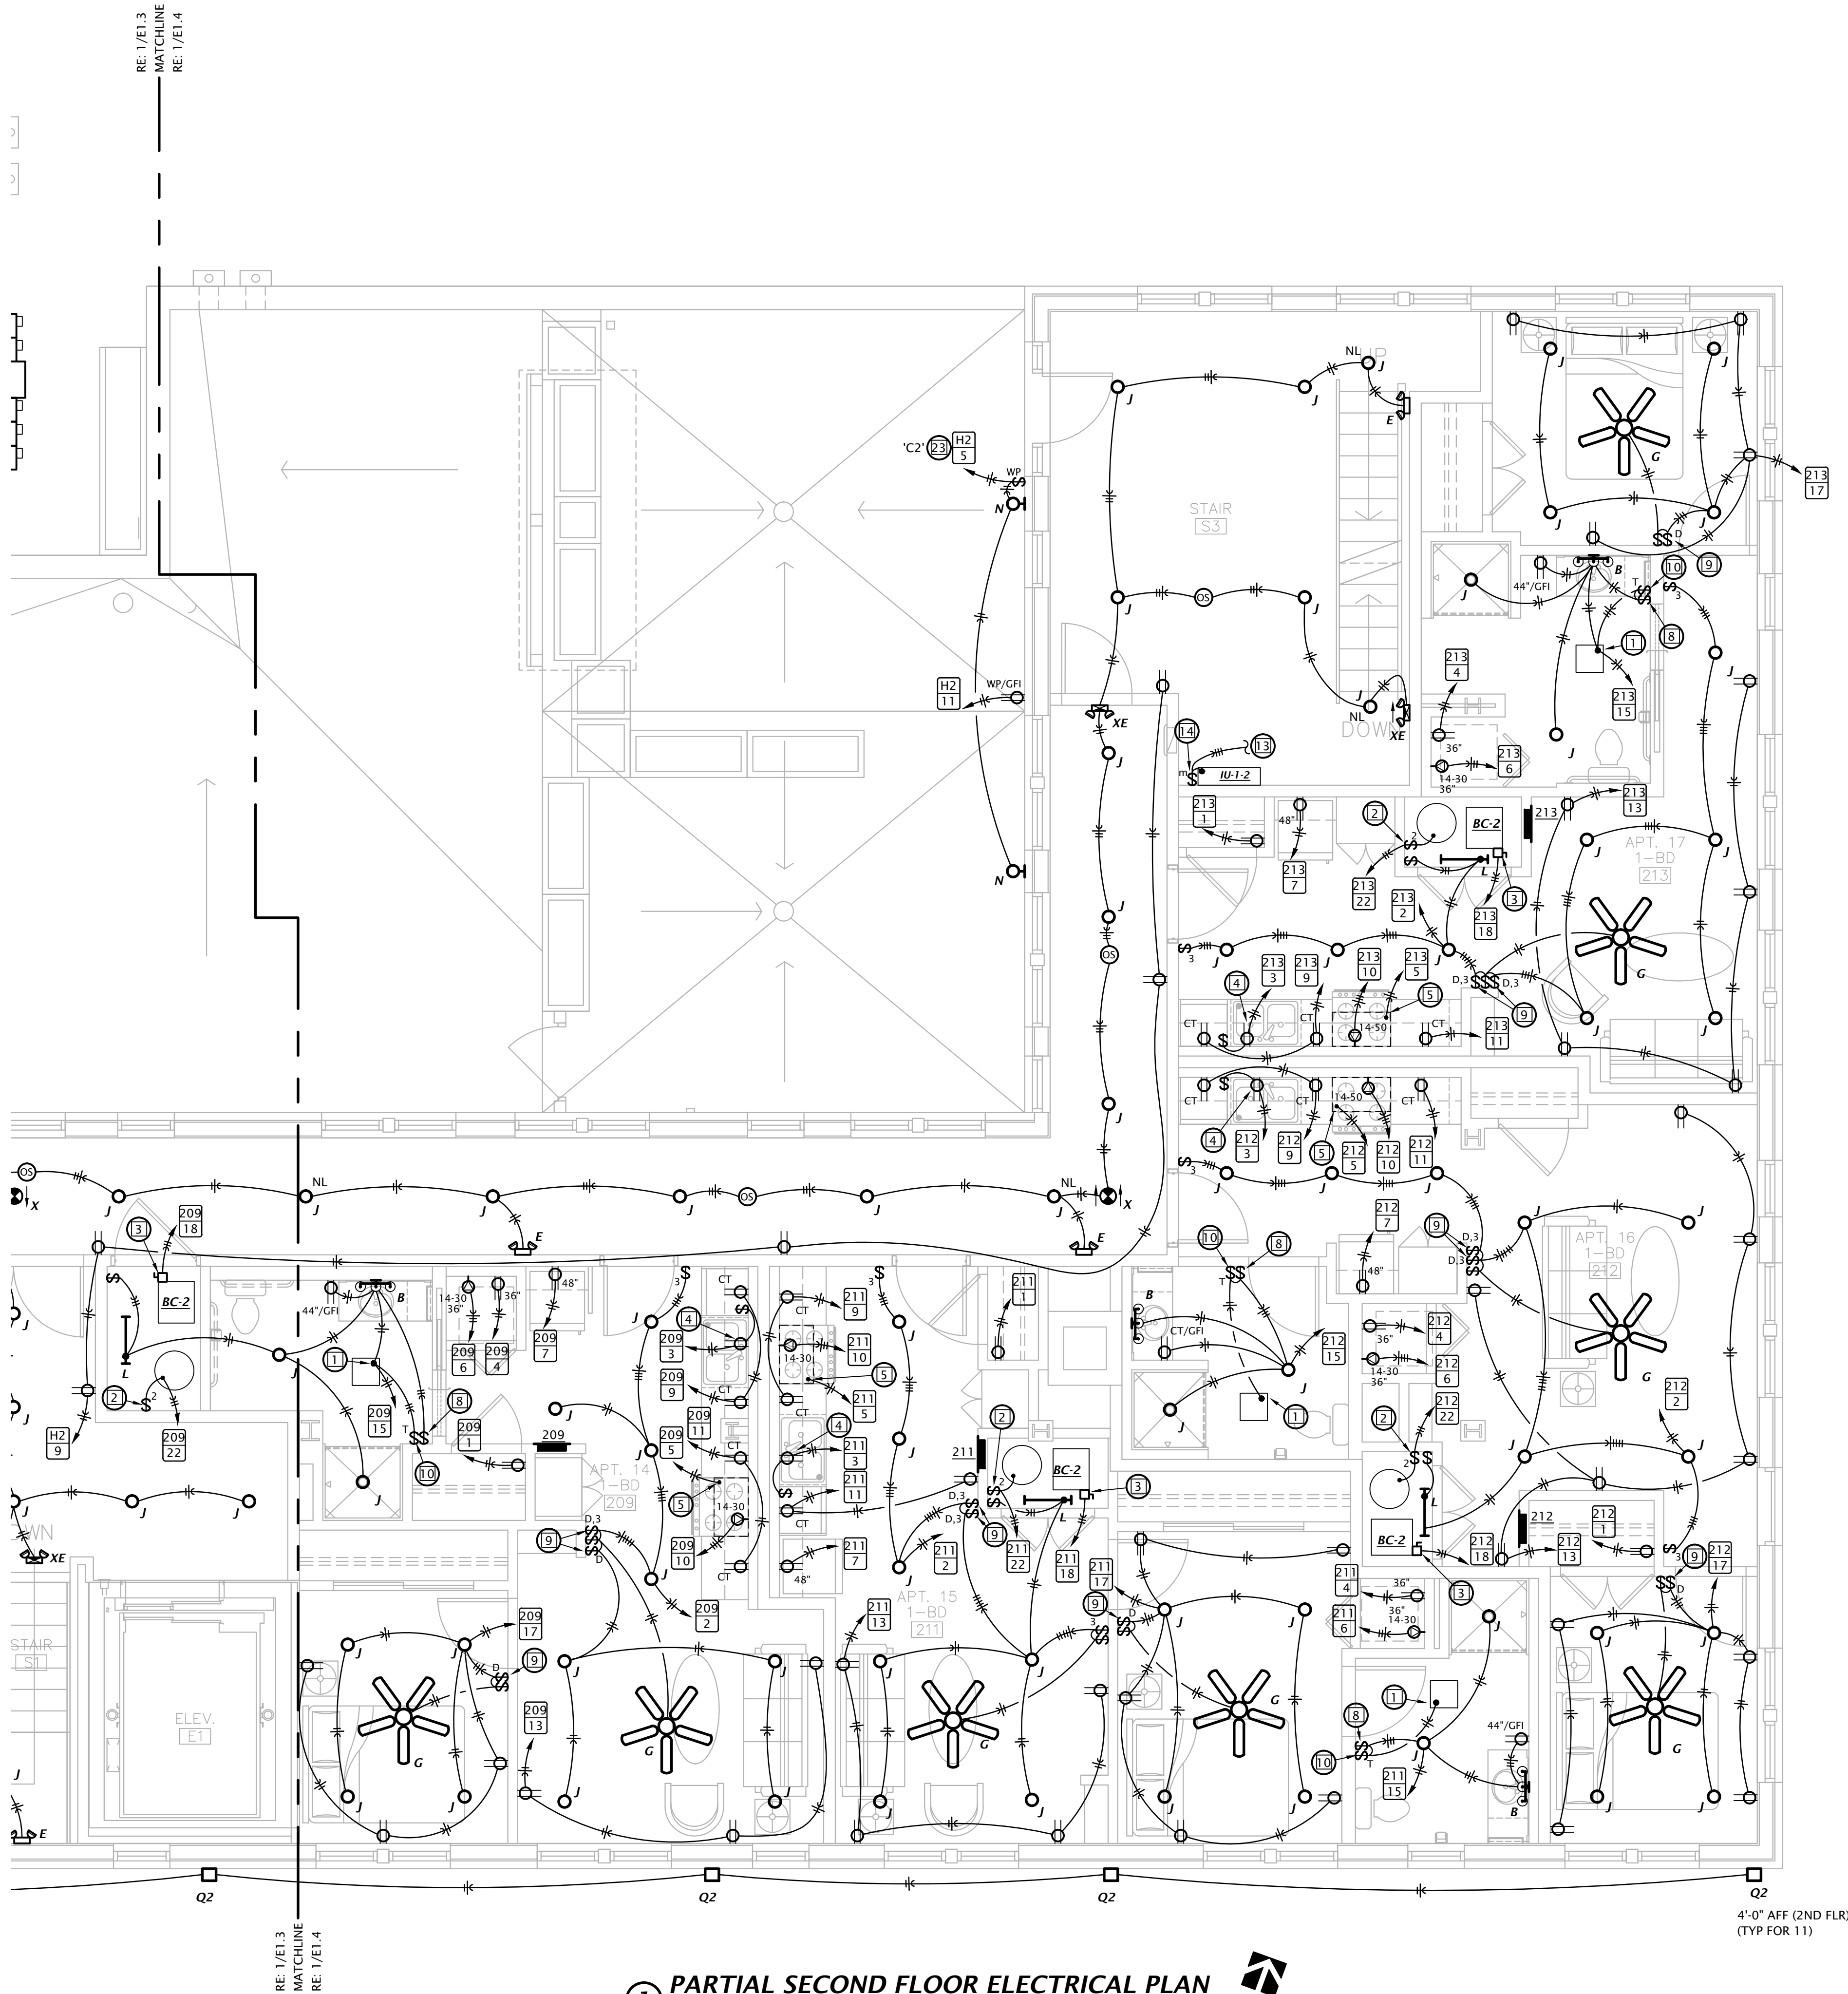

**1 PARTIAL SECOND FLOOR ELECTRICAL PLAN**  
1/4" = 1'-0"

SEE SHEET E1.5 FOR GENERAL ELECTRICAL NOTES.


**ELECTRICAL PLAN NOTES BY SYMBOL**

- CONNECT EXHAUST FAN PROVIDED BY MECHANICAL CONTRACTOR.
- PROVIDE 30A/2P SNAP SWITCH AND CONNECT WATER HEATER.
- PROVIDE 60A/2P DISCONNECT SWITCH AND CONNECT TO BLOWER COIL WITH ELECTRIC HEAT. SEE EQUIPMENT SCHEDULE FOR MORE INFORMATION. COORDINATE REQUIREMENTS WITH M.C.
- SPLIT-WIRE DUPLEX RECEPTACLE BELOW COUNTER. TOP HALF OF RECEPTACLE TO BE SWITCHED FOR CONTROL OF GARBAGE DISPOSAL. BOTTOM HALF OF RECEPTACLE TO BE WIRED UNSWITCHED FOR DISHWASHER. RECEPTACLE SHALL BE LOCATED IN BACK OF BASE CABINET ADJACENT TO DISHWASHER TO ALLOW ACCESS. PROVIDE CORDS AND GROUNDING PLUGS AS REQUIRED FOR DISPOSER AND DISHWASHER.
- PROVIDE 120V CONNECTION TO MICROWAVE/RANGE HOOD. STANDARD AND ADAPTABLE UNITS WILL HAVE MICROWAVE ABOVE RANGE. ACCESSIBLE UNITS WILL HAVE RANGE HOOD. COORDINATE EXACT ELECTRICAL ROUGH-IN REQUIREMENTS WITH EQUIPMENT PROVIDED. IF EQUIPMENT IS CORD AND PLUG, PROVIDE RECEPTACLE INSIDE CABINET ABOVE RANGE.
- PROVIDE SWITCH IN ACCESSIBLE UNITS FOR CONTROL OF RANGE HOOD.
- IN ACCESSIBLE UNITS, INSTALL COUNTERTOP RECEPTACLES A MINIMUM 36" AWAY FROM CORNER PER FAIR HOUSING ACT DESIGN MANUAL CHAPTER 5 'SIDE REACH OVER AN OBSTRUCTION' REQUIREMENTS. WHERE AN OBSTRUCTION PREVENTS 36" DISTANCE REQUIREMENT, INSTALL RECEPTACLE AS FAR FROM CORNER AS POSSIBLE. PROVIDE ADDITIONAL OUTLETS WITHIN 36" OF CORNER TO ENSURE COMPLIANCE WITH NEC SPACING REQUIREMENTS.
- SWITCH CLOSEST TO DOOR SHALL CONTROL ALL LIGHTS IN BATHROOM, AND THE OTHER SWITCH SHALL CONTROL THE EXHAUST FAN.
- PROVIDE PRESET SLIDE DIMMER COMPATIBLE WITH ASSOCIATED LIGHT FIXTURES.
- PROVIDE TIMER SWITCH EQUAL TO AIR CYCLER 'SMART EXHAUST' FOR CONTROL OF EXHAUST FAN. SET SWITCH PER MANUFACTURER'S INSTRUCTIONS TO OPERATE FAN AS INDICATED BELOW:  
1 BEDROOM: 20 MINUTES PER HOUR  
2 BEDROOM: 35 MINUTES PER HOUR
- ROUTE 120V CIRCUIT FOR HOT WATER RECIRCULATION PUMP (HWP) THROUGH ADJACENT AQUASTAT. PROVIDE 20A/1P SNAP SWITCH ADJACENT TO PUMP AND MAKE FINAL FLEXIBLE CONNECTION. COORDINATE WITH PLUMBING CONTRACTOR.
- CONNECT UNBALANCED PORTION OF WATER HEATER LOAD TO PHASE LEG INDICATED.
- (3) #12, #12G, 1/2" C FROM ASSOCIATED OUTDOOR UNIT ON ROOF. SEE SHEET E1.7.
- 30A/3P MANUAL MOTOR CONTROLLER SNAP SWITCH (WITHOUT OVERLOAD PROTECTION) IN NEMA 1 ENCLOSURE, P&S #7803W OR EQUAL. MOUNT ADJACENT TO UNIT AND MAKE FINAL FLEXIBLE CONNECTION TO EQUIPMENT.
- AT RECEPTACLES ABOVE KITCHEN COUNTERS IN ACCESSIBLE UNITS (#109 & #203, PROVIDE 1" DEEP FLUSH TYPE EXTENSION ADAPTER, WIREMOLD #V5751WH, TO BRING RECEPTACLE CLOSER TO COUNTERTOP EDGE TO COMPLY WITH 24" SIDE REACH REQUIREMENT.
- 30A/2P DISCONNECT SWITCH WITH SOLID NEUTRAL AND (1) 20A DUAL-ELEMENT, TIME DELAY FUSE IN NEMA 1 ENCLOSURE FOR ELEVATOR CAB LIGHTS & EXHAUST. SWITCH SHALL BE CAPABLE OF BEING LOCKED "OFF". MOUNT AT 6'-0" AFF TO TOP AND LABEL WITH CIRCUIT NUMBER. COORDINATE EXACT MOUNTING LOCATION AND REQUIREMENTS WITH ELEVATOR EQUIPMENT INSTALLER. PROVIDE FINAL ELECTRICAL CONNECTION TO INSPECTION AND TEST PANEL (IDU) AT TOP OF 3RD FLOOR WITHIN ELEVATOR DOOR JAMB.
- ELEVATOR POWER MODULE SWITCH: 100A/208V/3P SWITCH COMPLETE WITH 70A DUAL ELEMENT, TIME DELAY CLASS 'J' FUSES, 120V CONTROL TRANSFORMER, FIRE ALARM SAFETY INTERFACE RELAY, KEY TEST SWITCH, GREEN PILOT LIGHT, AUXILIARY CONTACTS FOR ELEVATOR RECALL, AND FIRE ALARM VOLTAGE MONITORING RELAY. COOPER BUSSMAN #PS-1 T20-R1-K-G-B-F1 OR EQUAL. COORDINATE EXACT MOUNTING LOCATION AND REQUIREMENTS WITH ELEVATOR EQUIPMENT INSTALLER.
- 3-PHASE POWER FEEDER AND (2) #18 STRANDED CU CONDUCTORS FROM ELEVATOR POWER MODULE SWITCH TO 'JH1' DISCONNECT SWITCH.
- 100A/3P NON-FUSED DISCONNECT SWITCH (DH1) IN NEMA 1 ENCLOSURE. PROVIDE WITH SPST AUXILIARY CONTACTS RATED FOR MIN 2A AT 24VDC. MAKE FINAL CONNECTION TO ELEVATOR FUSE BOX. COORDINATE MOUNTING LOCATION AT TOP OF HOISTWAY AND REQUIREMENTS WITH ELEVATOR EQUIPMENT INSTALLER.
- INSTALL LIGHT AND RECEPTACLE ON WALL OF ELEVATOR PIT. VERIFY EXACT LOCATION WITH ELEVATOR EQUIPMENT INSTALLER. INSTALL LIGHT SWITCH ADJACENT TO PIT LADDER AT 48" ABOVE FLOOR LANDING.
- INSTALL LIGHT AND RECEPTACLE ON WALL NEAR TOP OF ELEVATOR HOISTWAY. VERIFY EXACT LOCATION WITH ELEVATOR EQUIPMENT INSTALLER. INSTALL LIGHT SWITCH ADJACENT ENTRY AT 48" ABOVE FLOOR LANDING.
- SWITCH EXHAUST FAN WITH ROOM LIGHTS.
- ROUTE CIRCUIT THROUGH CONTACTOR INDICATED. SEE 5/E6.1.
- SIMPLEX RECEPTACLE IN ELEVATOR PIT FOR ELEVATOR SUMP PUMP. COORDINATE EXACT MOUNTING LOCATION WITH PLUMBING CONTRACTOR AND ELEVATOR EQUIPMENT INSTALLER.
- ELEVATOR SUMP PUMP ALARM PANEL IN CLOSET BELOW STAIR LANDING. PROVIDE 120V POWER CONNECTION AND 1" CONDUIT WITH PULL STRING STUBBED INTO ELEVATOR PIT FOR CONTROL CABLING. COORDINATE ALL WORK WITH PLUMBING CONTRACTOR.
- MOUNT LIGHT FIXTURE FOR CLOSET BELOW STAIR LANDING. MOUNT TO STRUCTURE.
- ROUTE DRYER CIRCUIT THROUGH CURRENT SWITCH FOR OPERATION OF OUTSIDE AIR INTAKE HOOD. HOOD DAMPER SHALL OPEN WHEN ANY DRYER IS OPERATING. SEE DETAIL 2/E6.2.
- COORDINATE EXACT MOUNTING LOCATION OF DRINKING FOUNTAIN RECEPTACLE WITH PLUMBING CONTRACTOR.
- PROVIDE 120V POWER CONNECTION TO SEWAGE EJECTOR ALARM PANEL AND SIMPLEX RECEPTACLE FOR POWER TO SEWAGE EJECTOR PUMP. COORDINATE REQUIREMENTS WITH G.C. AND PLUMBING CONTRACTOR.
- PROVIDE DOOR ANNUNCIATOR SYSTEM A/V HORN/STROBE DEVICE AND LOW VOLTAGE TRANSFORMER AT ALL ACCESSIBLE APARTMENTS AND ALSO AT APARTMENTS DESIGNATED HEARING-IMPAIRED. INSTALL HORN/STROBE APPLIANCE AT 80" AFF. INSTALL TRANSFORMER IN DOUBLE GANG JUNCTION BOX ABOVE HORN/STROBE WITH BLANK COVER PLATE AND PROVIDE LOW VOLTAGE CONTROL WIRING. SEE DETAIL 3, SHEET E6.2. PROVIDE ENGRAVED SIGN AT THE HORN/STROBE DEVICE TO READ "DOOR".
- PROVIDE PUSH BUTTON AT 48" AFF FOR ANNUNCIATOR SYSTEM AT ALL ACCESSIBLE APARTMENTS AND ALSO AT APARTMENTS DESIGNATED FOR HEARING-IMPAIRED. REFER TO ARCH DRAWINGS FOR APPLICABLE ROOMS. SEE DETAIL 3, SHEET E6.2.
- IN ADA/ACCESSIBLE UNITS, DISPOSER SWITCH SHALL BE COUNTERTOP MOUNTED, AIR ACTIVATED PUSH BUTTON TYPE, FINISH TO MATCH SINK. COORDINATE EXACT LOCATION OF PUSH BUTTON WITH ARCHITECT.
- RELAY FOR CONTROL OF MOTORIZED INTAKE HOOD ON ROOF. SEE 2/E6.2.
- TIMECLOCK AND CONTACTORS FOR LIGHTING AND RECEPTACLE CONTROL. RE: 5/E6.1.
- 2-HOUR DIAL TIMER OVERRIDE SWITCH FOR SWITCHED RECEPTACLES. SEE 5/E6.1.
- LINE VOLTAGE CEILING OCCUPANCY SENSOR/PHOTOCELL WITH DAYLIGHT HARVESTING CAPABILITY. SENSOR SHALL DIM 0-10V LIGHTS WHEN ADEQUATE DAYLIGHT IS PRESENT. SENSORWORX #SWX-2-3-1-2-D OR EQUAL.
- PRESET SLIDE DIMMER, 0-10V, LEVITON #P710-DLZ OR EQUAL. COORDINATE DEVICE COLOR WITH ARCHITECT.
- ONE RECEPTACLE SHALL BE CONNECTED TO CIRCUIT #44 (UNCONTROLLED) AND THE OTHER RECEPTACLES SHALL BE CONNECTED TO CIRCUIT #46 (CONTROLLED). CONTROLLED RECEPTACLE SHALL BE MARKED IN ACCORDANCE WITH NEC 406.3(E).

**JonesGillamRenz**  
730 N. Ninth  
Salina, KS 67401  
jgr@garchitects.com  
1881 Main Street, Suite 301  
Kansas City, MO 64108  
785.827.0386



**ROOSEVELT LOFTS**  
HISTORIC REHABILITATION - APARTMENTS  
SAN ANGELO, TEXAS

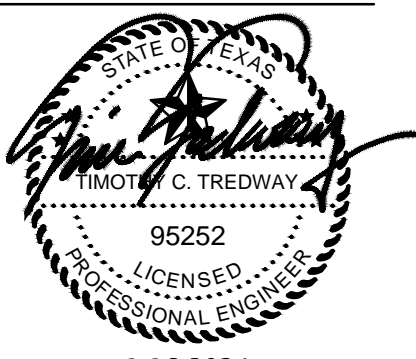

REVISION:	1-16-2024
DATE:	1-16-2024
JOB:	21-3166
SHEET NO.:	

**E1.4**

COPYRIGHTED ©



**LST Consulting Engineers, PA**


<b>MANHATTAN</b>	<b>WICHITA</b>
4809 Vue Du Lac Place, Suite 201	125 S. Washington, Suite 150
Manhattan, KS 66503	Wichita, Kansas 67202
785.587.8042	316.285.0696
<a href="http://www.LSTengineers.com">www.LSTengineers.com</a>	
<a href="mailto:mail@LSTengineers.com">mail@LSTengineers.com</a>	

**Project 23061** **January 2024**

Project 23061 January 2024

ER

# TEXAS

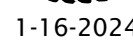

REVISION:

DATE: 1-16-2024

**JOB:** 21-3166

SHEET NO.:

## E1.5

COPYRIGHT ©

- A. VERIFY EXACT LOCATIONS AND ELECTRICAL REQUIREMENTS OF ALL EQUIPMENT PROVIDED OR SELECTED BY OWNER.
- B. VERIFY EXACT PLACEMENT OF ALL LUMINAIRES, DEVICES, AND EQUIPMENT SHOWN ON THE ELECTRICAL CONSTRUCTION DOCUMENTS WITH ARCHITECTURAL, MECHANICAL AND PLUMBING DRAWINGS PRIOR TO FINAL PLACEMENT.
- C. CIRCUIT ALL EMERGENCY LIGHTS, NIGHT LIGHTS AND EXIT LIGHTS TO AN UNSWITCHED HOT CONDUCTOR, UPSTREAM OF ALL CONTROLS.
- D. CEILING MOUNTED OCCUPANCY SENSORS SHALL BE LINE VOLTAGE, PASSIVE INFRARED, WITH 2000 SQFT COVERAGE OVER 360° PATTERN. SENSORWORX #SWX-202-2
- E. IN AREAS WHERE CEILING MOUNTED OCCUPANCY SENSORS ARE USED FOR LIGHTING CONTROL IN CONJUNCTION WITH WALL SWITCHES, OCCUPANCY SENSOR SWITCH LEADS SHALL BE WIRED IN SERIES WITH WALL SWITCH(ES) TO PROVIDE OVERRIDE "OFF" CONTROL FOR LIGHTS.
- F. VERIFY EXACT LOCATIONS OF HVAC AND PLUMBING EQUIPMENT WITH THE GENERAL CONTRACTOR AND ASSOCIATED SUB CONTRACTORS. COORDINATE ELECTRICAL INSTALLATION REQUIRED PRIOR TO COMMENCING ROUGH-IN WORK.
- G. PROVIDE TAMPER PROOF RECEPTACLES IN DWELLING UNITS PER NEC REQUIREMENTS.
- H. CONTROL WIRING FOR 0-10 vdc DIMMING SIGNAL CIRCUITS SHALL BE NEC CLASS 1, ROUTED IN SAME RACEWAY/CABLE WITH LIGHTING CIRCUIT POWER CONDUCTORS. WIRING SHALL CONSIST OF (2) #16 SOLID CU THHN OR TFC CONDUCTORS. CONDUCTOR INSULATION COLOR SHALL BE VIOLET (+ Vdc) AND PINK (- Vdc).

CONNECT EXHAUST FAN PROVIDED BY MECHANICAL CONTRACTOR.

2. PROVIDE 30A/32P SNAP SWITCH AND CONNECT WATER HEATER.

3. PROVIDE 60A/2P DISCONNECT SWITCH AND CONNECT TO BLOWER COIL WITH ELECTRIC HEAT. SEE EQUIPMENT SCHEDULE FOR MORE INFORMATION. COORDINATE REQUIREMENTS WITH M.C.

4. SPLIT-WIRE DUPLEX RECEPTACLE BELOW COUNTER. TOP HALF OF RECEPTACLE TO BE SWITCHED FOR CONTROL OF GARBAGE DISPOSAL. BOTTOM HALF OF RECEPTACLE TO BE W/ W/ UNSWITCHED FOR DISHWASHER. RECEPTACLE SHALL BE LOCATED IN BACK OF BASE CABINET ADJACENT TO DISHWASHER TO ALLOW ACCESS. PROVIDE CORDS AND GROUNDING PLUGS AS REQUIRED FOR DISPOSER AND DISHWASHER.

5. PROVIDE 120V CONNECTION TO MICROWAVE/RANGE HOOD. STANDARD AND ADAPTABLE UNITS WILL HAVE MICROWAVE ABOVE RANGE. ACCESSIBLE UNITS WILL HAVE RANGE HOOD. COORDINATE EXACT ELECTRICAL ROUGH-IN REQUIREMENTS WITH EQUIPMENT PROVIDED. IF EQUIPMENT IS CORD AND PLUG, PROVIDE RECEPTACLE INSIDE CABINET ABOVE RANGE.

6. PROVIDE SWITCH IN ACCESSIBLE UNITS FOR CONTROL OF RANGE HOOD.

7. IN ACCESSIBLE UNITS, INSTALL COUNTERTOP RECEPTABLES A MINIMUM 36" AWAY FROM CORNER PER FAIR HOUSING ACT DESIGN MANUAL CHAPTER 5 'SIDE REACH OVER AN OBSTRUCTION' REQUIREMENTS. WHERE AN OBSTRUCTION PREVENTS 36" DISTANCE REQUIREMENT, INSTALL RECEPTACLE AS FAR FROM CORNER AS POSSIBLE PROVIDE ADDITIONAL OUTLETS WITHIN 36" OF CORNER TO ENSURE COMPLIANCE WITH NEC SPACING REQUIREMENTS.

8. SWITCH CLOSEST TO DOOR SHALL CONTROL ALL LIGHTS IN BATHROOM, AND THE OTHER SWITCH SHALL CONTROL THE EXHAUST FAN.

9. PROVIDE PRESET SLIDE DIMMER COMPATIBLE WITH ASSOCIATED LIGHT FIXTURES.

10. PROVIDE TIME SWITCH EQUAL TO AIR CYCLER 'SMART EXHAUST' FOR CONTROL OF EXHAUST FAN. SET SWITCH PER MANUFACTURER'S INSTRUCTIONS TO OPERATE FAN AS INDICATED BELOW:

1 BEDROOM: 20 MINUTES PER HOUR  
2 BEDROOM: 35 MINUTES PER HOUR

11. ROUTE 120V CIRCUIT FOR HOT WATER RECIRCULATION PUMP (HWP) THROUGH ADJACENT AQUASTAT. PROVIDE 20A/1P SNAP SWITCH ADJACENT TO PUMP AND MAKE FINAL FLEXIBLE CONNECTION. COORDINATE WITH PLUMBING CONTRACTOR.

12. CONNECT UNBALANCED PORTION OF WATER HEATER LOAD TO PHASE LEG INDICATED.

13. (3) #12, 1/2" C FROM ASSOCIATED OUTDOOR UNIT ON ROOF. SEE SHEET E1.7.

14. 30A/3P MANUAL MOTOR CONTROLLER SNAP SWITCH (WITHOUT OVERLOAD PROTECTION) IN NEMA 1 ENCLOSURE, #85 #7803W OR EQUAL. MOUNT ADJACENT TO UNIT AND MAKE FINAL FLEXIBLE CONNECTION TO EQUIPMENT.

15. AT RECEPTABLES ABOVE KITCHEN COUNTERS IN ACCESSIBLE UNITS (#109 & #203, PROVIDE 1" DEEP FLUSH TYPE EXTENSION ADAPTER, WIREMOLD #V571WH, TO BRING RECEPTACLE CLOSER TO COUNTERTOP EDGE TO COMPLY WITH 24" SIDE REACH REQUIREMENT.

16. 30A/2P DISCONNECT SWITCH WITH SOLID NEUTRAL AND (1) 20A DUAL-ELEMENT, TIME DELAY FUSE IN NEMA 1 ENCLOSURE FOR ELEVATOR CAB LIGHTS & EXHAUST. SWITCH SHALL BE CAPABLE OF BEING LOCKED "OFF". MOUNT AT 6" OFF TO TOP AND LABEL WITH CIRCUIT NUMBER. COORDINATE EXACT MOUNTING LOCATION AND REQUIREMENTS WITH ELEVATOR EQUIPMENT INSTALLER. PROVIDE FINAL ELECTRICAL CONNECTION TO INSPECTION AND TEST PANEL (LDU) AT TOP OF 3RD FLOOR WITHIN ELEVATOR DOOR JAMB.

17. ELEVATOR POWER MODE SWITCH: 100A/208V/3P SWITCH COMPLETE WITH 70A DUAL ELEMENT, TIME DELAY CLASS "J" FUSES, 120V CONTROL TRANSFORMER, FIRE ALARM SAFETY INTERFACE RELAY, KEY TEST SWITCH, GREEN PILOT LIGHT, AUXILIARY CONTACTS FOR ELEVATOR RECALL, AND FIRE ALARM VOLTAGE MONITORING RELAY. COOPER BUSSMAN #P5-1-T20-R1-K-G-B-F1 OR EQUAL. COORDINATE EXACT MOUNTING LOCATION AND REQUIREMENTS WITH ELEVATOR EQUIPMENT INSTALLER.

18. 3-PHASE POWER FEEDER AND (2) #18 STRANDED CU CONDUCTORS FROM ELEVATOR POWER MODE SWITCH TO 'JH1' DISCONNECT SWITCH.

19. 100A/3P NON-FUSED DISCONNECT SWITCH (JH1) IN NEMA 1 ENCLOSURE. PROVIDE WITH SPST AUXILIARY CONTACTS RATED FOR MIN 2A AT 24VDC. MAKE FINAL CONNECTION TO ELEVATOR FUSE BOX. COORDINATE MOUNTING LOCATION AT TOP OF HOISTWAY AND REQUIREMENTS WITH ELEVATOR EQUIPMENT INSTALLER.

20. INSTALL LIGHT AND RECEPTACLE ON WALL OF ELEVATOR PIT. VERIFY EXACT LOCATION WITH ELEVATOR EQUIPMENT INSTALLER. INSTALL LIGHT SWITCH ADJACENT TO PIT LADDER AT 48" ABOVE FLOOR LANDING.

21. INSTALL LIGHT AND RECEPTACLE ON WALL NEAR TOP OF ELEVATOR HOISTWAY. VERIFY EXACT LOCATION WITH ELEVATOR EQUIPMENT INSTALLER. INSTALL LIGHT SWITCH ADJACENT ENTRY AT 48" ABOVE FLOOR LANDING.

22. SWITCH EXHAUST FAN WITH ROOM LIGHTS.

23. ROUTE CIRCUIT THROUGH CONTACTOR INDICATED. SEE 5/E6.1.

24. SIMPLEX RECEPTACLE IN ELEVATOR PIT FOR ELEVATOR SUMP PUMP. COORDINATE EXACT MOUNTING LOCATION WITH PLUMBING CONTRACTOR AND ELEVATOR EQUIPMENT INSTALLER.

25. ELEVATOR SUMP PUMP ALARM PANEL IN CLOSET BELOW STAIR LANDING. PROVIDE 120V POWER CONNECTION AND 1" CONDUIT WITH PULL STRING STUBBED INTO ELEVATOR PIT FOR CONTROL CABLING. COORDINATE ALL WORK WITH PLUMBING CONTRACTOR.

26. MOUNT LIGHT FIXTURE FOR CLOSET BELOW STAIR LANDING. MOUNT TO STRUCTURE.

27. ROUTE DRYER CIRCUIT THROUGH CURRENT SWITCH FOR OPERATION OF OUTSIDE AIR INTAKE HOOD. HOOD DAMPER SHALL OPEN WHEN ANY DRYER IS OPERATING. SEE DETAIL 2/E6.2.

28. COORDINATE EXACT MOUNTING LOCATION OF DRINKING FOUNTAIN RECEPTACLE WITH PLUMBING CONTRACTOR.

29. PROVIDE 120V POWER CONNECTION TO SEWAGE EJECTOR ALARM PANEL AND SIMPLEX RECEPTACLE FOR POWER TO SEWAGE EJECTOR PUMP. COORDINATE REQUIREMENTS WITH G.C. AND PLUMBING CONTRACTOR.

30. PROVIDE DOOR ANNUNCIATOR SYSTEM A/V HORN/STROBE DEVICE AND LOW VOLTAGE TRANSFORMER AT ALL ACCESSIBLE APARTMENTS AND ALSO AT APARTMENTS DESIGNATED HEARING-IMPAIRED. INSTALL HORN/STROBE APPLIANCE AT 80" AFF. INSTALL TRANSFORMER IN DOUBLE GANG JUNCTION BOX ABOVE HORN/STROBE WITH BLANK COVER PLATE AND PROVIDE LOW VOLTAGE CONTROL WIRING. SEE DETAIL 3, SHEET E6.2. PROVIDE ENGRAVED SIGN AT THE HORN/STROBE DEVICE TO READ "DOOR".

31. PROVIDE PUSH BUTTON AT 48" AFF FOR ANNUNCIATOR SYSTEM AT ALL ACCESSIBLE APARTMENTS AND ALSO AT APARTMENTS DESIGNATED FOR HEARING-IMPAIRED. REFER TO ARCH DRAWINGS FOR APPLICABLE ROOMS. SEE DETAIL 3, SHEET E6.2.

32. IN ADA/ACCESSIBLE UNITS, DISPOSER SWITCH SHALL BE COUNTERTOP MOUNTED, AIR ACTIVATED PUSH BUTTON TYPE, FINISH TO MATCH SINK. COORDINATE EXACT LOCATION OF PUSH BUTTON WITH ARCHITECT.

33. RELAY FOR CONTROL OF MOTORIZED INTAKE HOOD ON ROOF. SEE 2/E6.2.


34. TIMECLOCK AND CONTACTORS FOR LIGHTING AND RECEPTACLE CONTROL. RE: 5/E6.1.

35. 2-HOUR DIA. TIMER OVERRIDE SWITCH FOR SWITCHED RECEPTABLES. SEE 5/E6.1.

36. LINE VOLTAGE CEILING OCCUPANCY SENSOR/PHOTOCELL WITH DAYLIGHT HARVESTING CAPABILITY. SENSOR SHALL DIM 0-10V LIGHTS WHEN ADEQUATE DAYLIGHT IS PRESENT. SENSORWORX #SWX-2-3-1-2-D OR EQUAL.

37. PRESET SLIDE DIMMER, 0-10V, LEVITON #P710-DLZ OR EQUAL. COORDINATE DEVICE COLOR WITH ARCHITECT.

38. ONE RECEPTACLE SHALL BE CONNECTED TO CIRCUIT #44 (UNCONTROLLED) AND THE OTHER RECEPTABLES SHALL BE CONNECTED TO CIRCUIT #46 (CONTROLLED). CONTROLLED RECEPTACLE SHALL BE MARKED IN ACCORDANCE WITH NEC 406.3(E).

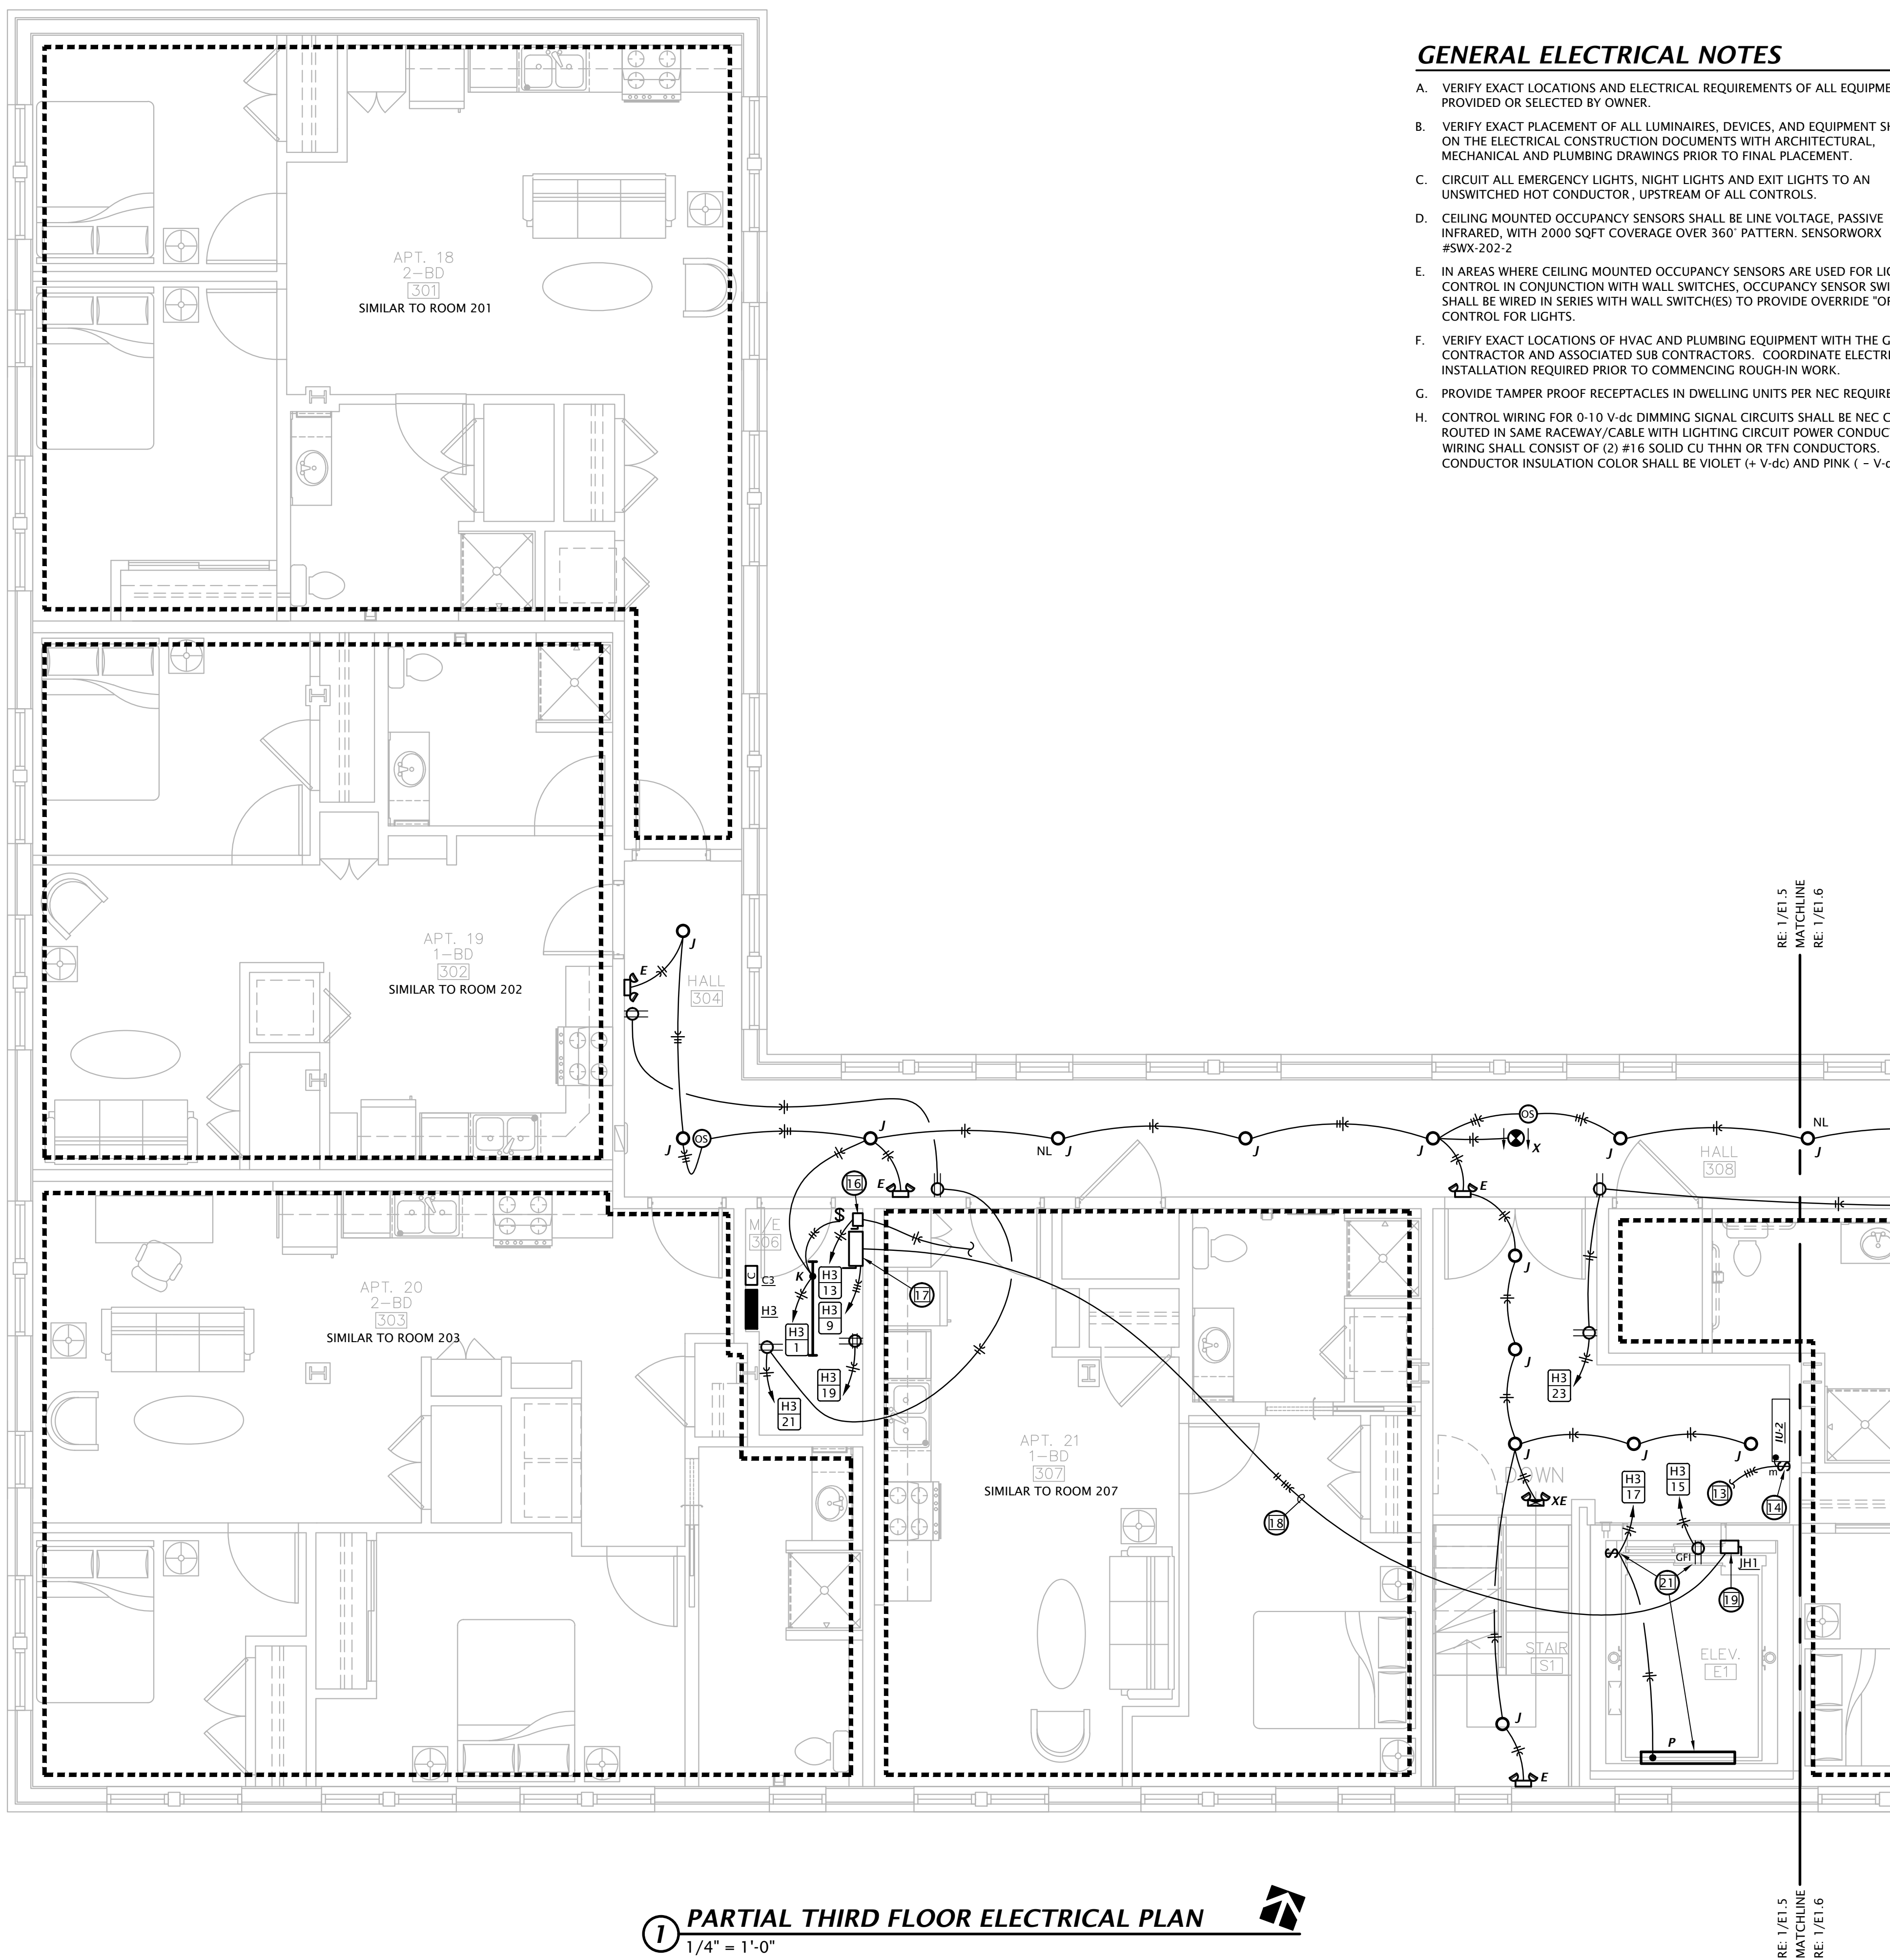


**1 PARTIAL THIRD FLOOR ELECTRICAL PLAN**  
1/4" = 1'-0"



ELECTRICAL PLAN NOTES BY SYMBOL


- CONNECT EXHAUST FAN PROVIDED BY MECHANICAL CONTRACTOR.
- PROVIDE 30A/2P SNAP SWITCH AND CONNECT WATER HEATER.
- PROVIDE 60A/2P DISCONNECT SWITCH AND CONNECT TO BLOWER COIL WITH ELECTRIC HEAT. SEE EQUIPMENT SCHEDULE FOR MORE INFORMATION. COORDINATE REQUIREMENTS WITH M.C.
- SPLIT-WIRE DUPLEX RECEPTACLE BELOW COUNTER. TOP HALF OF RECEPTACLE TO BE SWITCHED FOR CONTROL OF GARBAGE DISPOSAL. BOTTOM HALF OF RECEPTACLE TO BE WIRED UNSWITCHED FOR DISHWASHER. RECEPTACLE SHALL BE LOCATED IN BACK OF BASE CABINET ADJACENT TO DISHWASHER TO ALLOW ACCESS. PROVIDE CORDS AND GROUNDING PLUGS AS REQUIRED FOR DISPOSER AND DISHWASHER.
- PROVIDE 120V CONNECTION TO MICROWAVE/RANGE HOOD. STANDARD AND ADAPTABLE UNITS WILL HAVE MICROWAVE ABOVE RANGE. ACCESSIBLE UNITS WILL HAVE RANGE HOOD. COORDINATE EXACT ELECTRICAL ROUGH-IN REQUIREMENTS WITH EQUIPMENT PROVIDED. IF EQUIPMENT IS CORD AND PLUG, PROVIDE RECEPTACLE INSIDE CABINET ABOVE RANGE.
- PROVIDE SWITCH IN ACCESSIBLE UNITS FOR CONTROL OF RANGE HOOD.
- IN ACCESSIBLE UNITS, INSTALL COUNTERTOP RECEPTACLES A MINIMUM 36" AWAY FROM CORNER PER FAIR HOUSING ACT DESIGN MANUAL CHAPTER 5 'SIDE REACH OVER AN OBSTRUCTION' REQUIREMENTS. WHERE AN OBSTRUCTION PREVENTS 36" DISTANCE REQUIREMENT, INSTALL RECEPTACLE AS FAR FROM CORNER AS POSSIBLE. PROVIDE ADDITIONAL OUTLETS WITHIN 36" OF CORNER TO ENSURE COMPLIANCE WITH NEC SPACING REQUIREMENTS.
- SWITCH CLOSEST TO DOOR SHALL CONTROL ALL LIGHTS IN BATHROOM, AND THE OTHER SWITCH SHALL CONTROL THE EXHAUST FAN.
- PROVIDE PRESET SLIDE DIMMER COMPATIBLE WITH ASSOCIATED LIGHT FIXTURES.
- PROVIDE TIMER SWITCH EQUAL TO AIR CYCLER 'SMART EXHAUST' FOR CONTROL OF EXHAUST FAN. SET SWITCH PER MANUFACTURER'S INSTRUCTIONS TO OPERATE FAN AS INDICATED BELOW:  
1 BEDROOM: 20 MINUTES PER HOUR  
2 BEDROOM: 35 MINUTES PER HOUR
- ROUTE 120V CIRCUIT FOR HOT WATER RECIRCULATION PUMP (HWP) THROUGH ADJACENT AQUASTAT. PROVIDE 20A/1P SNAP SWITCH ADJACENT TO PUMP AND MAKE FINAL FLEXIBLE CONNECTION. COORDINATE WITH PLUMBING CONTRACTOR.
- CONNECT UNBALANCED PORTION OF WATER HEATER LOAD TO PHASE LEG INDICATED.
- (3) #12, #12G, 1/2" C FROM ASSOCIATED OUTDOOR UNIT ON ROOF. SEE SHEET E1.7.
- 30A/3P MANUAL MOTOR CONTROLLER SNAP SWITCH (WITHOUT OVERLOAD PROTECTION) IN NEMA 1 ENCLOSURE, P&S #7803W OR EQUAL. MOUNT ADJACENT TO UNIT AND MAKE FINAL FLEXIBLE CONNECTION TO EQUIPMENT.
- AT RECEPTACLES ABOVE KITCHEN COUNTERS IN ACCESSIBLE UNITS (#109 & #203, PROVIDE 1" DEEP FLUSH TYPE EXTENSION ADAPTER, WIREMOLD #V5751WH, TO BRING RECEPTACLE CLOSER TO COUNTERTOP EDGE TO COMPLY WITH 24" SIDE REACH REQUIREMENT.
- 30A/2P DISCONNECT SWITCH WITH SOLID NEUTRAL AND (1) 20A DUAL-ELEMENT, TIME DELAY FUSE IN NEMA 1 ENCLOSURE FOR ELEVATOR CAB LIGHTS & EXHAUST. SWITCH SHALL BE CAPABLE OF BEING LOCKED "OFF". MOUNT AT 6'-0" AFF TO TOP AND LABEL WITH CIRCUIT NUMBER. COORDINATE EXACT MOUNTING LOCATION AND REQUIREMENTS WITH ELEVATOR EQUIPMENT INSTALLER. PROVIDE FINAL ELECTRICAL CONNECTION TO INSPECTION AND TEST PANEL (LDU) AT TOP OF 3RD FLOOR WITHIN ELEVATOR DOOR JAMB.
- ELEVATOR POWER MODULE SWITCH: 100A/208V/3P SWITCH COMPLETE WITH 70A DUAL ELEMENT, TIME DELAY CLASS 'J' FUSES, 120V CONTROL TRANSFORMER, FIRE ALARM SAFETY INTERFACE RELAY, KEY TEST SWITCH, GREEN PILOT LIGHT, AUXILIARY CONTACTS FOR ELEVATOR RECALL, AND FIRE ALARM VOLTAGE MONITORING RELAY. COOPER BUSSMAN #P5-1-T20-R1-K-G-B-F1 OR EQUAL. COORDINATE EXACT MOUNTING LOCATION AND REQUIREMENTS WITH ELEVATOR EQUIPMENT INSTALLER.
- 3-PHASE POWER FEEDER AND (2) #18 STRANDED CU CONDUCTORS FROM ELEVATOR POWER MODULE SWITCH TO 'JH1' DISCONNECT SWITCH.
- 100A/3P NON-FUSED DISCONNECT SWITCH (JH1) IN NEMA 1 ENCLOSURE. PROVIDE WITH SPST AUXILIARY CONTACTS RATED FOR MIN 2A AT 24VDC. MAKE FINAL CONNECTION TO ELEVATOR EQUIPMENT BOX. COORDINATE MOUNTING LOCATION AT TOP OF HOISTWAY AND REQUIREMENTS WITH ELEVATOR EQUIPMENT INSTALLER.
- INSTALL LIGHT AND RECEPTACLE ON WALL OF ELEVATOR PIT. VERIFY EXACT LOCATION WITH ELEVATOR EQUIPMENT INSTALLER. INSTALL LIGHT SWITCH ADJACENT TO PIT LADDER AT 48" ABOVE FLOOR LANDING.
- INSTALL LIGHT AND RECEPTACLE ON WALL NEAR TOP OF ELEVATOR HOISTWAY. VERIFY EXACT LOCATION WITH ELEVATOR EQUIPMENT INSTALLER. INSTALL LIGHT SWITCH ADJACENT ENTRY AT 48" ABOVE FLOOR LANDING.
- SWITCH EXHAUST FAN WITH ROOM LIGHTS.
- ROUTE CIRCUIT THROUGH CONTACTOR INDICATED. SEE 5/E6.1.
- SIMPLEX RECEPTACLE IN ELEVATOR PIT FOR ELEVATOR SUMP PUMP. COORDINATE EXACT MOUNTING LOCATION WITH PLUMBING CONTRACTOR AND ELEVATOR EQUIPMENT INSTALLER.
- ELEVATOR SUMP PUMP ALARM PANEL IN CLOSET BELOW STAIR LANDING. PROVIDE 120V POWER CONNECTION AND 1" CONDUIT WITH PULL STRING STUBBED INTO ELEVATOR PIT FOR CONTROL CABLING. COORDINATE ALL WORK WITH PLUMBING CONTRACTOR.
- MOUNT LIGHT FIXTURE FOR CLOSET BELOW STAIR LANDING. MOUNT TO STRUCTURE.
- ROUTE DRYER CIRCUIT THROUGH CURRENT SWITCH FOR OPERATION OF OUTSIDE AIR INTAKE HOOD. HOOD DAMPER SHALL OPEN WHEN ANY DRYER IS OPERATING. SEE DETAIL 2/E6.2.
- COORDINATE EXACT MOUNTING LOCATION OF DRINKING FOUNTAIN RECEPTACLE WITH PLUMBING CONTRACTOR.
- PROVIDE 120V POWER CONNECTION TO SEWAGE EJECTOR ALARM PANEL AND SIMPLEX RECEPTACLE FOR POWER TO SEWAGE EJECTOR PUMP. COORDINATE REQUIREMENTS WITH G.C. AND PLUMBING CONTRACTOR.
- PROVIDE DOOR ANNUNCIATOR SYSTEM A/V HORN/STROBE DEVICE AND LOW VOLTAGE TRANSFORMER AT ALL ACCESSIBLE APARTMENTS AND ALSO AT APARTMENTS DESIGNATED HEARING-IMPAIRED. INSTALL HORN/STROBE APPLIANCE AT 80" AFF. INSTALL TRANSFORMER IN DOUBLE GANG JUNCTION BOX ABOVE HORN/STROBE WITH BLANK COVER PLATE AND PROVIDE LOW VOLTAGE CONTROL WIRING. SEE DETAIL 3, SHEET E6.2. PROVIDE ENGRAVED SIGN AT THE HORN/STROBE DEVICE TO READ "DOOR".
- PROVIDE PUSH BUTTON AT 48" AFF FOR ANNUNCIATOR SYSTEM AT ALL ACCESSIBLE APARTMENTS AND ALSO AT APARTMENTS DESIGNATED FOR HEARING-IMPAIRED. REFER TO ARCH DRAWINGS FOR APPLICABLE ROOMS. SEE DETAIL 3, SHEET E6.2.
- IN ADA/ACCESSIBLE UNITS, DISPOSER SWITCH SHALL BE COUNTERTOP MOUNTED, AIR ACTIVATED PUSH BUTTON TYPE, FINISH TO MATCH SINK. COORDINATE EXACT LOCATION OF PUSH BUTTON WITH ARCHITECT.
- RELAY FOR CONTROL OF MOTORIZED INTAKE HOOD ON ROOF. SEE 2/E6.2.
- TIMECLOCK AND CONTACTORS FOR LIGHTING AND RECEPTACLE CONTROL. RE: 5/E6.1.
- 2-HOUR DIAL TIMER OVERRIDE SWITCH FOR SWITCHED RECEPTACLES. SEE 5/E6.1.
- LINE VOLTAGE CEILING OCCUPANCY SENSOR/PHOTOCELL WITH DAYLIGHT HARVESTING CAPABILITY. SENSOR SHALL DIM 0-10V LIGHTS WHEN ADEQUATE DAYLIGHT IS PRESENT. SENSORWORX #SWX-2-3-1-2-D OR EQUAL.
- PRESET SLIDE DIMMER, 0-10V, LEVITON #P710-DLZ OR EQUAL. COORDINATE DEVICE COLOR WITH ARCHITECT.
- ONE RECEPTACLE SHALL BE CONNECTED TO CIRCUIT #44 (UNCONTROLLED) AND THE OTHER RECEPTACLES SHALL BE CONNECTED TO CIRCUIT #46 (CONTROLLED). CONTROLLED RECEPTACLE SHALL BE MARKED IN ACCORDANCE WITH NEC 406.3(E).

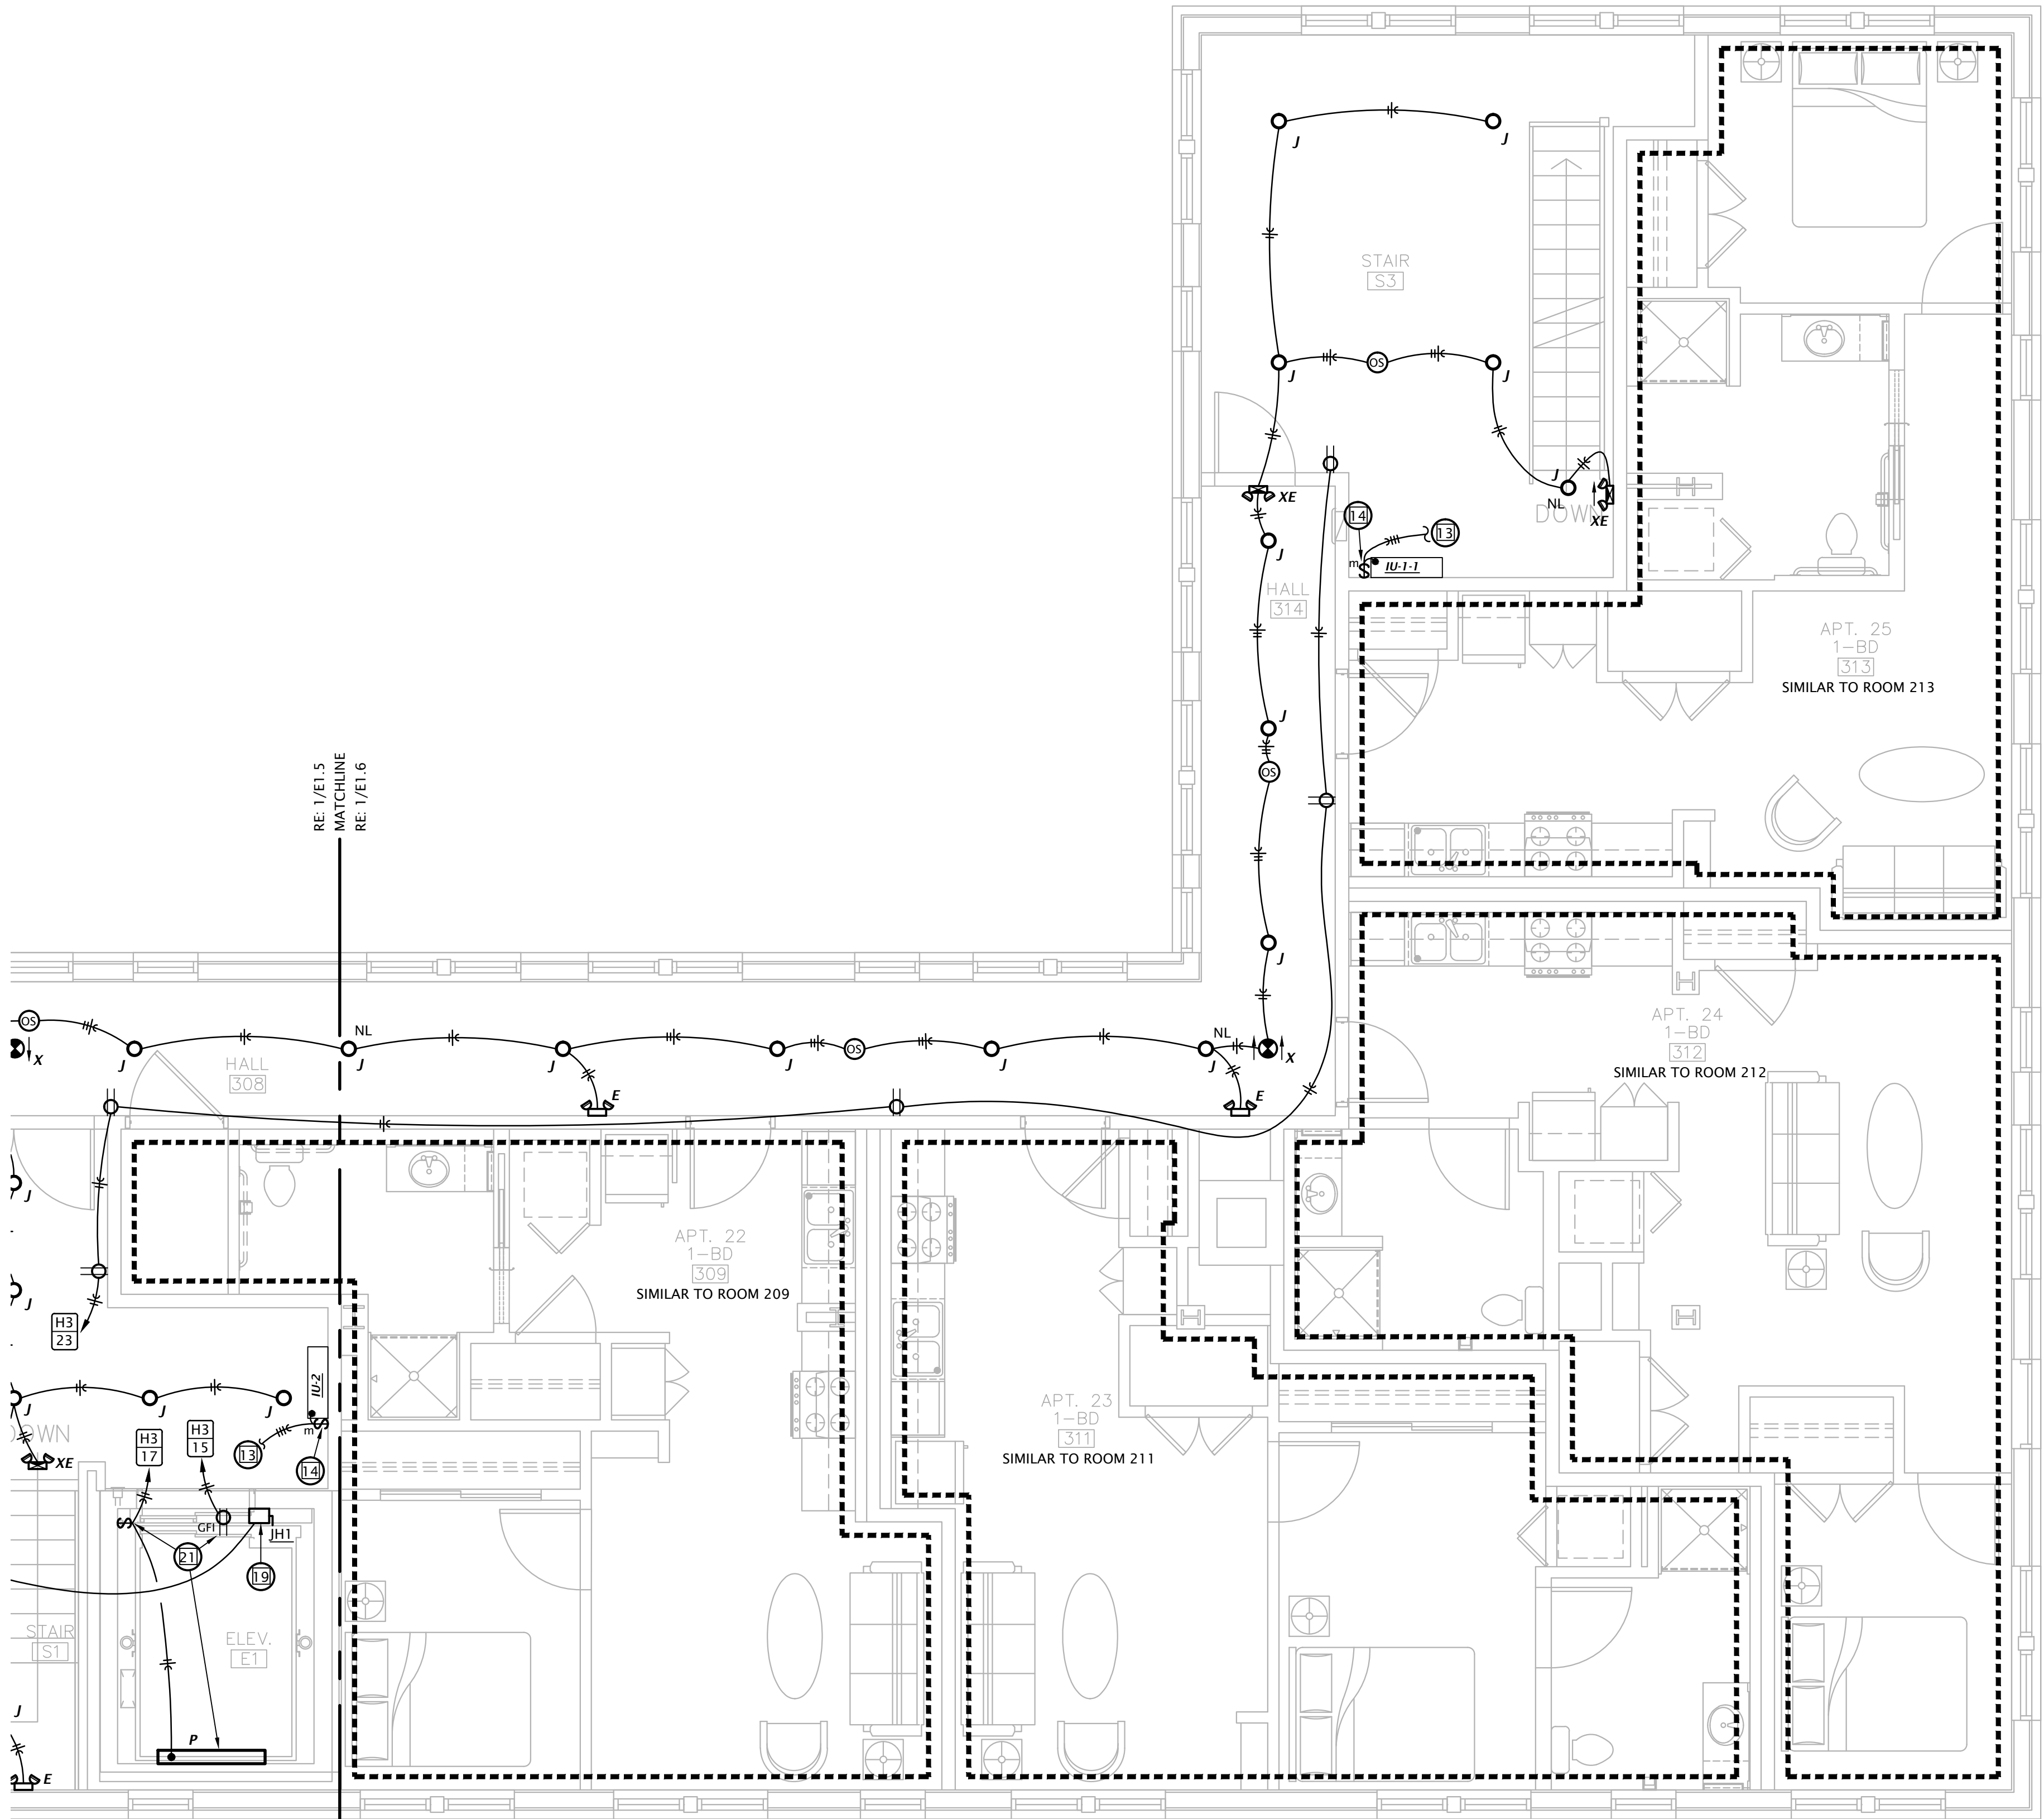

PARTIAL THIRD FLOOR ELECTRICAL PLAN  
1/4" = 1'-0"



REVISION:	1-16-2024
DATE:	1-16-2024
JOB:	21-3166
SHEET NO.:	

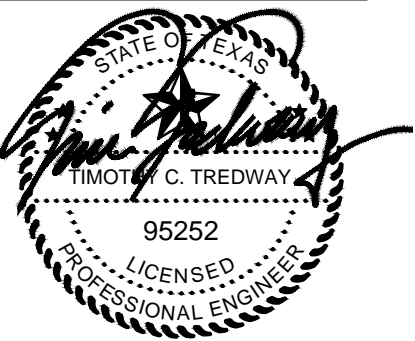


REVISION:	
DATE:	1-16-2024
JOB:	21-3166
SHEET NO.:	

GENERAL ELECTRICAL NOTES

- A. COORDINATE EXACT PANEL OF CIRCUIT ORIGIN FOR RESIDENTIAL TENANT HEAT PUMP UNITS.
- B. ALL CONDUIT PENETRATIONS THROUGH ROOF SHALL OCCUR AT PIPE CURBS ALONG WITH REFRIGERANT PIPING, ETC. COORDINATE CURB LOCATIONS WITH MECHANICAL CONTRACTOR.


# ELECTRICAL PLAN NOTES BY SYMBOL

1. 30A/2P NON-FUSED DISCONNECT SWITCH IN NEMA 3R ENCLOSURE. MOUNT SWITCH TO UNISTRUT FRAME SUPPORTED FROM EQUIPMENT SUPPORT RAILS. MAKE FINAL CONNECTION TO EQUIPMENT IN 'LFMC' RACEWAY.
2. MOUNT RECEPTACLE TO UNISTRUT FRAME SUPPORTED FROM EQUIPMENT SUPPORT RAILS.
3. PROVIDE (3) #12, #12G, 1/2" C FROM OUTDOOR UNIT TO ASSOCIATED INDOOR UNIT (UNIT ID AND LOCATION NOTED).
4. 60A/2P NON-FUSED DISCONNECT SWITCH IN NEMA 3R ENCLOSURE. MOUNT SWITCH TO UNISTRUT FRAME SUPPORTED FROM EQUIPMENT SUPPORT RAILS. MAKE FINAL CONNECTION TO EQUIPMENT IN 'LFMC' RACEWAY.
5. CONNECT TO MOTORIZED DAMPER FOR INTAKE HOOD. COORDINATE WITH MECHANICAL CONTRACTOR.
6. SWITCHED 120V POWER FROM RELAY IN LAUNDRY ROOM 116. SEE SHEET E1.1 FOR CONTINUATION. SEE DETAIL 2, SHEET E6.2.
7. MOUNT FLOOD LIGHT ON STRUCTURAL PLATFORM AND AIM AT SIGN.
8. ROUTE CIRCUIT THROUGH CONTACTOR 'C3'. SEE DETAIL 5, SHEET E6.1.

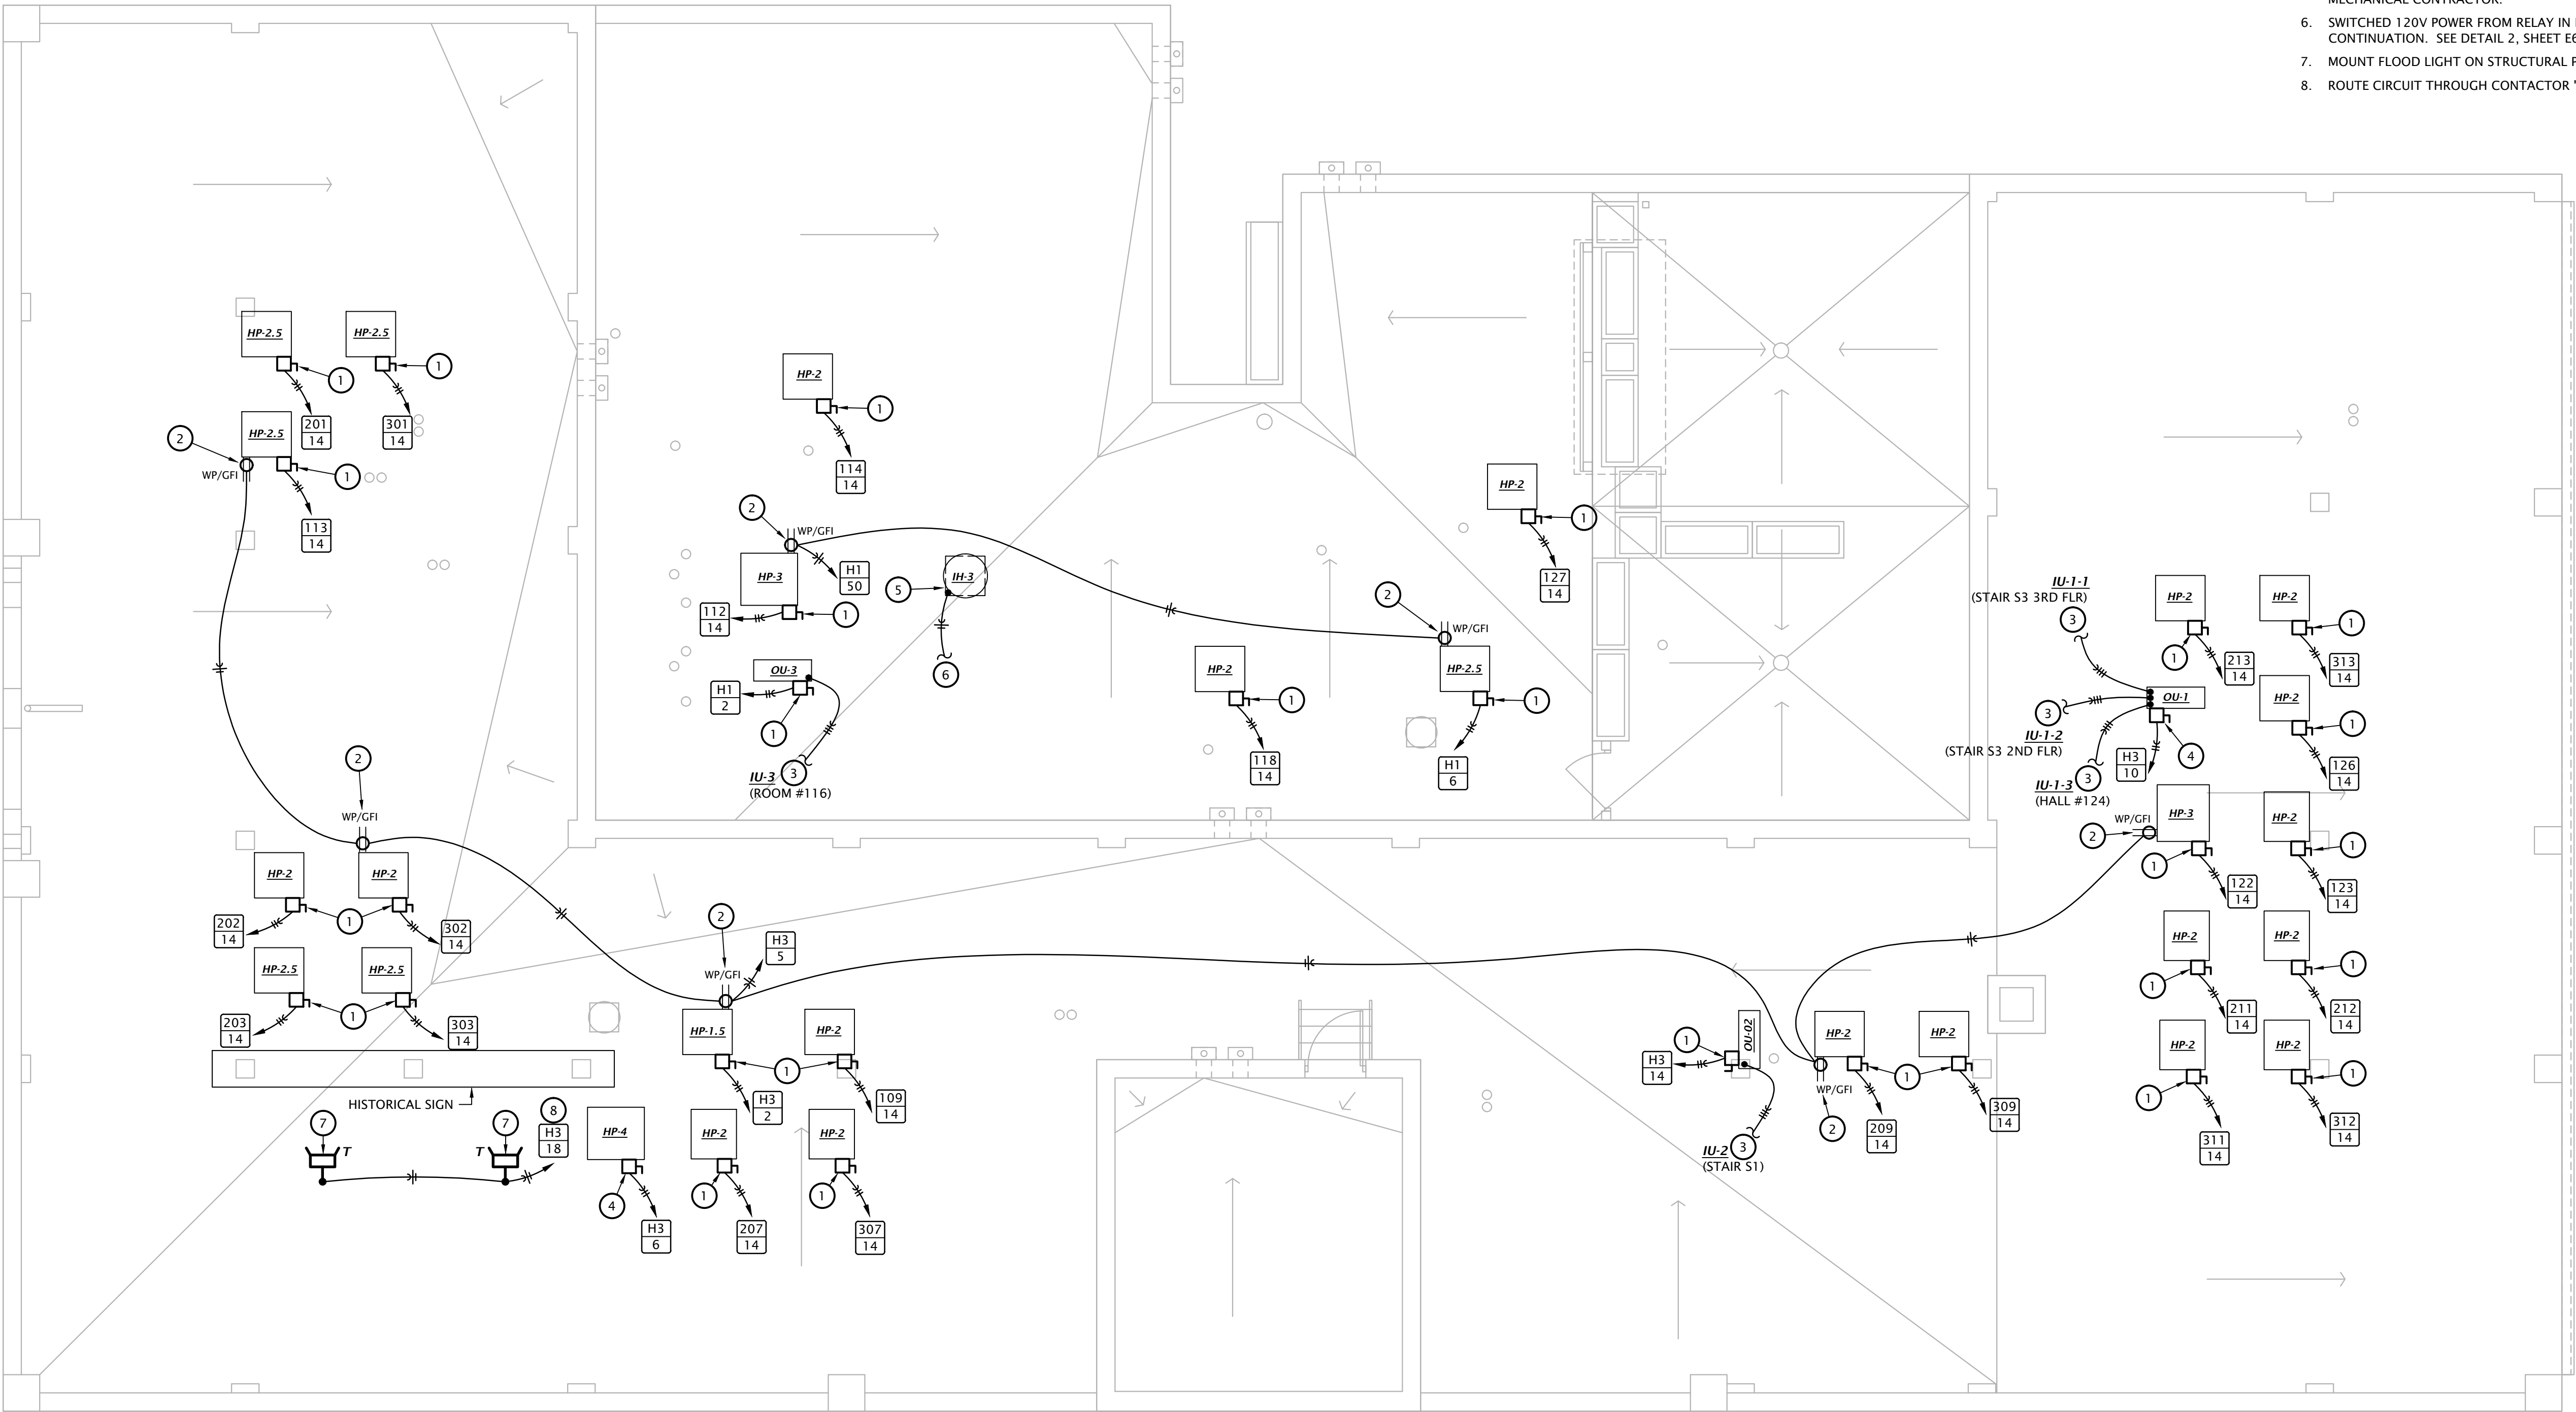

1 ELECTRICAL ROOF PLAN

3/16" = 1'-0"

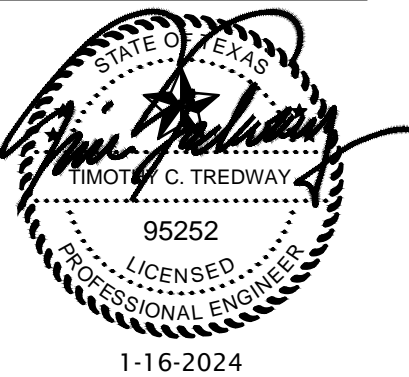

REVISION:


DATE: 1-16-2024

JOB: 21-3166

SHEET NO.:

E1.8

COPYRIGHTED ©

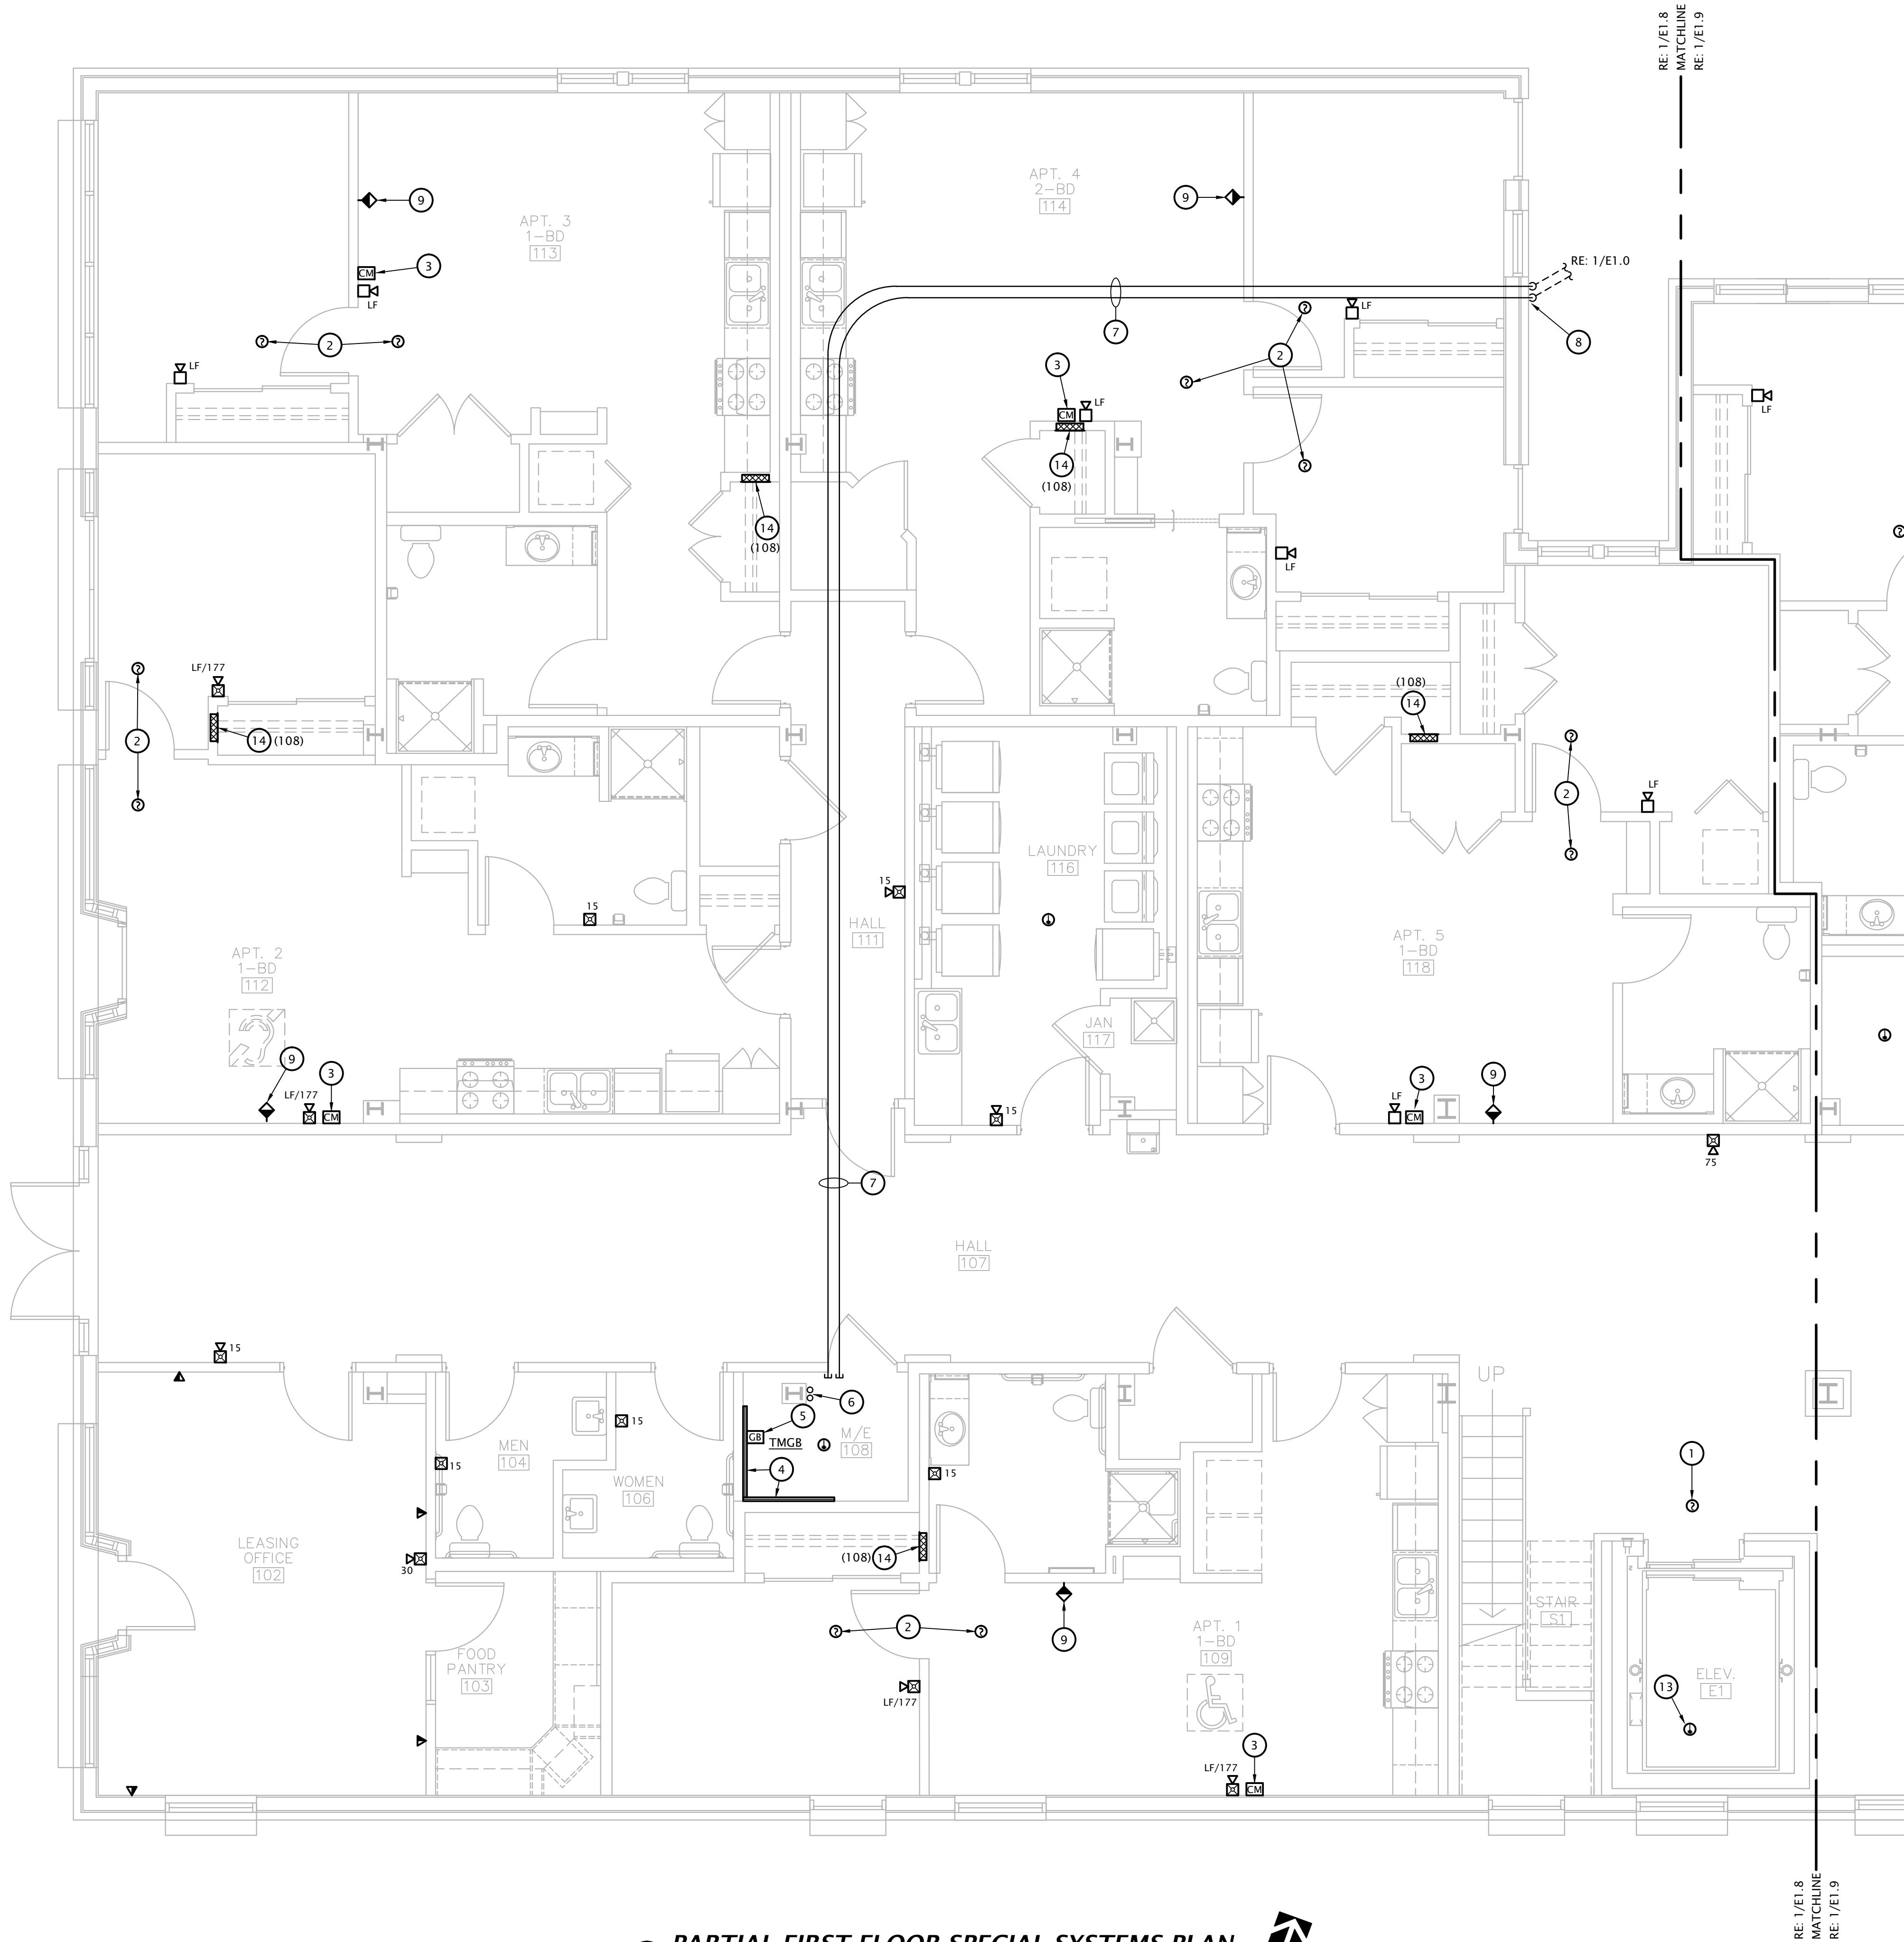

**1 PARTIAL FIRST FLOOR SPECIAL SYSTEMS PLAN**


1/4" = 1'-0"

**# SPECIAL SYSTEMS PLAN NOTES BY SYMBOL**


- ELEVATOR LOBBY HEAT DETECTOR. SEE DETAIL 4:E6.1.
- FIRE ALARM SYSTEM COMBINATION CO / SMOKE DETECTOR.
- FIRE ALARM ADDRESSABLE CONTROL MODULE FOR CONTROL OF APARTMENT UNIT'S NOTIFICATION APPLIANCE CIRCUIT. MODULE SHALL BE PROGRAMMED TO ACTIVATE APARTMENT UNIT'S NOTIFICATION APPLIANCES UPON GENERAL BUILDING FIRE ALARM AND UPON ACTIVATION OF ANY SMOKE DETECTOR OR CO DETECTOR WITHIN APARTMENT UNIT. MOUNT FLUSH IN WALL AT 8'-0" AFF.
- TELEPHONE TERMINAL BOARD: COVER WALL WITH 4'X8'X3/4" ACX FIRE RETARDANT PLYWOOD SHEETS INSTALLED VERTICALLY WITH BOTTOM AT 6" AFF. PLYWOOD SHALL BE PERMANENTLY FASTENED TO THE WALL BY MEANS OF WALL ANCHORS UTILIZING GALVANIZED, ZINC PLATED, OR STAINLESS STEEL HARDWARE WITH A FLAT HEAD. FINISHED INSTALLATION SHALL HAVE FLUSH APPEARANCE WITH COUNTERSUNK SCREW HEADS TO PREVENT SPLITTING OF THE PLYWOOD. DRYWALL SCREWS ARE NOT ACCEPTABLE. PAINT WITH TWO COATS OF LIGHT GRAY FIRE RETARDANT SEALER PRIOR TO INSTALLATION OF ANY EQUIPMENT.
- TELECOMMUNICATIONS GROUND BAR AT 18" AFF. SEE DETAIL 6, SHEET E6.1.
- (2) 4" EMT CONDUIT SLEEVES FROM OVERHEAD IN M/E ROOM 108, THROUGH M/E ROOM 206, AND STUBBED UP 4" ABOVE FINISHED FLOOR OF M/E ROOM 306 FOR COMMUNICATIONS BACKBONE CABLING. PROVIDE WITH FIRESTOPPING FITTINGS (WIREMOLD #FS4R-RED) AT BOTH ENDS.
- (2) 4" CONDUITS FOR COMMUNICATIONS SERVICE CABLING ROUTED CONCEALED OVERHEAD AND STUBBED INTO M/E ROOM 108.
- SEAL CONDUIT PENETRATIONS THROUGH EXTERIOR WALL WEATHERTIGHT.
- COORDINATE FINAL LOCATIONS OF ALL CATV AND PHONE OUTLETS WITH OWNER. SEE 1:E6.2 FOR OUTLET DETAILS.
- ADDRESSABLE FIRE ALARM RELAY FOR ELEVATOR POWER SHUNT-TRIP, AND ADDRESSABLE MONITORING MODULE FOR MONITORING OF SHUNT TRIP VOLTAGE. SEE DETAIL 4:E6.1.
- ADDRESSABLE FIRE ALARM RELAYS FOR ELEVATOR PRIMARY AND ALTERNATE FLOOR RECALL AND FIREMAN'S HAT. MOUNT ON HOISTWAY WALL ABOVE CEILING AND PROVIDE ACCESS PANEL IN CEILING AS REQUIRED. COORDINATE WITH ELEVATOR EQUIPMENT INSTALLER AND G.C. SEE DETAIL 4:E6.1.
- INSTALL SMOKE DETECTOR AND HEAT DETECTOR AT TOP OF ELEVATOR HOISTWAY PER LOCAL JURISDICTION REQUIREMENTS. SEE DETAIL 4:E6.1.
- INSTALL HEAT DETECTOR IN ELEVATOR PIT. SEE DETAIL 4:E6.1.
- TELECOM DISTRIBUTION DEVICE APPROXIMATELY 4'-0" AFF. SEE DETAIL 1:E6.2. COORDINATE EXACT REQUIREMENTS WITH UTILITY PROVIDER SELECTED BY OWNER. HOMERUN CAT6 AND COAX CABLE TO ROOM INDICATED.
- COORDINATE TELECOM OUTLET LOCATION NEAR TOP OF HOISTWAY WITH ELEVATOR INSTALLER.
- PROVIDE FIRE ALARM RELAYS AND MONITORING MODULES FOR ALL FIRE SPRINKLER FLOW SWITCHES, AND BELL/CONG. SEE E1.1 SITE PLAN FOR LOCATION OF TAMPER SWITCHES. COORDINATE QUANTITIES AND LOCATIONS WITH FIRE SPRINKLER CONTRACTOR PRIOR TO BID.

# SPECIAL SYSTEMS PLAN NOTES BY SYMBOL

- ELEVATOR LOBBY HEAT DETECTOR. SEE DETAIL 4:E6.1.
- FIRE ALARM SYSTEM COMBINATION CO / SMOKE DETECTOR.
- FIRE ALARM ADDRESSABLE CONTROL MODULE FOR CONTROL OF APARTMENT UNIT'S NOTIFICATION APPLIANCE CIRCUIT. MODULE SHALL BE PROGRAMMED TO ACTIVATE APARTMENT UNIT'S NOTIFICATION APPLIANCES UPON GENERAL BUILDING FIRE ALARM AND UPON ACTIVATION OF ANY SMOKE DETECTOR OR CO DETECTOR WITHIN APARTMENT UNIT. MOUNT FLUSH IN WALL AT 8'-0" AFF.
- TELEPHONE TERMINAL BOARD: COVER WALL WITH 4'X8'X3/4" ACX FIRE RETARDANT PLYWOOD SHEETS INSTALLED VERTICALLY WITH BOTTOM AT 6" AFF. PLYWOOD SHALL BE PERMANENTLY FASTENED TO THE WALL BY MEANS OF WALL ANCHORS UTILIZING GALVANIZED, ZINC PLATED, OR STAINLESS STEEL HARDWARE WITH A FLAT HEAD. FINISHED INSTALLATION SHALL HAVE FLUSH APPEARANCE WITH COUNTERSUNK SCREW HEADS TO PREVENT SPLITTING OF THE PLYWOOD. DRYWALL SCREWS ARE NOT ACCEPTABLE. PAINT WITH TWO COATS OF LIGHT GRAY FIRE RETARDANT SEALER PRIOR TO INSTALLATION OF ANY EQUIPMENT.
- TELECOMMUNICATIONS GROUND BAR AT 18" AFF. SEE DETAIL 6, SHEET E6.1.
- (2) 4" EMT CONDUIT SLEEVES FROM OVERHEAD IN M/E ROOM 108, THROUGH M/E ROOM 206, AND STUBBED UP 4" ABOVE FINISHED FLOOR OF M/E ROOM 306 FOR COMMUNICATIONS BACKBONE CABLING. P PROVIDE WITH FIRESTOPPING FITTINGS (WIREMOLD #FS4R-RED) AT BOTH ENDS.
- (2) 4" CONDUITS FOR COMMUNICATIONS SERVICE CABLING ROUTED CONCEALED OVERHEAD AND STUBBED INTO M/E ROOM 108.
- SEAL CONDUIT PENETRATIONS THROUGH EXTERIOR WALL WEATHERTIGHT.
- COORDINATE FINAL LOCATIONS OF ALL CATV AND PHONE OUTLETS WITH OWNER. SEE 1:E6.2 FOR OUTLET DETAILS.
- ADDRESSABLE FIRE ALARM RELAY FOR ELEVATOR POWER SHUNT-TRIP, AND ADDRESSABLE MONITORING MODULE FOR MONITORING OF SHUNT TRIP VOLTAGE. SEE DETAIL 4:E6.1.
- ADDRESSABLE FIRE ALARM RELAYS FOR ELEVATOR PRIMARY AND ALTERNATE FLOOR RECALL AND FIREMAN'S HAT. MOUNT ON HOISTWAY WALL ABOVE CEILING AND PROVIDE ACCESS PANEL IN CEILING AS REQUIRED. COORDINATE WITH ELEVATOR EQUIPMENT INSTALLER AND G.C. SEE DETAIL 4:E6.1
- INSTALL SMOKE DETECTOR AND HEAT DETECTOR AT TOP OF ELEVATOR HOISTWAY PER LOCAL JURISDICTION REQUIREMENTS. SEE DETAIL 4:E6.1.
- INSTALL HEAT DETECTOR IN ELEVATOR PIT. SEE DETAIL 4:E6.1.
- TELECOM DISTRIBUTION DEVICE APPROXIMATELY 4'-0" AFF. SEE DETAIL 1:E6.2. COORDINATE EXACT REQUIREMENTS WITH UTILITY PROVIDER SELECTED BY OWNER. HOMERUN CAT6 AND COAX CABLE TO ROOM INDICATED.
- COORDINATE TELECOM OUTLET LOCATION NEAR TOP OF HOISTWAY WITH ELEVATOR INSTALLER.
- PROVIDE FIRE ALARM RELAYS AND MONITORING MODULES FOR ALL FIRE SPRINKLER FLOW SWITCHES, AND BELL/GONG. SEE E1.1 SITE PLAN FOR LOCATION OF TAMPER SWITCHES. COORDINATE QUANTITIES AND LOCATIONS WITH FIRE SPRINKLER CONTRACTOR PRIOR TO BID.

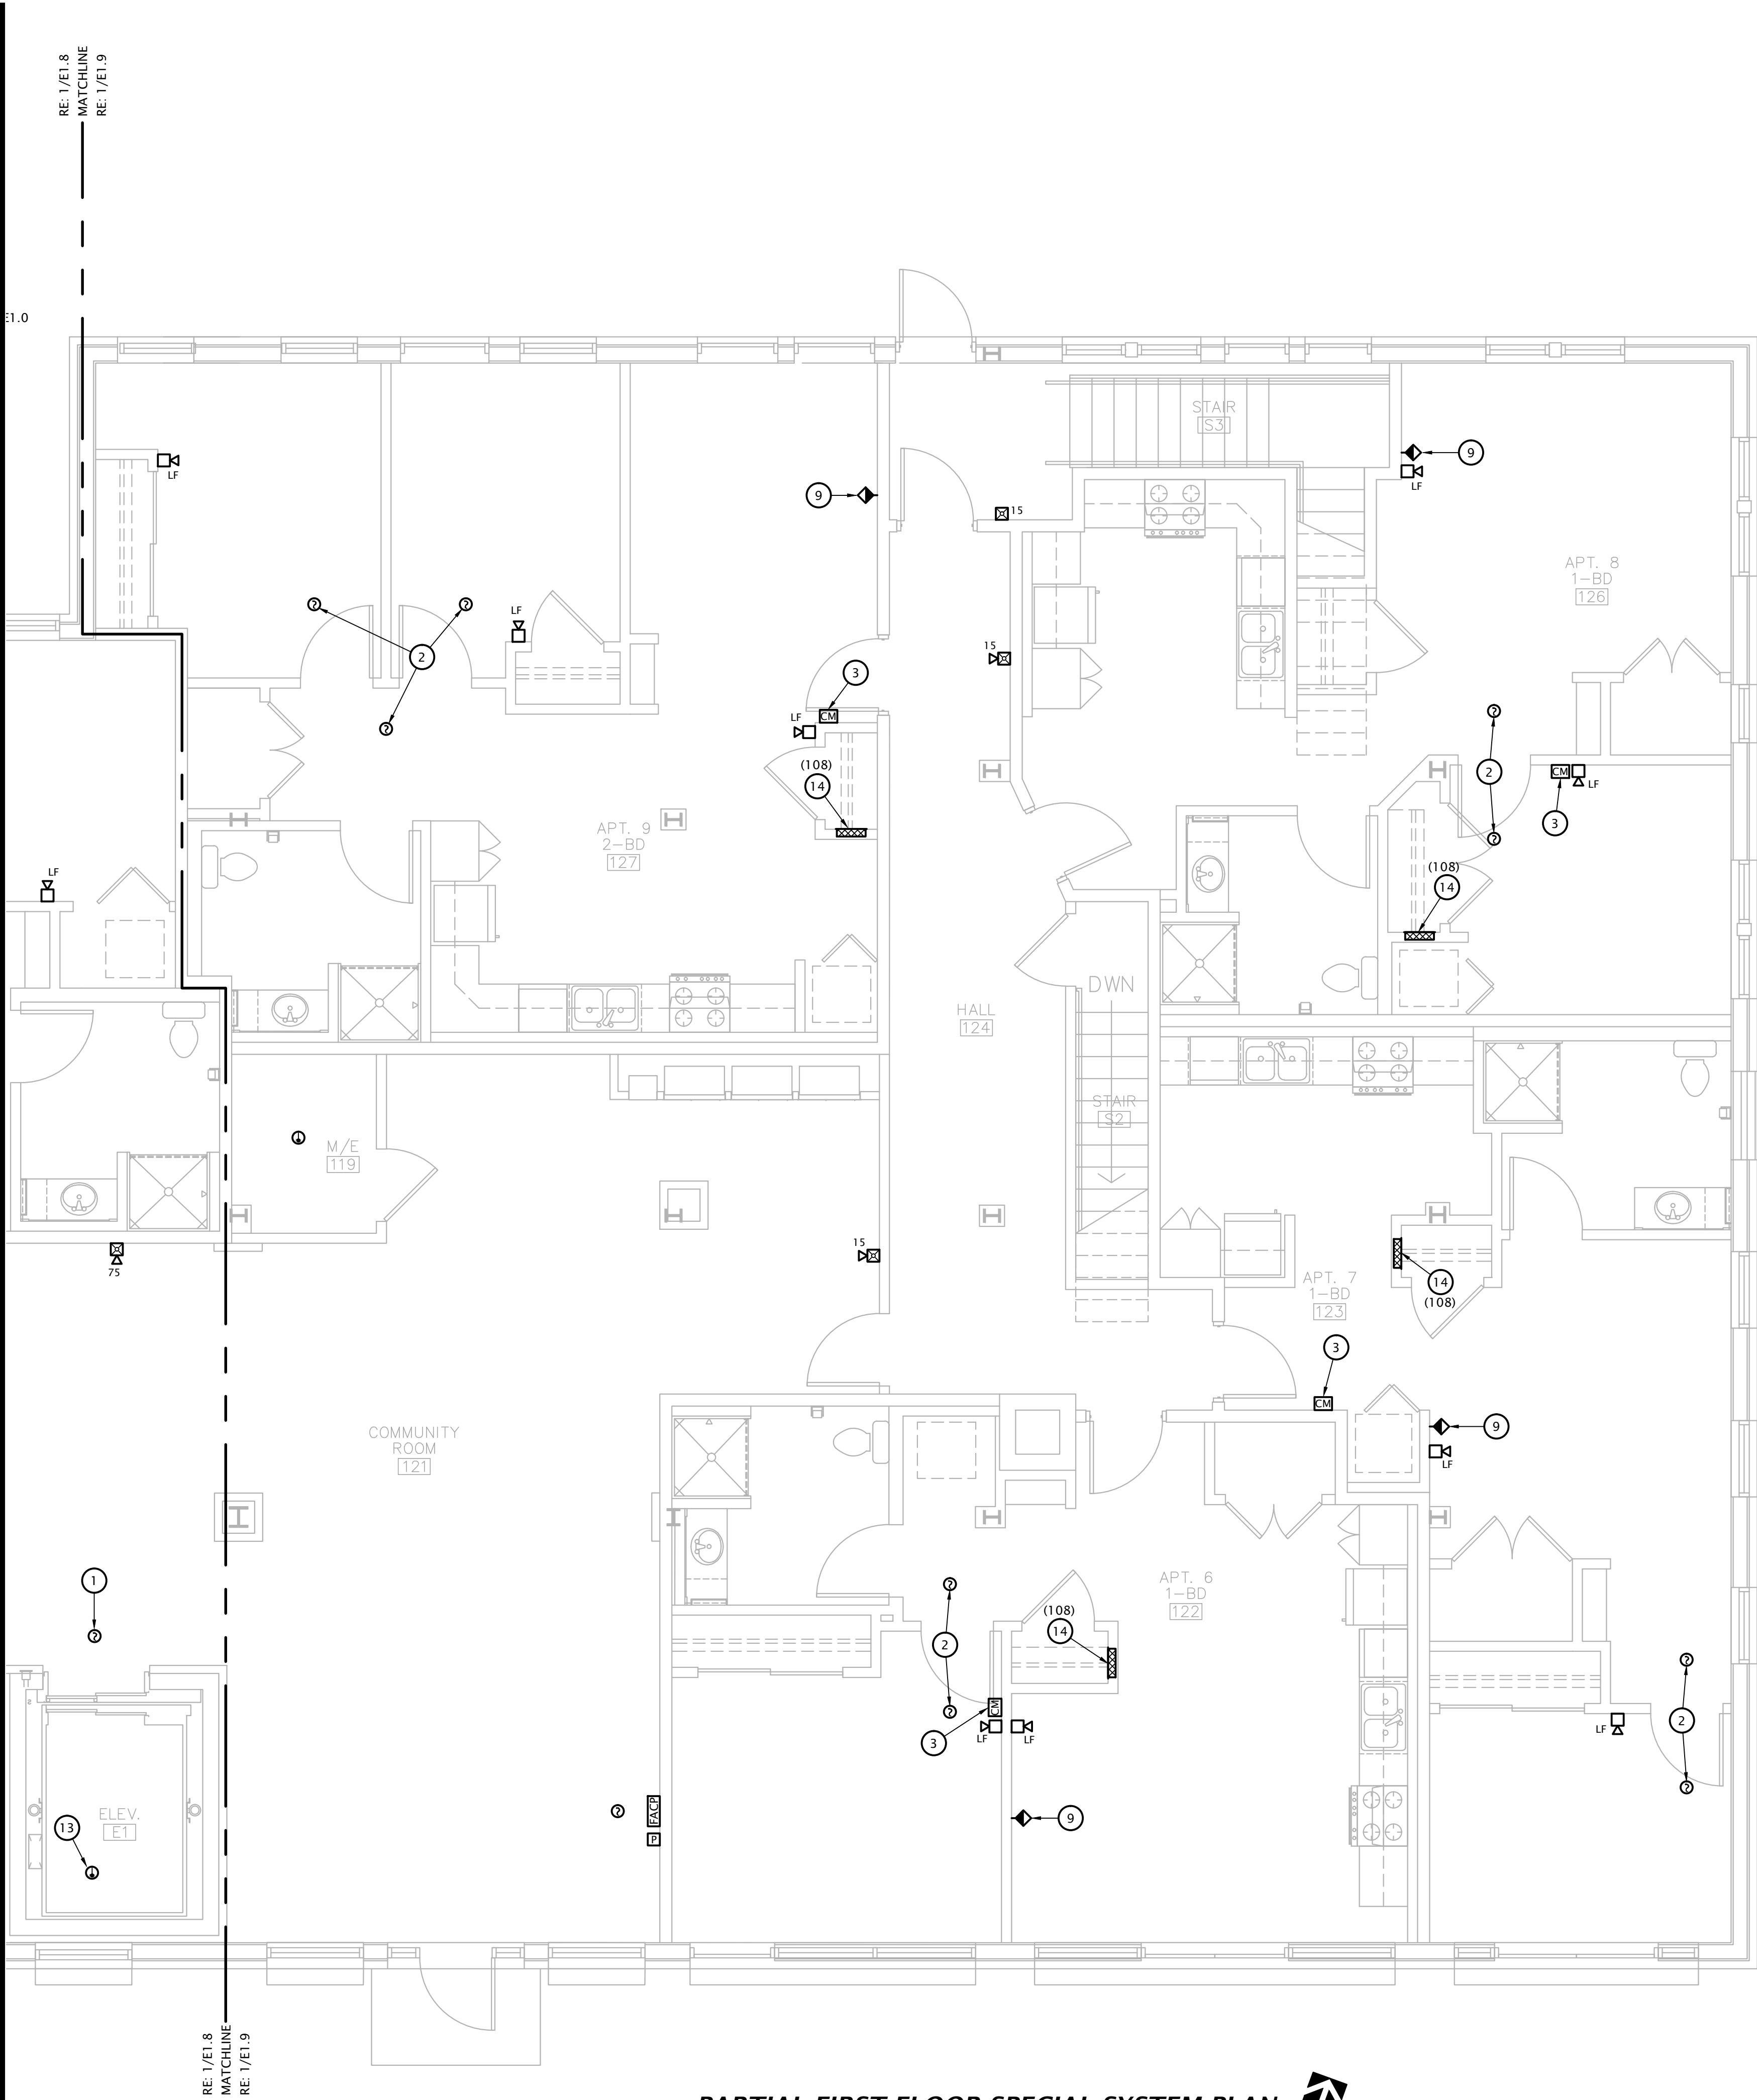


1 PARTIAL FIRST FLOOR SPECIAL SYSTEM PLAN  
1/4" = 1'-0"

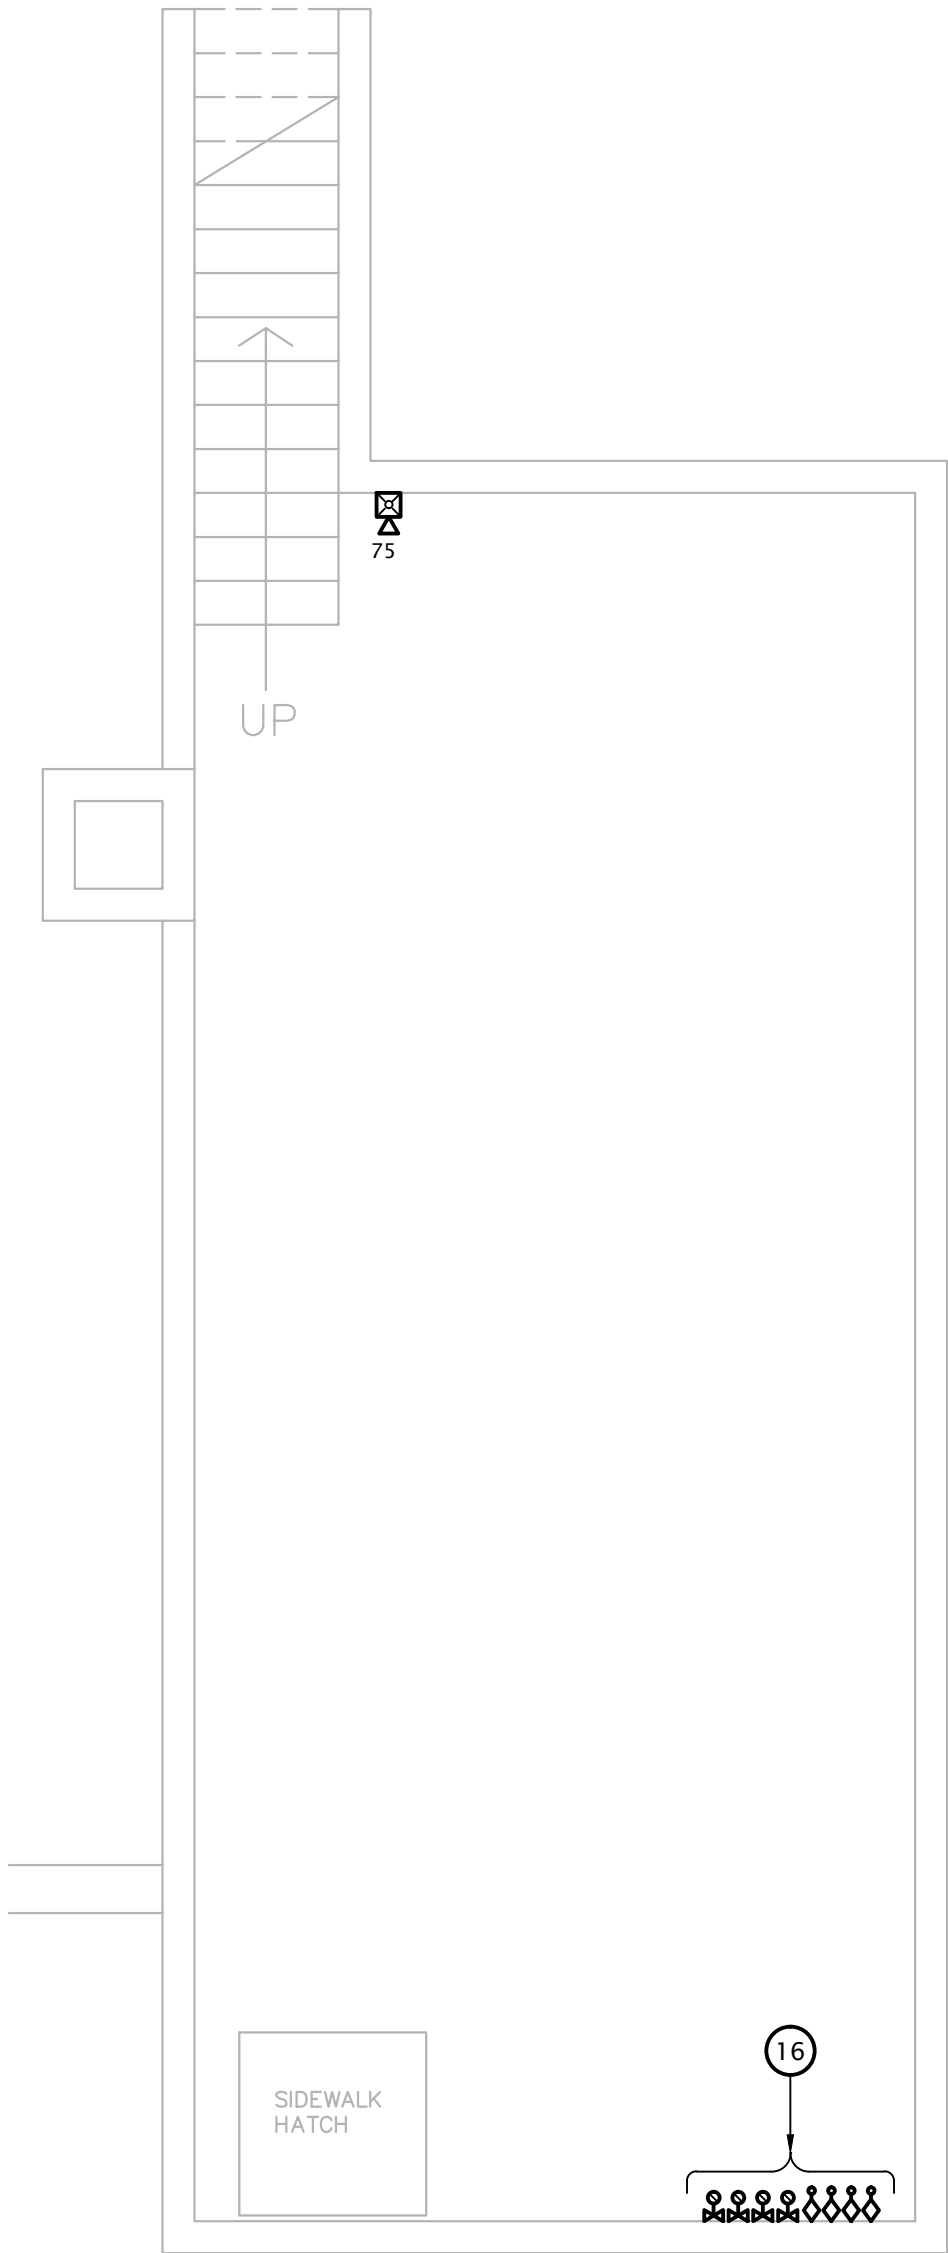

2 BASEMENT SPECIAL SYSTEMS PLAN  
1/4" = 1'-0"

JonesGillamRenz  
730 N. Ninth  
Salina, KS 67401  
785-827-0386  
jgr@jarchitects.com

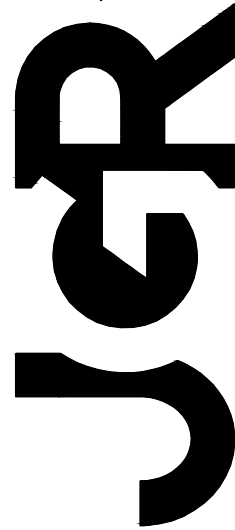

ROOSEVELT LOFTS  
HISTORIC REHABILITATION - APARTMENTS  
SAN ANGELO, TEXAS



REVISION: 1-16-2024

DATE: 1-16-2024

JOB: 21-3166

SHEET NO.:

E1.9

COPYRIGHTED ©

# SPECIAL SYSTEMS PLAN NOTES BY SYMBOL


- ELEVATOR LOBBY HEAT DETECTOR. SEE DETAIL 4:E6.1.
- FIRE ALARM SYSTEM COMBINATION CO / SMOKE DETECTOR.
- FIRE ALARM ADDRESSABLE CONTROL MODULE FOR CONTROL OF APARTMENT UNIT'S NOTIFICATION APPLIANCE CIRCUIT. MODULE SHALL BE PROGRAMMED TO ACTIVATE APARTMENT UNIT'S NOTIFICATION APPLIANCES UPON GENERAL BUILDING FIRE ALARM AND UPON ACTIVATION OF ANY SMOKE DETECTOR OR CO DETECTOR WITHIN APARTMENT UNIT. MOUNT FLUSH IN WALL AT 8'-0" AFF.
- TELEPHONE TERMINAL BOARD: COVER WALL WITH 4'X8'X3/4" ACX FIRE RETARDANT PLYWOOD SHEETS INSTALLED VERTICALLY WITH BOTTOM AT 6" AFF. PLYWOOD SHALL BE PERMANENTLY FASTENED TO THE WALL BY MEANS OF WALL ANCHORS UTILIZING GALVANIZED, ZINC PLATED, OR STAINLESS STEEL HARDWARE WITH A FLAT HEAD. FINISHED INSTALLATION SHALL HAVE FLUSH APPEARANCE WITH COUNTERSUNK SCREW HEADS TO PREVENT SPLITTING OF THE PLYWOOD. DRYWALL SCREWS ARE NOT ACCEPTABLE. PAINT WITH TWO COATS OF LIGHT GRAY FIRE RETARDANT SEALER PRIOR TO INSTALLATION OF ANY EQUIPMENT.
- TELECOMMUNICATIONS GROUND BAR AT 18" AFF. SEE DETAIL 6, SHEET E6.1.
- (2) 4" EMT CONDUIT SLEEVES FROM OVERHEAD IN M/E ROOM 108, THROUGH M/E ROOM 206, AND STUBBED UP 4" ABOVE FINISHED FLOOR OF M/E ROOM 306 FOR COMMUNICATIONS BACKBONE CABLING. P ROVIDE WITH FIRESTOPPING FITTINGS (WIREMOLD #FS4R-RED) AT BOTH ENDS.
- (2) 4" CONDUITS FOR COMMUNICATIONS SERVICE CABLING ROUTED CONCEALED OVERHEAD AND STUBBED INTO M/E ROOM 108.
- SEAL CONDUIT PENETRATIONS THROUGH EXTERIOR WALL WEATHERTIGHT.
- COORDINATE FINAL LOCATIONS OF ALL CATV AND PHONE OUTLETS WITH OWNER. SEE 1:E6.2 FOR OUTLET DETAILS.
- ADDRESSABLE FIRE ALARM RELAY FOR ELEVATOR POWER SHUNT-TRIP, AND ADDRESSABLE MONITORING MODULE FOR MONITORING OF SHUNT TRIP VOLTAGE. SEE DETAIL 4:E6.1.
- ADDRESSABLE FIRE ALARM RELAYS FOR ELEVATOR PRIMARY AND ALTERNATE FLOOR RECALL AND FIREMAN'S HAT. MOUNT ON HOISTWAY WALL ABOVE CEILING AND PROVIDE ACCESS PANEL IN CEILING AS REQUIRED. COORDINATE WITH ELEVATOR EQUIPMENT INSTALLER AND G.C. SEE DETAIL 4:E6.1
- INSTALL SMOKE DETECTOR AND HEAT DETECTOR AT TOP OF ELEVATOR HOISTWAY PER LOCAL JURISDICTION REQUIREMENTS. SEE DETAIL 4:E6.1.
- INSTALL HEAT DETECTOR IN ELEVATOR PIT. SEE DETAIL 4:E6.1.
- TELECOM DISTRIBUTION DEVICE APPROXIMATELY 4'-0" AFF. SEE DETAIL 1:E6.2. COORDINATE EXACT REQUIREMENTS WITH UTILITY PROVIDER SELECTED BY OWNER. HOMERUN CAT6 AND COAX CABLE TO ROOM INDICATED.
- COORDINATE TELECOM OUTLET LOCATION NEAR TOP OF HOISTWAY WITH ELEVATOR INSTALLER.
- PROVIDE FIRE ALARM RELAYS AND MONITORING MODULES FOR ALL FIRE SPRINKLER FLOW SWITCHES, AND BELL/GONG. SEE E1.1 SITE PLAN FOR LOCATION OF TAMPER SWITCHES. COORDINATE QUANTITIES AND LOCATIONS WITH FIRE SPRINKLER CONTRACTOR PRIOR TO BID.



1 PARTIAL SECOND FLOOR SPECIAL SYSTEMS PLAN

1/4" = 1'-0"



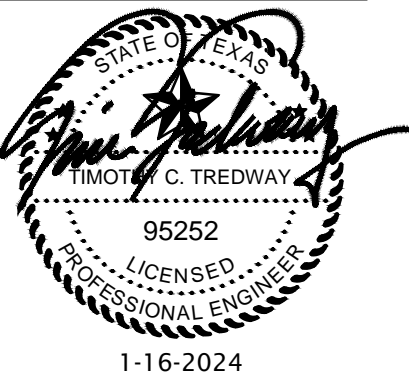

REVISION:


DATE: 1-16-2024

JOB: 21-3166

SHEET NO.:

E1.11


COPYRIGHTED ©

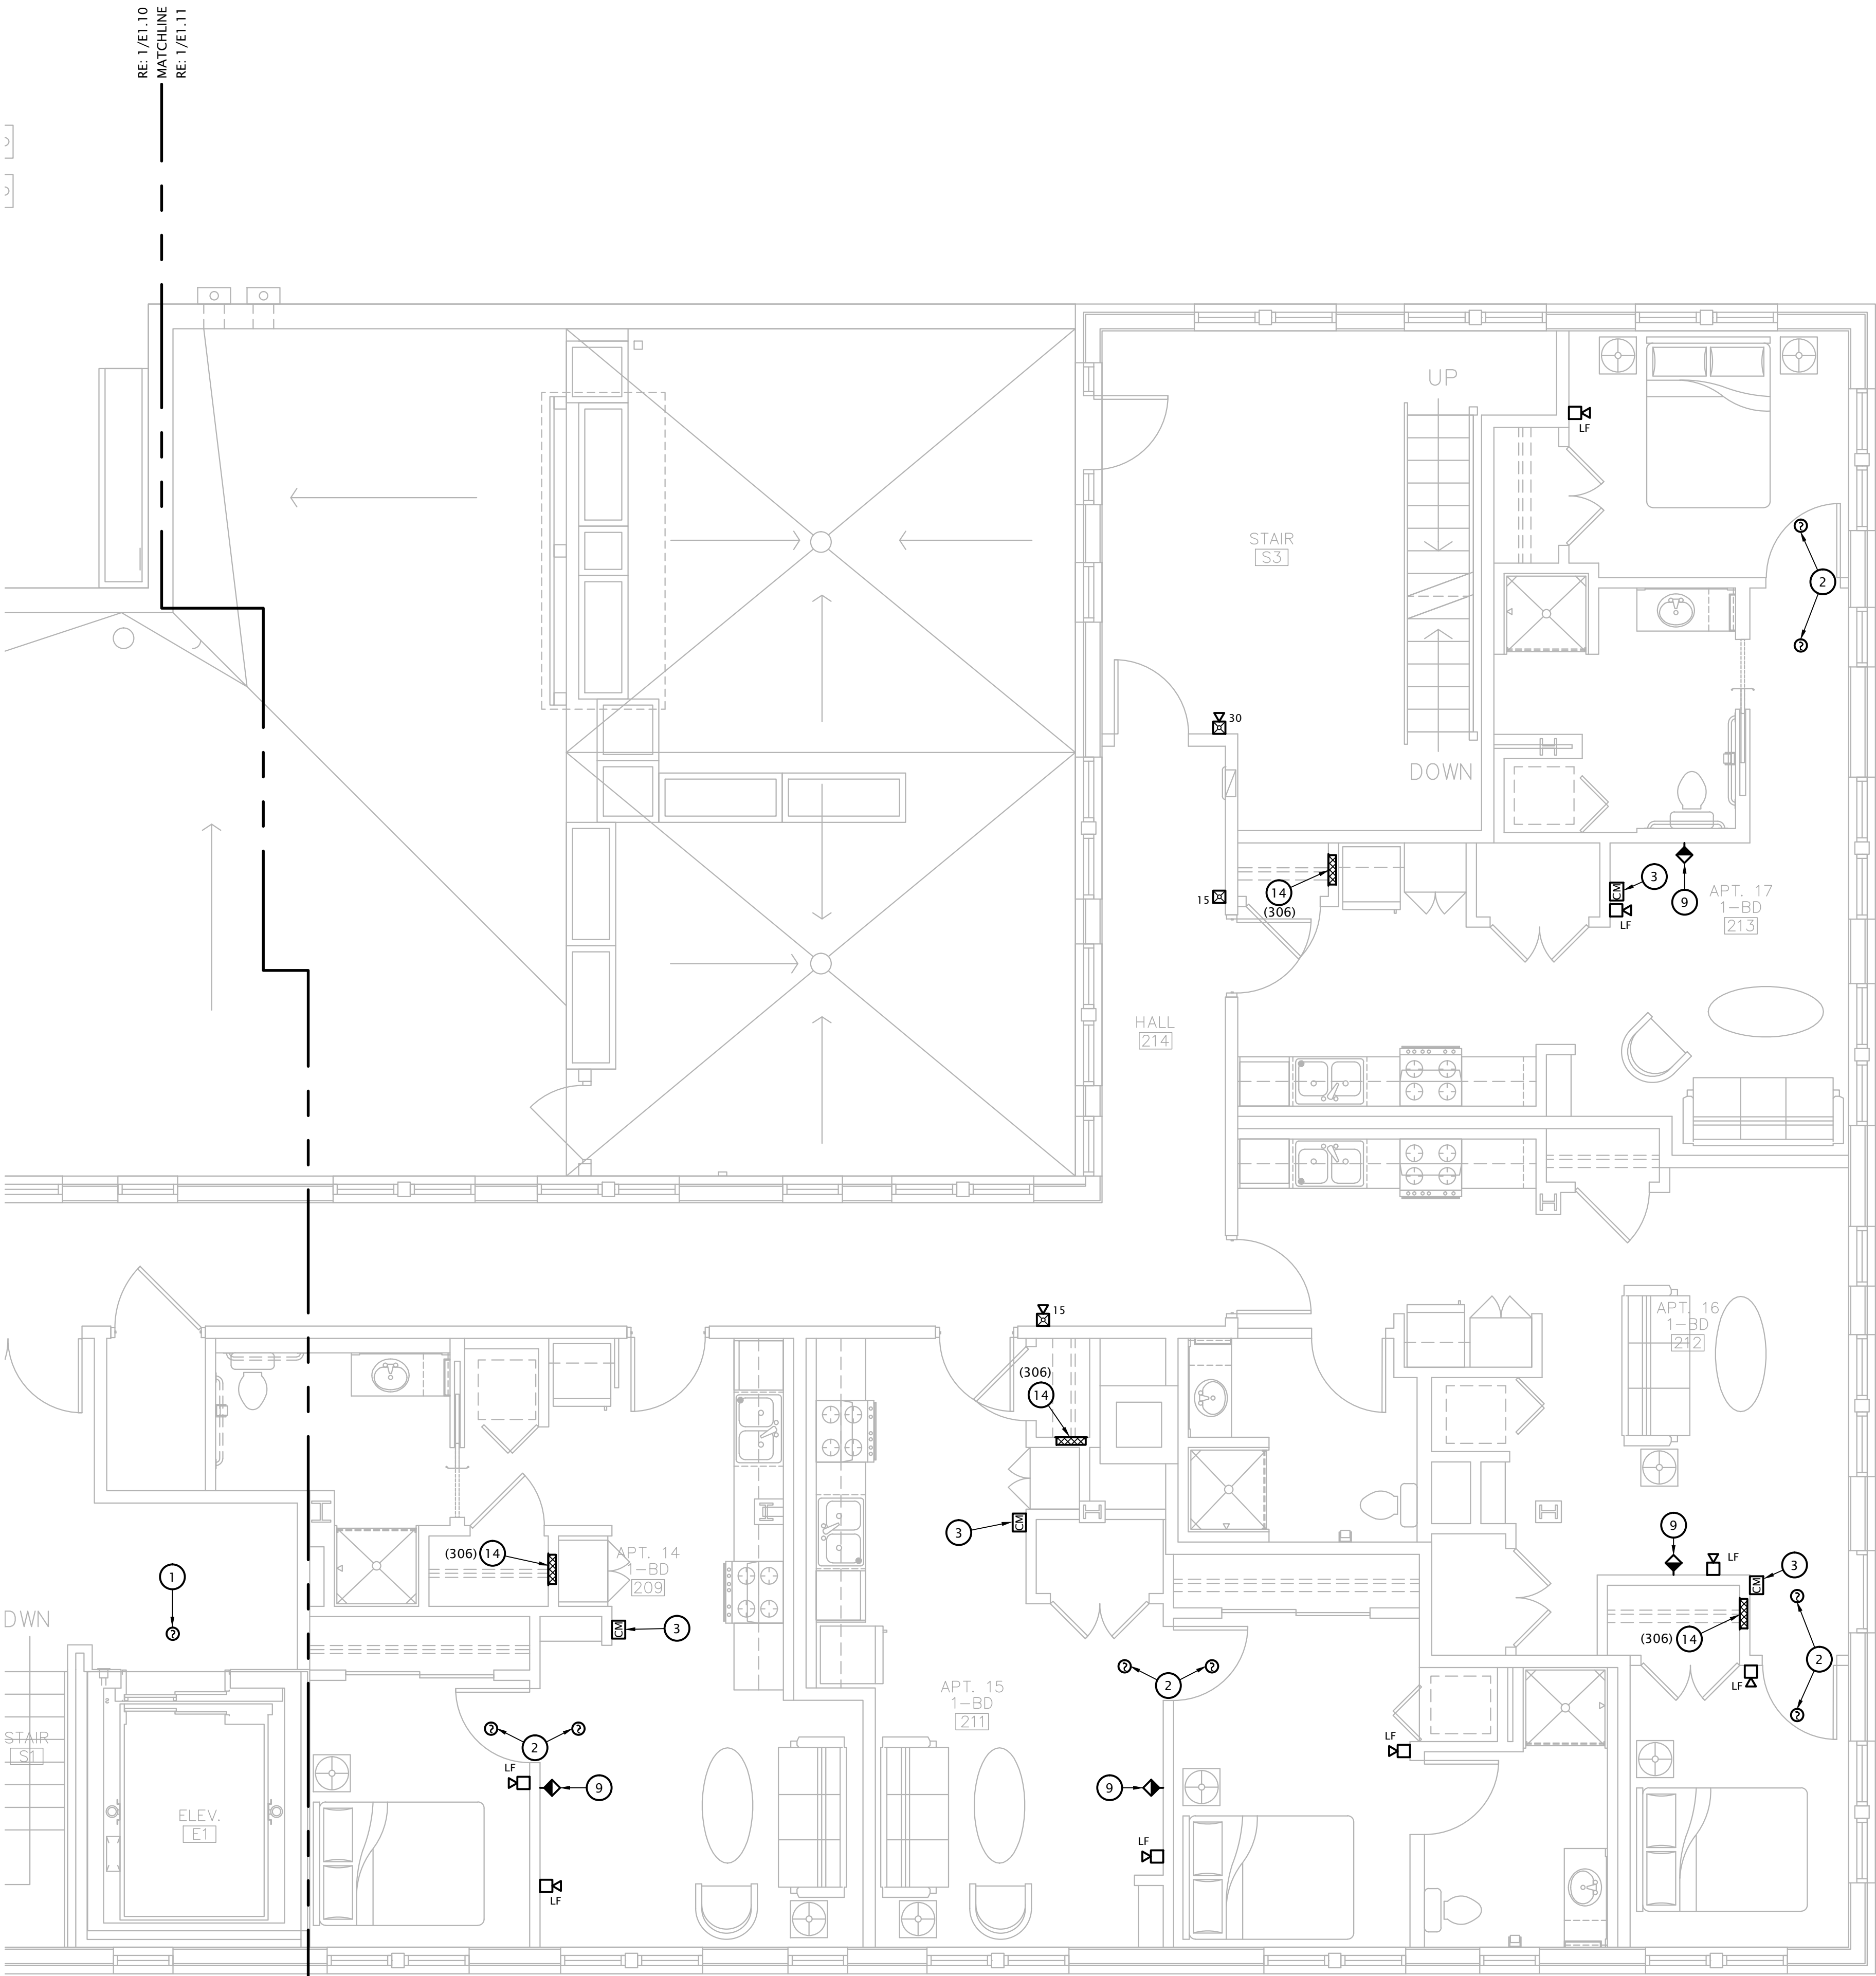

**1 PARTIAL SECOND FLOOR SPECIAL SYSTEMS PLAN**  
1/4" = 1'-0"

**# SPECIAL SYSTEMS PLAN NOTES BY SYMBOL**

- ELEVATOR LOBBY HEAT DETECTOR. SEE DETAIL 4:E6.1.
- FIRE ALARM SYSTEM COMBINATION CO / SMOKE DETECTOR.
- FIRE ALARM ADDRESSABLE CONTROL MODULE FOR CONTROL OF APARTMENT UNIT'S NOTIFICATION APPLIANCE CIRCUIT. MODULE SHALL BE PROGRAMMED TO ACTIVATE APARTMENT UNIT'S NOTIFICATION APPLIANCES UPON GENERAL BUILDING FIRE ALARM AND UPON ACTIVATION OF ANY SMOKE DETECTOR OR CO DETECTOR WITHIN APARTMENT UNIT. MOUNT FLUSH IN WALL AT 8'-0" AFF.
- TELEPHONE TERMINAL BOARD: COVER WALL WITH 4'X8'X3/4" ACX FIRE RETARDANT PLYWOOD SHEETS INSTALLED VERTICALLY WITH BOTTOM AT 6" AFF. PLYWOOD SHALL BE PERMANENTLY FASTENED TO THE WALL BY MEANS OF WALL ANCHORS UTILIZING GALVANIZED, ZINC PLATED, OR STAINLESS STEEL HARDWARE WITH A FLAT HEAD. FINISHED INSTALLATION SHALL HAVE FLUSH APPEARANCE WITH COUNTERSUNK SCREW HEADS TO PREVENT SPLITTING OF THE PLYWOOD. DRYWALL SCREWS ARE NOT ACCEPTABLE. PAINT WITH TWO COATS OF LIGHT GRAY FIRE RETARDANT SEALER PRIOR TO INSTALLATION OF ANY EQUIPMENT.
- TELECOMMUNICATIONS GROUND BAR AT 18" AFF. SEE DETAIL 6, SHEET E6.1.
- (2) 4" EMT CONDUIT SLEEVES FROM OVERHEAD IN M/E ROOM 108, THROUGH M/E ROOM 206, AND STUBBED UP 4" ABOVE FINISHED FLOOR OF M/E ROOM 306 FOR COMMUNICATIONS BACKBONE CABLING. PROVIDE WITH FIRESTOPPING FITTINGS (WIREMOLD #FS4R-RED) AT BOTH ENDS.
- (2) 4" CONDUITS FOR COMMUNICATIONS SERVICE CABLING ROUTED CONCEALED OVERHEAD AND STUBBED INTO M/E ROOM 108.
- SEAL CONDUIT PENETRATIONS THROUGH EXTERIOR WALL WEATHERTIGHT.
- COORDINATE FINAL LOCATIONS OF ALL CATV AND PHONE OUTLETS WITH OWNER. SEE 1:E6.2 FOR OUTLET DETAILS.
- ADDRESSABLE FIRE ALARM RELAY FOR ELEVATOR POWER SHUNT-TRIP, AND ADDRESSABLE MONITORING MODULE FOR MONITORING OF SHUNT TRIP VOLTAGE. SEE DETAIL 4:E6.1.
- ADDRESSABLE FIRE ALARM RELAYS FOR ELEVATOR PRIMARY AND ALTERNATE FLOOR RECALL AND FIREMAN'S HAT. MOUNT ON HOISTWAY WALL ABOVE CEILING AND PROVIDE ACCESS PANEL IN CEILING AS REQUIRED. COORDINATE WITH ELEVATOR EQUIPMENT INSTALLER AND G.C. SEE DETAIL 4:E6.1
- INSTALL SMOKE DETECTOR AND HEAT DETECTOR AT TOP OF ELEVATOR HOISTWAY PER LOCAL JURISDICTION REQUIREMENTS. SEE DETAIL 4:E6.1.
- INSTALL HEAT DETECTOR IN ELEVATOR PIT. SEE DETAIL 4:E6.1.
- TELECOM DISTRIBUTION DEVICE APPROXIMATELY 4'-0" AFF. SEE DETAIL 1:E6.2. COORDINATE EXACT REQUIREMENTS WITH UTILITY PROVIDER SELECTED BY OWNER. HOMERUN CAT6 AND COAX CABLE TO ROOM INDICATED.
- COORDINATE TELECOM OUTLET LOCATION NEAR TOP OF HOISTWAY WITH ELEVATOR INSTALLER.
- PROVIDE FIRE ALARM RELAYS AND MONITORING MODULES FOR ALL FIRE SPRINKLER FLOW SWITCHES, AND BELL/GONG. SEE E1.1 SITE PLAN FOR LOCATION OF TAMPER SWITCHES. COORDINATE QUANTITIES AND LOCATIONS WITH FIRE SPRINKLER CONTRACTOR PRIOR TO BID.

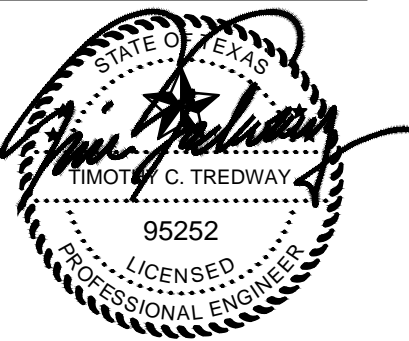

REVISION:

DATE: 1-16-2024

JOB: 21-3166

SHEET NO.:

E1.12


COPYRIGHTED ©



**1 PARTIAL THIRD FLOOR SPECIAL SYSTEMS PLAN**  
1/4" = 1'-0"

**# SPECIAL SYSTEMS PLAN NOTES BY SYMBOL**

- ELEVATOR LOBBY HEAT DETECTOR. SEE DETAIL 4:E6.1.
- FIRE ALARM SYSTEM COMBINATION CO / SMOKE DETECTOR.
- FIRE ALARM ADDRESSABLE CONTROL MODULE FOR CONTROL OF APARTMENT UNIT'S NOTIFICATION APPLIANCE CIRCUIT. MODULE SHALL BE PROGRAMMED TO ACTIVATE APARTMENT UNIT'S NOTIFICATION APPLIANCES UPON GENERAL BUILDING FIRE ALARM AND UPON ACTIVATION OF ANY SMOKE DETECTOR OR CO DETECTOR WITHIN APARTMENT UNIT. MOUNT FLUSH IN WALL AT 8'-0" AFF.
- TELEPHONE TERMINAL BOARD: COVER WALL WITH 4'X8'X3/4" ACX FIRE RETARDANT PLYWOOD SHEETS INSTALLED VERTICALLY WITH BOTTOM AT 6" AFF. PLYWOOD SHALL BE PERMANENTLY FASTENED TO THE WALL BY MEANS OF WALL ANCHORS UTILIZING GALVANIZED, ZINC PLATED, OR STAINLESS STEEL HARDWARE WITH A FLAT HEAD. FINISHED INSTALLATION SHALL HAVE FLUSH APPEARANCE WITH COUNTERSUNK SCREW HEADS TO PREVENT SPLITTING OF THE PLYWOOD. DRYWALL SCREWS ARE NOT ACCEPTABLE. PAINT WITH TWO COATS OF LIGHT GRAY FIRE RETARDANT SEALER PRIOR TO INSTALLATION OF ANY EQUIPMENT.
- TELECOMMUNICATIONS GROUND BAR AT 18" AFF. SEE DETAIL 6, SHEET E6.1.
- (2) 4" EMT CONDUIT SLEEVES FROM OVERHEAD IN M/E ROOM 108, THROUGH M/E ROOM 206, AND STUBBED UP 4" ABOVE FINISHED FLOOR OF M/E ROOM 306 FOR COMMUNICATIONS BACKBONE CABLING. PROVIDE WITH FIRESTOPPING FITTINGS (WIREMOLD #FS4R-RED) AT BOTH ENDS.
- (2) 4" CONDUITS FOR COMMUNICATIONS SERVICE CABLING ROUTED CONCEALED OVERHEAD AND STUBBED INTO M/E ROOM 108.
- SEAL CONDUIT PENETRATIONS THROUGH EXTERIOR WALL WEATHERTIGHT.
- COORDINATE FINAL LOCATIONS OF ALL CATV AND PHONE OUTLETS WITH OWNER. SEE 1:E6.2 FOR OUTLET DETAILS.
- ADDRESSABLE FIRE ALARM RELAY FOR ELEVATOR POWER SHUNT-TRIP, AND ADDRESSABLE MONITORING MODULE FOR MONITORING OF SHUNT TRIP VOLTAGE. SEE DETAIL 4:E6.1.
- ADDRESSABLE FIRE ALARM RELAYS FOR ELEVATOR PRIMARY AND ALTERNATE FLOOR RECALL AND FIREMAN'S HAT. MOUNT ON HOISTWAY WALL ABOVE CEILING AND PROVIDE ACCESS PANEL IN CEILING AS REQUIRED. COORDINATE WITH ELEVATOR EQUIPMENT INSTALLER AND G.C. SEE DETAIL 4:E6.1.
- INSTALL SMOKE DETECTOR AND HEAT DETECTOR AT TOP OF ELEVATOR HOISTWAY PER LOCAL JURISDICTION REQUIREMENTS. SEE DETAIL 4:E6.1.
- INSTALL HEAT DETECTOR IN ELEVATOR PIT. SEE DETAIL 4:E6.1.
- TELECOM DISTRIBUTION DEVICE APPROXIMATELY 4'-0" AFF. SEE DETAIL 1:E6.2. COORDINATE EXACT REQUIREMENTS WITH UTILITY PROVIDER SELECTED BY OWNER. HOMERUN CAT6 AND COAX CABLE TO ROOM INDICATED.
- COORDINATE TELECOM OUTLET LOCATION NEAR TOP OF HOISTWAY WITH ELEVATOR INSTALLER.
- PROVIDE FIRE ALARM RELAYS AND MONITORING MODULES FOR ALL FIRE SPRINKLER FLOW SWITCHES, AND BELL/GONG. SEE E1.1 SITE PLAN FOR LOCATION OF TAMPER SWITCHES. COORDINATE QUANTITIES AND LOCATIONS WITH FIRE SPRINKLER CONTRACTOR PRIOR TO BID.

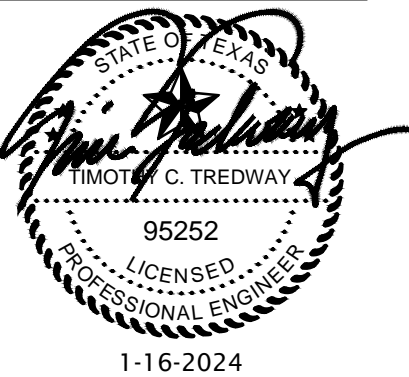

REVISION:

DATE: 1-16-2024

JOB: 21-3166


SHEET NO.:

E1.13

COPYRIGHTED ©

# SPECIAL SYSTEMS PLAN NOTES BY SYMBOL


- ELEVATOR LOBBY HEAT DETECTOR. SEE DETAIL 4:E6.1.
- FIRE ALARM SYSTEM COMBINATION CO / SMOKE DETECTOR.
- FIRE ALARM ADDRESSABLE CONTROL MODULE FOR CONTROL OF APARTMENT UNIT'S NOTIFICATION APPLIANCE CIRCUIT. MODULE SHALL BE PROGRAMMED TO ACTIVATE APARTMENT UNIT'S NOTIFICATION APPLIANCES UPON GENERAL BUILDING FIRE ALARM AND UPON ACTIVATION OF ANY SMOKE DETECTOR OR CO DETECTOR WITHIN APARTMENT UNIT. MOUNT FLUSH IN WALL AT 8'-0" AFF.
- TELEPHONE TERMINAL BOARD: COVER WALL WITH 4'X8'X3/4" ACX FIRE RETARDANT PLYWOOD SHEETS INSTALLED VERTICALLY WITH BOTTOM AT 6" AFF. PLYWOOD SHALL BE PERMANENTLY FASTENED TO THE WALL BY MEANS OF WALL ANCHORS UTILIZING GALVANIZED, ZINC PLATED, OR STAINLESS STEEL HARDWARE WITH A FLAT HEAD. FINISHED INSTALLATION SHALL HAVE FLUSH APPEARANCE WITH COUNTERSUNK SCREW HEADS TO PREVENT SPLITTING OF THE PLYWOOD. DRYWALL SCREWS ARE NOT ACCEPTABLE. PAINT WITH TWO COATS OF LIGHT GRAY FIRE RETARDANT SEALER PRIOR TO INSTALLATION OF ANY EQUIPMENT.
- TELECOMMUNICATIONS GROUND BAR AT 18" AFF. SEE DETAIL 6, SHEET E6.1.
- (2) 4" EMT CONDUIT SLEEVES FROM OVERHEAD IN M/E ROOM 108, THROUGH M/E ROOM 206, AND STUBBED UP 4" ABOVE FINISHED FLOOR OF M/E ROOM 306 FOR COMMUNICATIONS BACKBONE CABLING. PROVIDE WITH FIRESTOPPING FITTINGS (WIREMOLD #FS4R-RED) AT BOTH ENDS.
- (2) 4" CONDUITS FOR COMMUNICATIONS SERVICE CABLING ROUTED CONCEALED OVERHEAD AND STUBBED INTO M/E ROOM 108.
- SEAL CONDUIT PENETRATIONS THROUGH EXTERIOR WALL WEATHERTIGHT.
- COORDINATE FINAL LOCATIONS OF ALL CATV AND PHONE OUTLETS WITH OWNER. SEE 1:E6.2 FOR OUTLET DETAILS.
- ADDRESSABLE FIRE ALARM RELAY FOR ELEVATOR POWER SHUNT-TRIP, AND ADDRESSABLE MONITORING MODULE FOR MONITORING OF SHUNT TRIP VOLTAGE. SEE DETAIL 4:E6.1.
- ADDRESSABLE FIRE ALARM RELAYS FOR ELEVATOR PRIMARY AND ALTERNATE FLOOR RECALL AND FIREMAN'S HAT. MOUNT ON HOISTWAY WALL ABOVE CEILING AND PROVIDE ACCESS PANEL IN CEILING AS REQUIRED. COORDINATE WITH ELEVATOR EQUIPMENT INSTALLER AND G.C. SEE DETAIL 4:E6.1
- INSTALL SMOKE DETECTOR AND HEAT DETECTOR AT TOP OF ELEVATOR HOISTWAY PER LOCAL JURISDICTION REQUIREMENTS. SEE DETAIL 4:E6.1.
- INSTALL HEAT DETECTOR IN ELEVATOR PIT. SEE DETAIL 4:E6.1.
- TELECOM DISTRIBUTION DEVICE APPROXIMATELY 4'-0" AFF. SEE DETAIL 1:E6.2. COORDINATE EXACT REQUIREMENTS WITH UTILITY PROVIDER SELECTED BY OWNER. HOMERUN CAT6 AND COAX CABLE TO ROOM INDICATED.
- COORDINATE TELECOM OUTLET LOCATION NEAR TOP OF HOISTWAY WITH ELEVATOR INSTALLER.
- PROVIDE FIRE ALARM RELAYS AND MONITORING MODULES FOR ALL FIRE SPRINKLER FLOW SWITCHES, AND BELL/GONG. SEE E1.1 SITE PLAN FOR LOCATION OF TAMPER SWITCHES. COORDINATE QUANTITIES AND LOCATIONS WITH FIRE SPRINKLER CONTRACTOR PRIOR TO BID.

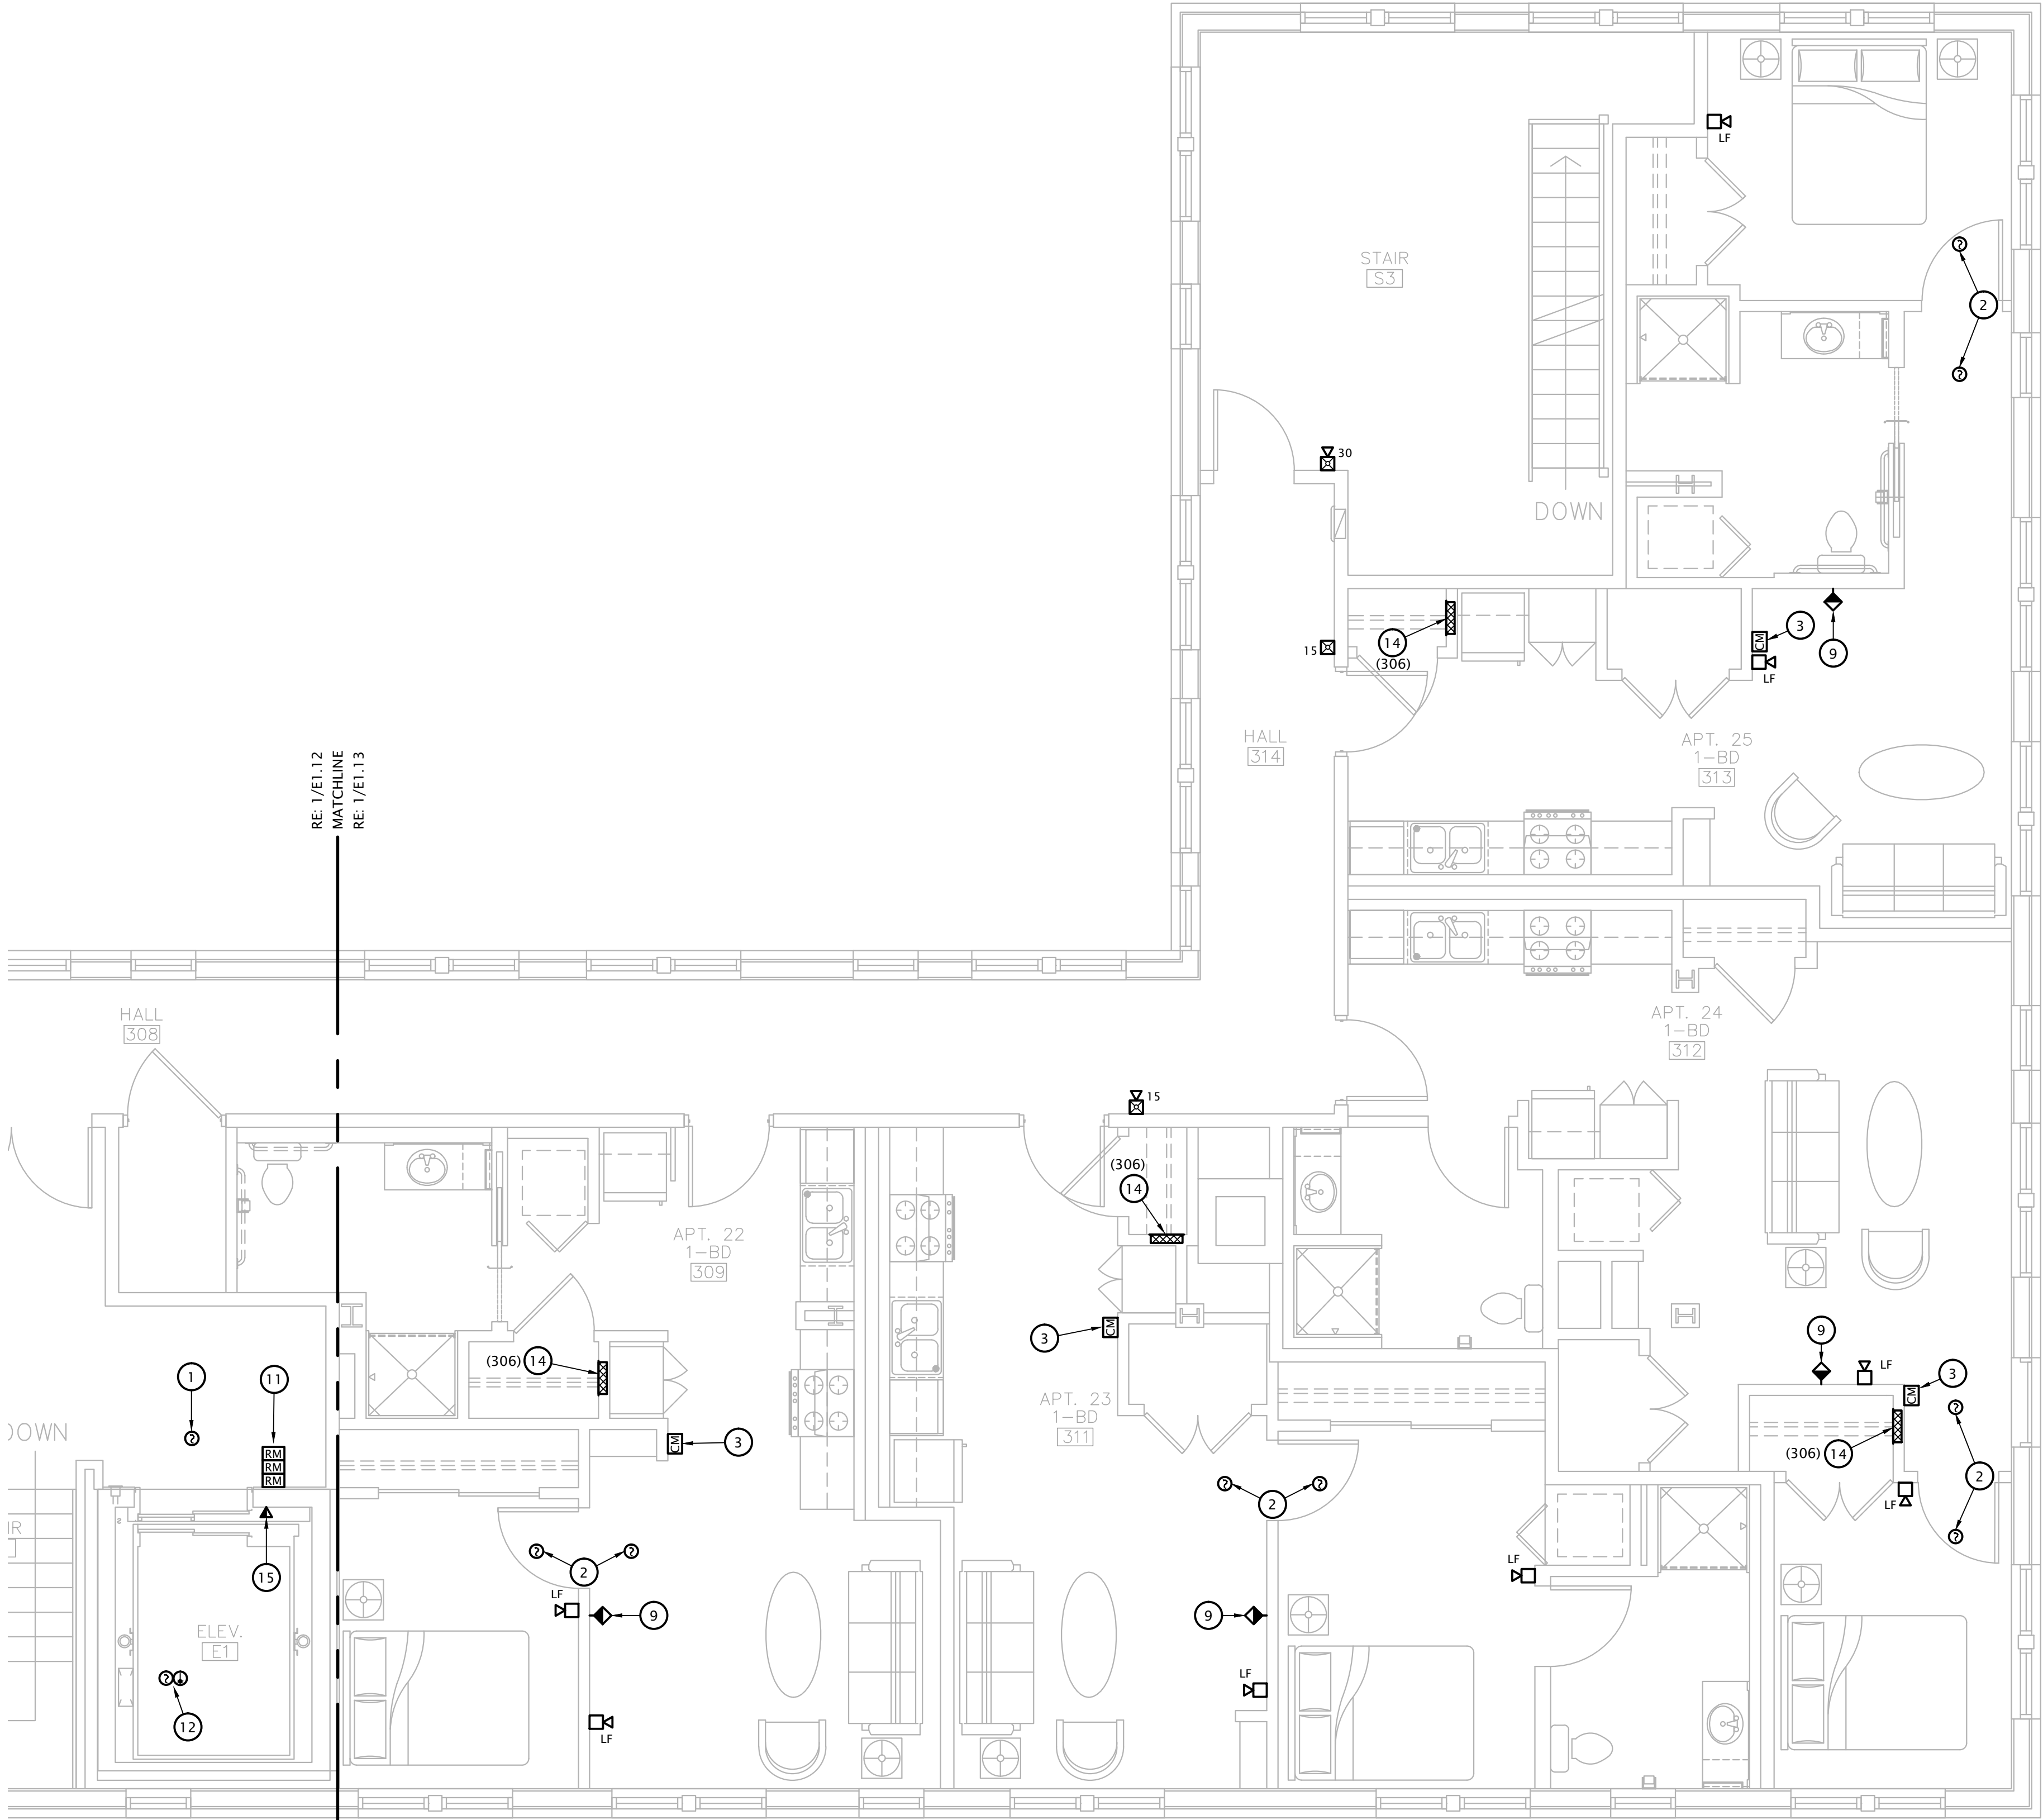


1 PARTIAL THIRD FLOOR SPECIAL SYSTEMS PLAN

1/4" = 1'-0"




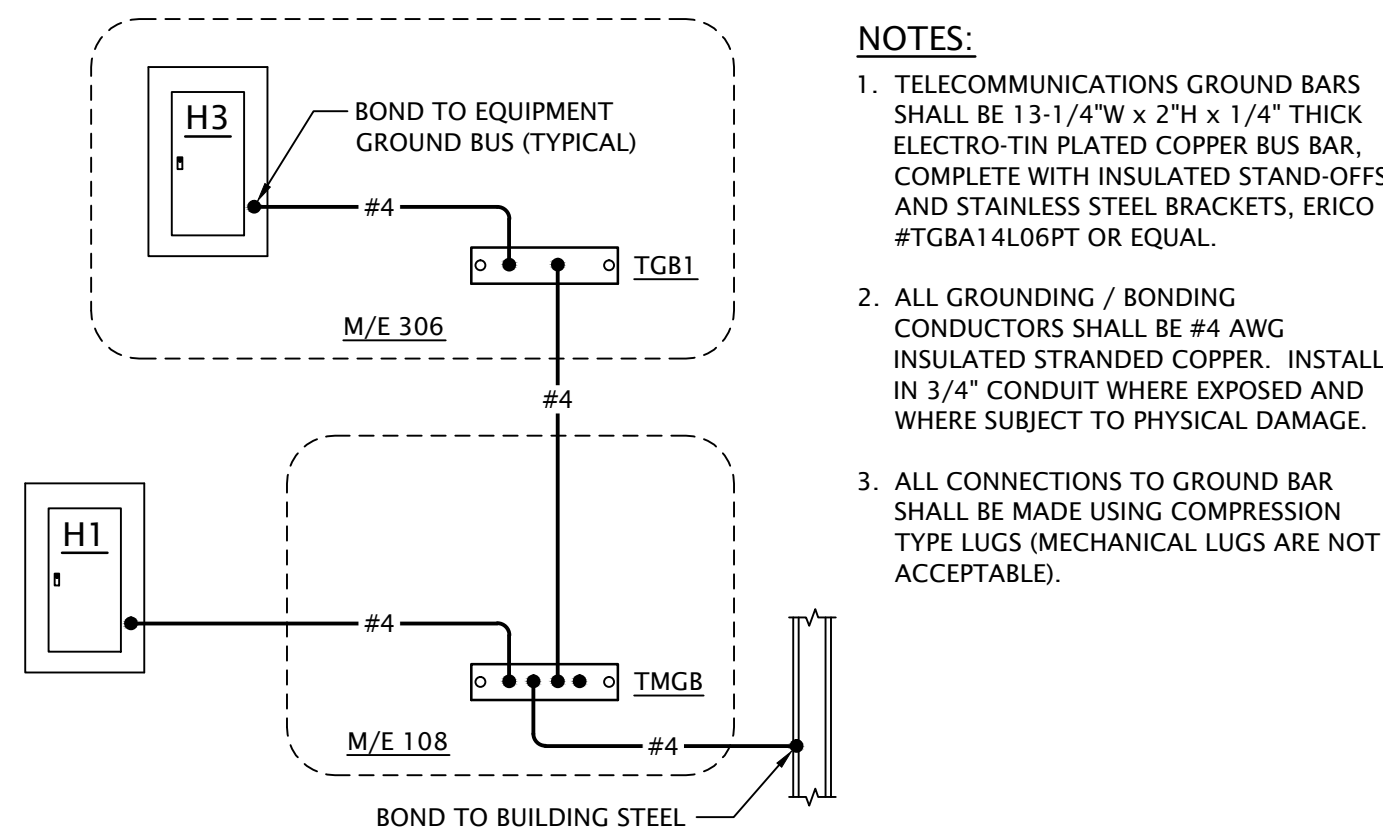


6 TELECOM GROUNDING & BONDING DIAGRAM  
No Scale

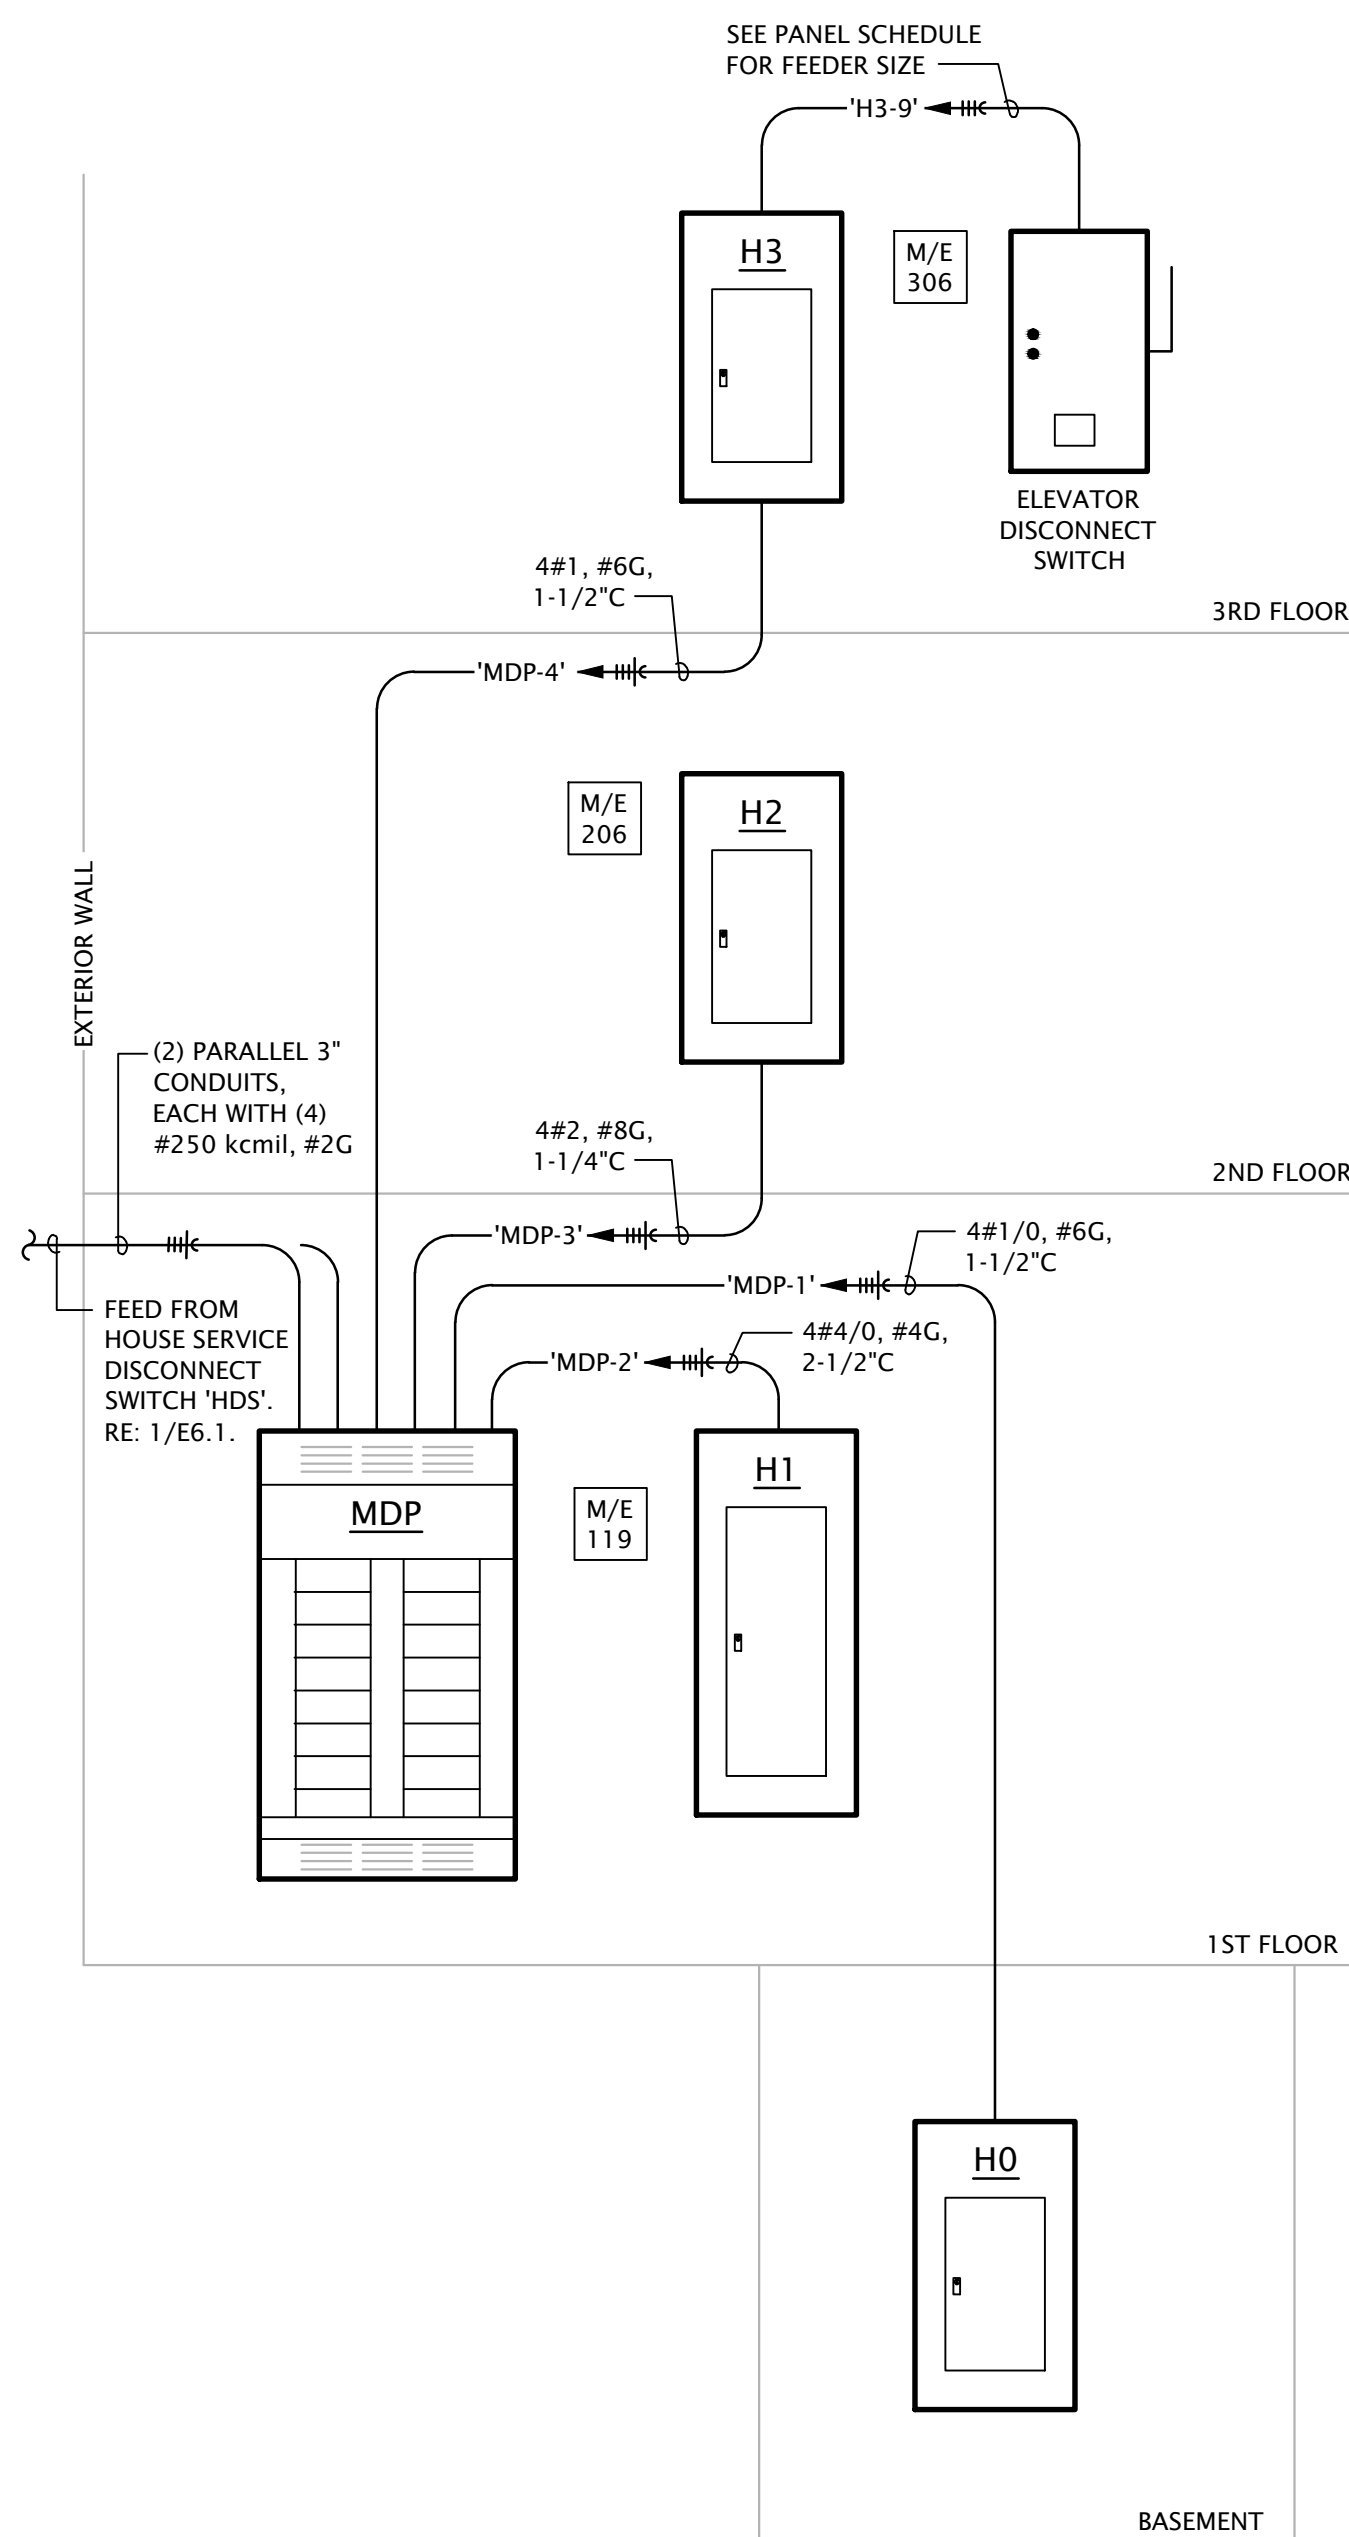


2 ELECTRICAL RISER DIAGRAM - HOUSE DISTRIBUTION  
No Scale

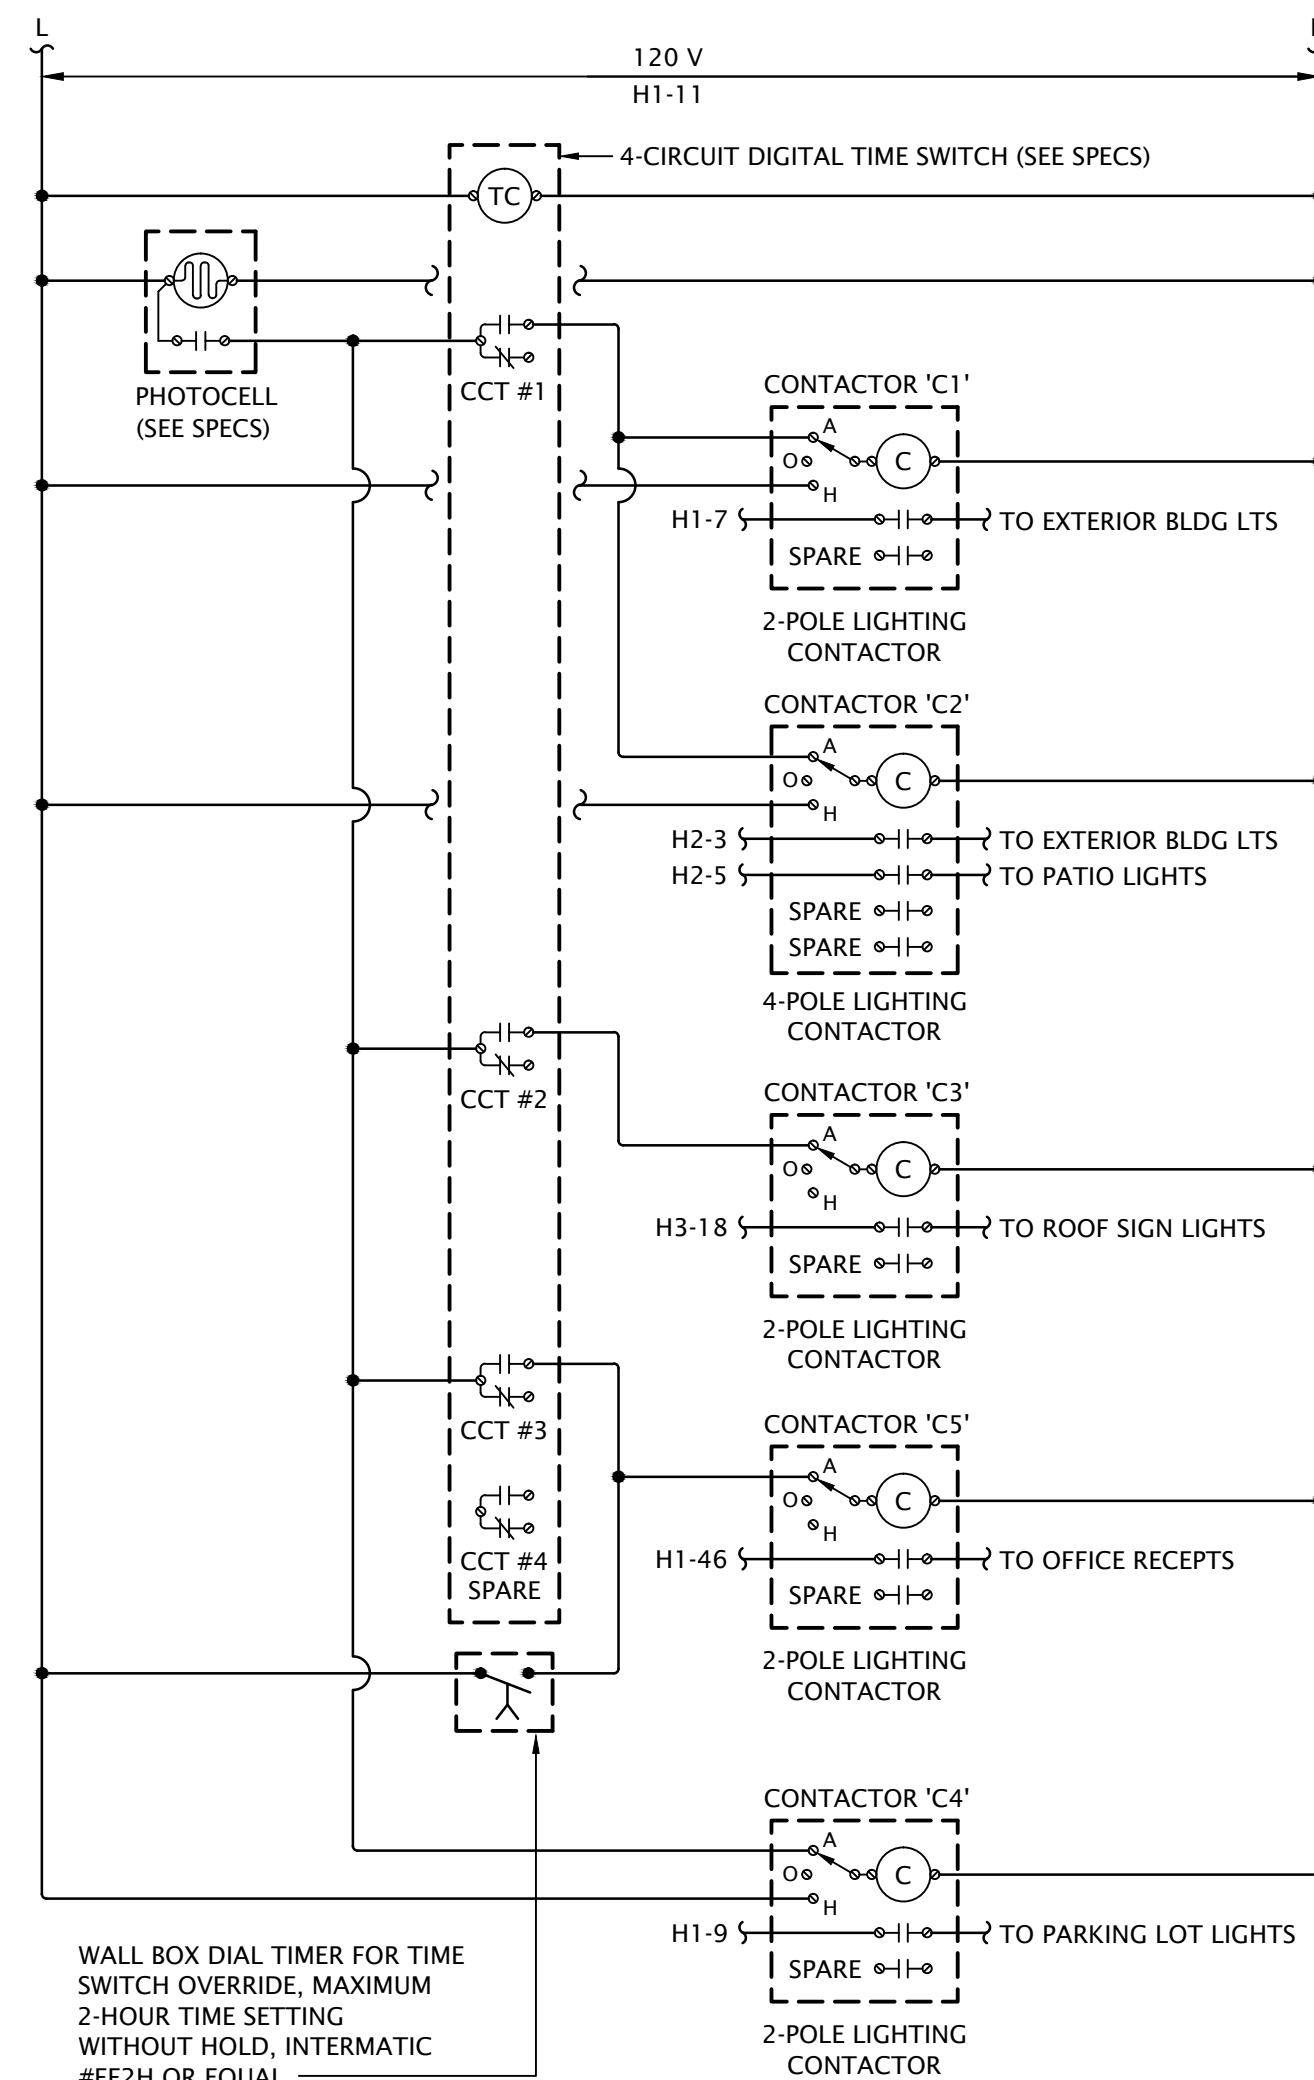

5 LIGHTING CONTROL DIAGRAM  
No Scale

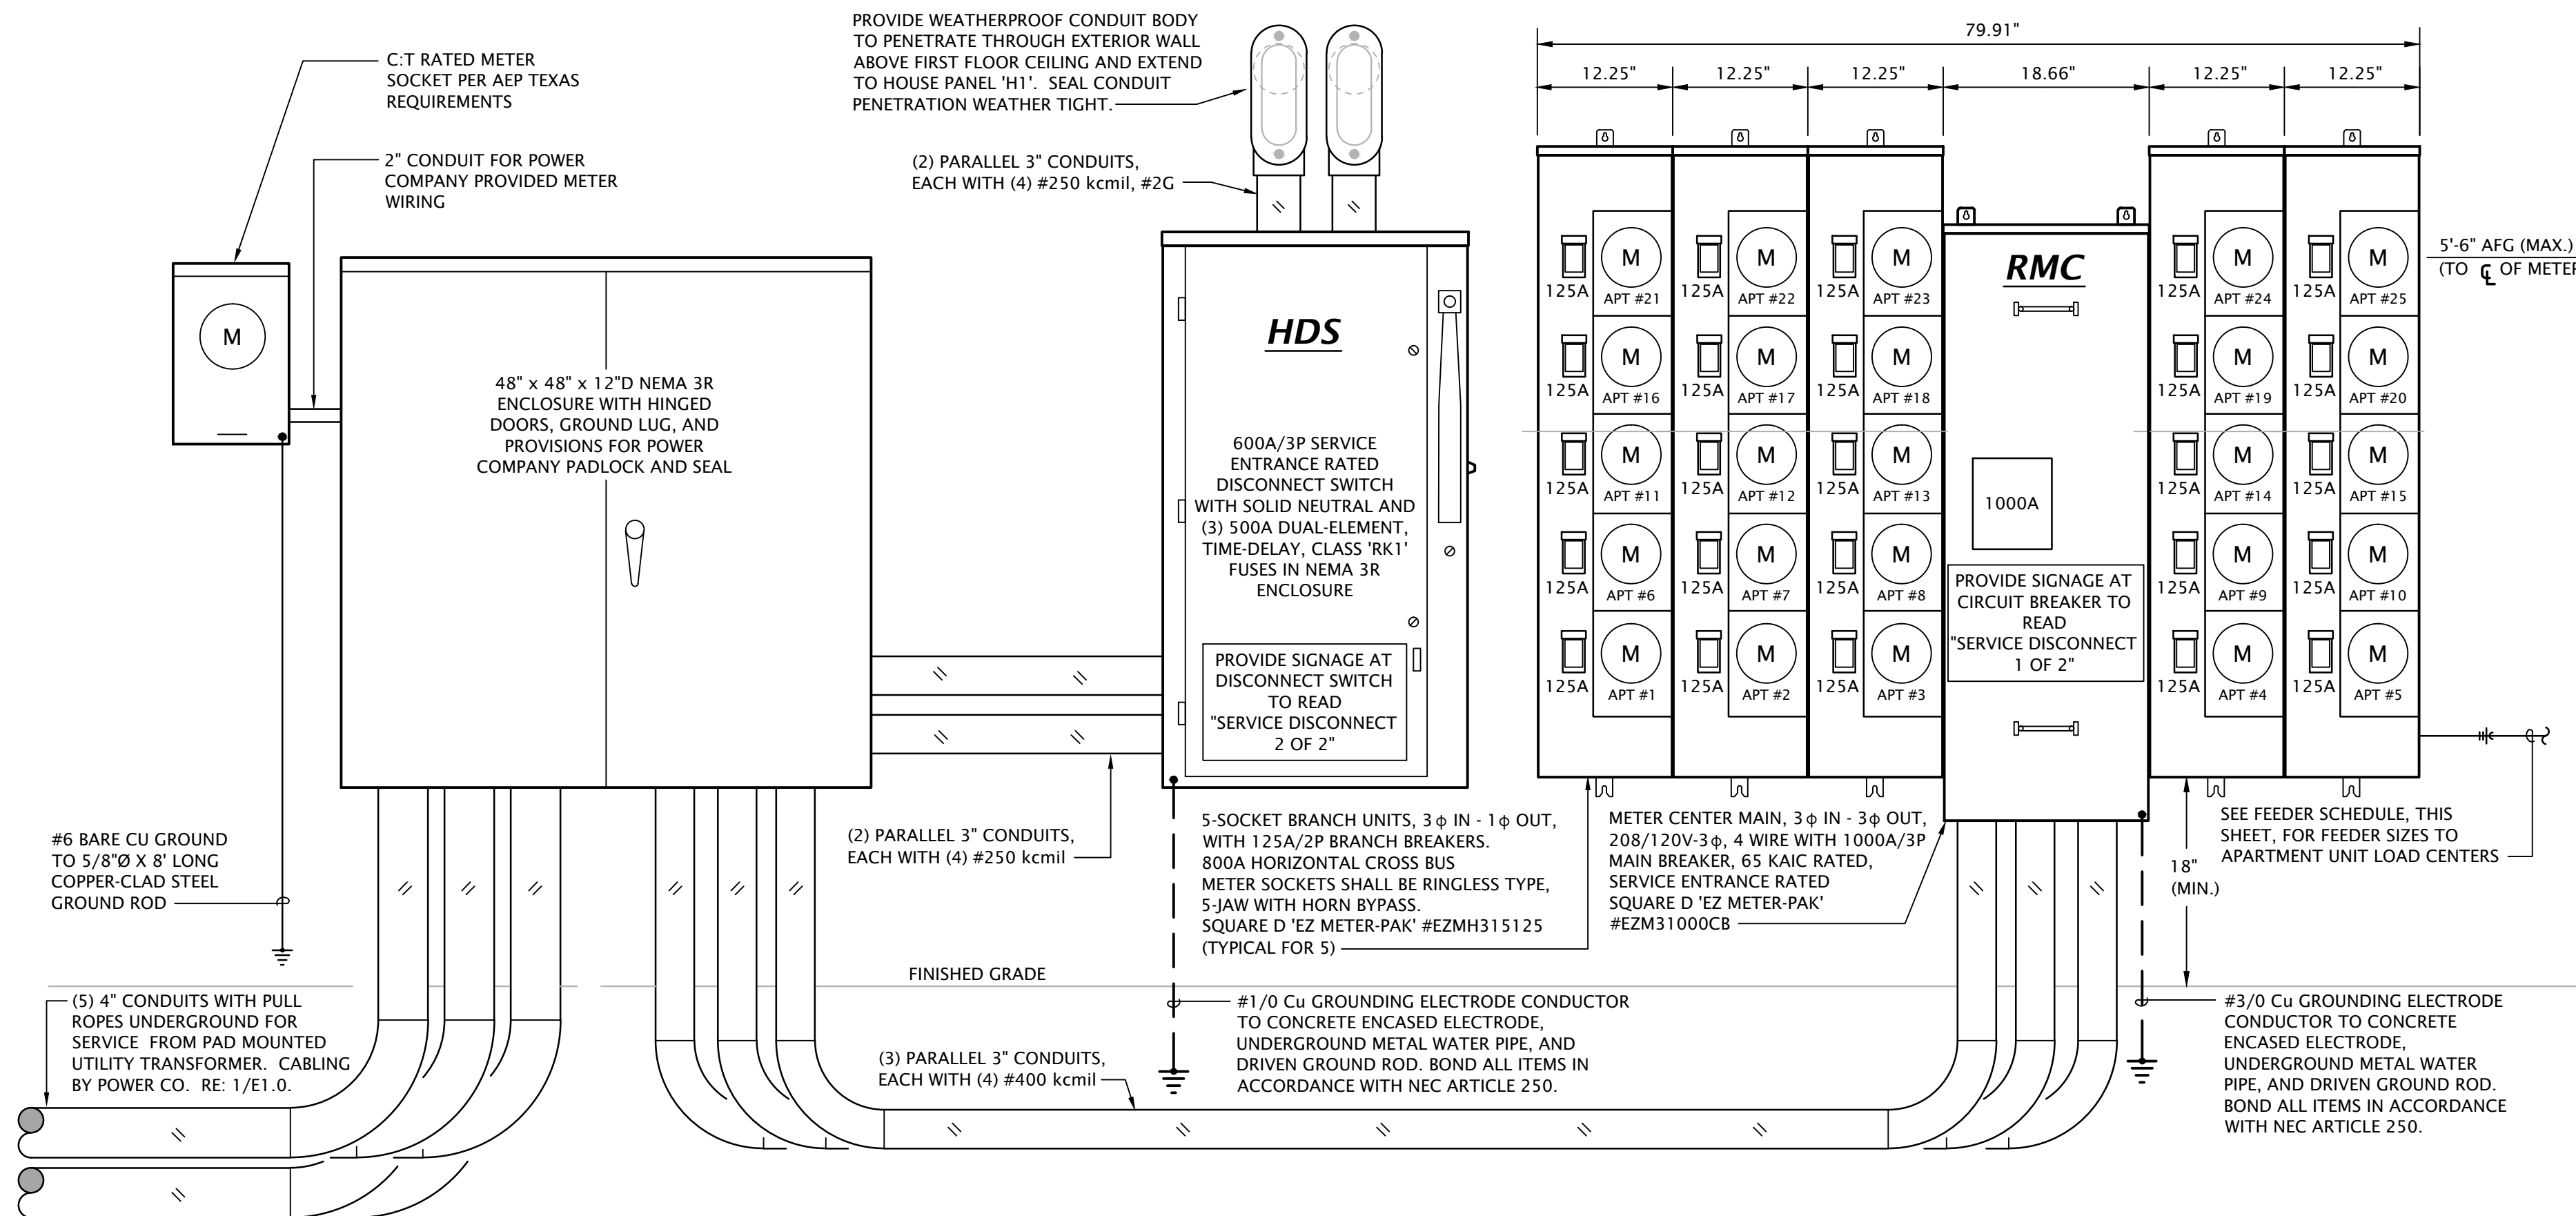

1 ELECTRICAL RISER DIAGRAM - SERVICE EQUIPMENT  
No Scale

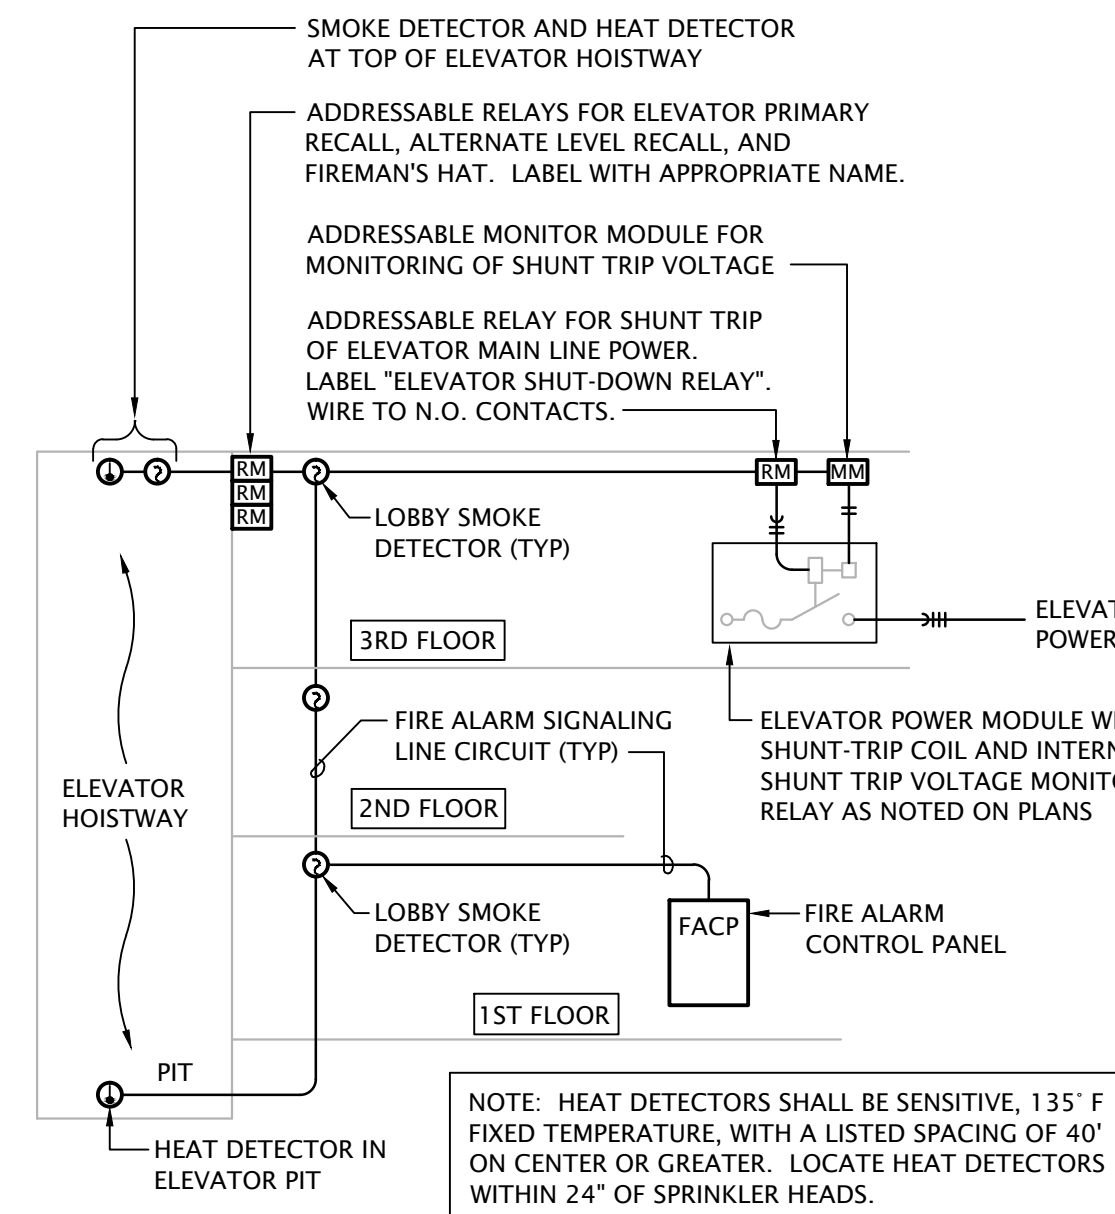

ELEVATOR SEQUENCE OF OPERATION: (DURING SMOKE/HEAT ALARM)

- UPON SENSING SMOKE FROM ELEVATOR LOBBY(S) OR HOISTWAY, THE SMOKE DETECTOR SHALL SIGNAL THE FACP, WHICH WILL FORWARD THE SIGNAL TO THE ELEVATOR LOGIC CONTROLLER TO RECALL ELEVATOR CAB TO THE DESIGNATED MAIN FLOOR. IF DESIGNATED FLOOR'S LOBBY SMOKE DETECTOR SENSES SMOKE AT THAT FLOOR, THE ELEVATOR CONTROLLER WILL SEND THE ELEVATOR CAB TO THE NEXT FLOOR CLEAR OF SMOKE. ONCE THE ELEVATOR CAB HAS REACHED THE DESIGNATED FLOOR, THE ELEVATOR CAB DOORS WILL OPEN AND THE CONTROLLER WILL LOCK THE ELEVATOR CAB AT THAT FLOOR, DISABLING THE ELEVATOR CAB CONTROLS, UNLESS A FIREMAN'S KEY IS USED TO OVERRIDE AUTOMATIC CONTROLS.
- ALL SMOKE DETECTORS SHALL TRANSMIT A SEPARATE AND DISTINCT VISIBLE ANNUNCIATION AT THE FACP AND ANNUNCIATOR PANEL.
- HEAT DETECTORS IN THE ELEVATOR HOISTWAY WILL SEND A SIGNAL TO THE SHUNT-TRIP SWITCH POWERING THE ELEVATOR SO AS TO SHUT DOWN POWER TO THAT CIRCUIT. (THIS IS A NON-AUTO RESET SWITCH). WHEN THE SPRINKLER HEAD HAS REACHED ITS CRITICAL TEMPERATURE OF 165° F., THE HEAD WILL BEGIN DISCHARGE OF WATER.

4 ELEVATOR INTERLOCK WITH FIRE ALARM  
No Scale


APARTMENT FEEDER SCHEDULE	
Apartment #	Feeder Size
#1 (109), #2 (112), #3 (113), #4 (114), #5 (118), #9 (127), #10 (201), #11 (202), #12 (203), #13 (207), #14 (209), #18 (301), #19 (302), #21 (307)	COPPER (BASE BID): (3)#2, #6G IN 1-1/4" C OR MC-CABLE ALUMINUM (ALTERNATE BID): (3)#1/0, #4G IN 1-1/4" C OR MC-CABLE
#6 (122), #8 (126), #15 (211), #17 (213), #20 (303), #22 (309)	COPPER (BASE BID): (3)#1, #4G IN 1-1/4" C OR MC-CABLE ALUMINUM (ALTERNATE BID): (3)#2/0, #2G IN 1-1/2" C OR MC-CABLE
#7 (123), #16 (212), #23 (311), #24 (312), #25 (313)	COPPER (BASE BID): (3)#1/0, #3G IN 1-1/2" C OR MC-CABLE ALUMINUM (ALTERNATE BID): (3)#3/0, #1G IN 2" C OR MC-CABLE
NOTES:	
1. Voltage drop has been accounted for in sizes indicated, further up-sizing of feeders is not necessary	
2. Ensure panel lugs are adequately sized to handle up-sized feeders.	

NOTES:

- Meter Center main circuit breaker shall be 65 kAIC fully rated. Feeder breakers may be series rated with main breaker for a 65 kAIC rating.
- All conductor sizes are based on copper, U.N.O.
- Entire installation shall comply with NEC.
- Coordinate all responsibilities and requirements with power utility company and pay associated fees. Contact Information:  
AEP Texas  
Jacob D Carson  
Technician Sr.  
(325) 657-2821  
jdc@carson@aep.com
- Coordinate final location of meter assemblies with utility company. Provide shop drawings of proposed equipment whether as specified or substituted to utility company for approval.
- All meter center components shall be NEMA 3R.
- All dimensions based on Square D equipment. It is the contractor's responsibility to verify the dimensions of substitute equipment.
- For each meter, provide a permanent brass, copper or aluminum tag identifying the apartment served. Tags shall be securely fastened to the meter base and be stamped with 1/8" letters, minimum.



## TELECOMMUNICATIONS SYMBOLS

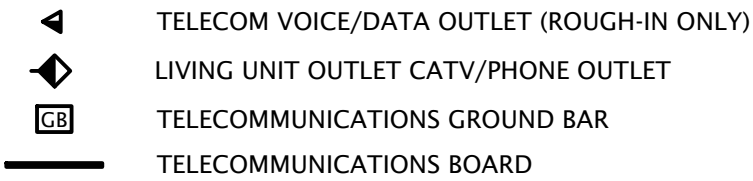

	FIRE ALARM CONTROL PANEL
	MANUAL PULL STATION
	HEAT DETECTOR
	SPOT TYPE AREA SMOKE DETECTOR
	ADDRESSABLE MONITORING MODULE
	ADDRESSABLE RELAY MODULE
	ADDRESSABLE CONTROL MODULE
	NOTIFICATION HORN, WALL
	NOTIFICATION STROBE, WALL (CANDELA NOTED)
	NOTIFICATION HORN/STROBE, WALL (CANDELA NOTED)
	NOTIFICATION HORN, LOW FREQUENCY TYPE, WALL
	FIRE SPRINKLER SYSTEM FLOW SWITCH
	FIRE SPRINKLER SYSTEM TAMPER SWITCH
	FIRE SPRINKLER SYSTEM BELL/CLONG


	CEILING FAN
	PENDANT OR SURFACE MOUNTED LINEAR LUMINAIRE
	STANDARD STRIP LIGHT
	SURFACE DOWNLIGHT
	WALL MOUNTED LUMINAIRE
	TWIN HEAD EMERGENCY LIGHTING UNIT
	COMBINATION EXIT/TWIN HEAD EMERGENCY LIGHTING UNIT
	WEATHERPROOF EXTERIOR REMOTE EMERGENCY HEAD - WALL AND CEILING MOUNTED
	SINGLE FACE EXIT SIGN - WALL AND CEILING MOUNTED WITH DIRECTIONAL ARROWS AS INDICATED ON PLANS
	DOUBLE FACE EXIT SIGN - WALL AND CEILING MOUNTED WITH DIRECTIONAL ARROWS AS INDICATED ON PLANS

CLG	CEILING MOUNTED • FLUSH MOUNTED IN SUSPENDED CEILINGS • SURFACE MOUNTED TO STRUCTURE ABOVE IN OPEN CEILINGS
CT	MOUNT BOTTOM OF DEVICE AT 6" ABOVE COUNTERTOP
GFI	GROUND FAULT CIRCUIT INTERRUPTING DEVICE
NL	NIGHTLIGHT WIRED TO UNSWITCHED HOT CONDUCTOR
WP	PROVIDE WEATHERPROOF ENCLOSURE FOR DEVICE
XX"	MOUNTING HEIGHT OF DEVICE ABOVE FINISHED FLOOR


	SINGLE RECEPTACLE
	DUPLEX RECEPTACLE
	DOUBLE DUPLEX RECEPTACLE
	SPECIAL RECEPTACLE (# = NEMA CONFIGURATION)
	SINGLE POLE TOGGLE SNAP SWITCH
	DOUBLE POLE TOGGLE SNAP SWITCH
	THREE-WAY TOGGLE SNAP SWITCH
	MOTOR HP RATED SWITCH WITHOUT OVERLOAD PROTECTION
	PRESET SLIDE DIMMER WALL SWITCH
	TIMER WALL SWITCH
	LINE VOLTAGE OCCUPANCY SENSING WALL SWITCH
	LINE VOLTAGE CEILING OCCUPANCY SENSOR
	TIMECLOCK
	EXTERIOR PHOTOCCELL
	CONTACTOR
	POWER RELAY
	CURRENT SWITCH
	PUSH BUTTON OPERATOR
	JUNCTION BOX
	MOTOR
	MOTORIZED DAMPER
	DISCONNECT SWITCH
	BRANCH CIRCUIT PANELBOARD, SURFACE MOUNTED
	BRANCH CIRCUIT PANELBOARD, FLUSH MOUNTED
	DISTRIBUTION BUSBAR

A	AMPERE
ac	ALTERNATING CURRENT
AFF	ABOVE FINISH FLOOR
C	CONDUIT
CATV	COMMUNITY ANTENNA TELEVISION
dc	DIRECT CURRENT
E	ELECTRICAL
EC	ELECTRICAL CONTRACTOR
EMT	ELECTRICAL METALLIC TUBING
G	GROUNDING (BONDING) CONDUCTOR
GC	GENERAL CONTRACTOR
GFCI	GROUND FAULT CIRCUIT INTERRUPTER
kcmil	THOUSAND CIRCULAR MILLS
MC	MECHANICAL CONTRACTOR
MCB	MAIN CIRCUIT BREAKER
MLO	MAIN LUG ONLY
NEC	NATIONAL ELECTRICAL CODE (NFPA 70)
NFPA	NATIONAL FIRE PROTECTION ASSOCIATION
PH or $\phi$	PHASE
PVC	POLYVINYL CHLORIDE CONDUIT
RCPT	RECEPTACLE
TYP	TYPICAL
U.L.	UNDERWRITERS LABORATORY
UNO	UNLESS NOTED OTHERWISE
V	VOLT (ALTERNATING CURRENT)
VA	VOLTAMPERE
W	WATT(S)


— E UG —	UNDERGROUND ELECTRICAL PRIMARY
— T UG —	UNDERGROUND TELEPHONE SERVICE
	POLE MOUNTED AREA LIGHT
	POWER COMPANY PAD MOUNTED UTILITY TRANSFORMER
	POWER COMPANY UTILITY POLE

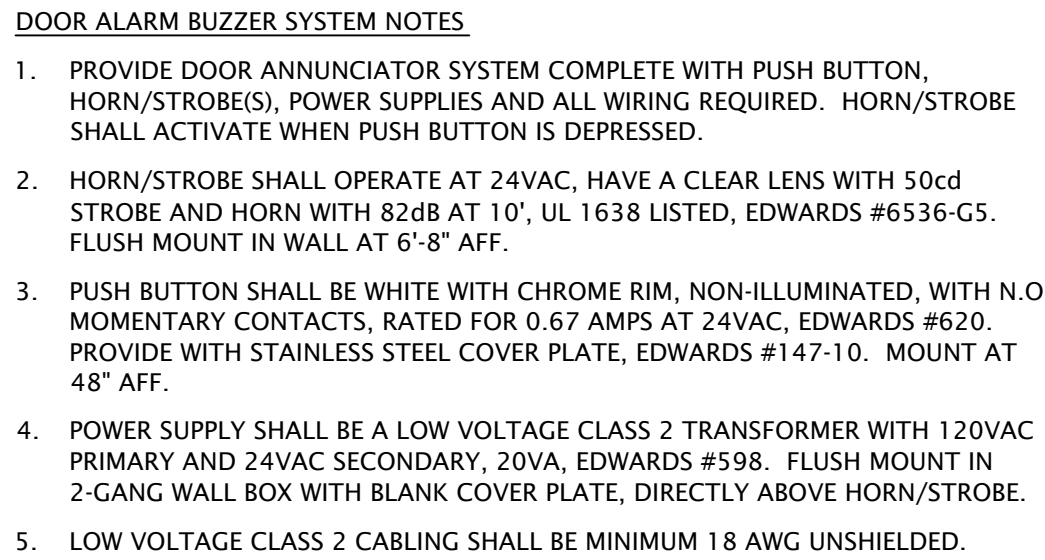

3 No Scale

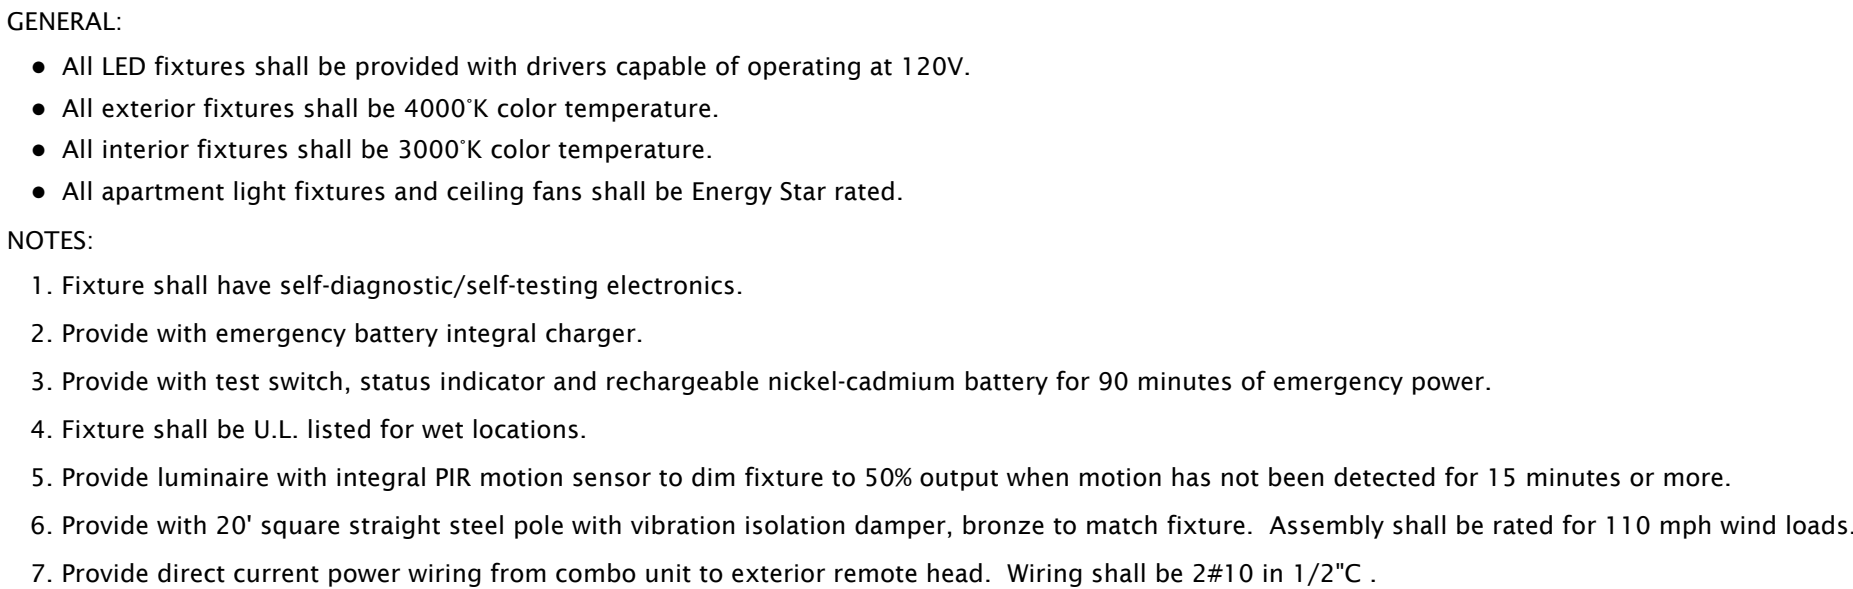

**ROOSEVELT LOFTS**  
**HISTORIC REHABILITATION - APARTMENTS**  
**SAN ANGELO, TEXAS**

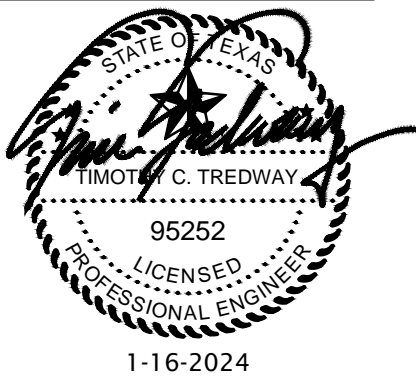

REVISION:

DATE: 1-16-2024

**JOB:** 21-3166

**SHEET NO.:**

## E6.2

COPYRIGHTED ©

Panel Designation: 1BR APT #					Mounting: Flush		
Location: 1 Bedroom Apartment					Bus Amps: 125		
Voltage: 208/120V-1Ph-3W					MCB Amps: MLO		
Enclosure: NEMA 1					Other: 10 KAIC		
Panel is typical for 1BR units							
Circuit #	Load Description	Conductors	C/B Size	C/B Size	Conductors	Load Description	Circuit #
1	CLOSET RCPT (TELECOM)	2#12, #12G, 1/2"	20 / 1	20 / 1	2#12, #12G, 1/2"	KITCHEN/LIVING/HALL LTS	2
3	DISHWASHER/DISPOSAL	2#12, #12G, 1/2"	20 / 1	20 / 1	2#12, #12G, 1/2"	CLOTHES WASHER RCPT	4
5	HOOD/MICROWAVE	2#12, #12G, 1/2"	20 / 1	30 / 2	3#10, #10G, 3/4"	CLOTHES DRYER	6
7	REFRIGERATOR	2#12, #12G, 1/2"	20 / 1				8
9	COUNTER TOP RCPTS	2#12, #12G, 1/2"	20 / 1	40 / 2	3#8, #10G, 1"	RANGE	10
11	COUNTER TOP RCPTS	2#12, #12G, 1/2"	20 / 1				12
13	LIVING ROOM RCPTS	2#12, #12G, 1/2"	20 / 1	25 / 2	2#10, #10G, 3/4"	HEAT PUMP 'HP'	14
15	BATHROOM	2#12, #12G, 1/2"	20 / 1				16
17	BEDROOM	2#12, #12G, 1/2"	20 / 1	45 / 2	2#6, #10G, 3/4"	BLOWER COIL 'BC'	18
19	SPACE ONLY	---	---				20
21	SPACE ONLY	---	---	30 / 2	2#10, #10G, 3/4"	WATER HEATER 'HWH'	22
23	SPACE ONLY	---	---				24

Designation: H2				Manufacturer: Square D 'NQ'			
Location: M/E 206				Bus Amps: 100			
Voltage: 208Y/120V-3Ph-4W				MCB Amps: MLO			
Enclosure: NEMA 1				AIC Rating: 10 KAIC			
Mounting: Surface				Other:			
Circuit #	Load Description	Conductors	C/B Size	C/B Size	Conductors	Load Description	Circuit #
1	LTG: HALL/STAIR	2#12, #12G, 1/2" C	20 / 1	60 / 2	2#4, #10G, 3/4" C	'BC-4' (CIRCUIT #1)	2
3	LTG: EXTERIOR UPLIGHTS	2#12, #12G, 1/2" C	20 / 1				4
5	LTG: PATIO LIGHTS	2#12, #12G, 1/2" C	20 / 1	45 / 2	2#6, #10G, 3/4" C	'BC-4' (CIRCUIT #2)	6
7	RCPT: HALL W	2#12, #12G, 1/2" C	20 / 1				8
9	RCPT: HALL E	2#12, #12G, 1/2" C	20 / 1	20 / 1	---	SPARE BREAKER	10
11	RCPT: PATIO	2#12, #12G, 1/2" C	20 / 1	20 / 1	---	SPARE BREAKER	12
13	SPACE ONLY	---	---	---	---	SPACE ONLY	14
15	SPACE ONLY	---	---	---	---	SPACE ONLY	16
17	SPACE ONLY	---	---	---	---	SPACE ONLY	18
19	SPACE ONLY	---	---	---	---	SPACE ONLY	20
21	SPACE ONLY	---	---	---	---	SPACE ONLY	22
23	SPACE ONLY	---	---	---	---	SPACE ONLY	24
25	SPACE ONLY	---	---	---	---	SPACE ONLY	26
27	SPACE ONLY	---	---	---	---	SPACE ONLY	28
29	SPACE ONLY	---	---	---	---	SPACE ONLY	30

Designation: H0				Manufacturer: Square D 'NQ'			
Location: Basement				Bus Amps: 225			
Voltage: 208Y/120V-3Ph-4W				MCB Amps: MLO			
Enclosure: NEMA 1				AIC Rating: 10 KAIC			
Mounting: Surface				Other:			
Circuit #	Load Description	Conductors	C/B Size	C/B Size	Conductors	Load Description	Circuit #
1	'HWH-B' (NORTH)	3#6, #10G, 3/4" C	60 / 3	20 / 1	2#12, #12G, 1/2" C	BASEMENT LIGHTS	2
3				20 / 1	2#12, #12G, 1/2" C	BASEMENT HEATER 'EWH-4'	4
5	'HWH-B' (MID)	3#6, #10G, 3/4" C	60 / 3	20 / 1	2#12, #12G, 1/2" C	HW RECIRC PUMP 'HWP'	6
7				20 / 1	2#12, #12G, 1/2" C	BASEMENT RCPTS	8
9				20 / 1	2#12, #12G, 1/2" C	FIRE SPRINKLER FLOW/BELL	10
11				20 / 1	2#12, #12G, 1/2" C	SEWAGE EJECTOR CONTROL	12
13	'HWH-B' (SOUTH)	3#6, #10G, 3/4" C	60 / 3	20 / 1	2#12, #12G, 1/2" C	SEWAGE EJECTOR PUMP	14
15				---	---	SPACE ONLY	16
17				---	---	SPACE ONLY	18
19				---	---	SPACE ONLY	20
21				---	---	SPACE ONLY	22
23	SPACE ONLY	---	---	---	---	SPACE ONLY	24
25	SPACE ONLY	---	---	---	---	SPACE ONLY	26
27	SPACE ONLY	---	---	---	---	SPACE ONLY	28
29	SPACE ONLY	---	---	---	---	SPACE ONLY	30

Panel Designation: 2BR APT #				Mounting: Flush			
Location: 2 Bedroom Apartment				Bus Amps: 125			
Voltage: 208/120V-1Ph-3W				MCB Amps: MLO			
Enclosure: NEMA 1				Other: 10 KAIC			
Panel is typical for 2BR units							
Circuit #	Load Description	Conductors	C/B Size	C/B Size	Conductors	Load Description	Circuit #
2	1 CLOSET RCPT (TELECOM)	2#12, #12G, 1/2" C	20 / 1	20 / 1	2#12, #12G, 1/2" C	KITCHEN/LIVING/HALL LTS	2
3	3 DISHWASHER/DISPOSAL	2#12, #12G, 1/2" C	20 / 1	20 / 1	2#12, #12G, 1/2" C	CLOTHES WASHER RCPT	4
3	5 HOOD/MICROWAVE	2#12, #12G, 1/2" C	20 / 1	30 / 2	3#10, #10G, 3/4" C	CLOTHES DRYER	6
3	7 REFRIGERATOR	2#12, #12G, 1/2" C	20 / 1	40 / 2	3#8, #10G, 1" C	RANGE	8
3	9 COUNTER TOP RCPTS	2#12, #12G, 1/2" C	20 / 1				10
3	11 COUNTER TOP RCPTS	2#12, #12G, 1/2" C	20 / 1				12
2	13 LIVING ROOM RCPTS	2#12, #12G, 1/2" C	20 / 1	25 / 2	2#10, #10G, 3/4" C	HEAT PUMP 'HP'	14
	15 BATHROOM	2#12, #12G, 1/2" C	20 / 1	45 / 2	2#6, #10G, 3/4" C	BLOWER COIL 'BC'	16
2	17 BEDROOM	2#12, #12G, 1/2" C	20 / 1				18
2	19 BEDROOM	2#12, #12G, 1/2" C	20 / 1				20
	21 SPACE ONLY	---	---	30 / 2	2#10, #10G, 3/4" C	WATER HEATER 'HWH'	22
	23 SPACE ONLY	---	---				24

Designation: H3				Manufacturer: Square D 'NQ'			
Location: M/E 306				Bus Amps: 225			
Voltage: 208Y/120V-3Ph-4W				MCB Amps: MLO			
Enclosure: NEMA 1				AIC Rating: 10 KAIC			
Mounting: Surface				Other:			
Circuit #	Load Description	Conductors	C/B Size	C/B Size	Conductors	Load Description	Circuit #
1	LTG: HALL/STAIR	2#12, #12G, 1/2" C	20 / 1	20 / 2	2#12, #12G, 1/2" C	HEAT PUMP 'HP-1.5'	2
3	ROOFTOP SIGN LIGHTS	2#12, #12G, 1/2" C	20 / 1				4
5	RCPT: ROOF	2#10, #10G, 1/2" C	20 / 1	40 / 2	2#8, #10G, 3/4" C	HEAT PUMP 'HP-4'	6
7	ELEVATOR	3#4, #8G, 1" C	70 / 3	40 / 2	2#8, #10G, 3/4" C	OUTDOOR A/C UNIT 'OU-1'	8
9				40 / 2	2#8, #10G, 3/4" C	OUTDOOR A/C UNIT 'OU-1'	10
11							12
13	ELEVATOR CAB LTS/EXH.	2#12, #12G, 1/2" C	20 / 1	15 / 2	2#12, #12G, 1/2" C	OUTDOOR A/C UNIT 'OU-2'	14
15	ELEV. HOISTWAY RCPT	2#12, #12G, 1/2" C	20 / 1				16
17	ELEV. HOISTWAY LIGHT	2#12, #12G, 1/2" C	20 / 1	20 / 1	2#12, #12G, 1/2" C	ROOF SIGN LIGHTING	18
19	RCPT: TELECOM BD	2#12, #12G, 1/2" C	20 / 1	20 / 1	---	SPARE BREAKER	20
21	RCPT: HALL W	2#12, #12G, 1/2" C	20 / 1	20 / 1	---	SPARE BREAKER	22
23	RCPT: HALL E	2#12, #12G, 1/2" C	20 / 1	20 / 1	---	SPARE BREAKER	24
25	SPACE ONLY	---	---	---	---	SPACE ONLY	26
27	SPACE ONLY	---	---	---	---	SPACE ONLY	28
29	SPACE ONLY	---	---	---	---	SPACE ONLY	30

Designation: H1				Manufacturer: Square D 'NQ'			
Location: M/E 119				Bus Amps: 225			
Voltage: 208Y/120V-3Ph-4W				MCB Amps: MLO			
Enclosure: NEMA 1				AIC Rating: 25 KAIC			
Mounting: Surface				Other:			
Circuit #	Load Description	Conductors	C/B Size	C/B Size	Conductors	Load Description	Circuit #
1	LTG: OFFICE/RESTRMS	2#12, #12G, 1/2" C	20 / 1	15 / 2	2#12, #12G, 1/2" C	OUTDOOR A/C UNIT 'OU-3'	2
3	LTG: HALL/LAUNDRY	2#12, #12G, 1/2" C	20 / 1				4
5	LTG: COMMUNITY RM/HALL	2#12, #12G, 1/2" C	20 / 1	25 / 2	2#10, #10G, 1/2" C	HEAT PUMP 'HP-2.5'	6
7	EXTERIOR WALL LTS	2#12, #12G, 1/2" C	20 / 1				8
9	PARKING LOT POLE LTS	2#10, #10G, 3/4" C	20 / 1	50 / 2	2#6, #10G, 3/4" C	'BC-2.5b' (CIRCUIT #1)	10
11	EXTERIOR LTG CONTROLS	2#12, #12G, 1/2" C	20 / 1				12
13	CLOTHES DRYER	3#10, #10G, 3/4" C	30 / 2	25 / 2	2#10, #10G, 1/2" C	'BC-2.5b' (CIRCUIT #2)	14
15							16
17	CLOTHES DRYER	3#10, #10G, 3/4" C	30 / 2	40 / 2	2#8, #10G, 3/4" C	'BC-1.5'	18
19							20
21	CLOTHES DRYER	3#10, #10G, 3/4" C	30 / 2	20 / 1	2#12, #12G, 1/2" C	WALL HEATER 'EWH-1'	22
23				20 / 1	2#12, #12G, 1/2" C	WALL HEATER 'EWH-2'	24
25	CLOTHES DRYER	3#10, #10G, 3/4" C	30 / 2	20 / 1	2#12, #12G, 1/2" C	WALL HEATER 'EWH-3'	26
27				20 / 1	2#12, #12G, 1/2" C	DRINKING FOUNTAIN	28
29	WASHER	2#12, #12G, 1/2" C	20 / 1	20 / 1	2#12, #12G, 1/2" C	RCPT: TELECOM BOARD	30
31	WASHER	2#12, #12G, 1/2" C	20 / 1	20 / 1	2#12, #12G, 1/2" C	RCPT: PANTRY MICROWAVE	32
33	WASHER	2#12, #12G, 1/2" C	20 / 1	20 / 1	2#12, #12G, 1/2" C	RCPT: HALL W	34
35	WASHER	2#12, #12G, 1/2" C	20 / 1	20 / 1	2#12, #12G, 1/2" C	RCPT: COMMUNITY RM	36
37	EV CHARGING STATION	2#8, #10G, 3/4" C	40 / 2	20 / 1	2#12, #12G, 1/2" C	RCPT: LAUNDRY/JAN	38
39				20 / 1	2#12, #12G, 1/2" C	RCPT: HALL E	40
41	EV CHARGING MAINT. RCPT	2#10, #10G, 3/4" C	20 / 1	20 / 1	2#12, #12G, 1/2" C	FIRE ALARM CONTROL PNL	42
43	ELEVATOR PIT RCPT	2#12, #12G, 1/2" C	20 / 1	20 / 1	2#12, #12G, 1/2" C	RCPT: OFFICE UNSWITCHED	44
45	ELEVATOR PIT LIGHT	2#12, #12G, 1/2" C	20 / 1	20 / 1	2#12, #12G, 1/2" C	RCPT: OFFICE SWITCHED	46
47	ELEVATOR SUMP PUMP ALARM PANEL	2#12, #12G, 1/2" C	20 / 1	20 / 1	2#12, #12G, 1/2" C	DRYER MAKE-UP AIR CNTL	48
49	ELEVATOR SUMP PUMP RCPT	2#12, #12G, 1/2" C	20 / 1	20 / 1	2#12, #12G, 1/2" C	RCPT: ROOFTOP	50
51	SPARE BREAKER	---	20 / 1	20 / 1	---	SPARE BREAKER	52
53	SPARE BREAKER	---	20 / 1	20 / 1	---	SPARE BREAKER	54
55	SPACE ONLY	---	---	---	---	SPACE ONLY	56
57	SPACE ONLY	---	---	---	---	SPACE ONLY	58
59	SPACE ONLY	---	---	---	---	SPACE ONLY	60

CIRCUIT BREAKER DISTRIBUTION PANEL SCHEDULE				
Designation: MDP		Enclosure: NEMA 1	Bus Amps: 600	
Location: M/E 119		Mounting: Wall	MCB Amps: MLO	
Voltage: 208Y/120V-3Ph-4W		Manufacturer: Square D "I-LINE"	AIC Rating: 30 kAIC	
Circuit #	Equipment Served	Feeder Size	C/B Size	Remarks
1	PANEL "H0"	SEE RISER DIAGRAM 2/E6.1	150/3	
2	PANEL "H1"	SEE RISER DIAGRAM 2/E6.1	225/3	
3	PANEL "H2"	SEE RISER DIAGRAM 2/E6.1	100/3	
4	PANEL "H3"	SEE RISER DIAGRAM 2/E6.1	125/3	
5	BUSSED SPACE	---	225A	PROVISIONAL SPACE
6	BUSSED SPACE	---	225A	PROVISIONAL SPACE
7	BUSSED SPACE	---	225A	PROVISIONAL SPACE
Notes:				
1. Provide panel with integral surge protection per specifications.				