

REVISION:

6-14-2024 22-3262

SHEET NO.:

ME1.1

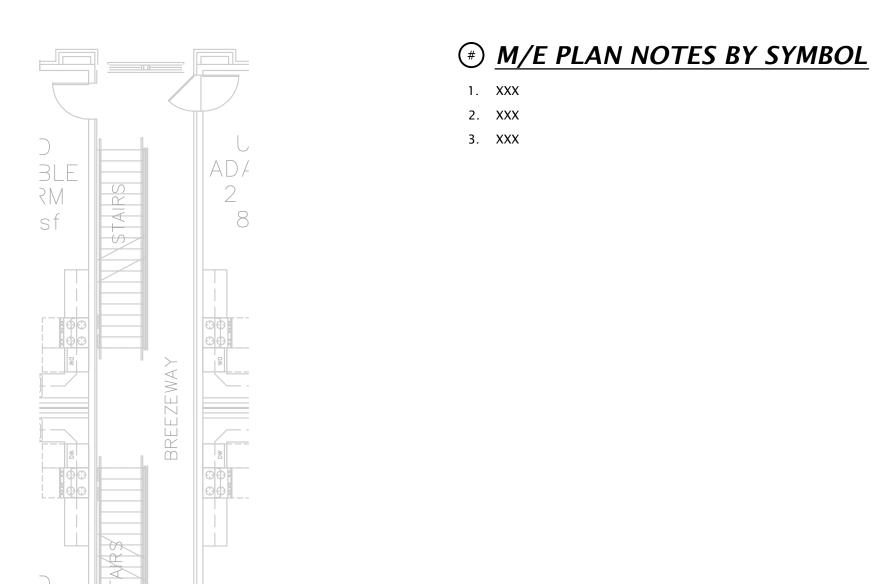

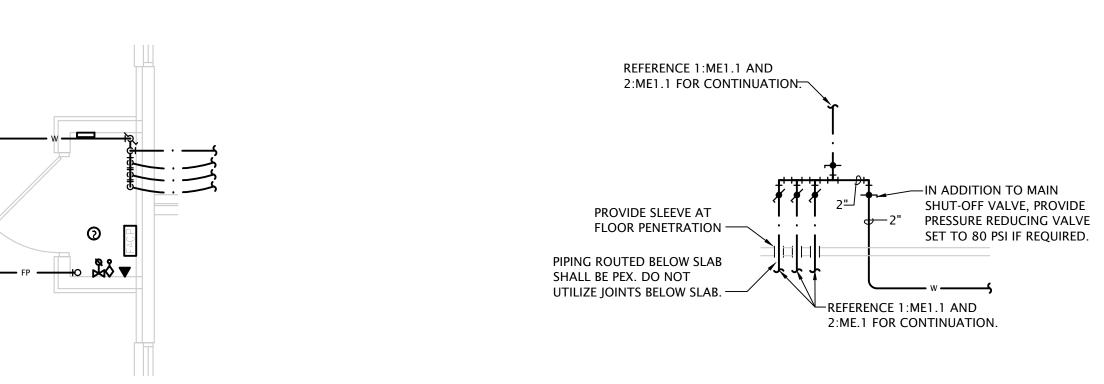


2 BUILDING - B WATER RISER CLOSET

1/4" = 1'-0"

3 BUILDING - B WATER SERVICE RISER
NO SCALE



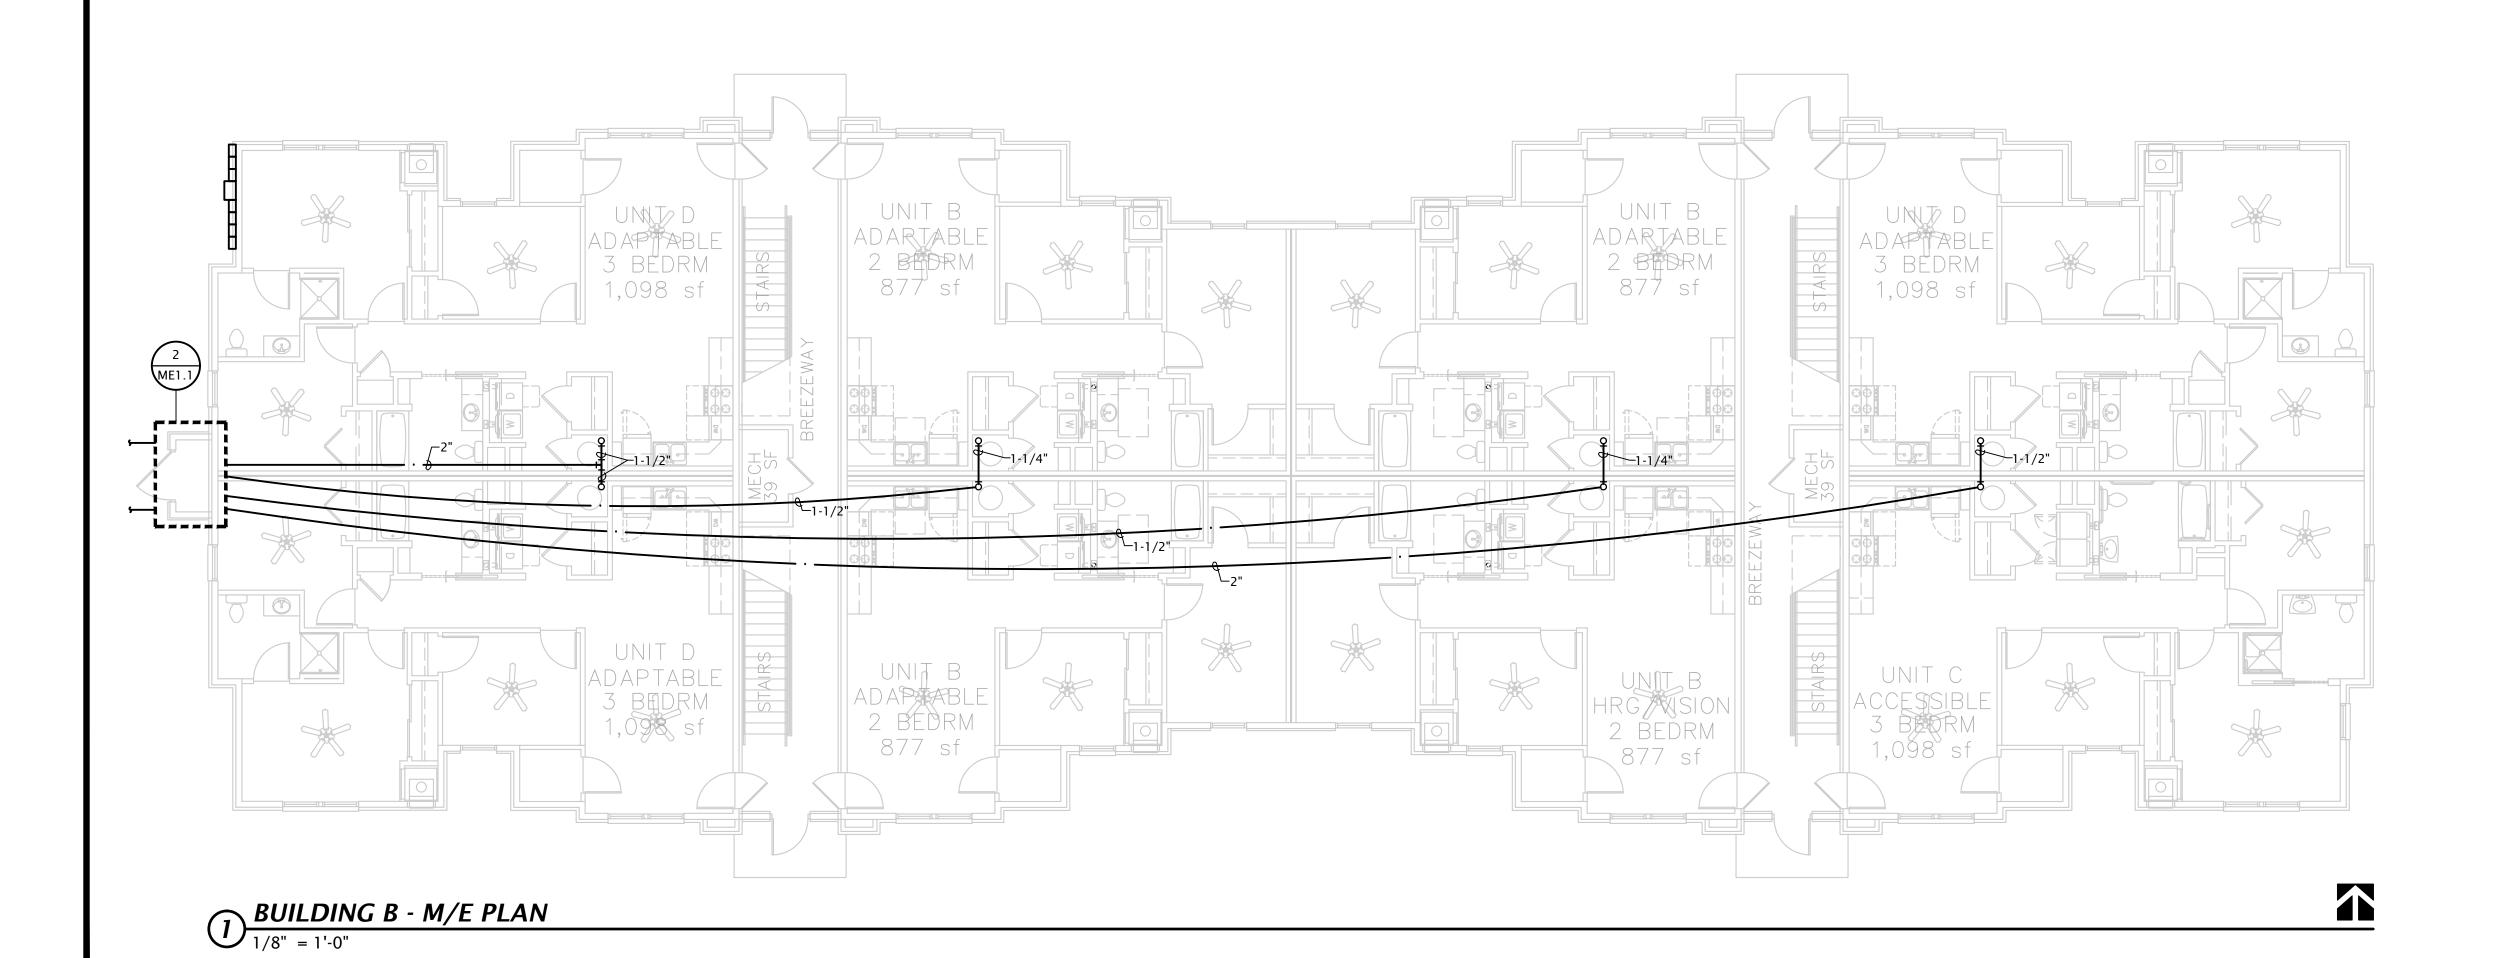


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6-14-2024 22-3262 SHEET NO.:

ME1.2

1. XXX

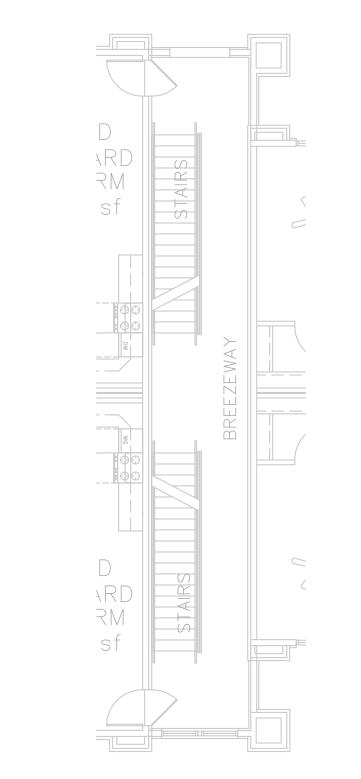


REFERENCE 1:ME1.1 AND 2:ME1.1 FOR CONTINUATION. IN ADDITION TO MAIN
SHUT-OFF VALVE, PROVIDE
PRESSURE REDUCING VALVE
SET TO 80 PSI IF REQUIRED. PROVIDE SLEEVE AT FLOOR PENETRATION — PIPING ROUTED BELOW SLAB
SHALL BE PEX. DO NOT
UTILIZE JOINTS BELOW SLAB. REFERENCE 1:ME1.1 AND 2:ME.1 FOR CONTINUATION.

BUILDING - A WATER SERVICE RISER
NO SCALE

UPPER FLOOR BREEZEWAY PLAN

1/8" = 1'-0" (3RD FLOOR SIMILAR)

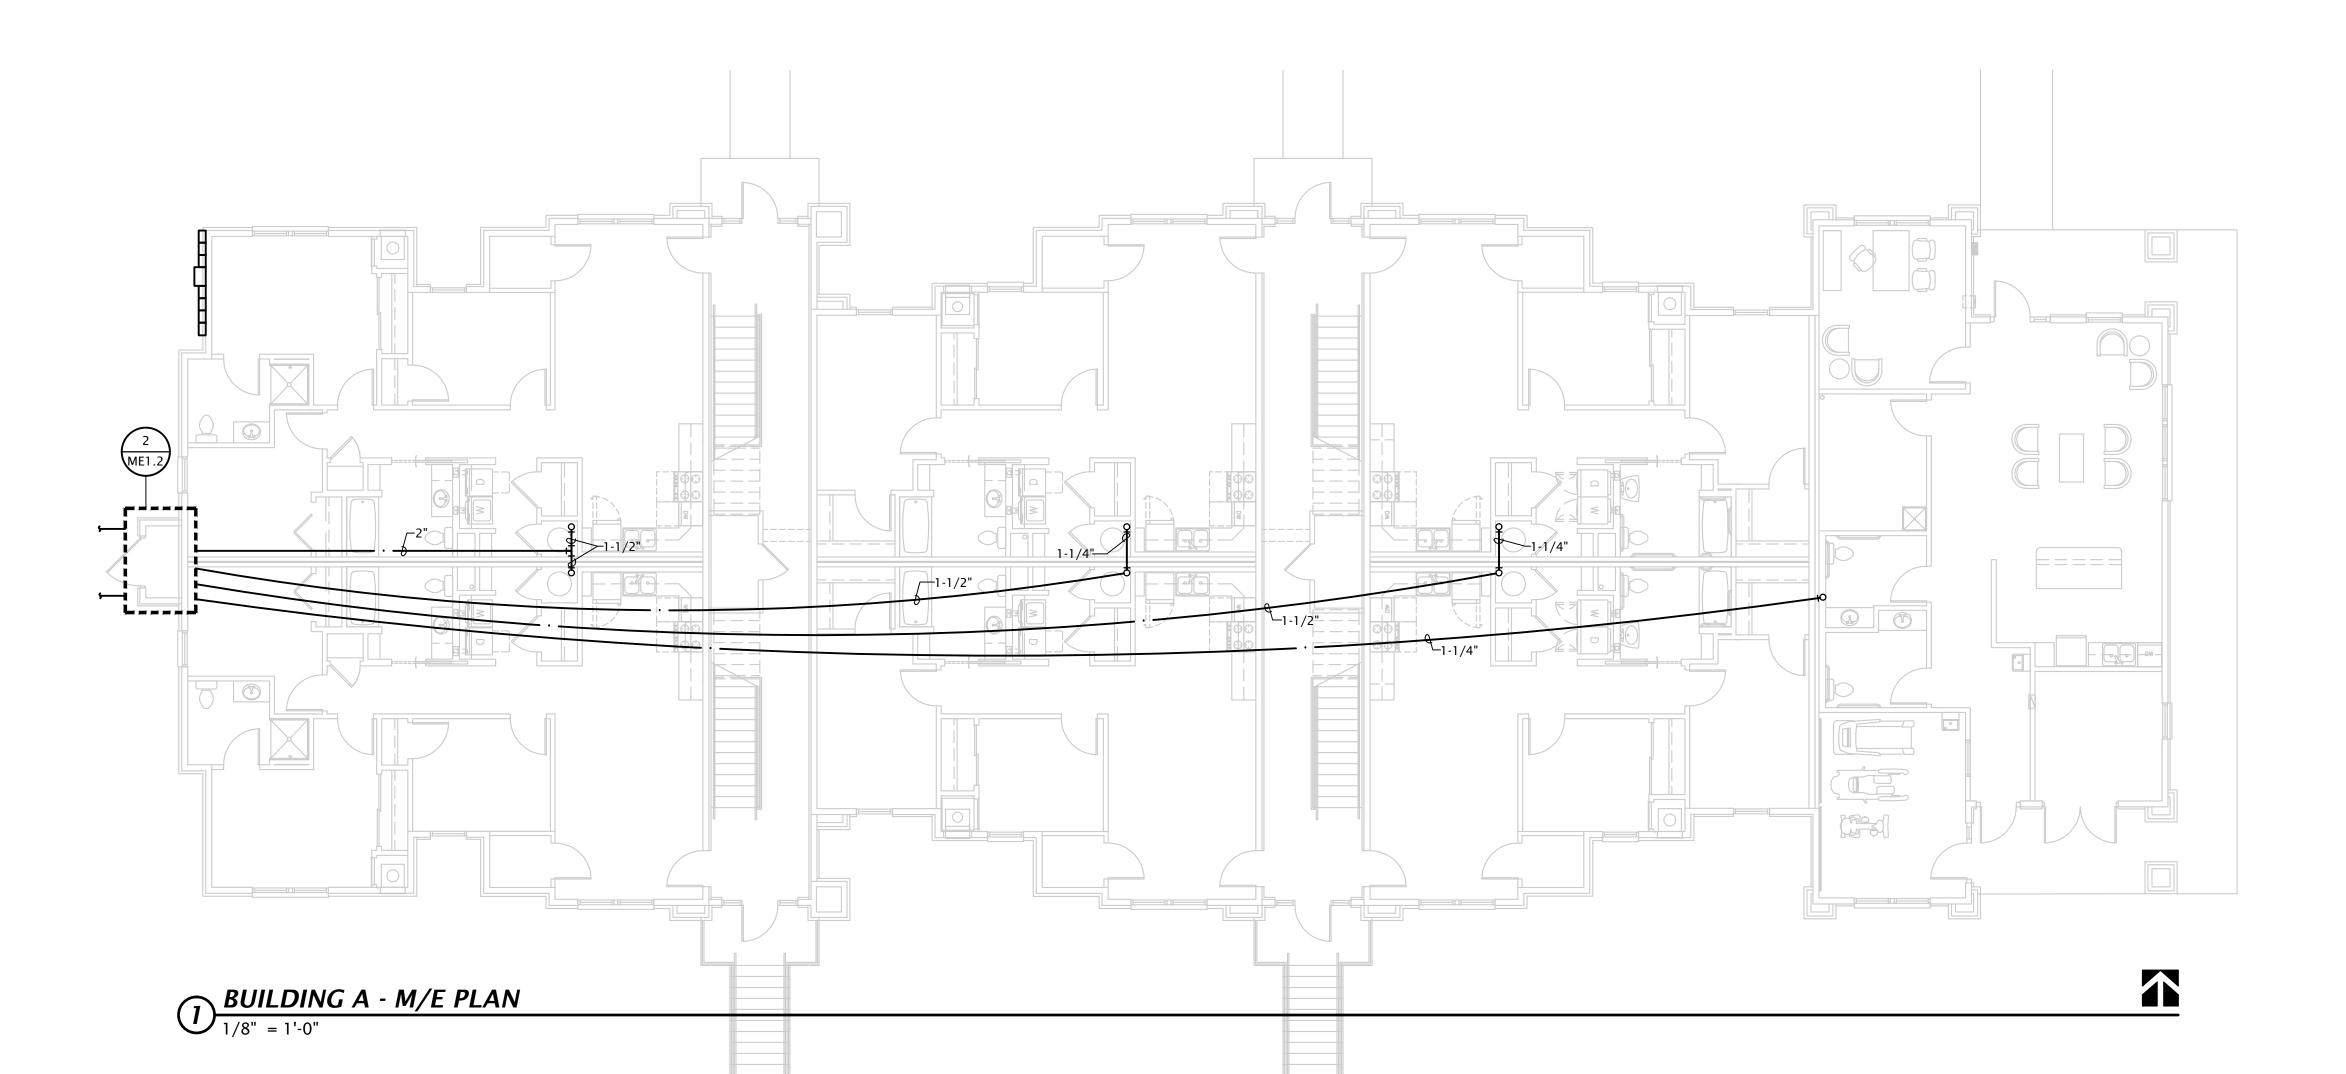

BUILDING - A WATER RISER CLOSET

1/4" = 1'-0"

M/E PLAN NOTES BY SYMBOL


2. XXX 3. XXX

BE CONSTRUED TO BE CONSTRUCTION DOCUMENTS

REVISION:

6-14-2024 22-3262 SHEET NO.:

ME1.3

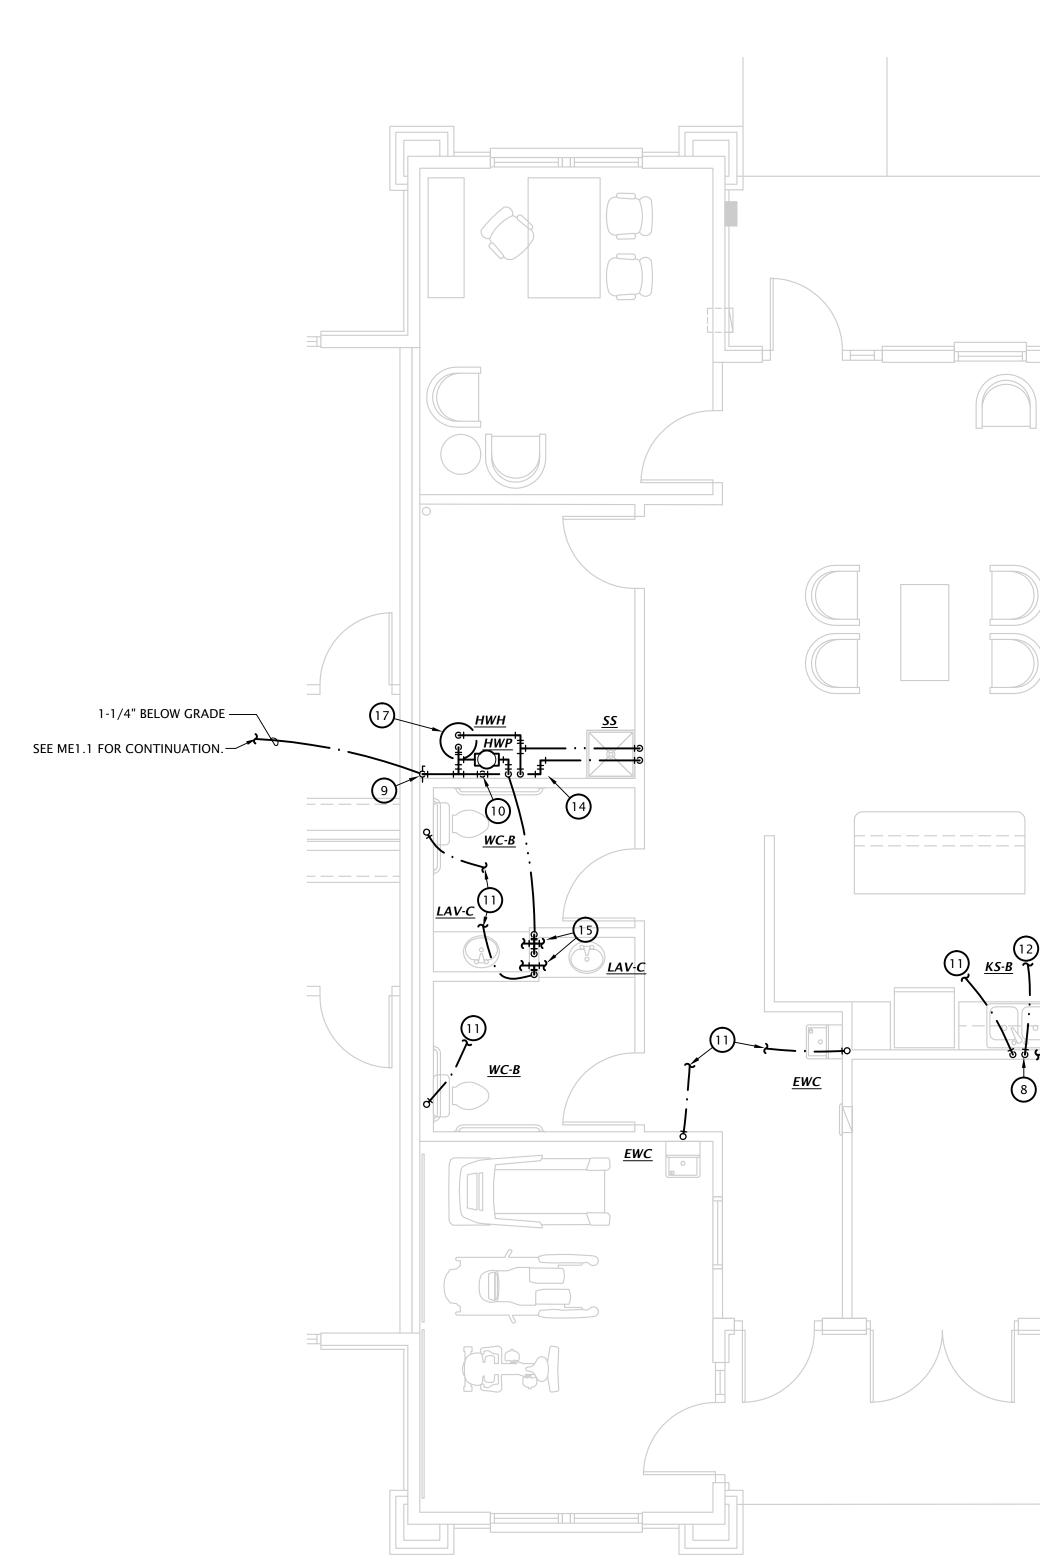



14/14



-6" BELOW CEILING

6" ABOVE FLOOR

1

MECHANICAL PLAN NOTES BY SYMBOL

1. MOUNT HEAT PUMP ON 3-1/2 CONCRETE PAD. COORDINATE EXACT LOCATION WITH

2. ROUTE REFRIGERANT PIPING FROM HEAT PUMP TO MATCHING BLOWER COIL. PENETRATE WALL 18" ABOVE GRADE AND ROUTE PIPING CONCEALED IN WALLS AND ABOVE CEILINGS. COORDINATE LINE SIZE WITH MANUFACTURER.

3. ROUTE 8"Ø OUTDOOR AIR INTAKE DUCTWORK TO WALL CAP WITH BIRDSCREEN.

4. CONNECT OUTDOOR AIR DUCTWORK TO RETURN DUCT AND BALANCE TO 160 CFM.

5. EXTEND CONDENSATE DRAIN FROM BLOWER COIL TO FLOOR DRAIN. INSTALL DRAIN LINES WITH UNION AND P-TRAP AT UNIT. TERMINATE PIPING WITH AIR GAP BETWEEN END OF PIPE AND DRAIN RECEIVER.

6. LINE TRANSFER AIR PATH WITH SHEET METAL INSIDE STUD CAVITY.

7. ROUTE 4" EXHAUST DUCT TO MANUFACTURERS ROOF JACK WITH BACK-DRAFT DAMPER AND BIRD SCREEN.

8. PROVIDED VALVED 1/2" HOT WATER BRANCH FROM KITCHEN SINK AND CONNECT DISHWASHER.

9. PROVIDE SHUT -OFF VALVE IN RISER.

10. PROVIDE 1-1/4" COPPER COLD WATER MANIFOLD WITH BRASS BALL VALVES AT EACH BRANCH. PROVIDE PEX PIPING FROM MANIFOLD BELOW SLAB TO EACH FIXTURE AS INDICATED ON PLANS. SEE PLUMBING FIXTURE SCHEDULE FOR ADDITIONAL SIZING

SHALL BE PEX WITH NO FITTINGS LOCATED BELOW SLAB. SEE PLUMBING FIXTURE SCHEDULE FOR INDIVIDUAL PIPE SIZING UNLESS OTHERWISE NOTED.

11. ROUTE CW BRANCH BELOW GRADE TO MANIFOLD AT MECH CLOSET. PIPING BELOW GRADE

12. ROUTE 1" HW PIPING BELOW GRADE TO MANIFOLD. PIPING BELOW GRADE SHALL BE PEX WITH NO FITTINGS LOCATED BELOW SLAB.

13. 1/2" PEX HOT WATER RECALCULATION LINE BELOW SLAB TO HWP. PROVIDE 1/2" SHUT OFF VALVE PRIOR TO CONNECTION TO HWP.

14. PROVIDE 3/4" COPPER HOT WATER MANIFOLD WITH BRASS BALL VALVES AT EACH BRANCH. PROVIDE PEX PIPING FROM MANIFOLD BELOW SLAB TO EACH FIXTURE AS INDICATED ON PLANS. SEE PLUMBING FIXTURE SCHEDULE FOR ADDITIONAL SIZING INFORMATION.

15. ROUTE 1/2" HW AND CW BRANCHES UP IN WALL AND PROVIDE FIXTURE BRANCHES BELOW COUNTER ALONG WALL TO FIXTURE. COORDINATE EXACT ROUTING WITH G.C.

16. PROVIDE VALVED 1/2" CW BRANCH FROM KITCHEN SINK ROUGH-IN AND ROUTE LOW IN WALL TO WALL HYDRANT. PROVIDE ACCESS PANEL IN CABINET TO SHUT-OFF VALVE.

17. CONNECT 1" HW AND CW TO 'HWH' SEE DETAIL 1:P6.1 FOR ADDITIONAL INFO.

R E

SHEET NO.:

M4.1



1 3RD FLOOR 2 BEDROOM ENLARGED FLOOR PLAN









1

2 TON 600 CFM



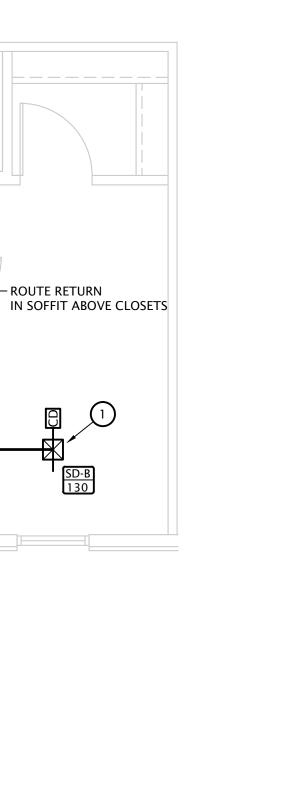



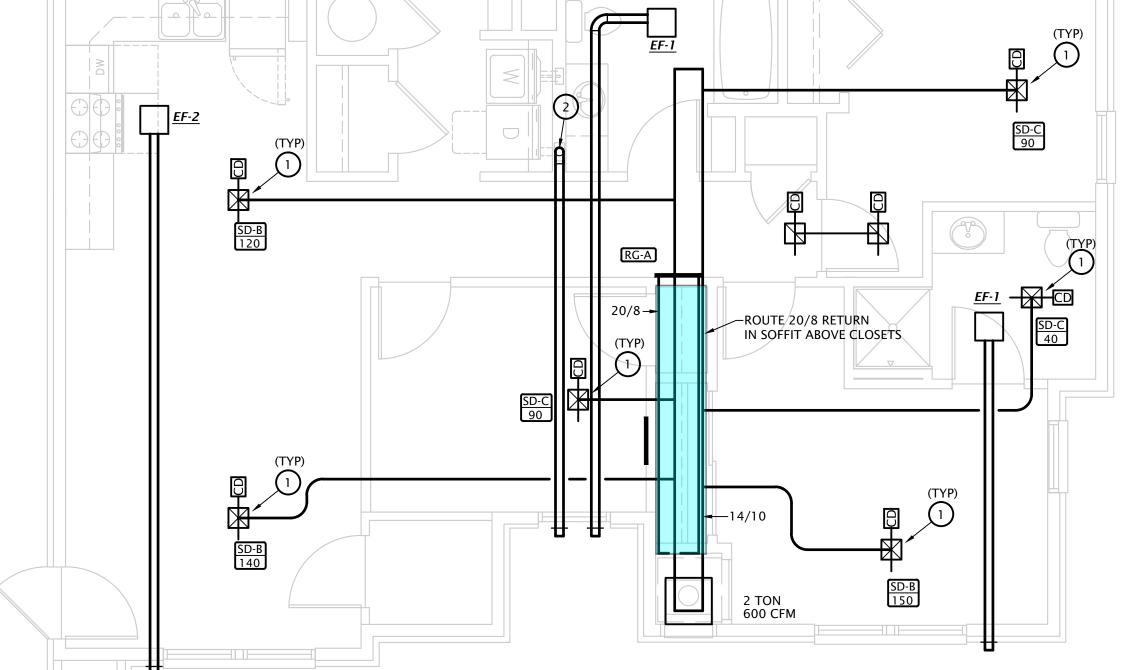

2 3 BEDROOM ENLARGED FLOOR PLAN

1/4" = 1'-0"

MECHANICAL NOTES BY SYMBOL NOTES SHOWN ARE TYPICAL FOR ALL APARTMENTS WHERE APPLICABLE.

1. PROVIDE BLOWER COIL WITH CONDENSATE OVERFLOW SHUTDOWN SWITCH.

2. PROVIDE UL LISTED DRYER BOX EQUAL TO IN-O-VATE TECHNOLOGIES IN WALL INSTALLED IN ACCORDANCE WITH MANUFACTURER'S RECOMMENDATIONS, AND ROUTE 4"Ø DRYER EXHAUST DUCT BELOW FLOOR TO WALL CAP WITH BACKDRAFT DAMPER. MANUFACTURER'S MAXIMUM ALLOWABLE DUCT LENGTH = 45' WITH TWO 90° ELBOW. COORDINATE EXACT REQUIREMENTS WITH EQUIPMENT PROVIDED. PROVIDE PERMANENT LABEL IDENTIFYING EQUIVALENT LENGTH OF DRYER DUCT INSTALLED PER IMC 504.

NOTE: ANNULAR SPACE AROUND DUCT IS TO BE SEALED AT ALL PENETRATIONS OF FLOORS AND CEILINGS WITH U.L. LISTED FIRE STOPPING

3. ROUTE REFRIGERANT PIPING FROM BLOWER COIL TO MATCHING HEAT PUMP CONCEALED ABOVE CEILINGS AND IN WALLS. SEE 'ME' SHEETS FOR HEAT PUMP LOCATIONS.

4. MOUNT TRANSFER GRILLE IN BEDROOM 6" BELOW CEILING AND MOUNT TRANSFER GRILLE ON OPPOSITE SIDE OF WALL 6" ABOVE FINISHED FLOOR. LINE STUD CAVITY WITH SHEET METAL.

5. BLOWER COIL TO BE DOWNFLOW TYPE. SEE M4.2 FOR SUPPLY DUCT ROUTING.

6. MOUNT RETURN GRILLES ON BOTH SIDES OF WALL. CENTER RETURN GRILLE BETWEEN CEILING AND TOP OF DOOR. PROVIDE TRANSFER DUCT BETWEEN GRILLES.

7. ROUTE 6"Ø EXHAUST DUCT TO WALL CAP WITH BIRD SCREEN AND BACKDRAFT DAMPER.

8. ROUTE 6"Ø OUTDOOR AIR INTAKE TO SOFFIT VENT WITH BIRD SCREEN. ENSURE OUTDOOR AIR INTAKE IS A MINIMUM OF 10'-0" FROM EXHAUST

9. CONNECT 6"Ø SUPPLY AIR FROM 'ERV' TO RETURN AIR DUCT. PROVIDE BALANCING DAMPERS AND BALANCE AS INDICATED ON PLANS, SEE DETAIL 1:M6.1 FOR MORE INFORMATION.

10. DUCT TO FLOOR BELOW, SEE SECOND FLOOR PLANS FOR CONTINUATION.

11. MAKE TRANSITION FROM 6"Ø DUCT FROM BELOW TO 14"x2" SUPPLY GRILLE IN TOE KICK.

ALL PENETRATIONS OF APARTMENT AIR BARRIERS SHALL BE SEALED TO MAINTAIN INTEGRITY OF AIR BARRIER. COORDINATE WITH G.C.

ALL DUCTWORK SHALL BE SEALED PER ENERGY STAR REQUIREMENTS. COORDINATE REQUIREMENTS WITH ENERGY

DUCTWORK AT SUPPLY, RETURN, AND TRANSFER AIR REGISTERS SHALL BE SEALED TO FLOOR, WALL, OR CEILING USING HVAC


PLUMBING SIZING SYMBOLS

(X")	DRAIN (X = SIZE)
X"	VENT (X = SIZE)
X"	WASTE STACK VENT (X = SIZE)


W&V PLAN GENERAL NOTES

- 1. SEE PLUMBING ROUGH-IN SCHEDULE ON SHEET P6.1 FOR INDIVIDUAL FIXTURE CONNECTION SIZES AND ADDITIONAL INFO.
- 2. SEE WASTE AND VENT ISOMETRICS ON SHEET P5.1 FOR ADDITIONAL INFO. 3. PIPING SHALL NOT BE ROUTED VERTICALLY IN FIREWALLS SEPARATING UNITS. ALL PIPING SHALL BE ROUTED VERTICALLY IN FURRED OUT WALLS AS INDICATED ON PLANS. VERIFY DIMENSIONS WITH ARCHITECTURAL
- 4. ALL PENETRATIONS OF APARTMENT AIR BARRIERS SHALL BE SEALED TO MAINTAIN INTEGRITY OF AIR BARRIER. COORDINATE WITH G.C.

- DISPOSER. ROUTE DRAIN AT BACK OF CABINETRY, COORDINATE EXACT ROUTING WITH G.C. COORDINATE EXACT REQUIREMENTS WITH DISHWASHER PROVIDED BY OTHERS.
- 3. SEE CIVIL DRAWINGS FOR CONTINUATION

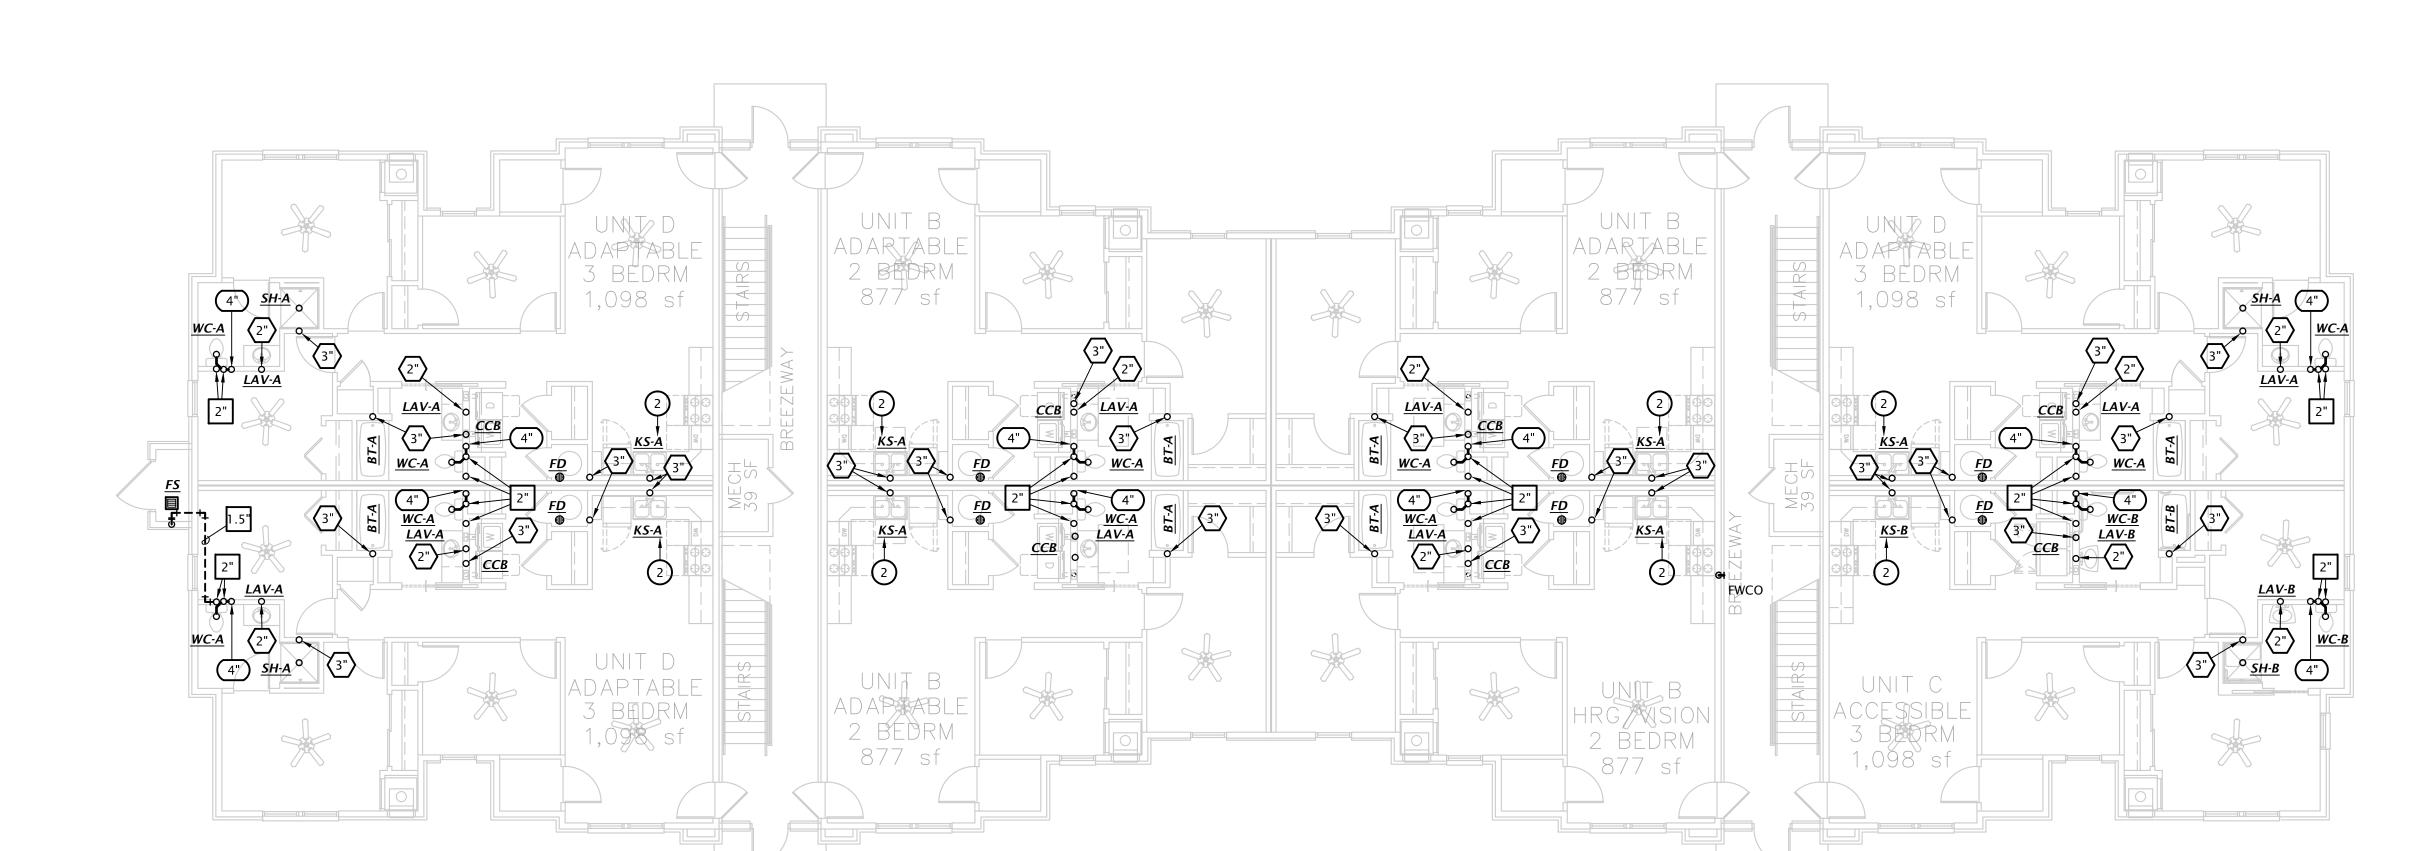

BUILDING 1 - FIRST FLOOR WASTE AND VENT PLAN1/8" = 1'-0"

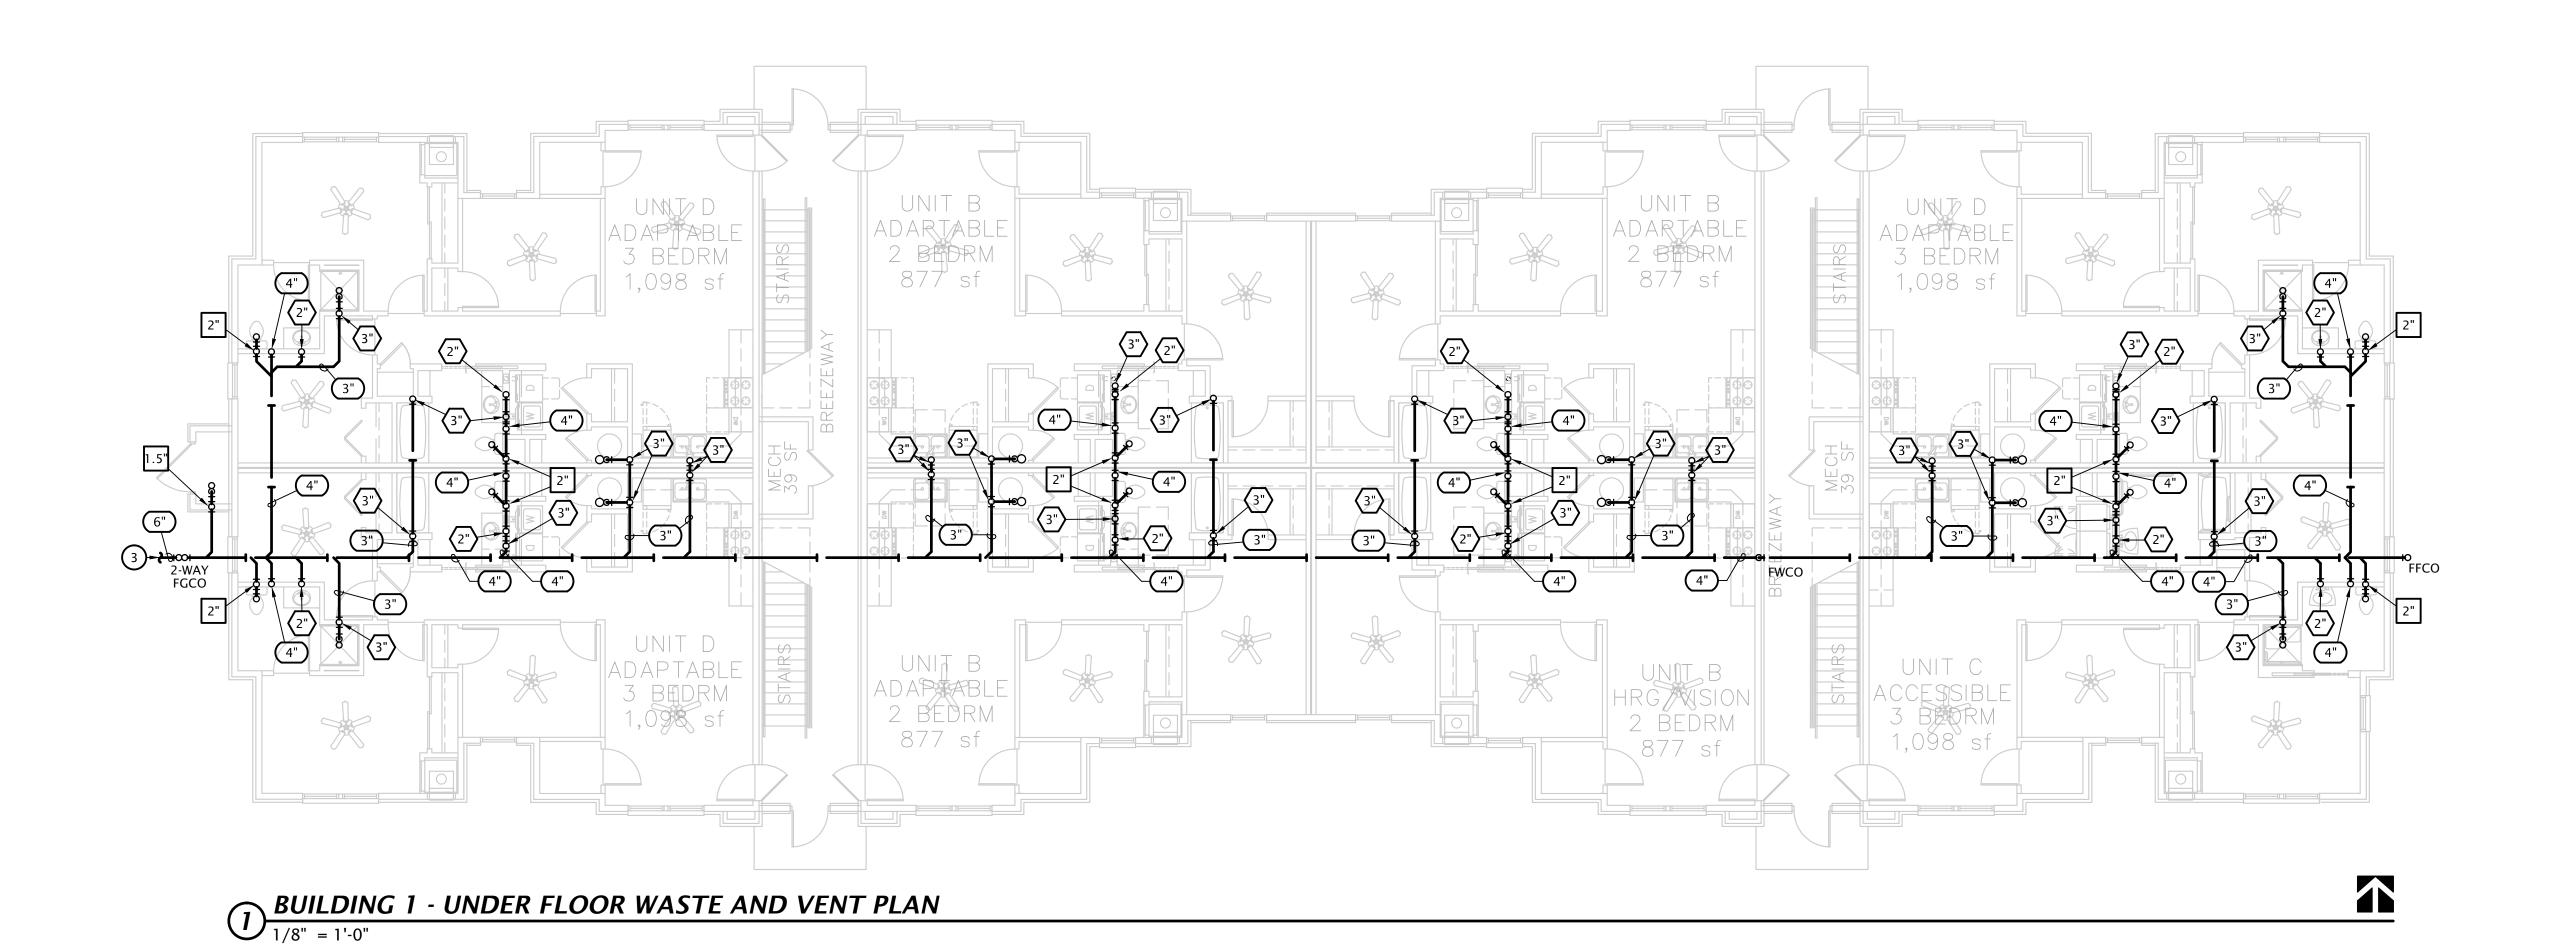

THESE DRAWINGS ARE FOR REVIEW AND PRICING PURPOSES ONLY. THESE DRAWINGS MAY BE INCOMPLETE AND ARE SUBJECT TO CHANGE.
DRAWINGS WITHOUT BE CONSTRUED TO BE CONSTRUCTION DOCUMENTS


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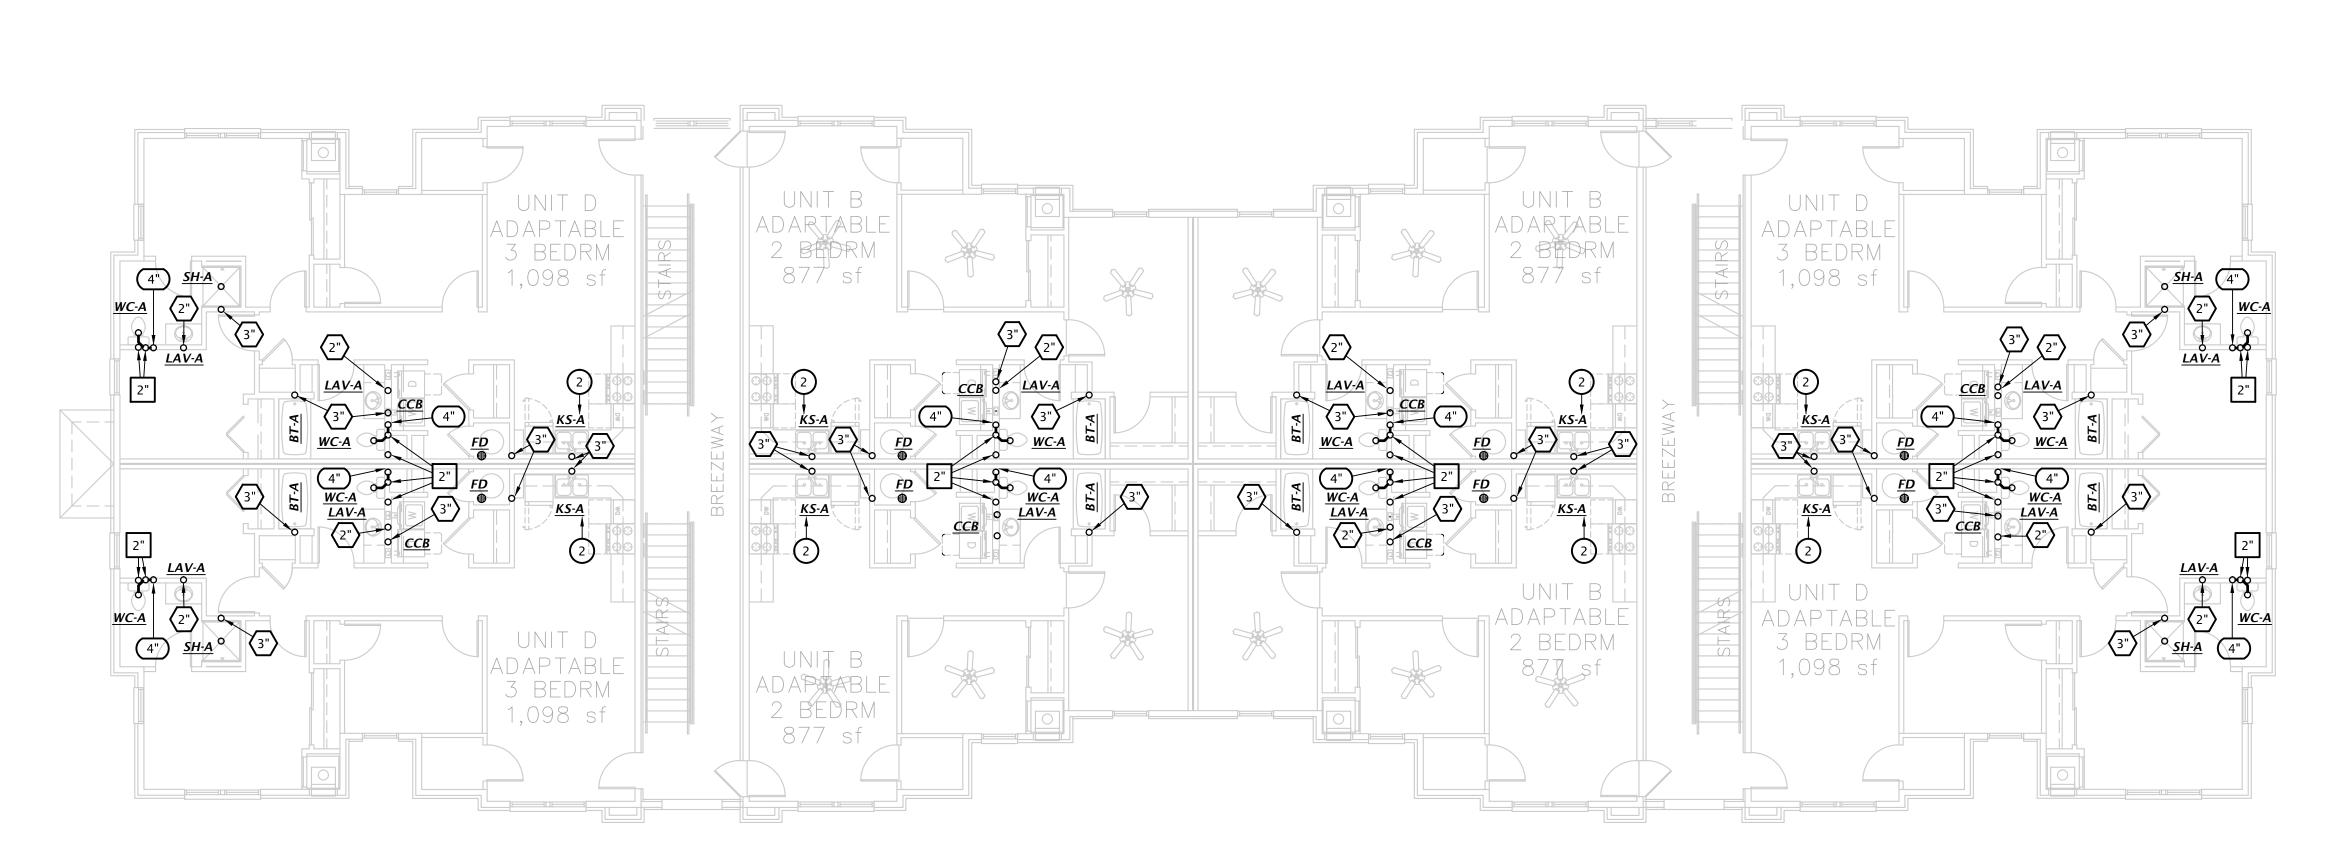
6-14-2024 22-3262 SHEET NO.:

P1.1

SHEET NO.:

P1.2



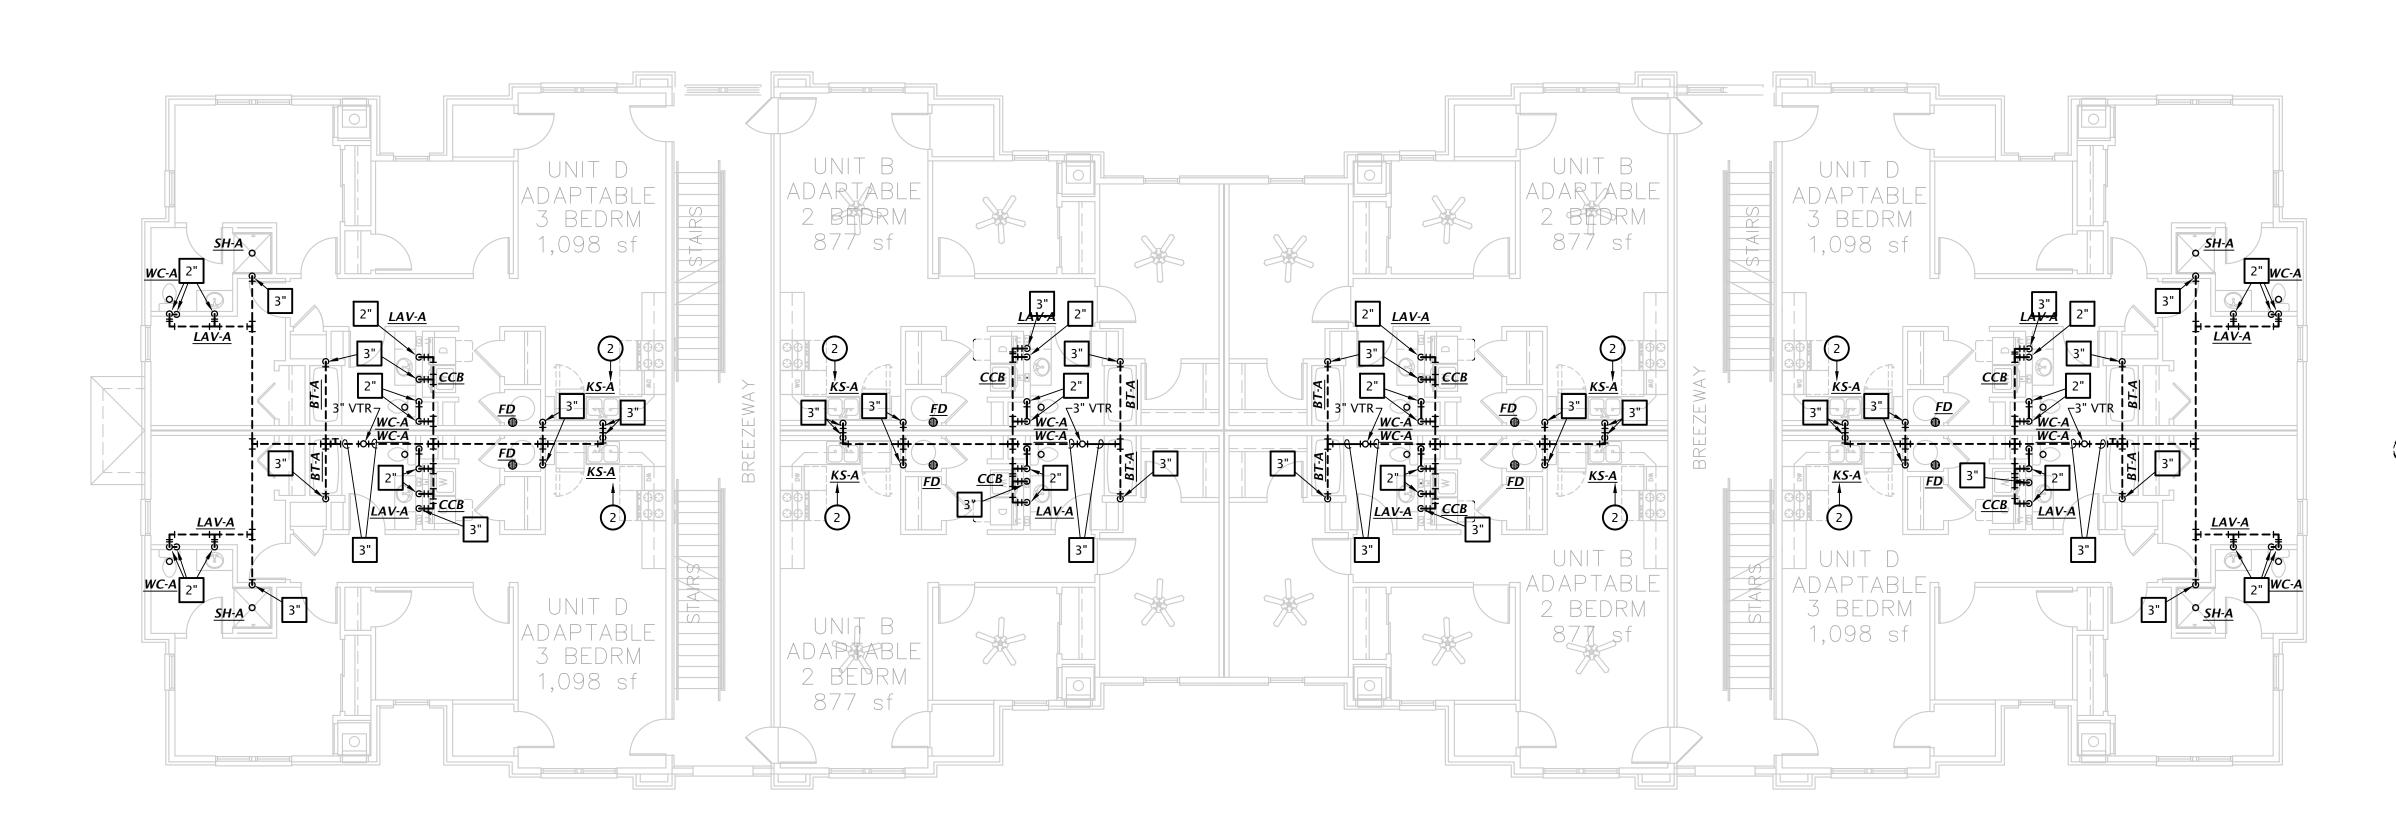

PLUMBING SIZING SYMBOLS

(X")	DRAIN (X = SIZE)
Χ"	VENT (X = SIZE)
(X")	WASTE STACK VENT (X = SIZE)

W&V PLAN GENERAL NOTES

- 1. SEE PLUMBING ROUGH-IN SCHEDULE ON SHEET P6.1 FOR INDIVIDUAL FIXTURE CONNECTION SIZES AND ADDITIONAL INFO.
- 2. SEE WASTE AND VENT ISOMETRICS ON SHEET P5.1 FOR ADDITIONAL INFO. 3. PIPING SHALL NOT BE ROUTED VERTICALLY IN FIREWALLS SEPARATING UNITS. ALL PIPING SHALL BE ROUTED VERTICALLY IN FURRED OUT WALLS AS
- 4. ALL PENETRATIONS OF APARTMENT AIR BARRIERS SHALL BE SEALED TO MAINTAIN INTEGRITY OF AIR BARRIER. COORDINATE WITH G.C.

INDICATED ON PLANS. VERIFY DIMENSIONS WITH ARCHITECTURAL

- DISPOSER. ROUTE DRAIN AT BACK OF CABINETRY, COORDINATE EXACT ROUTING WITH G.C. COORDINATE EXACT REQUIREMENTS WITH DISHWASHER PROVIDED BY OTHERS.
- 3. SEE CIVIL DRAWINGS FOR CONTINUATION


BUILDING 1 - THIRD FLOOR WASTE AND VENT PLAN1/8" = 1'-0"


VENT (X = SIZE)WASTE STACK VENT (X = SIZE)

W&V PLAN GENERAL NOTES

- 1. SEE PLUMBING ROUGH-IN SCHEDULE ON SHEET P6.1 FOR INDIVIDUAL FIXTURE CONNECTION SIZES AND ADDITIONAL INFO.
- 2. SEE WASTE AND VENT ISOMETRICS ON SHEET P5.1 FOR ADDITIONAL INFO. 3. PIPING SHALL NOT BE ROUTED VERTICALLY IN FIREWALLS SEPARATING UNITS. ALL PIPING SHALL BE ROUTED VERTICALLY IN FURRED OUT WALLS AS INDICATED ON PLANS. VERIFY DIMENSIONS WITH ARCHITECTURAL
- 4. ALL PENETRATIONS OF APARTMENT AIR BARRIERS SHALL BE SEALED TO MAINTAIN INTEGRITY OF AIR BARRIER. COORDINATE WITH G.C.

- DISPOSER. ROUTE DRAIN AT BACK OF CABINETRY, COORDINATE EXACT ROUTING WITH G.C. COORDINATE EXACT REQUIREMENTS WITH DISHWASHER PROVIDED BY OTHERS.
- 3. SEE CIVIL DRAWINGS FOR CONTINUATION

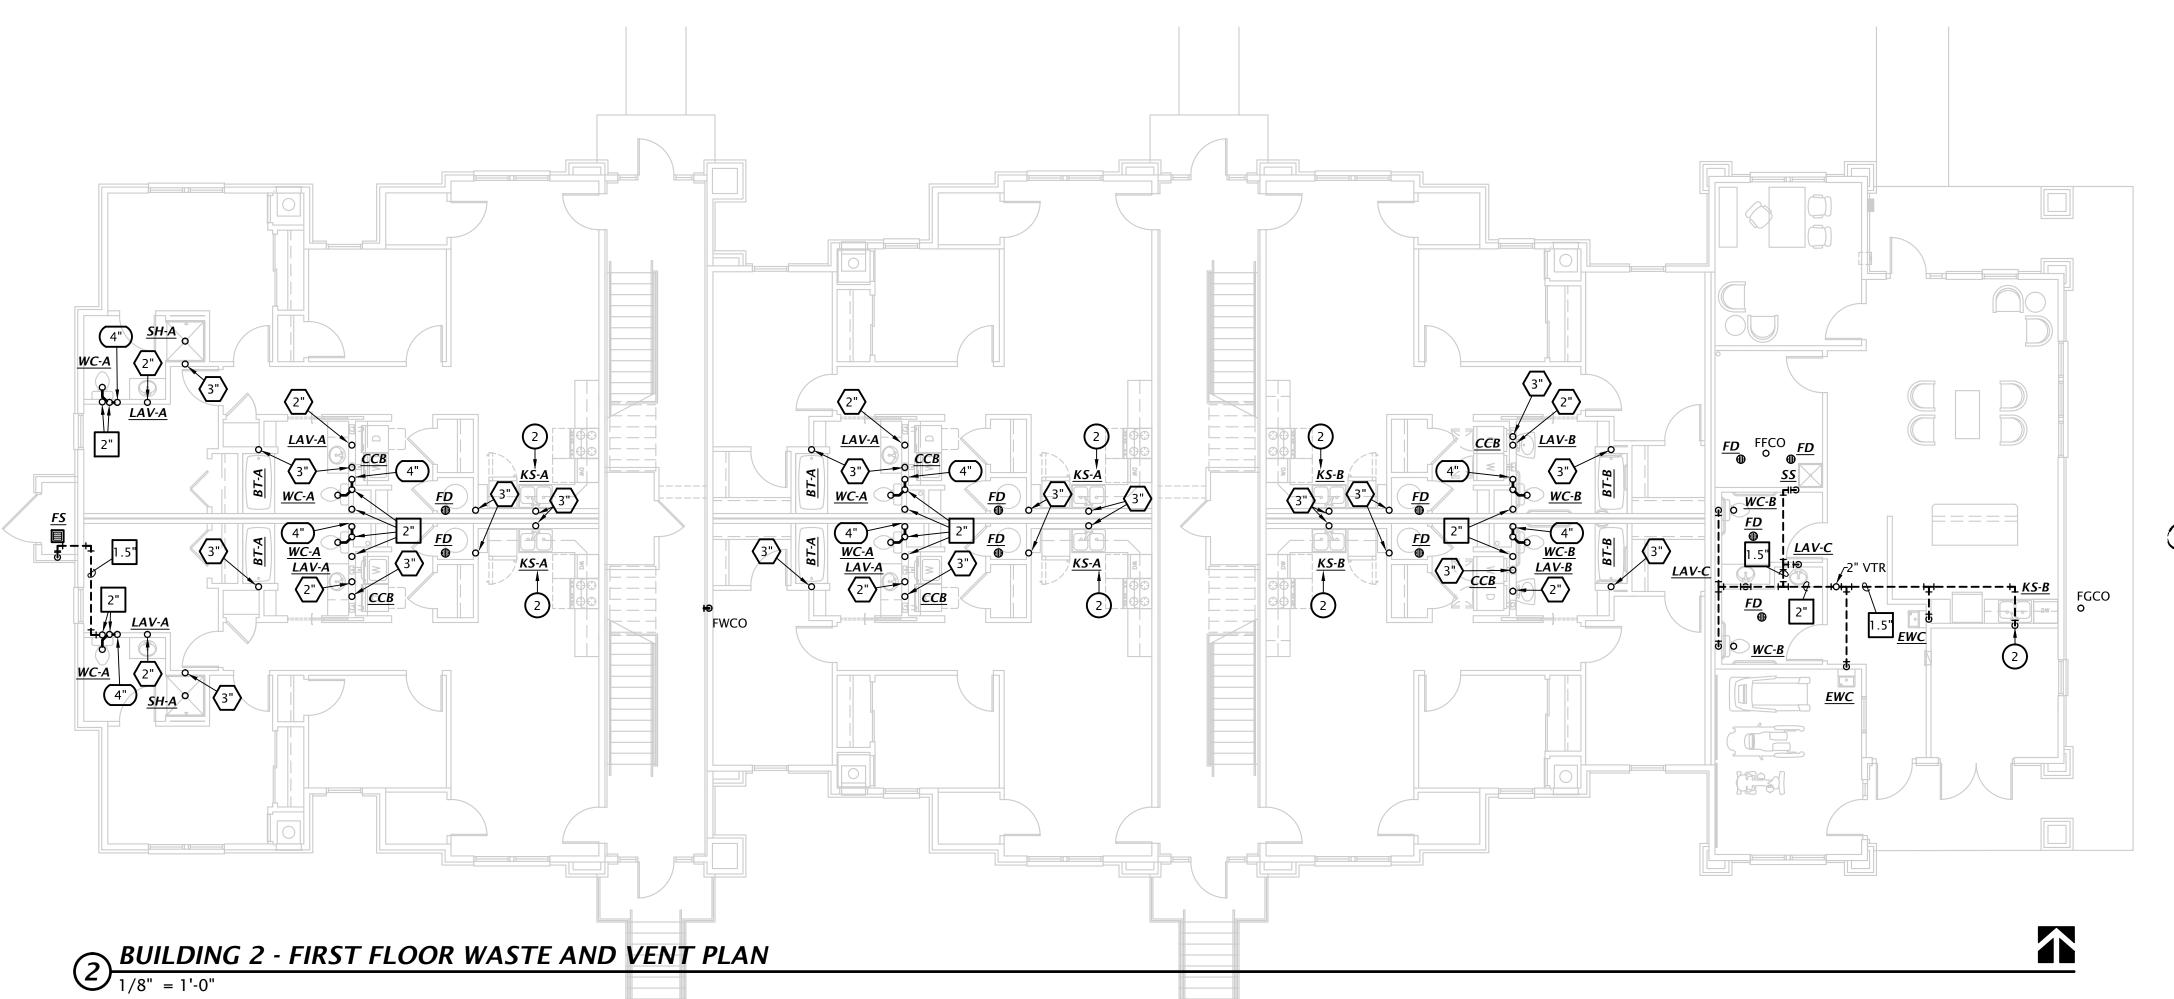

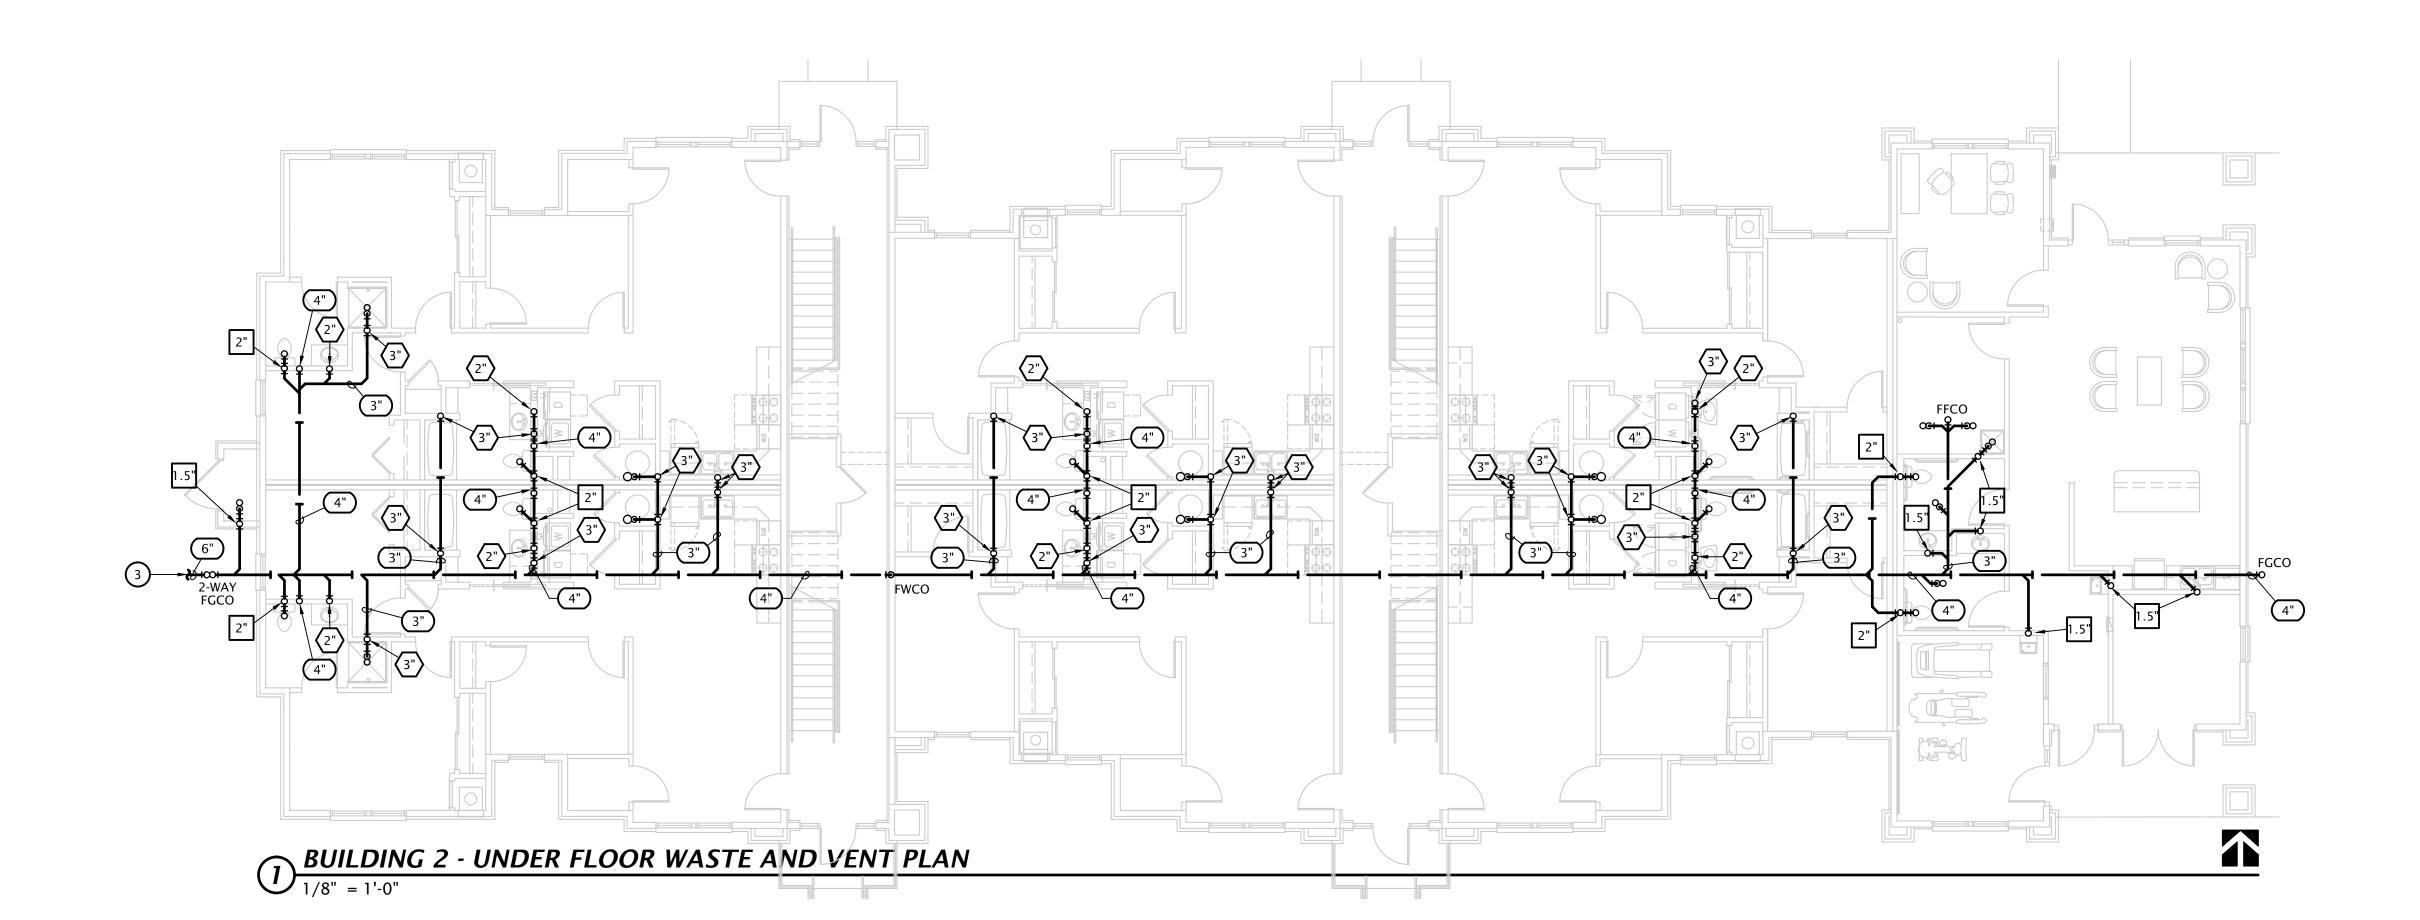

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6-14-2024 22-3262

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P1.4


PLUMBING SIZING SYMBOLS DRAIN (X = SIZE)VENT (X = SIZE)WASTE STACK VENT (X = SIZE)

W&V PLAN GENERAL NOTES


- 1. SEE PLUMBING ROUGH-IN SCHEDULE ON SHEET P6.1 FOR INDIVIDUAL FIXTURE CONNECTION SIZES AND ADDITIONAL INFO.
- 2. SEE WASTE AND VENT ISOMETRICS ON SHEET P5.1 FOR ADDITIONAL INFO. 3. PIPING SHALL NOT BE ROUTED VERTICALLY IN FIREWALLS SEPARATING UNITS. ALL PIPING SHALL BE ROUTED VERTICALLY IN FURRED OUT WALLS AS
- 4. ALL PENETRATIONS OF APARTMENT AIR BARRIERS SHALL BE SEALED TO MAINTAIN INTEGRITY OF AIR BARRIER. COORDINATE WITH G.C.

INDICATED ON PLANS. VERIFY DIMENSIONS WITH ARCHITECTURAL

- DISPOSER. ROUTE DRAIN AT BACK OF CABINETRY, COORDINATE EXACT ROUTING WITH G.C. COORDINATE EXACT REQUIREMENTS WITH DISHWASHER PROVIDED BY OTHERS.
- 3. SEE CIVIL DRAWINGS FOR CONTINUATION

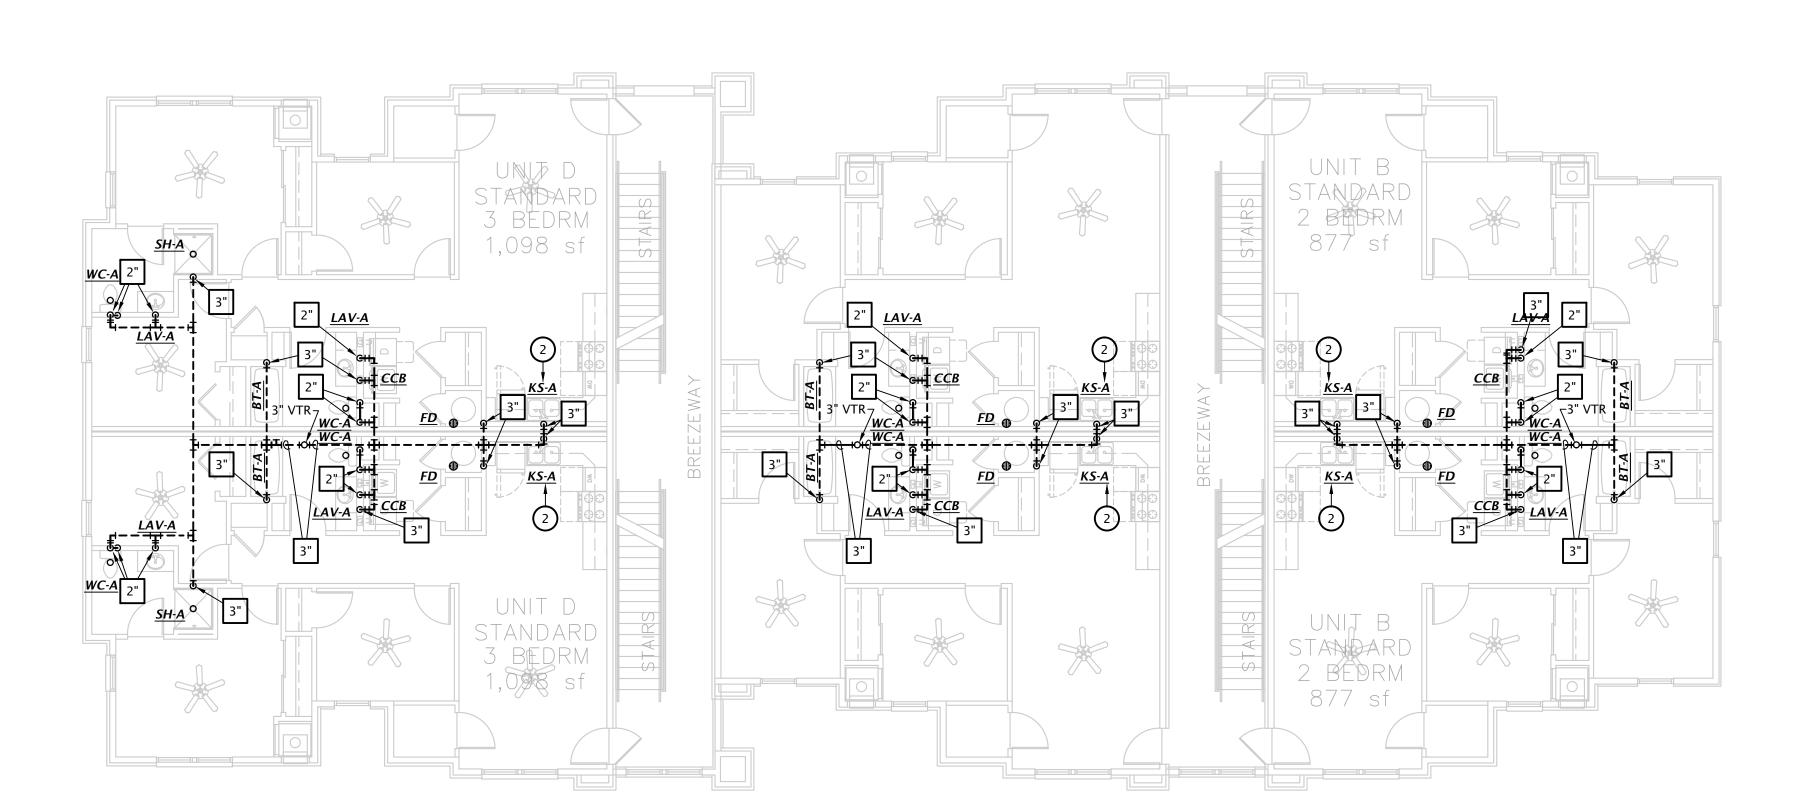

BUILDING 2 - THIRD FLOOR WASTE AND VENT PLAN1/8" = 1'-0"

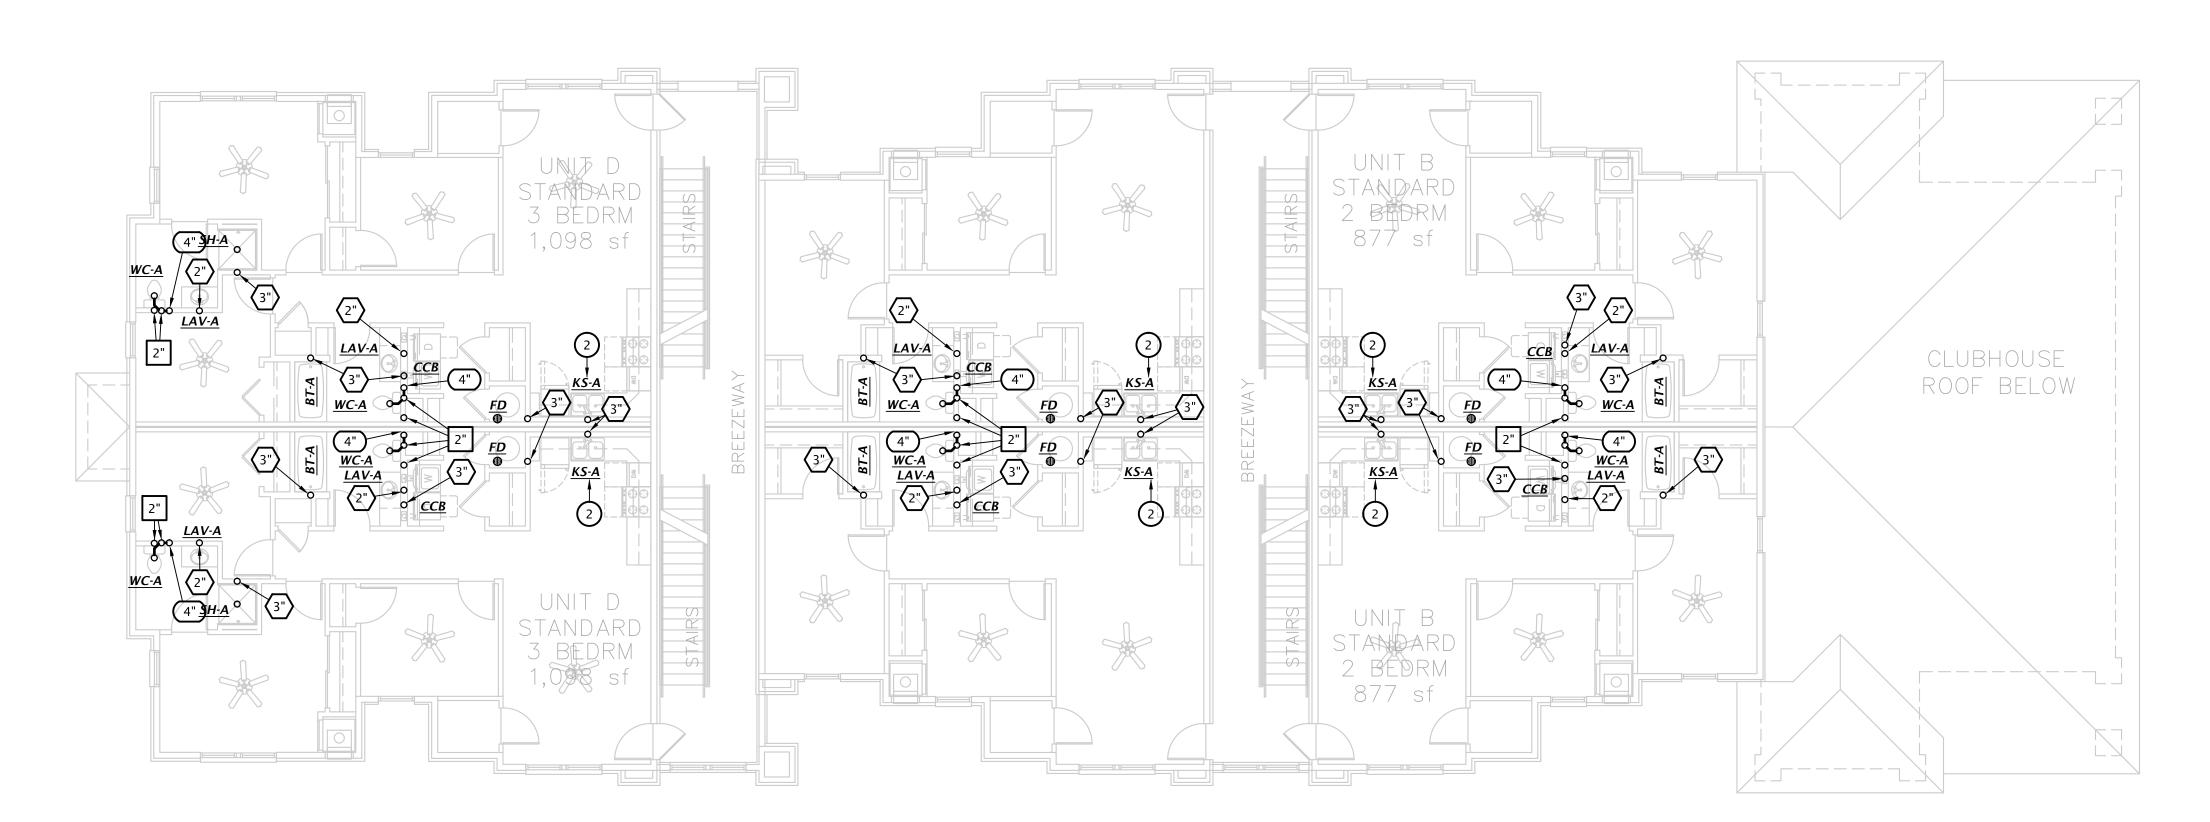

CONSTRUCTION DOCUMENTS

6-14-2024


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P4.1




PLUMBING PLAN NOTES BY SYMBOL

- 1. SEE OVERALL DOMESTIC WATER PLANS FOR CONTINUATION.
- PROVIDE 1-1/4" WATER SERVICE TO APARTMENT WITH SHUT-OFF VALVE. SEE DOMESTIC RISER DIAGRAMS ON SHEET P5.2 FOR ADDITIONAL INFORMATION.
- 4. PROVIDE 1/2" VALVED BRANCH BELOW SINK AND CONNECT DISHWASHER. ROUTE PIPING ALONG BACK OF CABINETRY, COORDINATE EXACT ROUTING WITH G.C. COORDINATE EXACT REQUIREMENTS WITH DISHWASHER

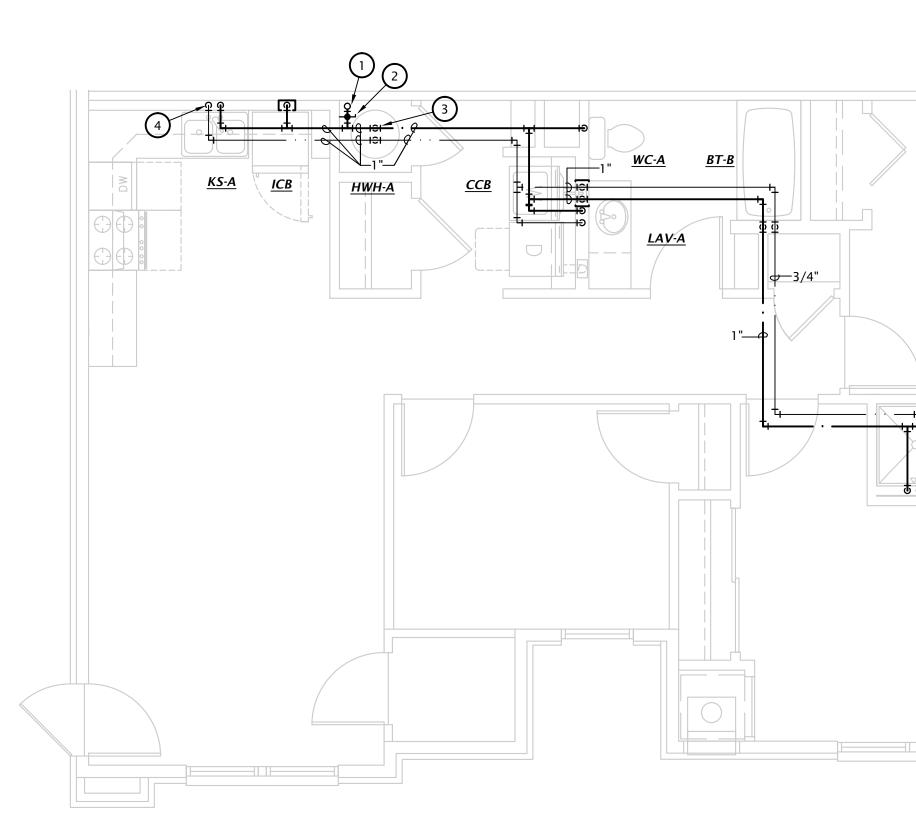


2 3 BEDROOM ENLARGED FLOOR PLAN 1/4" = 1'-0"

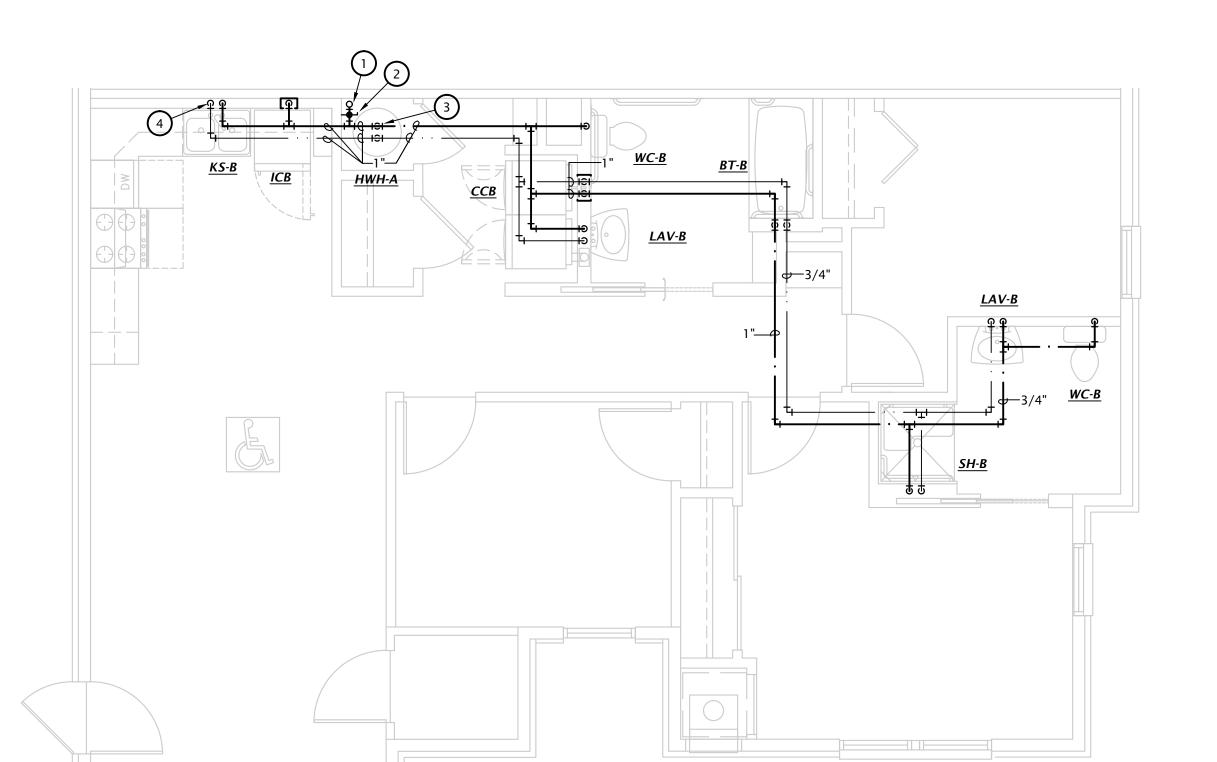


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3 BEDROOM ACCESSIBLE ENLARGED FLOOR PLAN 1/4" = 1'-0"



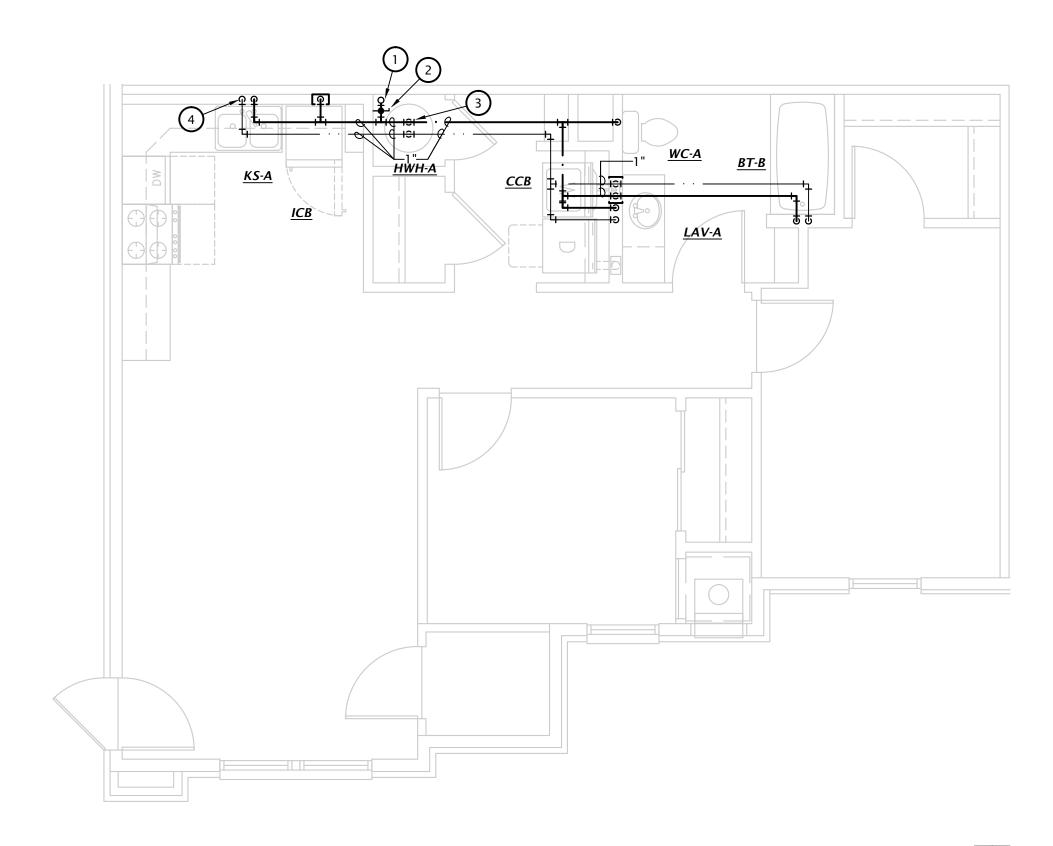

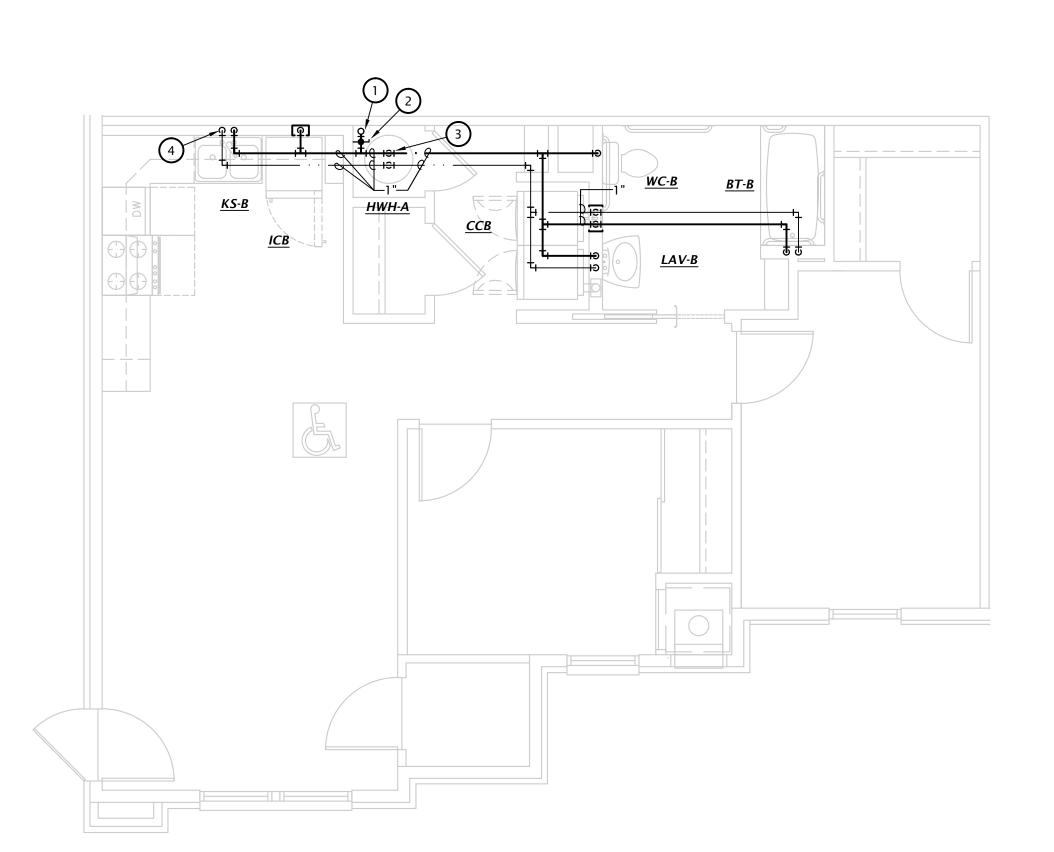

3 2 BEDROOM ACCESSIBLE ENLARGED FLOOR PLAN
1/4" = 1'-0"

1

ENGINEER'S SEAL AND SIGNATURE SHALL IN NO WAY BE CONSTRUED TO BE CONSTRUCTION DOCUMENTS.


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6-14-2024 22-3262

P5.1

WATE AND VENT ISOMETIRIC GENERAL NOTES

- 1. SEE PLUMBING ROUGH-IN SCHEDULE ON SHEET P6.1 FOR INDIVIDUAL FIXTURE CONNECTION SIZES AND ADDITIONAL INFO.
- 2. SEE WASTE AND VENT PLANS FOR ADDITIONAL ROUTING AND SIZING INFO.
- 3. PROVIDE CLEANOUT IN THE BASE OF EACH WASTE STACK.
- 4. ISOMETRICS SHOWN ARE TYPICAL AND OTHER APARTMENTS SHALL BE SIMILAR.

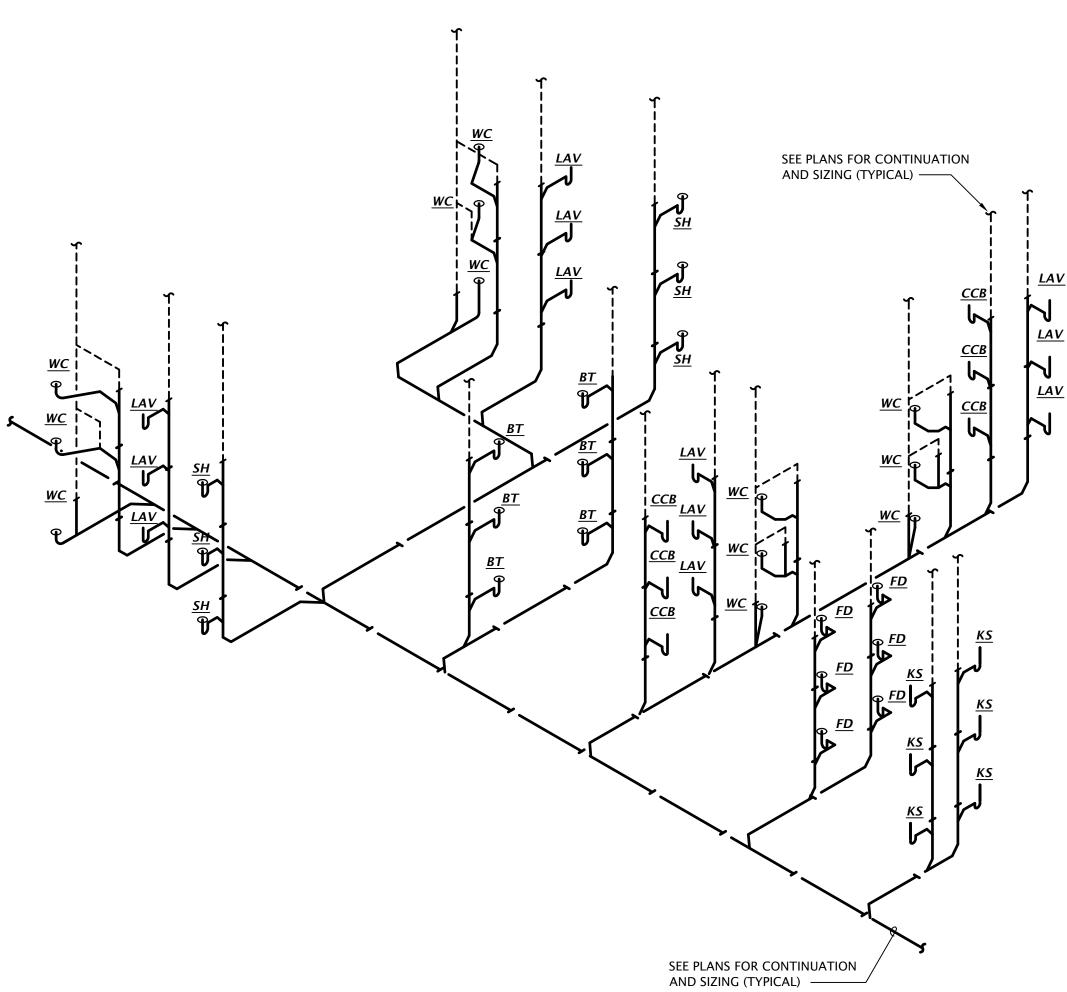

3 TYPICAL TWO BEDROOM WASTE AND VENT ISOMETRIC
No Scale

SEE PLANS FOR CONTINUATION AND SIZING (TYPICAL)

SEE PLANS FOR CONTINUATION AND SIZING (TYPICAL)

3 TYPICAL THREE BEDROOM WASTE AND VENT ISOMETRIC
No Scale


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CONSTRUCTION DOCUMENTS. **REVISION:**


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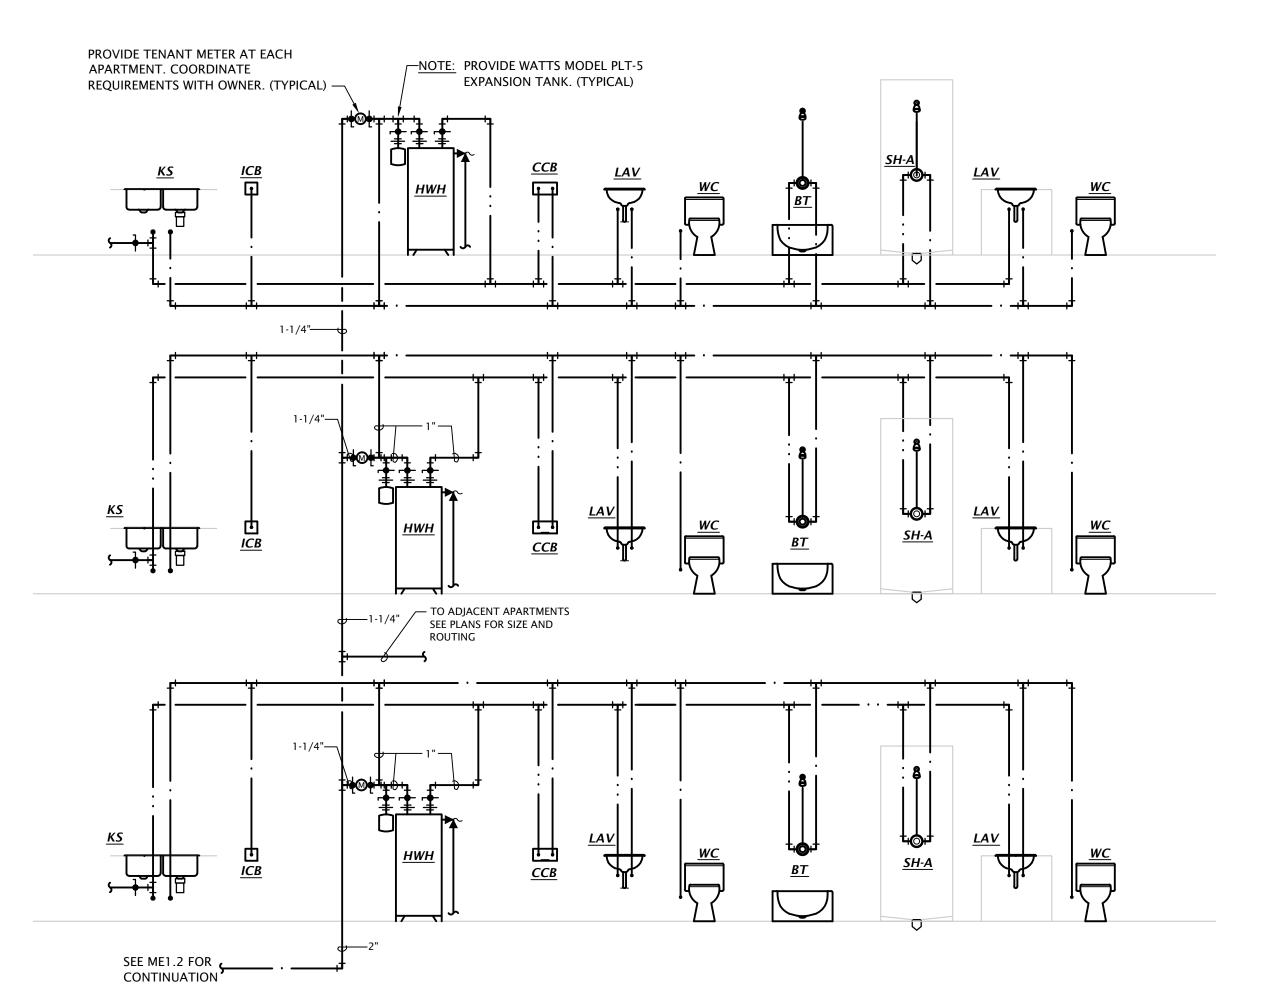
P5.2




3 BEDROOM DOMESTIC WATER RISER DIAGRAM Not to Scale



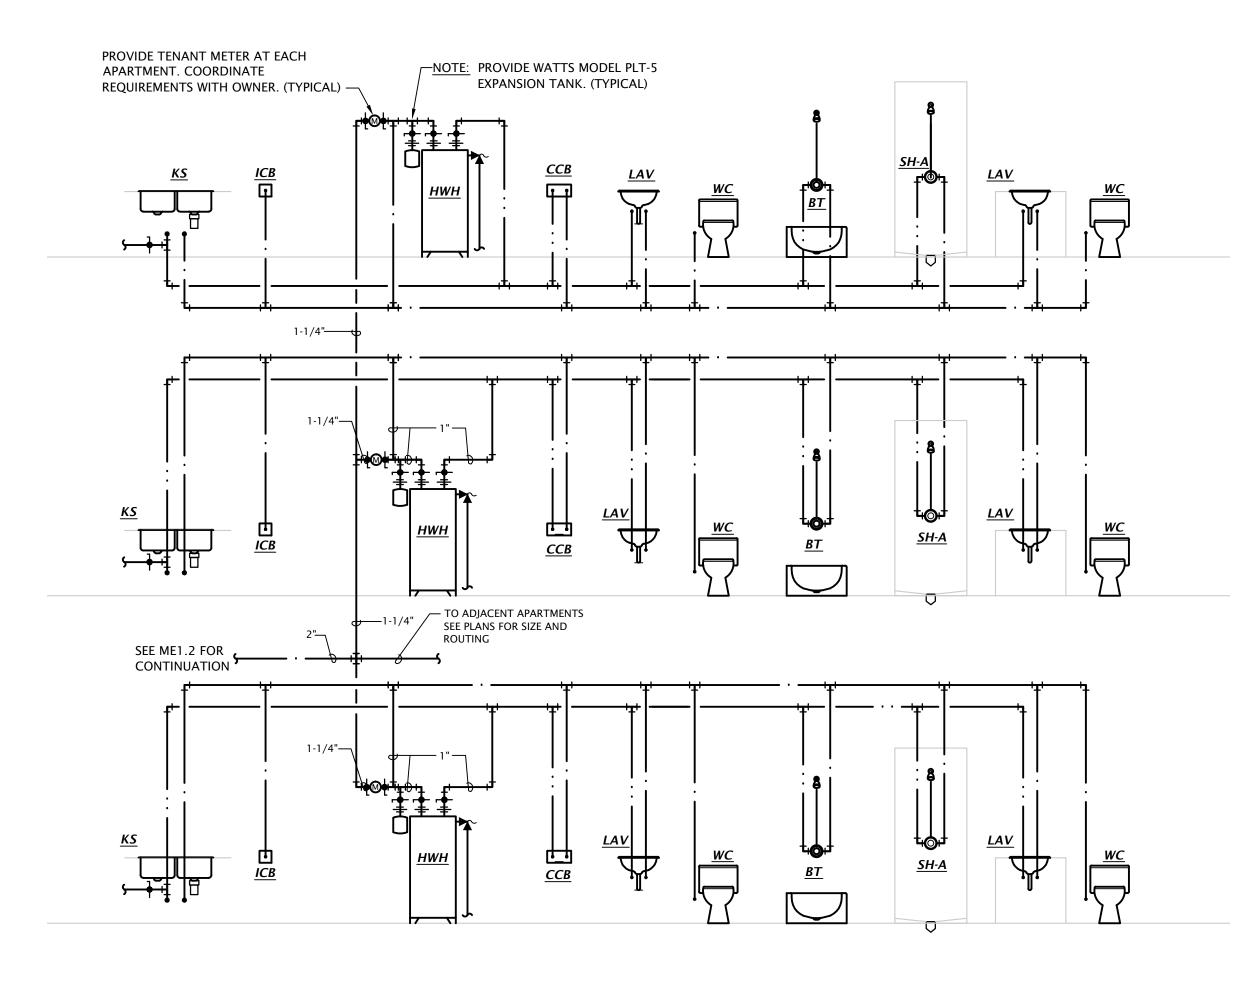


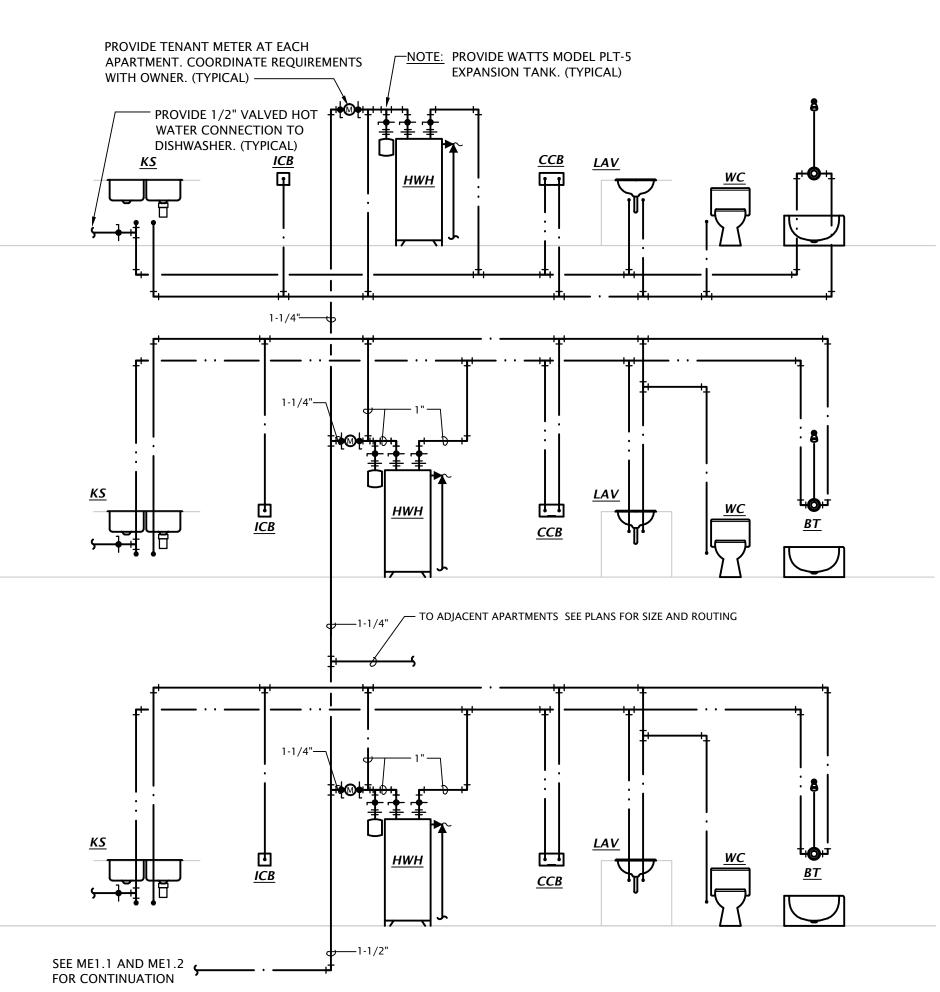

3 BEDROOM DOMESTIC WATER RISER DIAGRAM (BELOW GRADE) Not to Scale

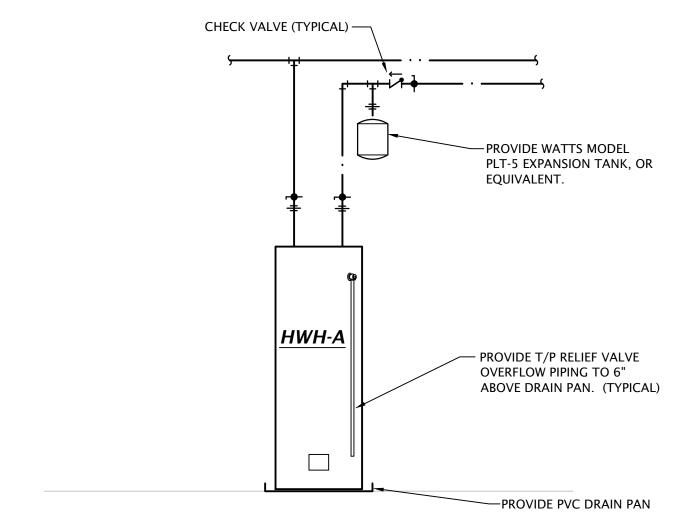

APARTMENT WATER HEATER DETAIL Not to Scale

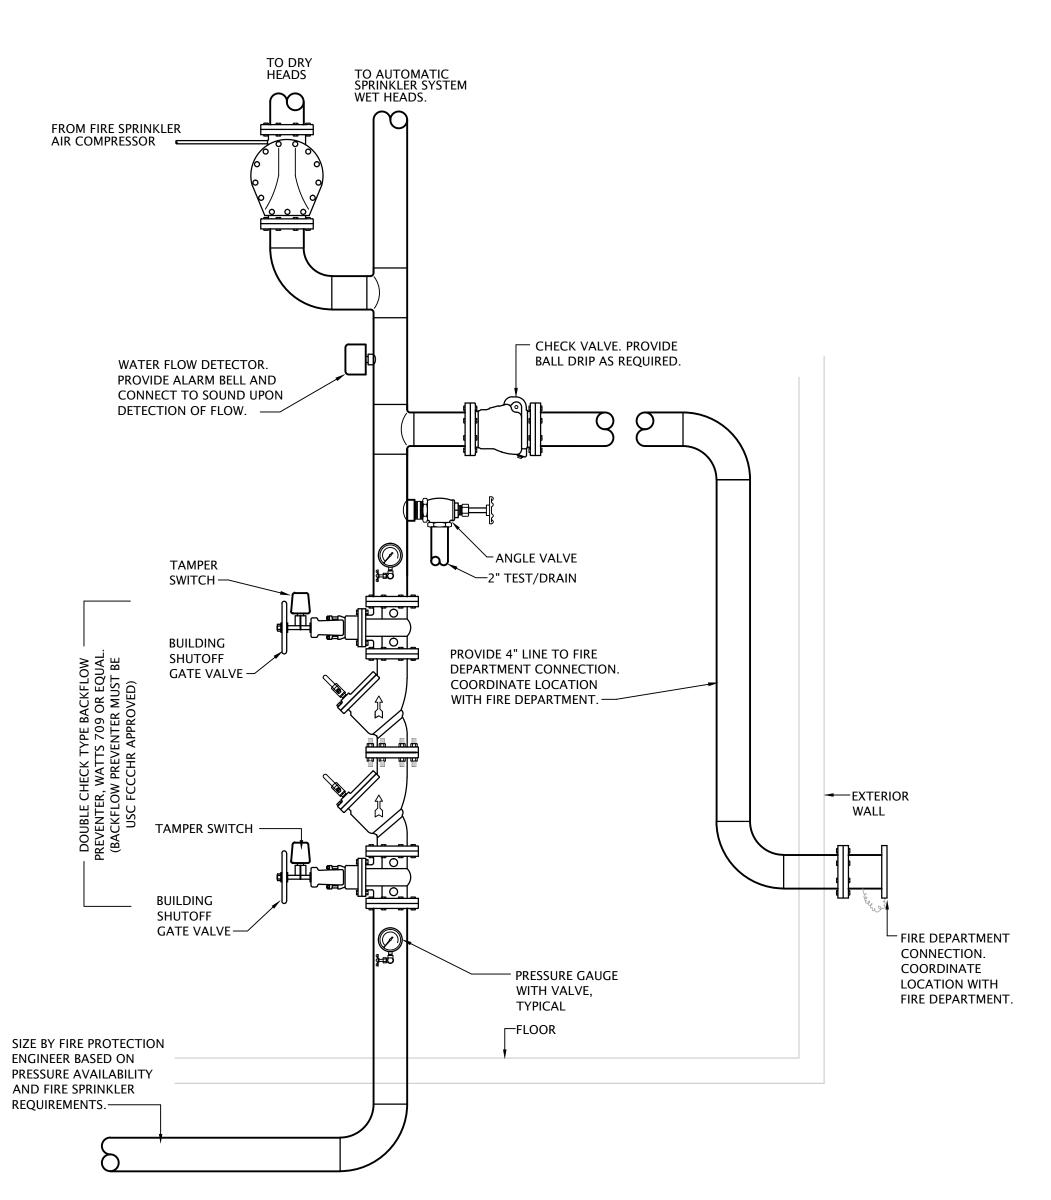

FIRE PROTECTION RISER DIAGRAM



o —	PIPE TURNING UP
с—	PIPE TURNING DOWN
	COLD WATER PIPING
	HOT WATER PIPING
w	- WATER SERVICE PIPING
—— FP ——	FIRE PROTECTION SERVICE PIPING
—	- WASTE PIPING BELOW GRADE
	- WASTE PIPING ABOVE GRADE
	- VENT PIPING
—— G ——	- NATURAL GAS PIPING
Z	CHECK VALVE
⋈	GATE VALVE
•	BALL VALVE
ф	UNION
<u>~</u>	T/P RELIEF VALVE

MARK	MANUFACTURER	DESCRIPTION		TRIM		ROUGH-IN	N SIZES		NOT
MAKK	MANOTACTORER	DESCRIPTION	MANUFACTURER	DESCRIPTION	WASTE	VENT	CW	HW	NOT
WC-A	KOHLER	Model 5296 "Highline" ADA compliant flush tank water closet, white vitreous china, two piece, 12" rough-in, elongated 16-1/2" high bowl, siphon jet flushing action, 1.28 GPF, polished chrome actuator located on open side of room.	K-5588 Purefresh white, elongated closed front seat and cover KOHLER		4"	2"	1/2"		
WC-B	KOHLER	Model 5296 "Highline" ADA compliant flush tank water closet, white vitreous china, two piece, 12" rough-in, elongated 16-1/2" high bowl, siphon jet flushing action, 1.28 GPF, polished chrome actuator located on open side of room.	KOHLER	K-5588 Purefresh white, elongated closed front seat and cover	4"	2"	1/2"		1
LAV-A	KOHLER	Model 2196-4-0 self-rimming lavatory, white vitreous china, 20"W \times 17", faucet holes on 4" centers.	KOHLER	Model 15182-4DRA, 0.5 GPM, single handle faucet. Provide pop-up drain.	2"	1-1/2"	1/2"	1/2"	2,4
LAV-B	KOHLER	Model 2005-0 wall hung lavatory, white vitrous china, $18-1/4$ "W x $17-1/4$ ", faucet holes on 4" centers.	KOHLER	Model 15199-4DRA, 0.5 GPM, single handle faucet. Provide pop-up drain.	2"	1-1/2"	1/2"	1/2"	1,2,3
LAV-C	KOHLER	Model 2196-4-0 self-rimming lavatory, white vitreous china, 20"W x 17", faucet holes on 4" centers.	KOHLER	Model 15182-4NDRA single handle faucet. Provide grid drain. Provide point of use tempering valve.	2"	1-1/2"	1/2"	1/2"	1,2,3
KS-A	JUST	Model DL-2233-A-GR two compartment 18 GA stainless steel sink, self rimming, 14"x16"x8"D inside, fully undercoated, faucet holes as req.	KOHLER IN-SINK-ERATOR	Model K-10412, 1.5 GPM, single handle kitchen sink faucet with hose spray attachment. Chrome finish. Provide basket strainer. "Badger 5" garbage disposal, 1/2hp, 120V,	2"	1-1/2"	1/2"	1/2"	2,4
KS-B	JUST	Model DL-ADA-2233-A-GR two compartment 18 GA stainless steel sink, self rimming, 14"x16"x5"D inside, fully undercoated, faucet holes as req., and drain holes center rear.	KOHLER IN-SINK-ERATOR	cord and plug connected. Model K-10412, 1.5 GPM, single handle kitchen sink faucet with hose spray attachment. Chrome finish. Provide basket strainer. "Badger 5" garbage disposal, 1/2hp, 120V,	2"	1-1/2"	1/2"	1/2"	1,3,2
BT-A	AQUARIUS	Model G 6063 TS reinforced fiberglass tub/shower, 60"W x35-3/4"D x76-1/2"H, with integral soap/toiletry shelves, right or left hand rough-in as required, white finish.	DELTA	cord and plug connected. Model R10000-UNWS/T13H232 single handle pressure-balancing valve with metal tub filler with pull diverter, 1.5 GPM push-clean showerhead and pop-up drain with overflow.	2"	1-1/2"	1/2"	1/2"	2,4,
ВТ-В	AQUARIUS	Model S 6000 TS OT reinforced fiberglass ADA tub/shower, 60"W x33"D x82"H, with integral soap/toiletry shelves and grab bars in accordance with ADA requirements, seat at end of tub, right or left hand rough-in as required, white finish.	DELTA	Model R10000-UNWS/T13H252 pressure balancing tub/shower valve with non-positive shut-off control and temperature control to ensure maximum 120° water with single metal lever handle, 1.5 GPM handshower with double check valves, flexible hose, 24" stainless steel slide bar, metal lever handshower, diverter valve, and shower head with arm.	2"	1-1/2"	1/2"	1/2"	1,2,4
SH-A	AQUARIUS	Model G-3679-SH cast acrylic shower, 36"W x36"D x79"H, with integral soap/toiletry shelves, right or left hand rough-in as required, center drain, white finish.	DELTA	Model R10000-UNWS/T13H132 single handle pressure-balancing valve, 1.5 GPM push-clean showerhead.	2"	1-1/2"	1/2"	1/2"	1,5
SH-B	AQUARIUS	Model G-3682 BF cast acrylic shower, 36" square inside, 18 gauge stainless steel grab bars, fold up padded seat, molded soap shelves, brass drain w/chrome strainer, collapsible water dam, right or left hand rough-in as required.	DELTA	Model R10000-UNWS/T13220-H2OT pressure balancing shower valve with integral temperature limits, single metal lever handle, 1.5 GPM handshower with double check valves, flexible hose, and 24" stainless steel slide bar.	2"	1-1/2"	1/2"	1/2"	1,5
SS	FIAT	Model MSB-2424 one piece molded stone mop vac		Model 28T9 faucet with hose thread outlet, vacuum breaker, pail hook, wall brace, metal lever handles.	3"	1-1/2"	3/4"	3/4"	4
EWC	ELKAY	Model EMABFTLDDWSLK ADA compliant dual height, self-contained water cooler with stainless steel basin, front and side push bar actuator, lead-free, 120 volts. Provide unit with EZH20 bottle filling station. Provide unit with Model 98313C Accessory Apron.					1/2"		
WH	WOODFORD	Model 25 frost proof wall hydrant with anti-siphon			3/4"				
ССВ	IPS CORP.	Model W4700 recessed washing machine box with turn adaptor ball valves, sweat connection.	2"PVC/ABS drain co	oupling and knockout test cap. Two, 1/4	2"	2"	1/2"	1/2"	
ICB	IPS CORP.	Model FRIB12 ice maker connection box with 1/4 t	urn ball valve and 1	/2" sweat copper connection.			1/2"		
FD	SIOUX CHIEF	Series 833 adjustable floor drain with nickel bronz			2"				
FS	SIOUX CHIEF	Series 861 PVC floor sink with PVC strainer. Provide			4"				
13	SIOUX CHIEF	Model ENJ-40, 40 gallon electric water heater, 0.93							

GENERAL:

Provide fixtures with all trim necessary for complete installation

1. Fixture and installation to meet accessibility requirements of the Fair Housing Act.

2. Provide 1/4 turn angle stops with escutcheon plates, and chrome plated or braided stainless steel supplies, and 1-1/4" cast brass p-trap.

3. Insulate water and waste piping below lavatory. Utilize insulation kit equivalent to LavGuard by Truebro.

4. Trim shall be provided with polished chrome finish.

5. Fixture shall be WaterSense labeled.

LST Consulting Engineers, PA
MANHATTAN

4809 Vue Du Lac Place, Suite 201
Manhattan, KS 66503
785.587.8042


LST Consulting Engineers, PA
WICHITA

125 S. Washington, Suite 150
Wichita, Kansas 67202
316.285.0696

REVISION:

10-2-2023 DATE: 22-3219 SHEET NO.:

P6.1

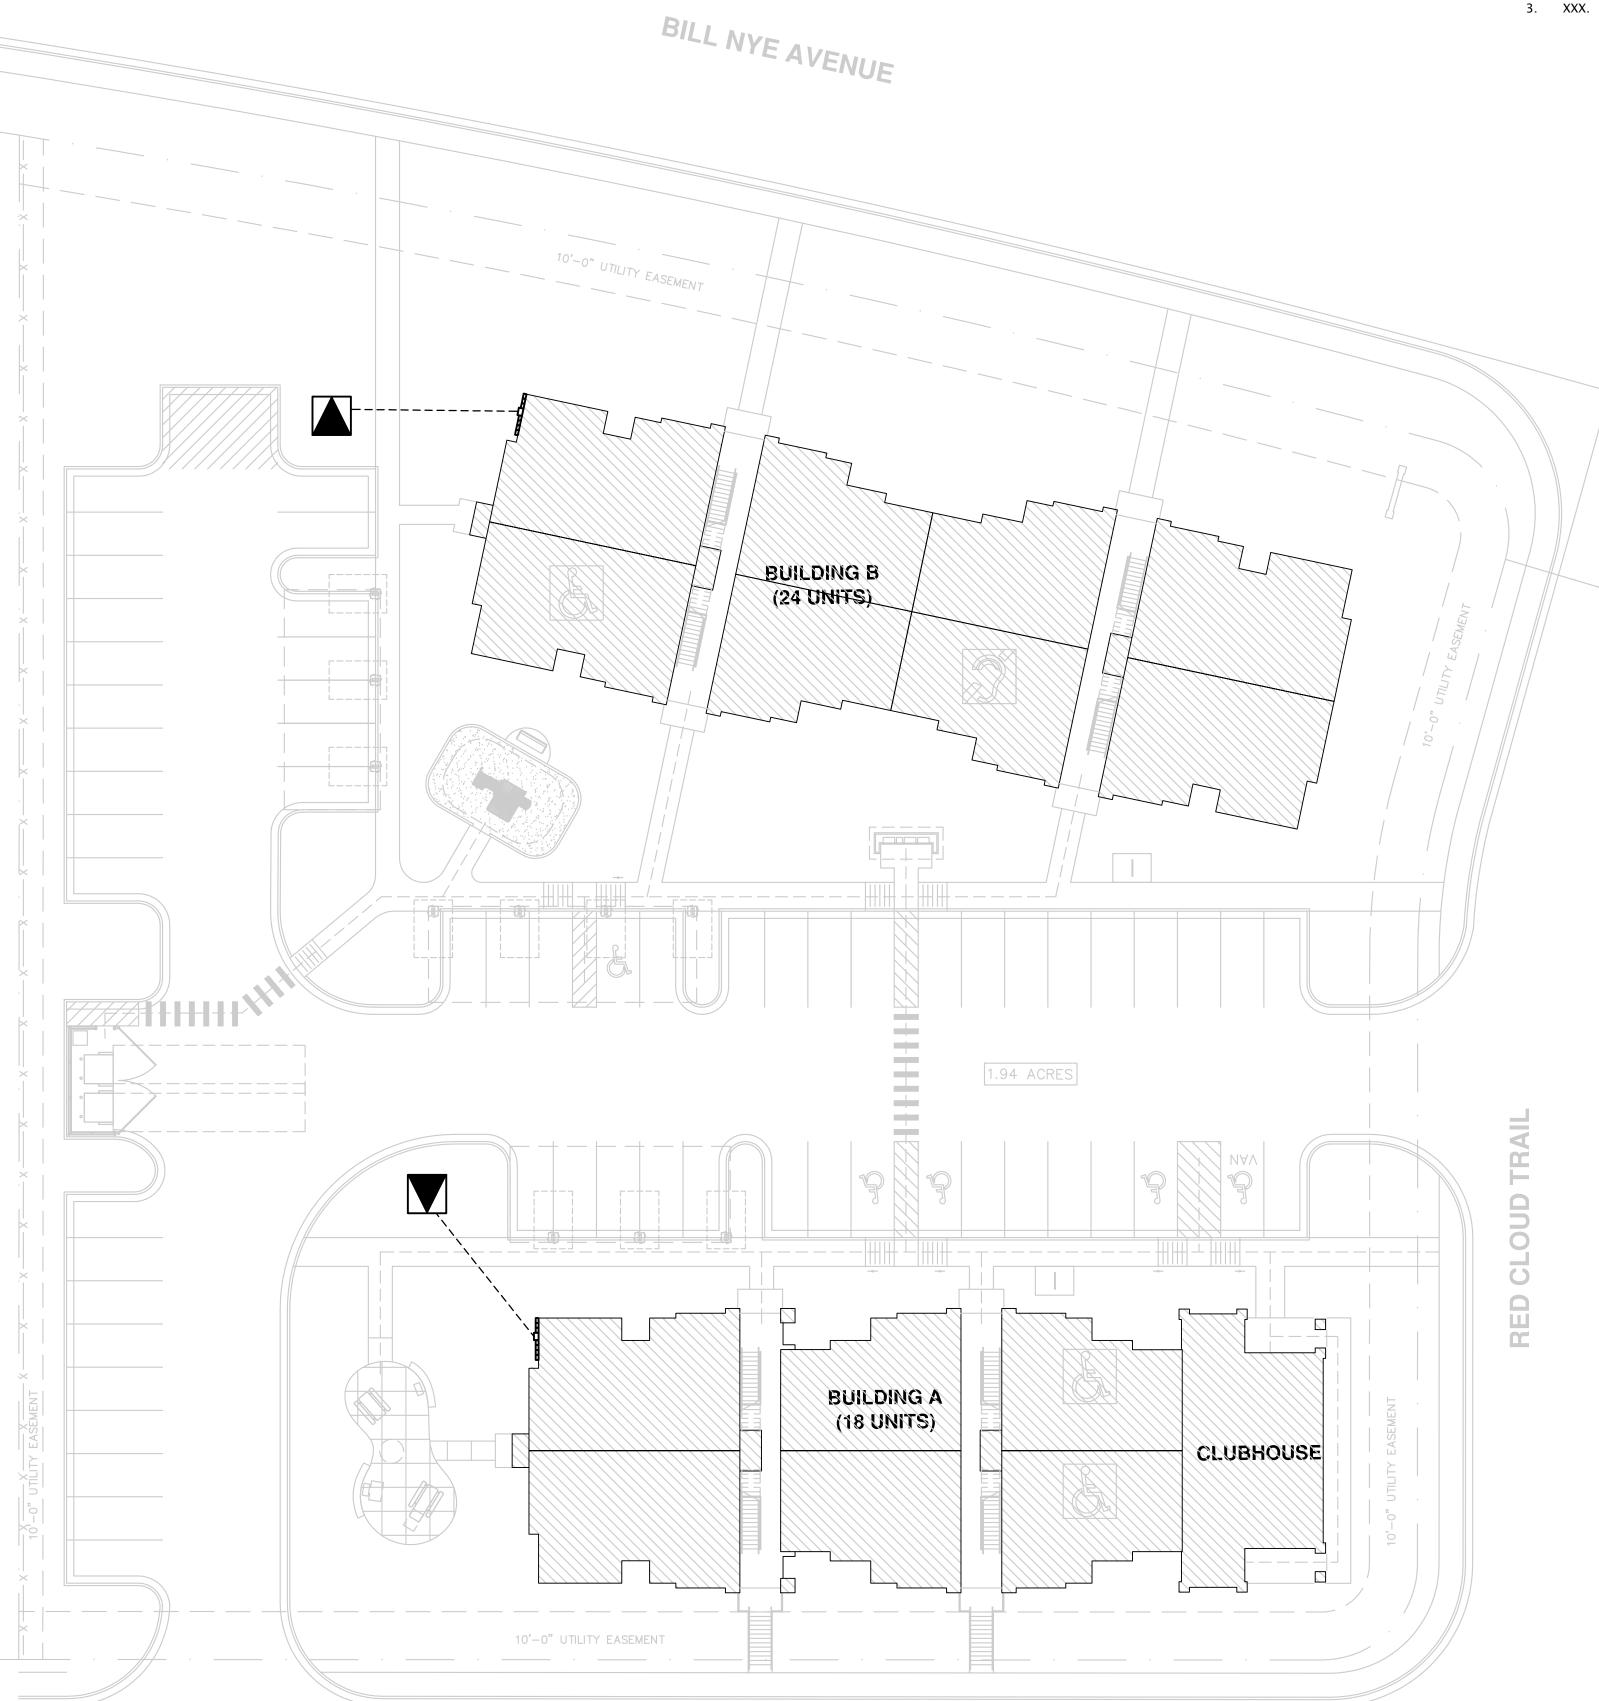

SITTING BULL TRAIL

1" = 20'-0"

1

RESERVES


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REVISION:

6-14-2024 22-3262 SHEET NO.:

E1.0


2. XXX 3. XXX

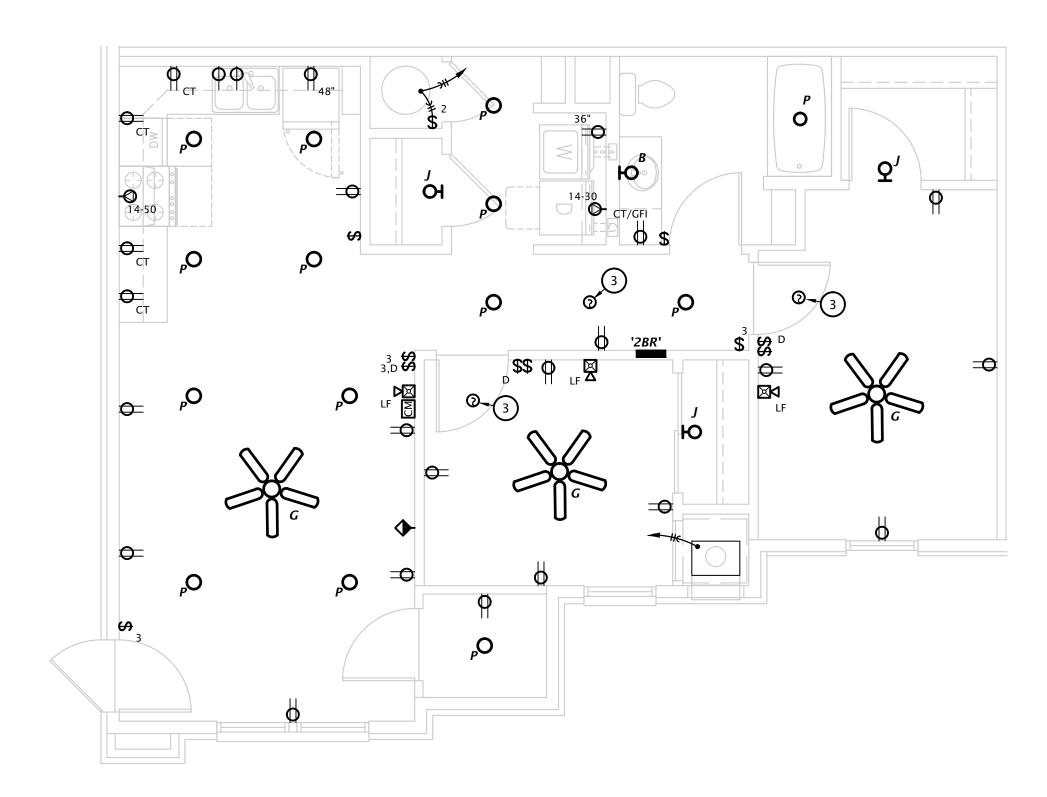


2 BEDROOM POWER PLAN

1/4" = 1'-0"

2 3 BEDROOM POWER PLAN
1/4" = 1'-0"

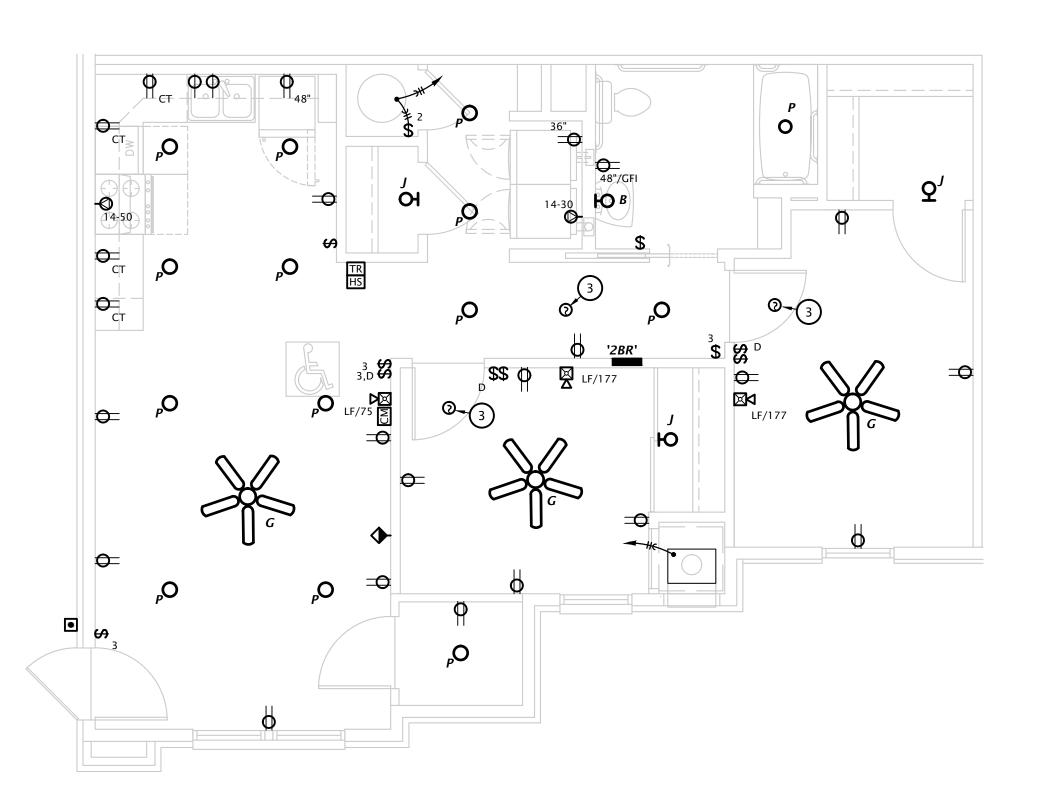

3 <u>2 BEDROOM ACCESSIBLE POWER PLAN</u>
1/4" = 1'-0"

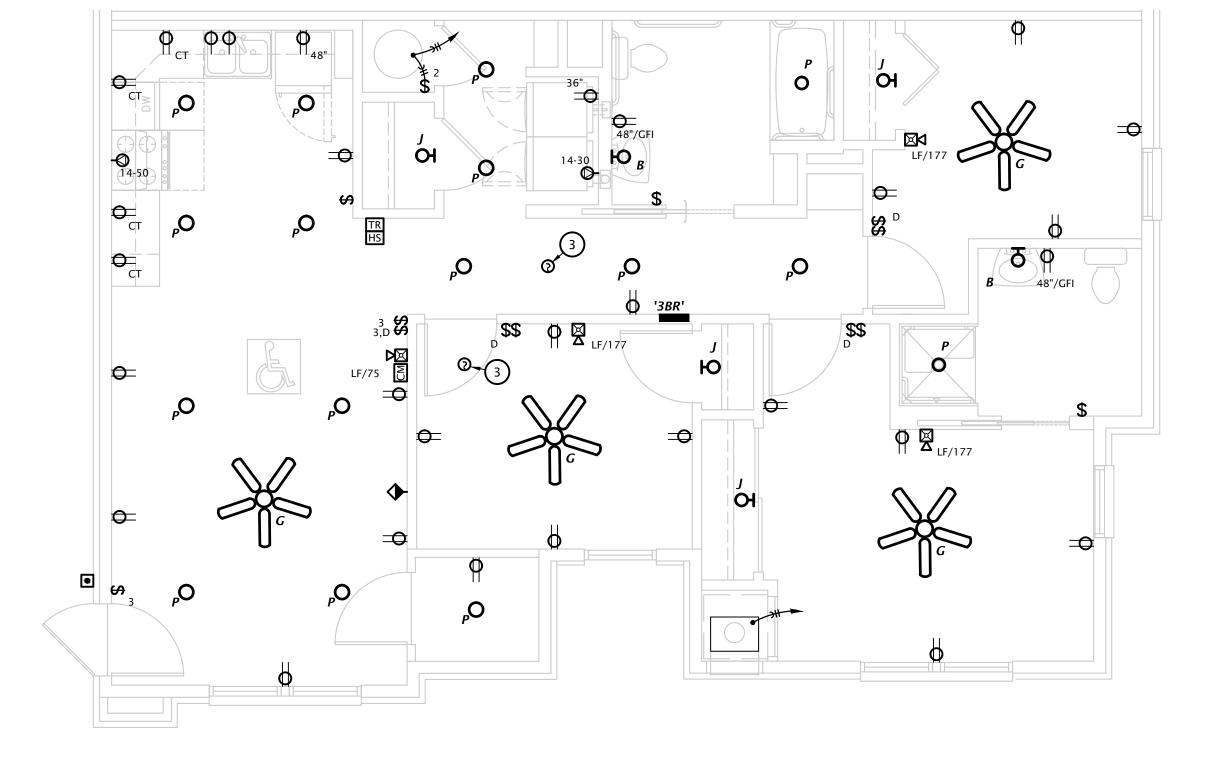

3 BEDROOM ACCESSIBLE POWER PLAN

1/4" = 1'-0"

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REVISION:

6-14-2024 22-3262 SHEET NO.:

	Designation:	HA			Manufact urer:	Square D 'NQ'				
	Location:	EXTERIOR WALL		Bus Amps: 100						
	Voltage:	208/120V-1Ph-3W			MCB Amps:	MLO				
	Enclosure:	NEMA 3R			AIC Rating:	10 KAIC				
	Mount ing:	Surface			Other:	Integral Surge Protectio	n			
Circuit #	Load Descript ion	Conductors	C/B Size	C/B Size	Conductors	Load Description	Circuit #			
1	EXTERIOR BUILDING LIGHTS	2#12,#12G., 1/2"C.	20 / 1	20 / 1	2#12,#12G., 1/2"C.	FACP	2			
3	WALL HEATER	2#12,#12G., 1/2"C.	20 / 1	20 / 1	2#12,#12G., 1/2"C.	RECEPTACLES	4			
5	PARKING LOT LIGHTING	2#10,#10G., 3/4"C.	20 / 1	20 / 1	2#10,#10G., 3/4"C.	FUTURE RADON FANS	6			
7	ELECTRIC WALL HEATER	2#12,#12G., 1/2"C.	20 / 1	20 / 1	2#10,#10G., 3/4"C.	MONUMENT SIGN LIGHTS	8			
9	FIRE SPRINKLER AIR COMPRESSOR	2#12,#12G., 1/2"C.	20 / 1	20 / 1	2#12,#12G., 1/2"C.	EXTERIOR LIGHTING CONTROLS	10			
11	WALL HEATER	2#12,#12G., 1/2"C.	20 / 1	20 / 1	2#12,#12G., 1/2"C.	TELECO MM	12			
13	SPACE	-	1		_	SPACE	14			
15	SPACE	-	-	-	_	SPACE	16			

				Manufacturer: Bus Amps: MCB Amps: AIC Rating: Other:	100 MLO	n	
Circuit #	Load Descript ion	Conductors	C/B Size	C/B Size	Conductors	Load Description	Circuit #
1	EXTERIOR BUILDING LIGHTS	2#12,#12G., 1/2"C.	20 / 1	20 / 1	2#12,#12G., 1/2"C.	FACP	2
3	WALL HEATER	2#12,#12G., 1/2"C.	20 / 1	20 / 1	2#12,#12G., 1/2"C.	RECEPTACLES	4
5	PARKING LOT LIGHTING	2#10,#10G., 3/4"C.	20 / 1	20 / 1	2#10,#10G., 3/4"C.	FUTURE RADON FANS	6
7	WALL HEATER	2#12,#12G., 1/2"C.	20 / 1	20 / 1	2# 8,# 8G., 1"C.	PARKING LOT LIGHTS	8
9	FIRE SPRINKLER AIR COMPRESSOR	2#12,#12G., 1/2"C.	20 / 1	20 / 1	2#12,#12G., 1/2"C.	EXTERIOR LIGHTING CONTROLS	10
11	WALL HEATER	2#12,#12G., 1/2"C.	20 / 1	20 / 1	2#12,#12G., 1/2"C.	TELECO MM	12
13	SPACE		11		_	SPACE	14
15	SPACE					SPACE	16

APARTMENT LIGHT FIXTURE SCHEDULE												
MARK MANUF.	MODEL NUMBER	LAMP DAT.		BALLAST/LED	MOUNTING	FINISH	DESCRIPTION	NOTES				
		#	TYPE	DRIVER	VER MOONTING TIMISTI		1.3123					
SEAGULL	4423003EN3-710	3	9.5W LED	STANDARD	WALL	BURNT SIENNA	3 LAMP VANITY LIGHT					
SEAGULL	15030EN-829	2	10W LED	STANDARD	SURFACE	BRONZE	52" DIAMETER CEILING FAN WITH LED LIGHT KIT					
HALO	SMD6R-6-930-WH		600 LUMEN 10W LED	STANDARD	Wall	WHITE	6" ROUND SURFACE MOUNT DOWNLIGHT	9				
HALO	SMD6R-6-930-WH		600 LUMEN 10W LED	STANDARD	SURFACE	WHITE	6" ROUND SURFACE MOUNT DOWNLIGHT	3				
	MANUF. SEAGULL SEAGULL HALO	MANUF. MODEL NUMBER SEAGULL 4423003EN3-710 SEAGULL 15030EN-829 HALO SMD6R-6-930-WH	MANUF. MODEL NUMBER # SEAGULL 4423003EN3-710 3 SEAGULL 15030EN-829 2 HALO SMD6R-6-930-WH	MANUF. LAMP DATA # TYPE SEAGULL 4423003EN3-710 3 9.5W LED SEAGULL 15030EN-829 2 10W LED HALO SMD6R-6-930-WH 600 LUMEN 10W LED	MANUF. LAMP DATA BALLAST/LED DRIVER # TYPE TYPE STANDARD SEAGULL 4423003EN3-710 3 9.5W LED STANDARD SEAGULL 15030EN-829 2 10W LED STANDARD HALO SMD6R-6-930-WH 600 LUMEN 10W LED STANDARD	MANUF. LAMP DATA BALLAST/LED DRIVER MOUNTING # TYPE TYPE STANDARD WALL SEAGULL 15030EN-829 2 10W LED STANDARD SURFACE HALO SMD6R-6-930-WH 600 LUMEN 10W LED STANDARD Wall	MANUF. LAMP DATA BALLAST/LED DRIVER MOUNTING FINISH SEAGULL 4423003EN3-710 3 9.5W LED STANDARD WALL BURNT SIENNA SEAGULL 15030EN-829 2 10W LED STANDARD SURFACE BRONZE HALO SMD6R-6-930-WH 600 LUMEN 10W LED STANDARD Wall WHITE	MANUF. MODEL NUMBER LAMP DATA # TYPE BALLAST/LED DRIVER MOUNTING FINISH DESCRIPTION DESCRIPTION DESCRIPTION DESCRIPTION SEAGULL SEAGULL 15030EN-829 2 10W LED STANDARD STANDARD STANDARD SURFACE BRONZE 52" DIAMETER CEILING FAN WITH LED LIGHT KIT HALO SMD6R-6-930-WH 600 LUMEN 10W LED STANDARD WAII WHITE 6" ROUND SURFACE MOUNT DOWNLIGHT				

- Fixture/pole assemblies shall be rated for 100mph wind loads. Provide wind dampeners when recommended by the manufacturer.
- All fixtures shall be provided with multi-volt driver capable of operating between 120V-277V
- All exterior fixtures shall be 4000K color temperature
- All interior fixtures shall be 3000K color temperature
- All apartment light fixtures and ceiling fans shall be Energy Star rated


- 1. Provide fixture/pole assembly with 22' round straight steel pole, bronze to match fixture. Fixture height shall not exceed 25'-0" AFG.
- 2. Provide wall or ceiling mounted as required
- 3. Where installed above showers and tubs fixture shall be wet location listed.
- 4. Fixture shall be U.L. listed for wet locations.
- 5. Provide fixture dusk to dawn control in accordance with Green Community requirements. See note 16 on sheet E1.1 for more information.
- 6. Provide with test switch, status indicator and rechargeable nickel-cadmium battery for 90 minutes of emergency power.
- 7. Provide fixture/pole assembly with 10' round straight steel pole, bronze to match fixture. Fixture height shall not exceed 12'-0" AFG.
- 8. Fixture shall be U.L. listed for damp locations.
- 9. Ensure fixture complies with 410.16(C)(5).

LIGHT	T FIXTURE	SCHEDULE							
MARK	MANUF.	MODEL NUMBER		LAMP DATA	BALLAST/LED	MOUNTING	FINISH	DESCRIPTION	NOTES
			#	TYPE	DRIVER				
F	HALO	SMD6R-6-930-WH		600 LUMEN 10W LED	STANDARD	SURFACE	WHITE	6" ROUND SURFACE MOUNT DOWNLIGHT	
Н	BEACON	LSQ1-25-4K7-UNV		30W LED 3,181 LUMEN	0-10V DIMMING	SURFACE	SELECTED BY ARCHITECT	SQUARE SURFACE MOUNTED ACRYLIC LENS	4,5,6
L1	LITHONIA	WPX2-LED-40K-MVOLTDBLXD		5,896 LUMEN 47W LED	STANDARD	WALL	BLACK	EXTERIOR LED WALL PACK	4
L2	LITHONIA	WPX1-LED-P2-40K-MVOLTDBLXD		2,912 LUMEN 24W LED	STANDARD	WALL	BLACK	EXTERIOR LED WALL PACK	4
S	LITHONIA	DSX0-LED-P3-40K-T4M-MVOLT		6,272 LUMEN 69W LED	STANDARD	POLE	BLACK	LED AREA LIGHT, SINGLE HEAD FULL CUT-OFF WITH IES TYPE IV DISTRIBUTION	1,4

- Fixture/pole assemblies shall be rated for 100mph wind loads. Provide wind dampeners when recommended by the manufacturer.
- All fixtures shall be provided with multi-volt driver capable of operating between 120V-277V
- All exterior fixtures shall be 4000K color temperature
- All interior fixtures shall be 3000K color temperature All apartment light fixtures shall be Energy Star rated

- 1. Provide fixture/pole assembly with mounting arm and 20' round straight steel pole, black to match fixture.
- 2. Provide with test switch, status indicator and rechargeable nickel-cadmium battery for 90 minutes of emergency power.
- 3. Provide wall or ceiling mounted as required
- 4. Fixture shall be U.L. listed for wet locations.
- 5. Provide with integrally occupancy sensor.
- 6. Provide with emergency battery backup.

<u> Build</u>	ling A Service Calculat	•	nits + Club	house)		
Area:	17190 SF (Dwelling Units	Only)				
					Connected Load (VA)	
eede	er & Service Loads per NEC	220.84 Part IV				
C1	General Loads (220.84 (C)(1))	1				
а	Lighting & Receptacles		3 VA/SF	17190 SF	51,570	
C2	Required Circuits (220.84 (C))	(2))				
а	Laundry Circuit	1,50	0 VA/Circuit	16 Circuit	24,000	
b	Kitchen Circuits	1,50	0 VA/Circuit	32 Circuit	48,000	
C3	Nameplate Ratings of Equipm	ent (220.84 (C)(3))			
a1	Microwave	1,00	0 VA/Circuit	16 ea	16,000	
a2	Dishwasher	84	0 VA/Circuit	16 ea	13,440	
а3	Disposal	117	5 VA/Circuit	16 ea	18,800	
	Refrigerator	120	0 VA/Circuit	16 ea	19,200	
b	Electric Range	8,00	0 VA/Circuit	16 ea	128,000	
	Electric Clothes Dryer	5,00	0 VA/Circuit	16 ea	80,000	
d	Water Heater	4,50	0 VA/Circuit	16 ea	72,000	
C4	Nameplate Ratings of Motors	(220.84 (C)(4))				
	VTAC Blower	15	0 VA/Circuit	16 ea	2,400	
	Exhaust Fan - Kitchen	2	0 VA/Circuit	16 ea	320	
	Exhuast Fan - RR	2	0 VA/Circuit	32 ea	640	
C5	Larger of Heating and A/C loa	d (220.84 (C)(5))				
	2BR Electric Heat	6,13	5 VA/Circuit	12 ea	73,620	
	3BR Electric Heat	8,18	0 VA/Circuit	4 ea	32,720	
			Conn	ected Load Total	580,710	i
		Dwelling Unit De	emand Load fr	om Table 220.84	38%	203,249
		Building S	Service NEC D	Demand Load (VA	A) Sub-Total	203,249
		Total	Aparment S	ervice Demand	Load (VA)	203,249
				ervice Demand	` '	35,338
	Total Duilding	Samilaa Daman		ervice Demand	-	8,072
	i otal Building	Service Demand Meter Cente	u Load (Amp	eres) @ 208/120	v-36n, 44V	685

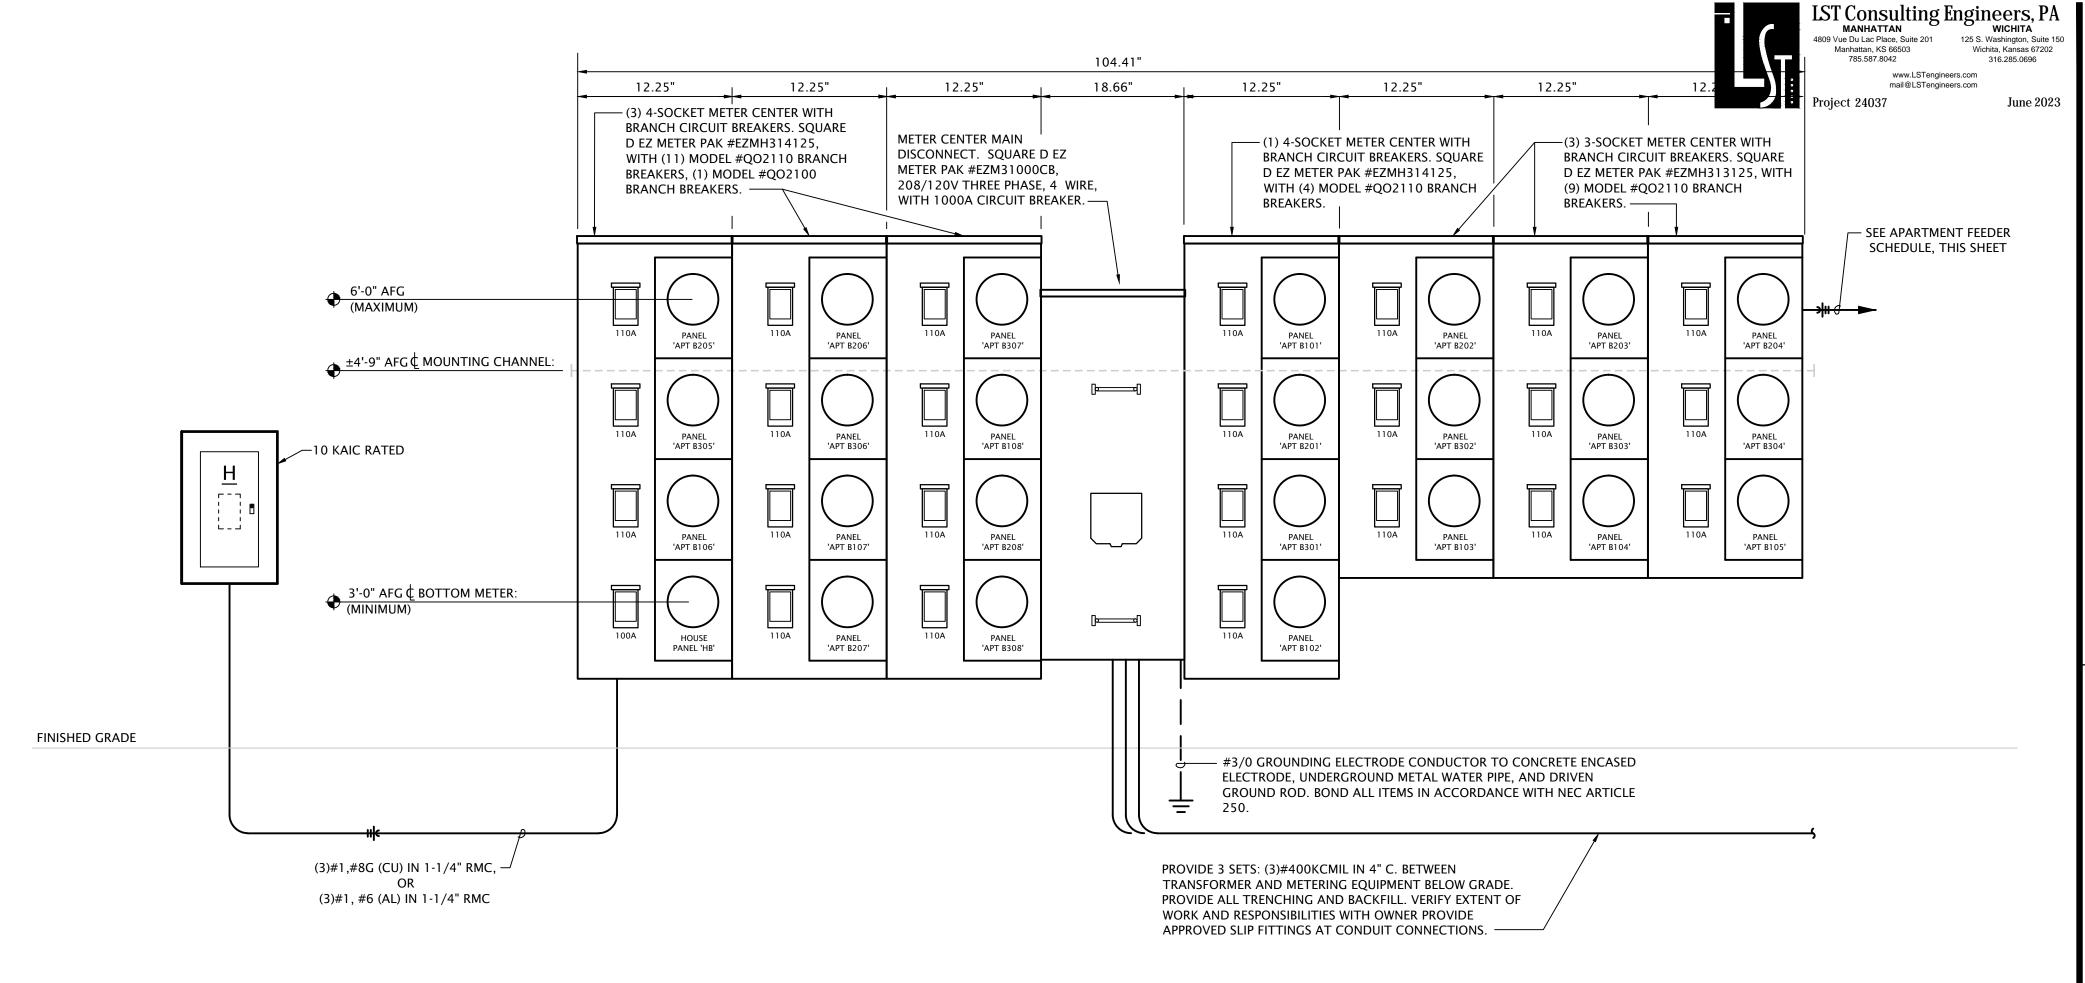

2 ELECTRICAL RISER DIAGRAM - BULDING B
No Scale

locations.

Information:

42,000A peak let through.

utility company for approval.

All conductor sizes are based on copper, U.N.O.

utility company and pay associated fees. Contact

Rocky Mountain Power

All meter center components shall be NEMA 3R


dimensions of substitute equipment and receive

the contractor's responsibility to verify the

approval from utility for substitution.

be stamped with 1/8" letters, minimum.

Entire installation shall comply with NEC.

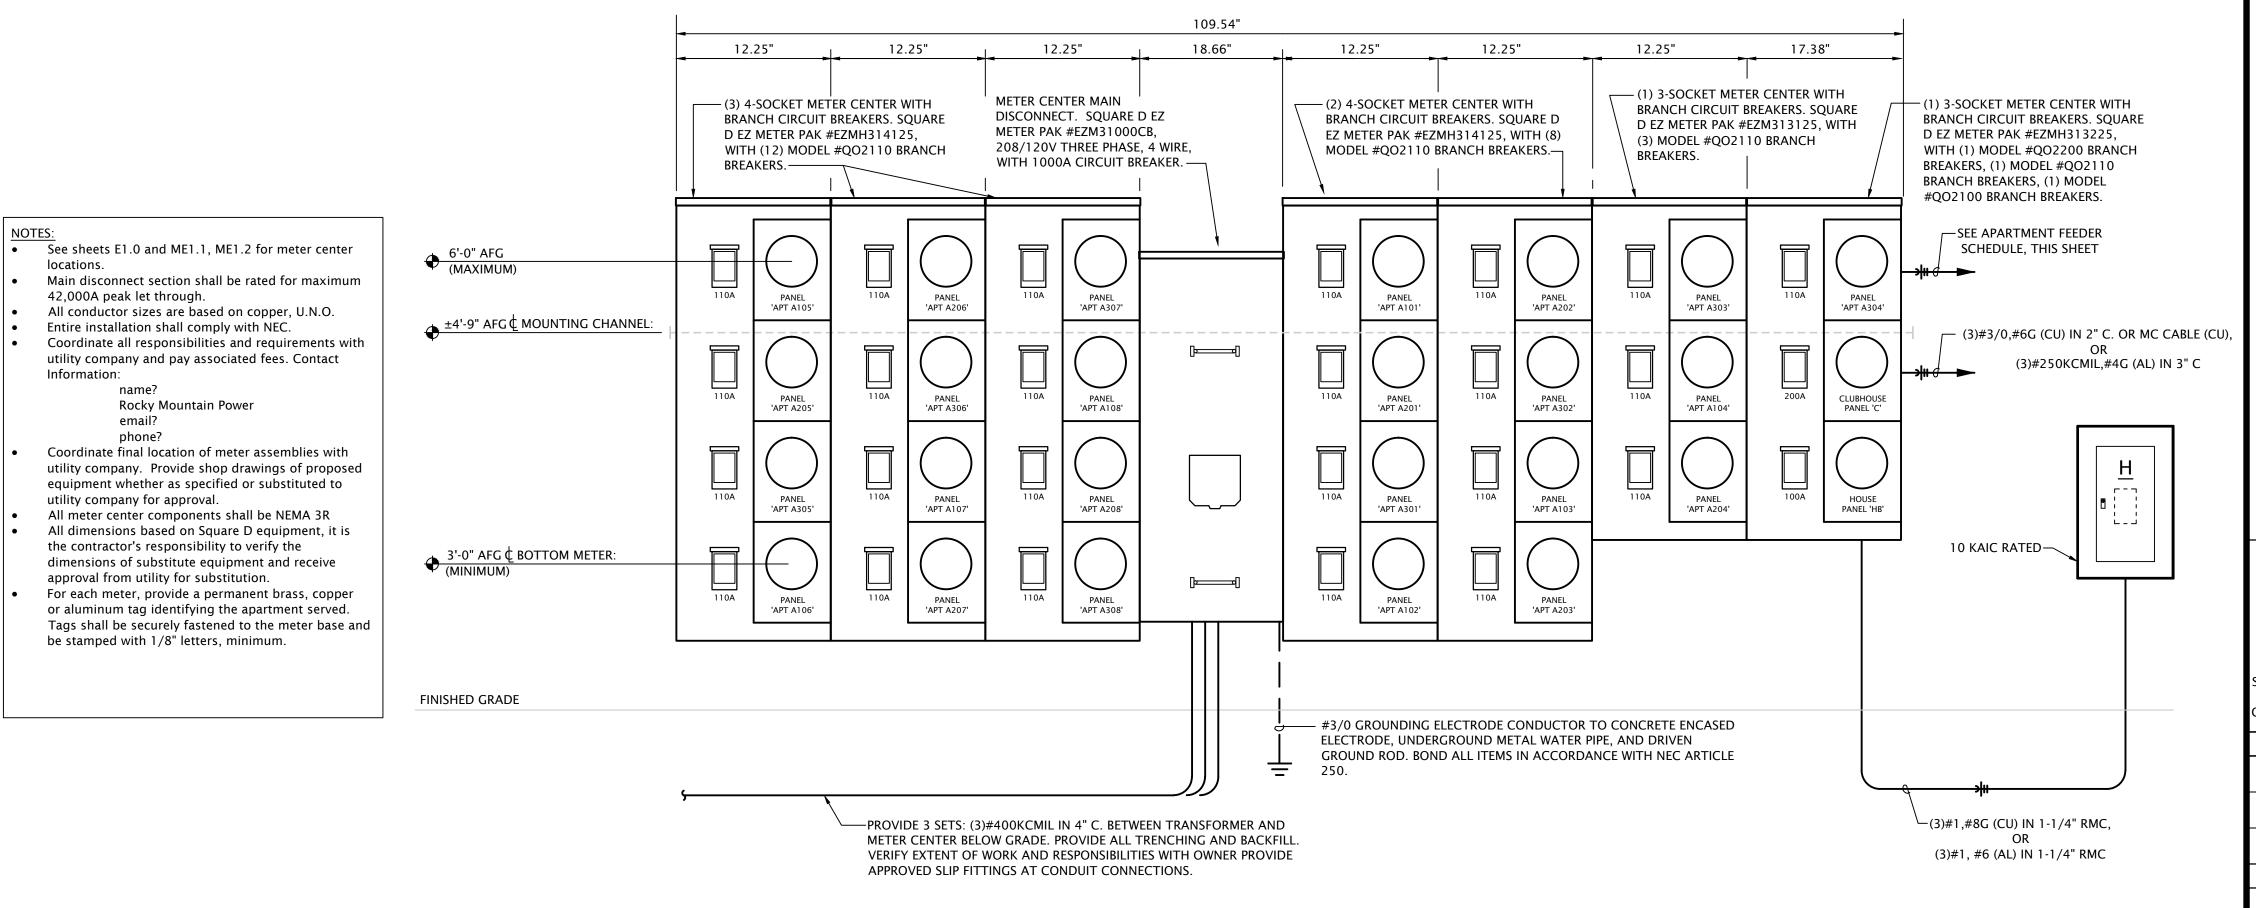

1 ELECTRICAL RISER DIAGRAM - BULDING A
No Scale

E6.2

onesGillamR

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