# JER

#### Jones Gillam Renz Architects

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#### NOTICE TO ALL CONTRACTORS AND SUB-CONTRACTORS

#### Nov. 27, 2024

#### The Residence at Green Meadow - JGR Proj 24-3395

#### ADDENDUM NO. 1

YOU ARE INSTRUCTED TO READ AND TO NOTE THE FOLLOWING DESCRIBED CHANGES, CORRECTIONS, CLARIFICATIONS, OMISSIONS, DELETIONS, ADDITIONS, APPROVALS, AND STATEMENTS PERTINENT TO THE CONTRACT AND CONSTRUCTION DOCUMENTS. THIS ADDENDUM IS A PART OF THE CONTRACT AND CONSTRUCTION DOCUMENTS AND SHALL GOVERN IN THE PERFORMANCE OF THE WORK.

#### CIVIL - Drawings

- Sheet C-3 Two of the four Accessible Parking spaces near the front entry have been relocated closer to the rear entry of the building.
- 2. Sheet C-12 Sodded vs. seeded area has been identified and notes have been added that pertain to the seeding/sodding of the site.

#### ARCHITECTURAL - Drawings


- 1. Sheet A3.1 Roof/parapet at Elevator shaft adjusted to show roof sloping to drain onto low roof.
- 2. Sheet A3.2 Roof/parapet at Elevator shaft adjusted to show roof sloping to drain onto low roof.
- Sheet A5.1 Roof slope changed to slope/drain to low roof vs. front of building. Gutter & downspout moved to opposite wall.
- 4. Sheet A6.2 Roof slope changed to slope/drain to low roof vs. front of building. Gutter & downspout moved to opposite wall.

#### MEP - Drawings

- 1. Sheet E1.1
  - a. Adjusted emergency and exit signs
  - b. Added IECC compliance note
- Sheet E1.2 Added IECC compliance note
- 3. Sheet E1.3
  - a. Added telecom conduit and notes
  - b. Added IECC compliance note
- 4. Sheet E1.4
  - a. Added telecom conduit and notes
  - b. Added IECC compliance note
- 5. Sheet E4.1
  - a. Added doorbell and notes
  - b. Modified washer/dryer receptacles
  - Added IECC compliance note
- 6. Sheet E6.1 Added doorbell detail
- 7. Sheet M1.1 Added IECC compliance note
- 8. Sheet M1.2 Added IECC compliance note
- 9. Sheet P1.3
  - a. Revised apartment domestic water piping for new HWH location
  - b. Added IECC compliance notes
- 10. Sheet P1.4
  - a. Revised apartment domestic water piping for new HWH location
  - b. Added IECC compliance notes
- 11. Sheet P4.1
  - a. Revised apartment domestic water piping for new HWH location
  - b. Added IECC compliance notes
- 12. Sheet P6.1 Revised descriptions of KS-A and KS-B
- 13. Sheet P9.1 Revised W/V isometric.

Receipt of this Addendum shall be noted on the Bid Form.


**END OF ADDENDUM NO. 1** 

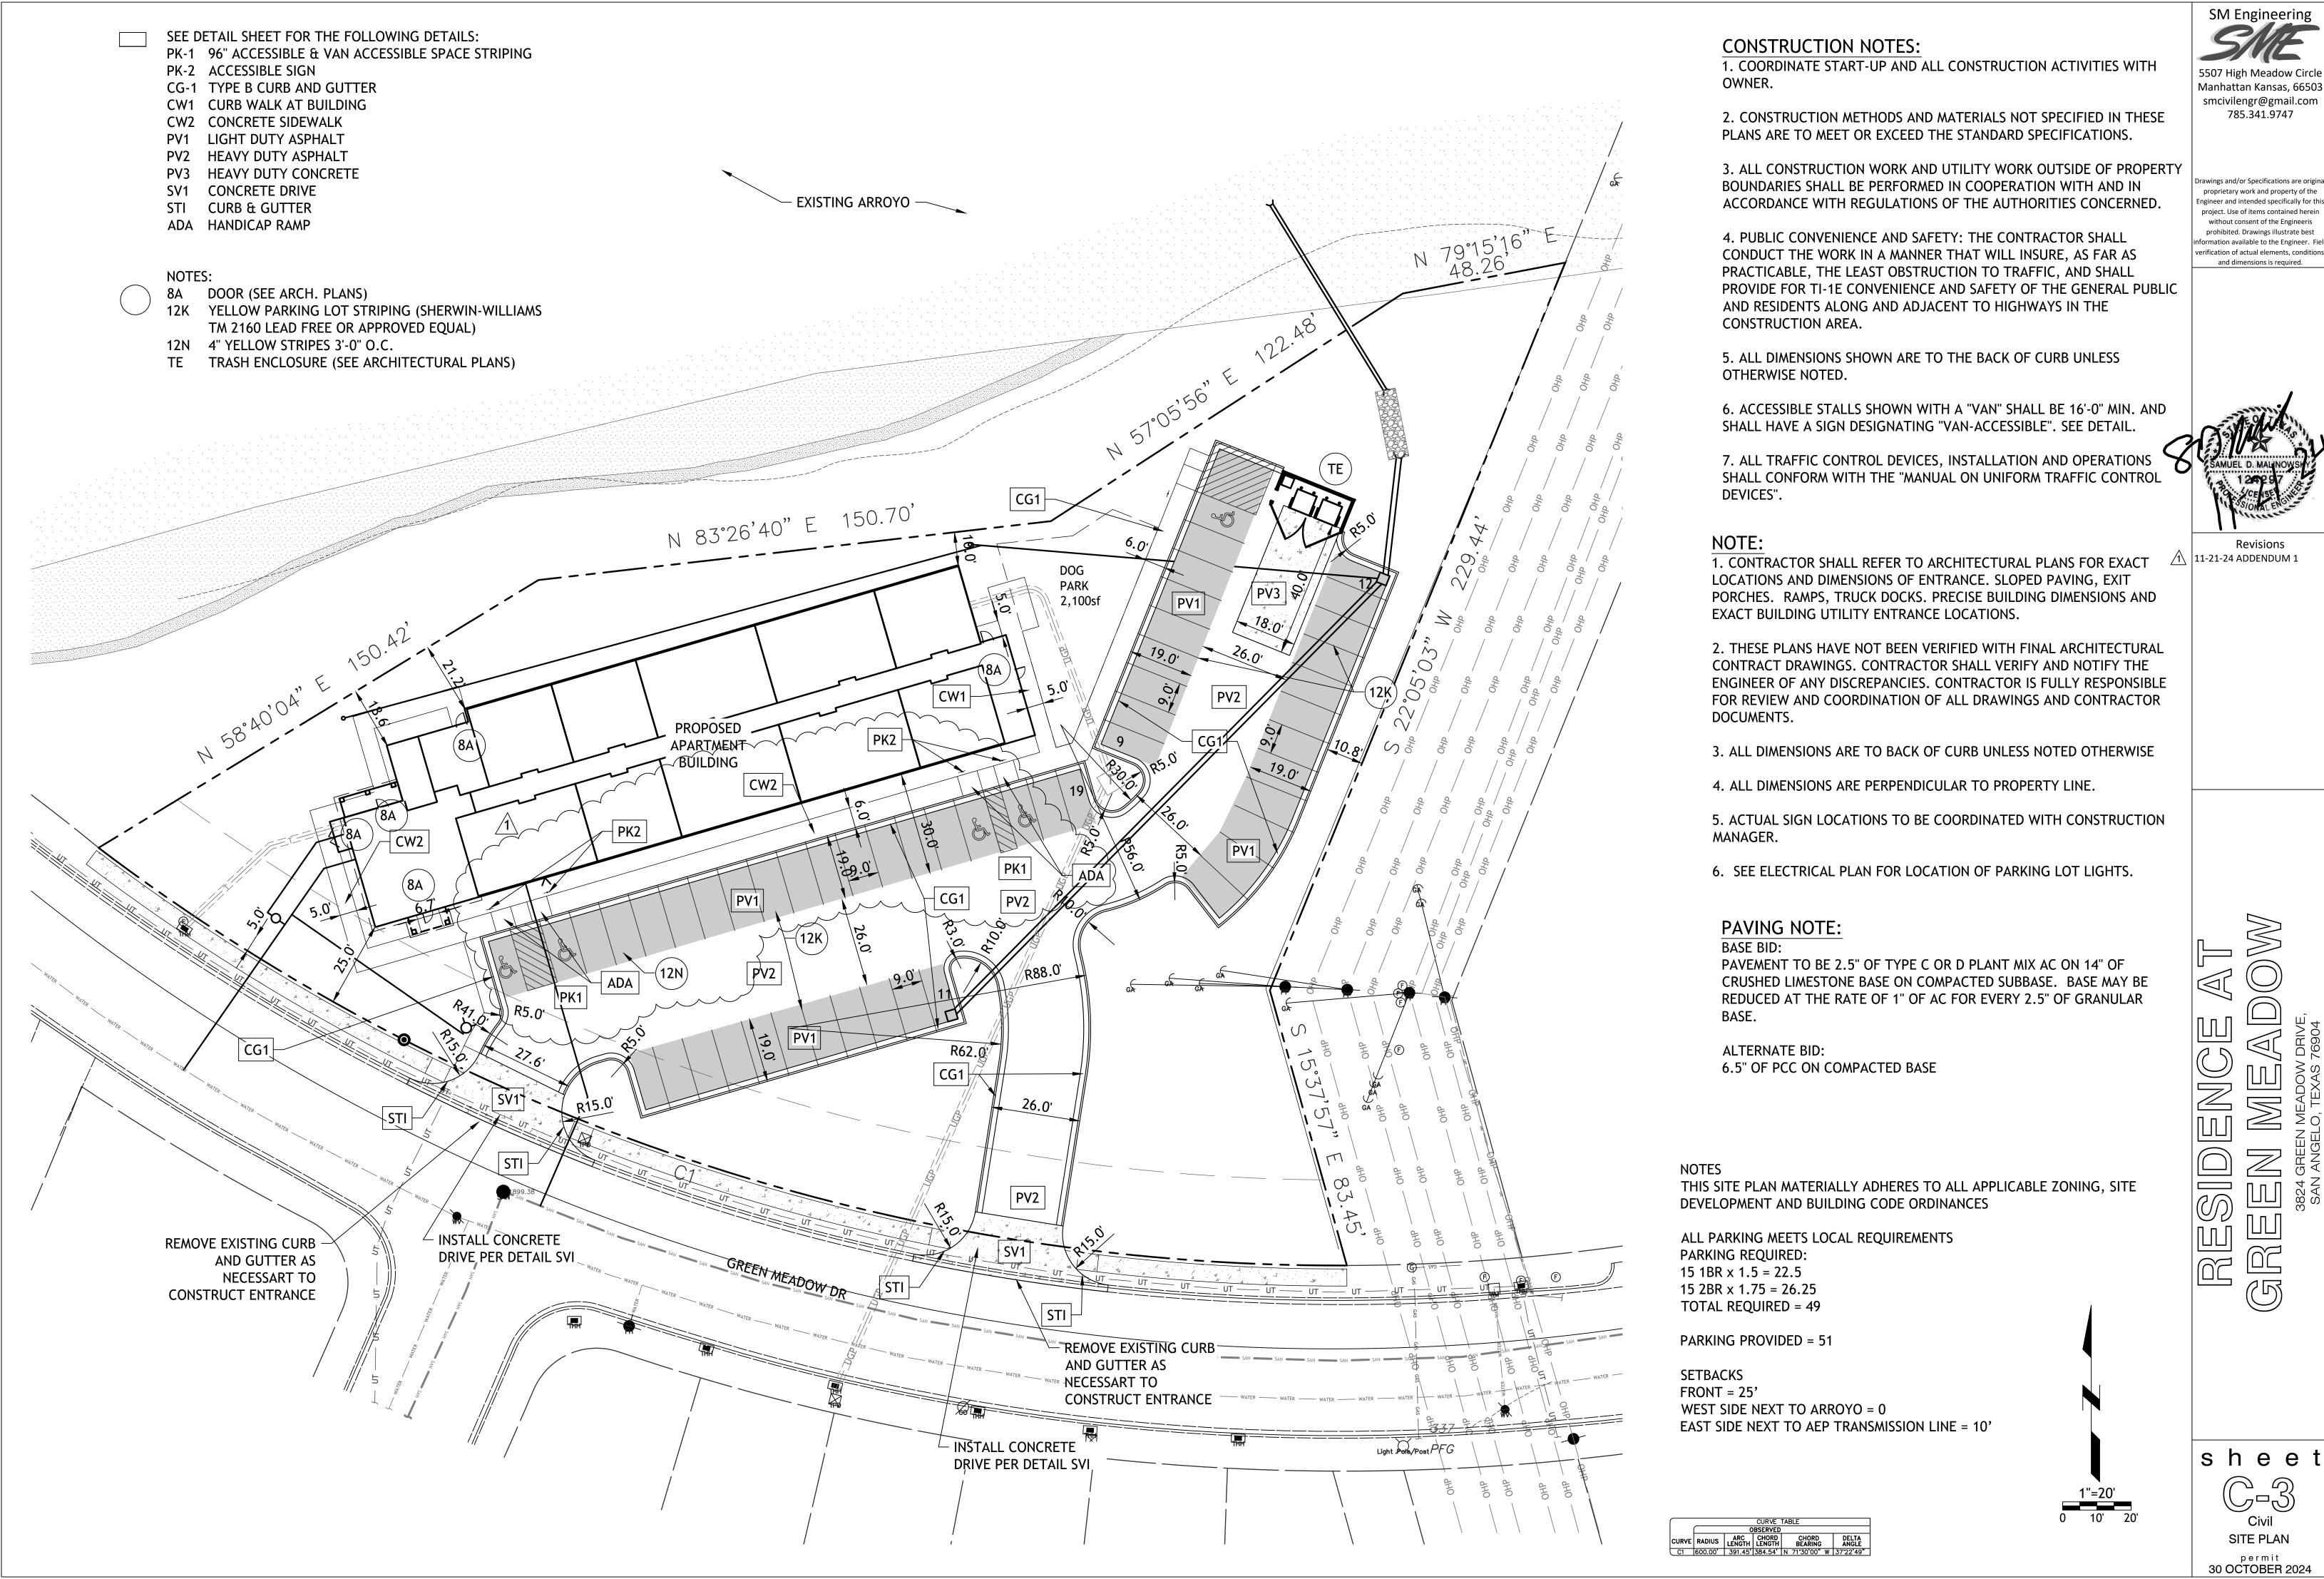

SM Engineering

Manhattan Kansas, 66503 smcivilengr@gmail.com

proprietary work and property of the prohibited. Drawings illustrate best

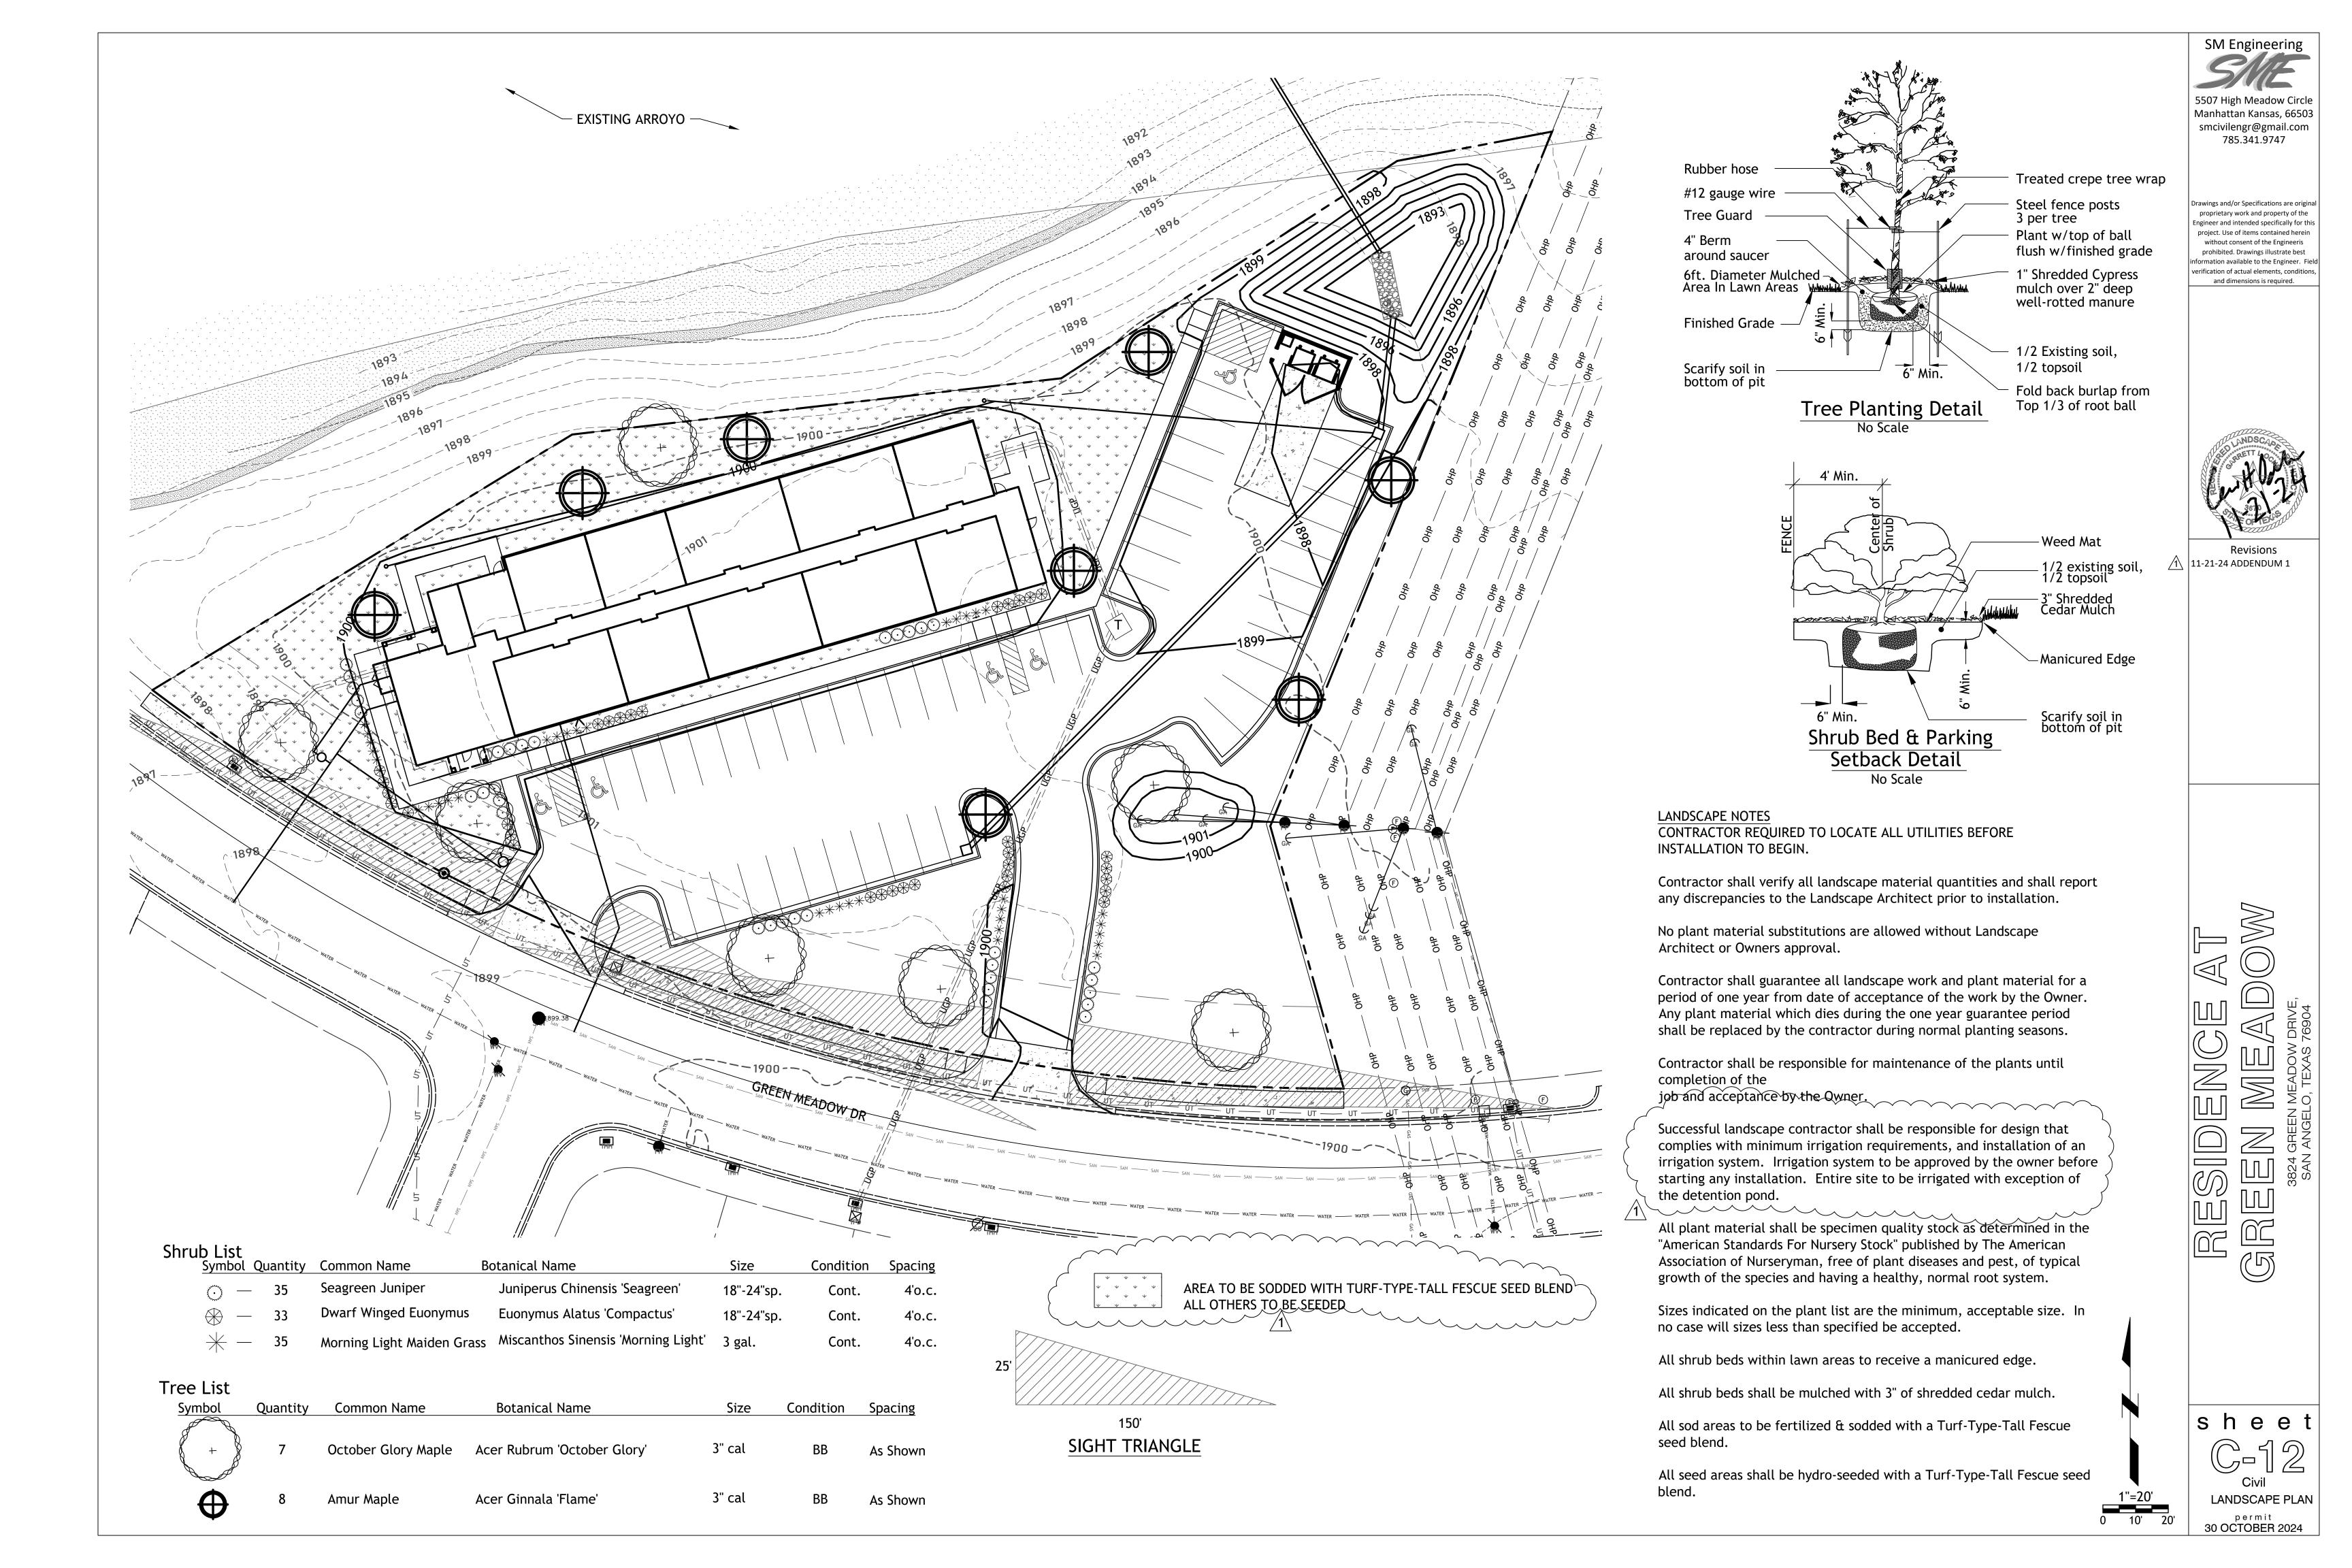



11-27-2024

DATE: 11-22-2024 JOB: 24-3395 SHEET NO.: **A3.1** 

FRONT ELEVATION


1/8" = 1'-0"

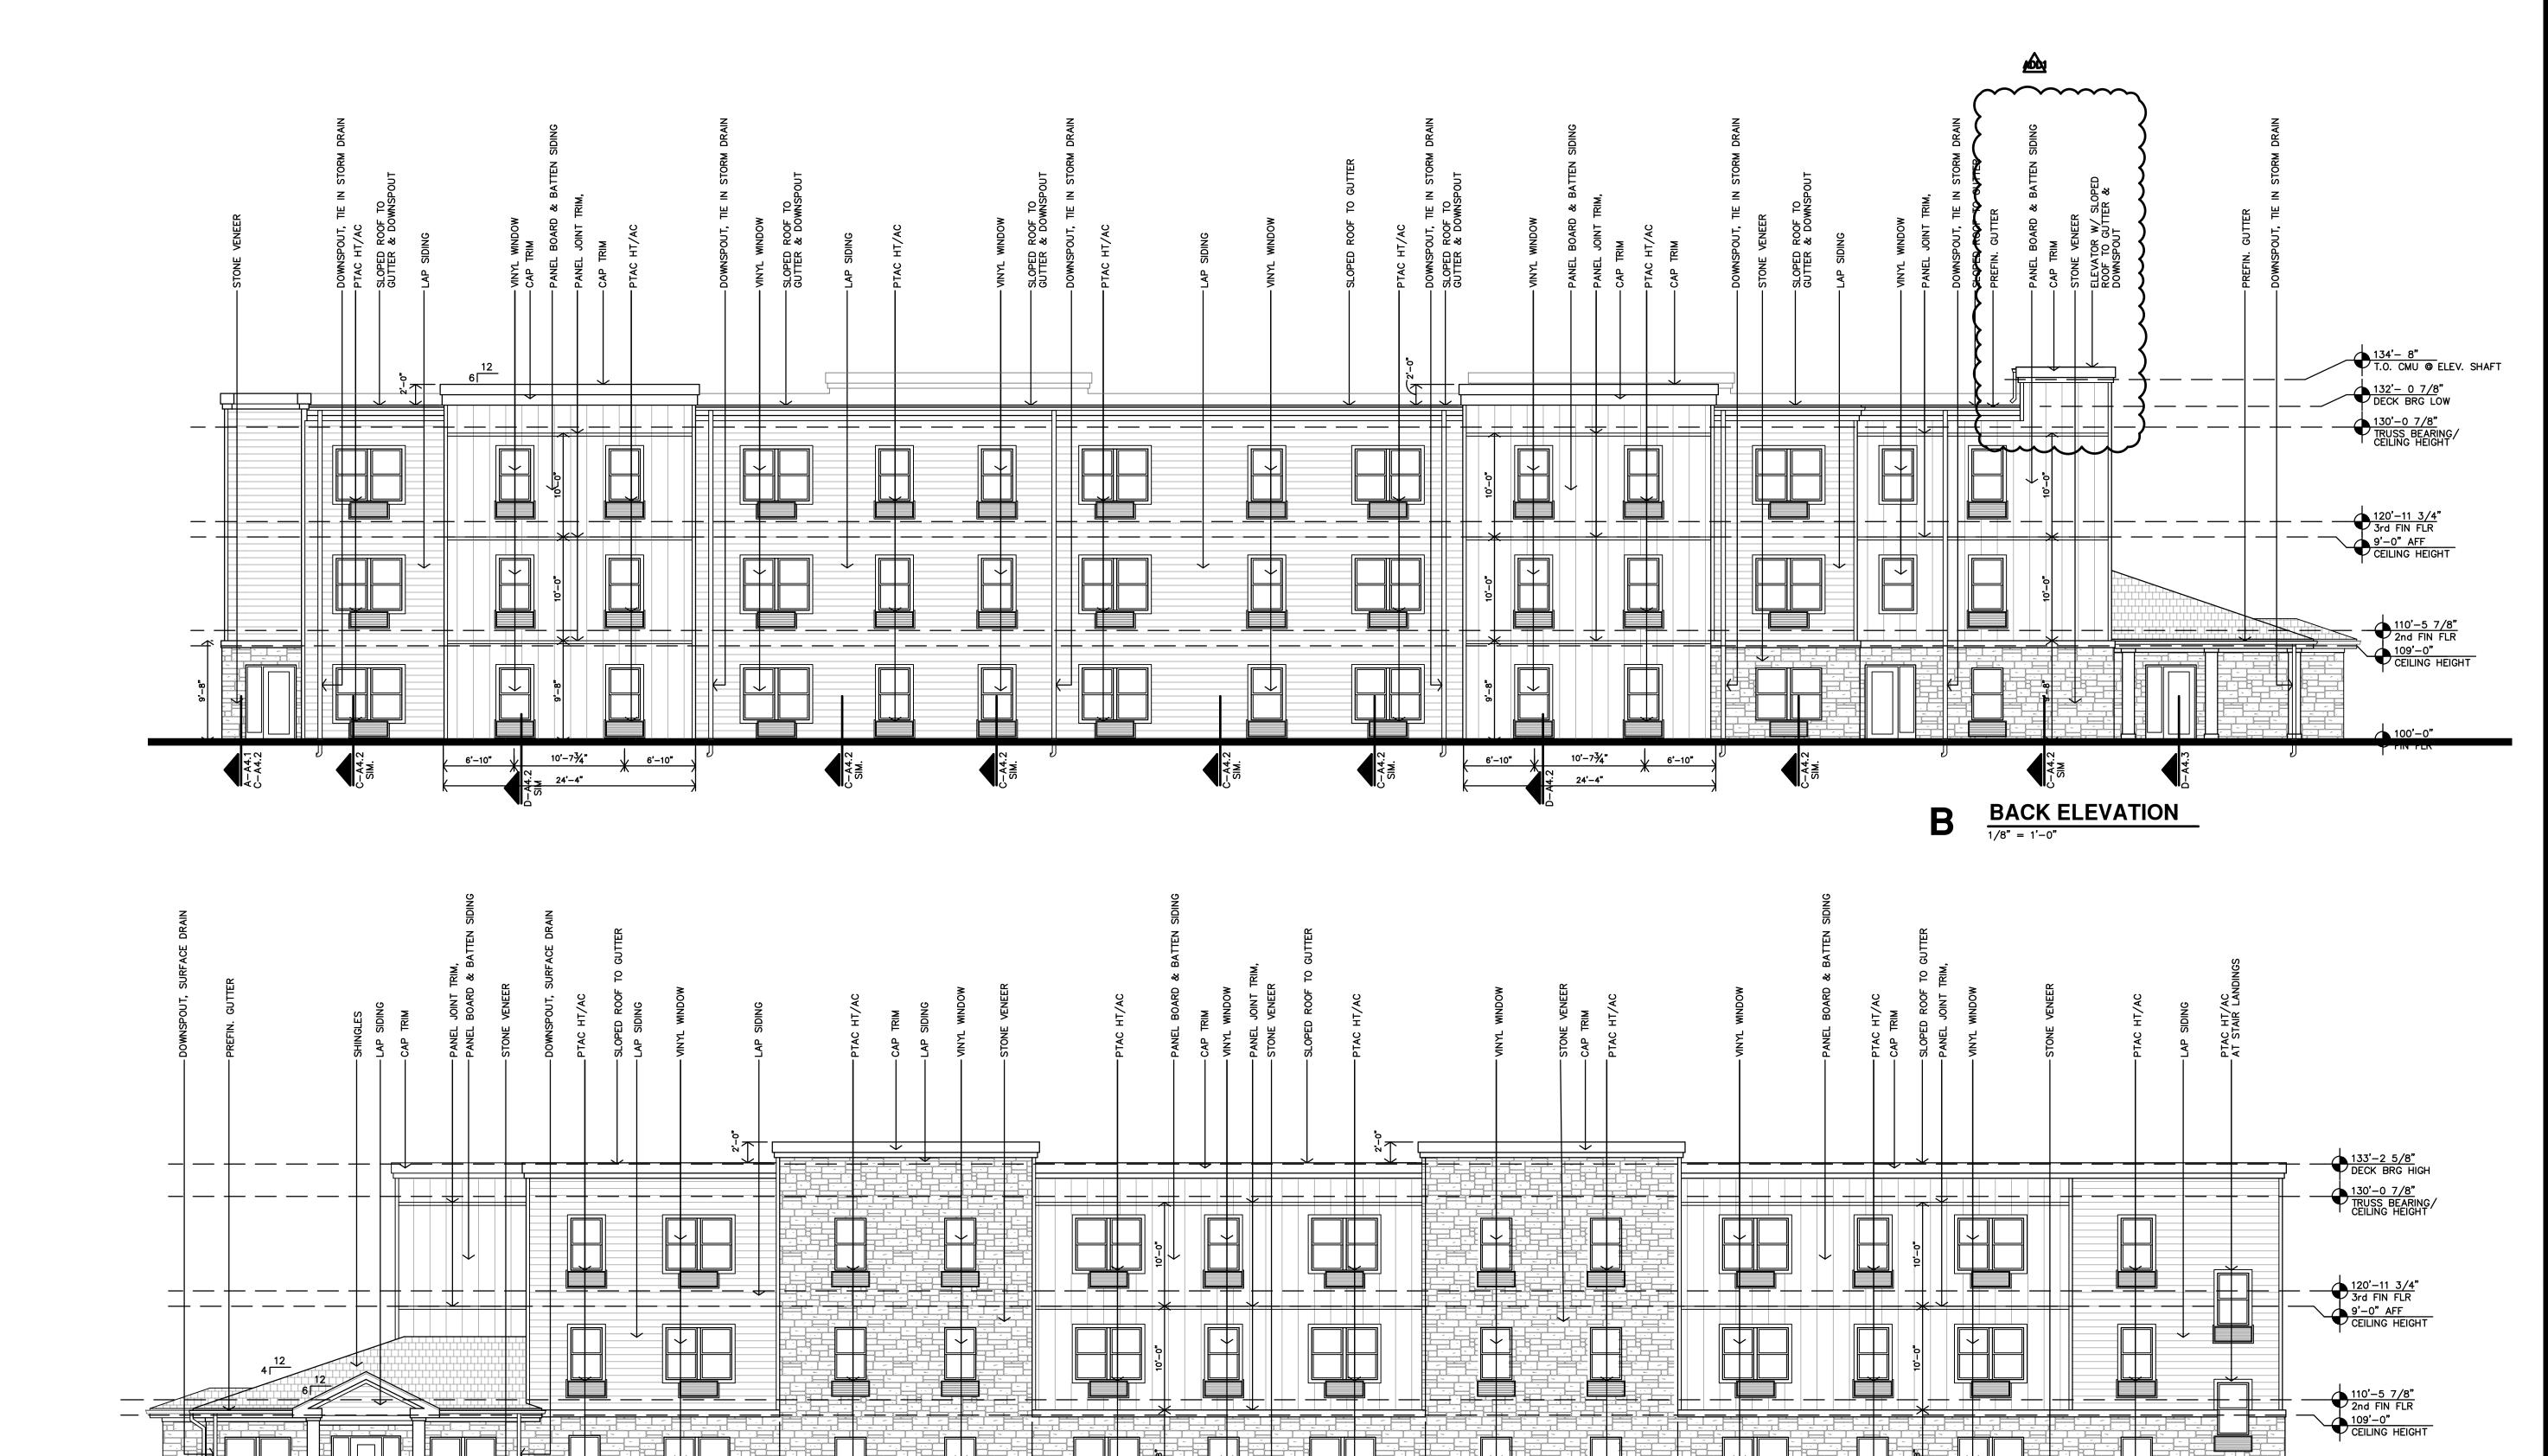

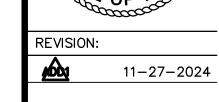


11-22-2024 DATE: 24-3395 SHEET NO.:


**A3.2** 

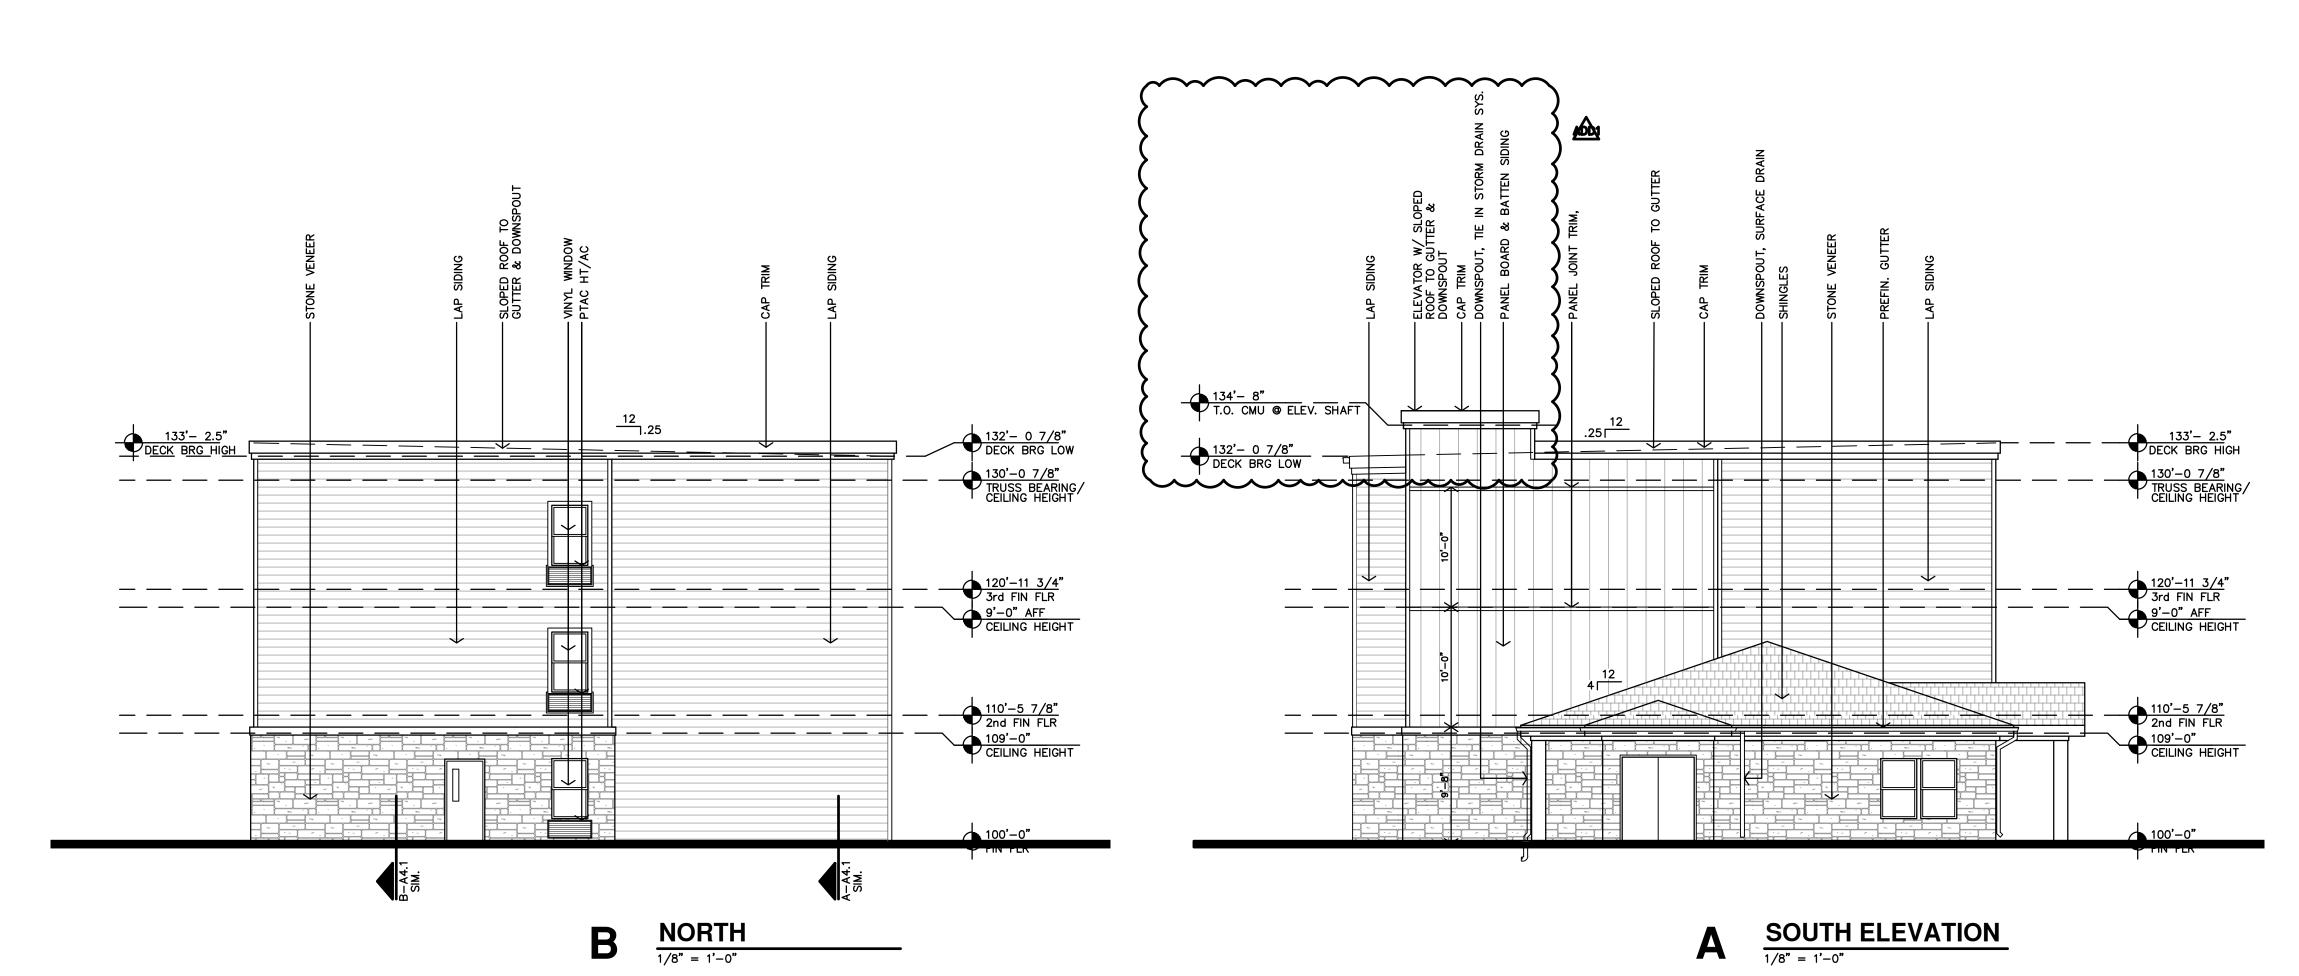




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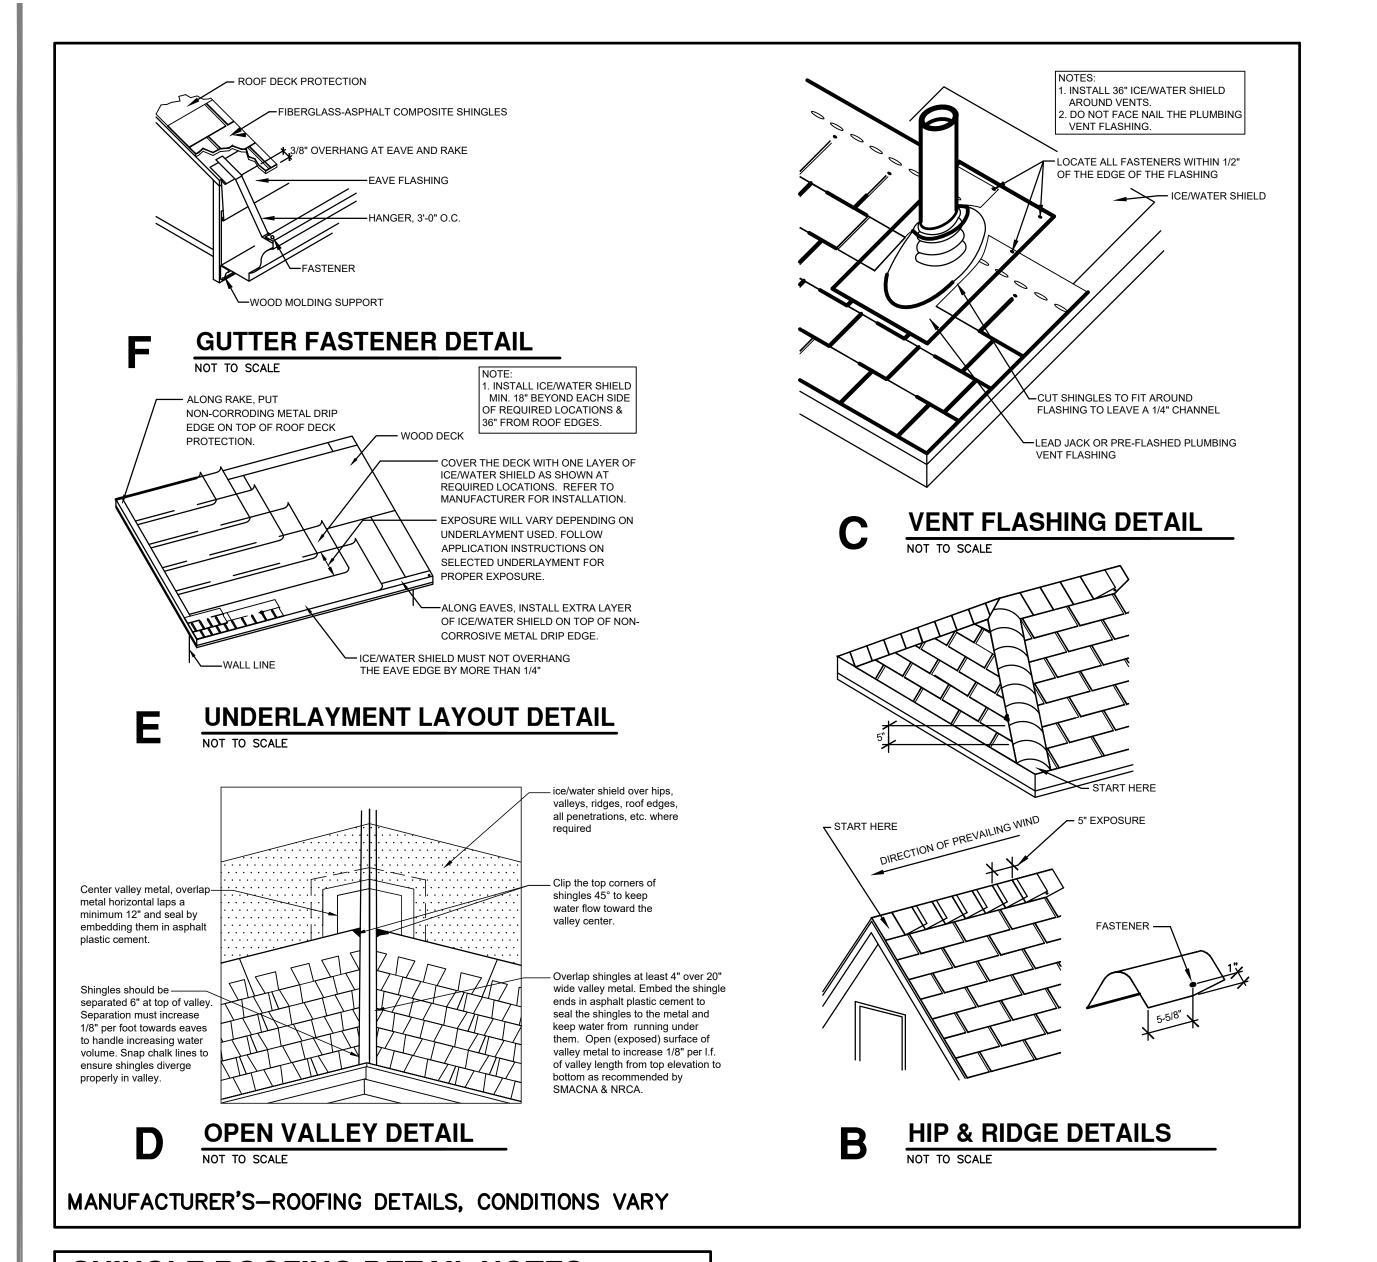


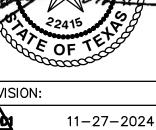


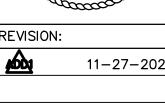11-22-2024 DATE: 24-3395 SHEET NO .:

**A5.**<sup>1</sup>



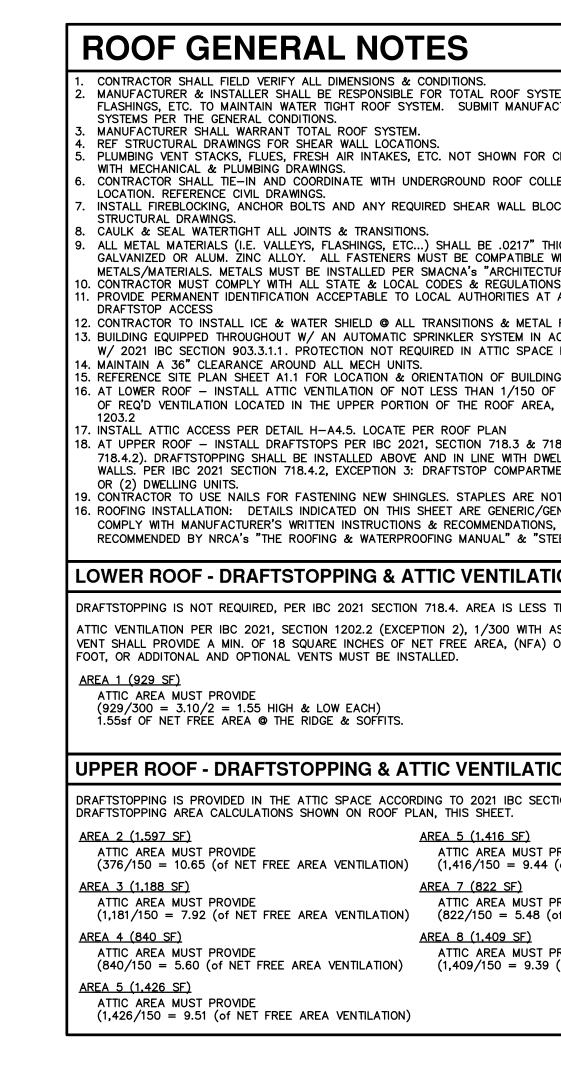

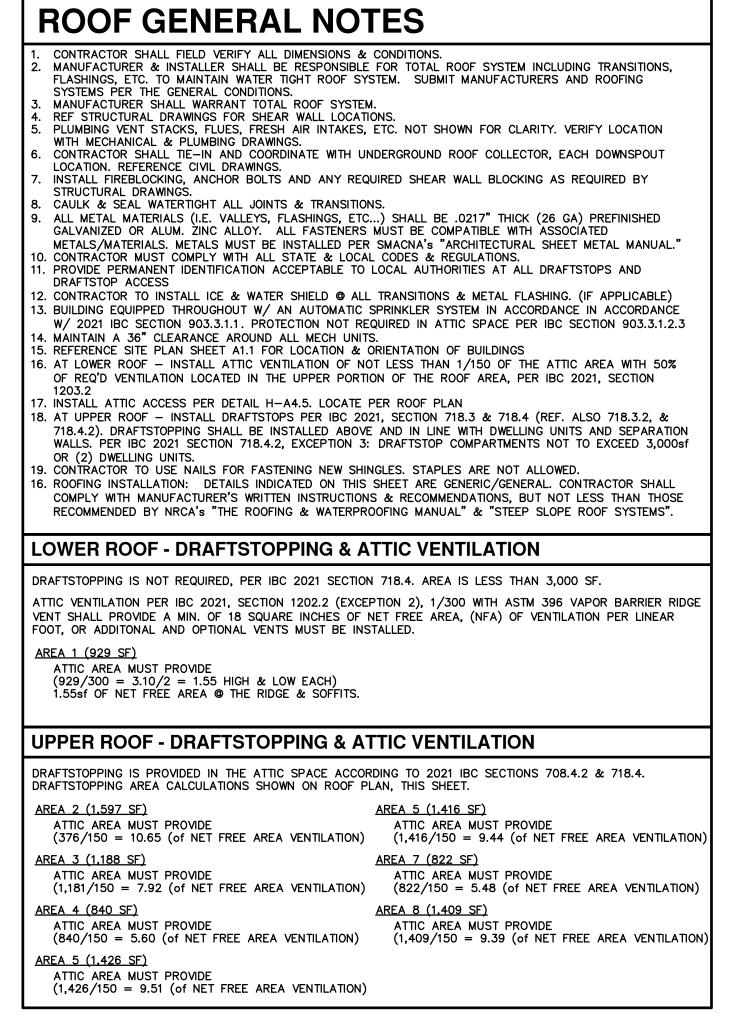

LEGEND

FULL COVERAGE WARRANTY.

REFERENCE DETAIL F-A4.4

REFERENCE DETAIL D-A4.4

MINIMUM GUTTER & DOWNSPOUT

GUTTER - PREFIN. 4x5

DOWNSPOUT - PREFIN. 3x4

INSTALL 60-MIL TPO ROOFING MEMBRANE OVER 1/2" COVER

J BOARD, XPS RIGID INSUL. (5"min), (TAPERED INSULATION AS

SHEATHING & ROOF TRUSSES (REF. STRUCT). PROVIDE

REQUIRED FOR ROOF DRAINAGE, REFERENCE ROOF PLAN), ROOF

TERMINATION BARS, FLASHING, SEALANT, & CAULKING. RUN ROOFING MEMBRANE UP BACKSIDE OF PARAPETS AND INSTALL

PARAPET METAL FLASHING CAPS (COLOR TO BE DETERMINED). ENTIRE ROOF ASSEMBLY SHALL BE PROVIDED AND INSTALLED A

1-HR FIRE PARTITION TO UNDERSIDE OF DECK. (ELEVATOR SHAFT BELOW)

INSTALL ASPHALT COMPOSITION SHINGLES OVER 30# FELT, 5/8"

INSTALL DRAFTSTOP DOOR(S) PER IBC 2021, SECTION 718.4.1.1.

INSTALL GRAVITY VENTILATOR, SIM. TO GREENHECK GRS-16-QD,

INDICATES 60-MIL TPO ROOFING MATERIAL

CEMENT BOARD SOFFIT OR HARDI BOARD (TYP)

INDICATES LOCATION OF A PREFIN. 3x4


3 LOCATION OF ROOF HATCH & SAFETY RAIL PER SPEC

ZIP SYSTEM DECKING REF IBC 2021, SECT. 1507.2

 $\stackrel{\prime}{\square}$  (MUST HAVE 1.45 SF OF NFA OR GREATER).

INSTALL ATTIC ACCESS PER IBC 2021, SECTION 1209.2.

REQUIRED & RECOMMENDED BY MANUFACTURER FOR A 20-YEAR

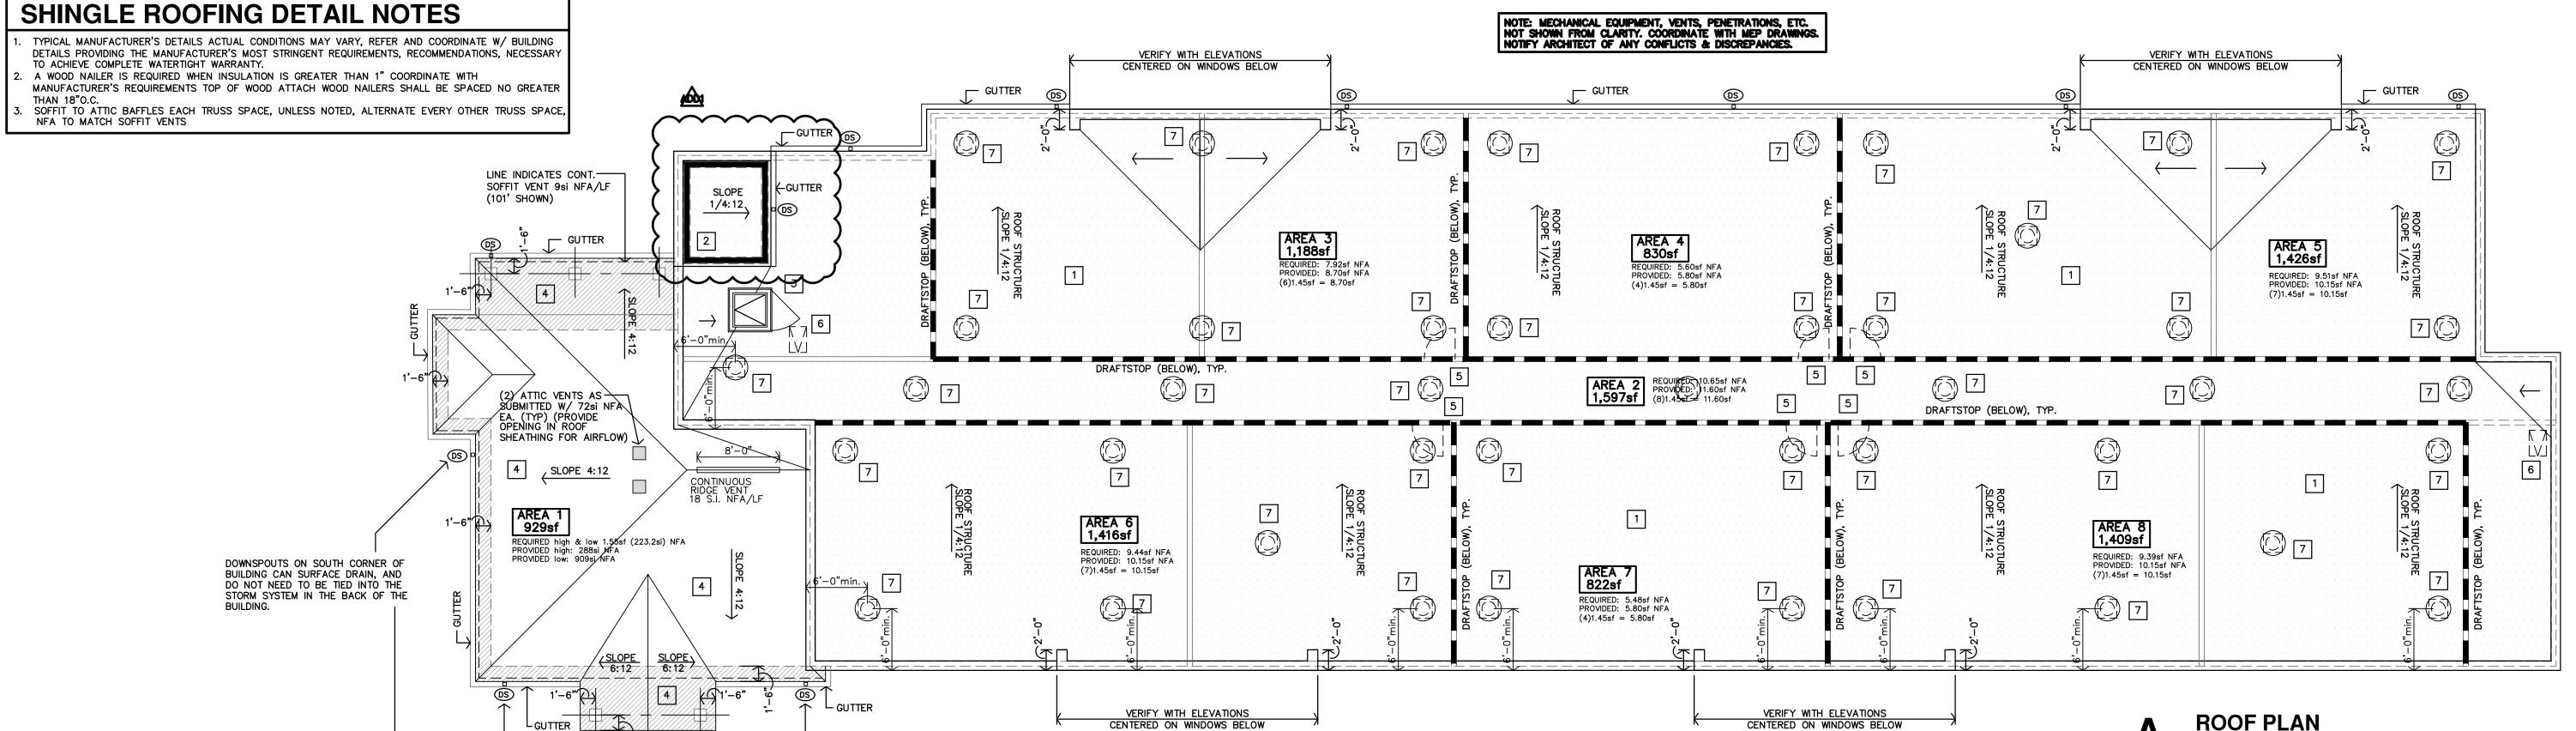



SUMP PUMP PIT (REF

ELEV.

TO BEEFCI

6'-11"

HYDRAULIC ELEVATOR CONTRACT DATA

**E1** 

\_ DTL. 6-S3.1)

<u>υ</u> <u>υ</u> <u>υ</u>

MECH DWGS & STRUCT.

ELEVATOR CAB TO

STRETCHER. REF.

ACCOMMODATE 24x84

2018 IBC, SEC. 3002.4

104

1'-0"

ELEVATOR
1st, 2nd & 3rd FLOORS

REVISION:

11-27-2024

DATE: 11-22-2024 24-3395

SHEET NO.: **A6.2** 


(REF STRUCT.)



SUMP PUMP PIT

& STRUCT.) └ — — — J

(REF MECH DWGS

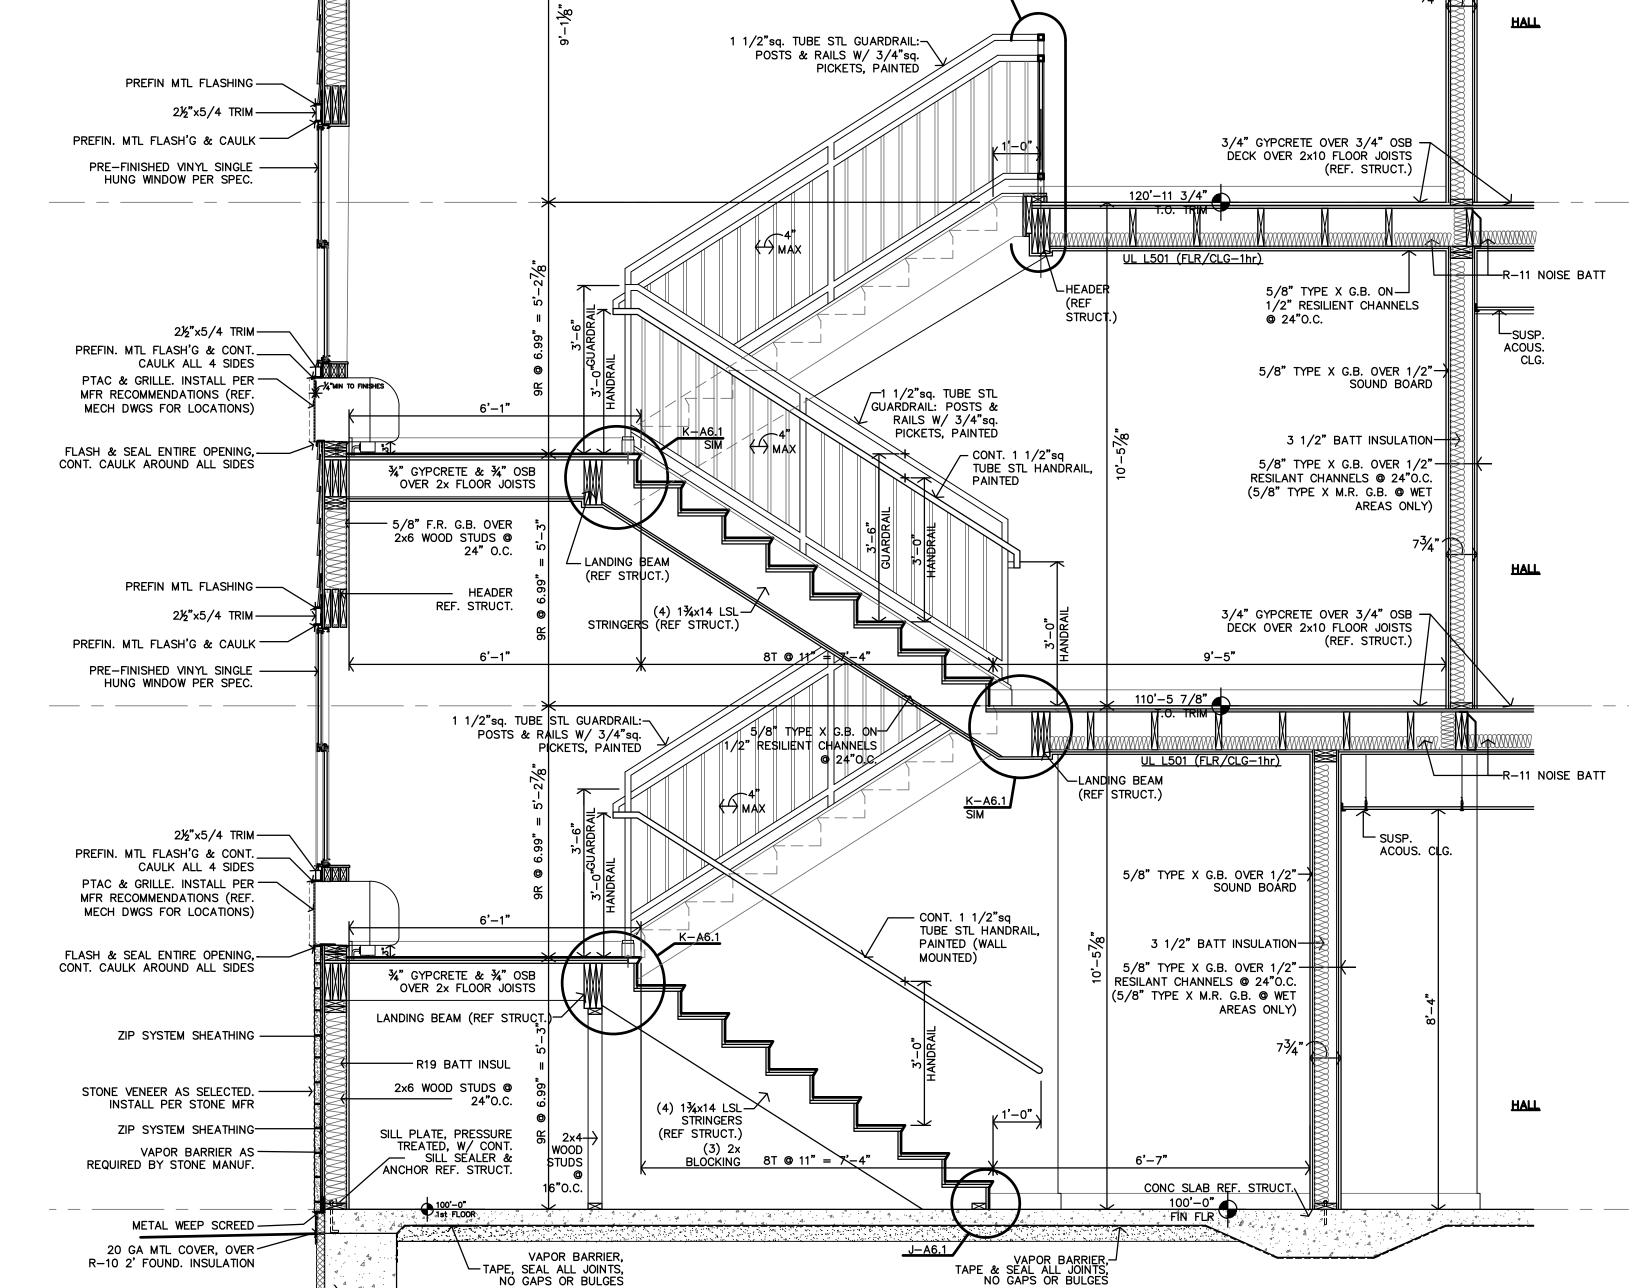

TLL ENTIRE CAVITY, MIN. R/49 BLOWN INSULATION, OVER ASTIM-E96 VAPOR/BARRIER 6 MIL VISQUEEN

└5/8" TYPE X G.B. OVER 7/8"

TREAD & RISER NAILING

BASE TREAD LAYER - 100 @ 8"O.C.

FACE TREAD LAYER - 160 @ 6"O.C.

- 10ø @ 6"O.C.

HAT CHANNELS @ 12"O.C.

23'-11" F.O.S.

ROOFING MEMBRANE (UP &

ROOF TRUSSES @/ 24"O.C. REF. STRUCT.

TAPE, SEAL ALL JOINTS, NO GAPS OR BULGES

UNDER CAP FLASHING)

CONT. CANT. STRIP

-5/8" F.R. G.B. OVER

7/8" HAT CHANNELS

5/8" F.R. G.B. OVER

-2x6 WOOD STUDS @

-R19 BATT INSUL

**@** 12"0.C.

PREFIN. MTL. CAP

133'-2 5/8" TOP ROOF DECK

9.25" HARDIE-PLANK

ZIP SYSTEM SHEATHING-


9.25" HARDIE-PLANK

SIDING (OR BD-BATTEN)

CONCRETE FOOTING REF. STRUCTURAL

SIDING (OR BD-BATTEN)

FLASH'G W/ DRIP EDGE

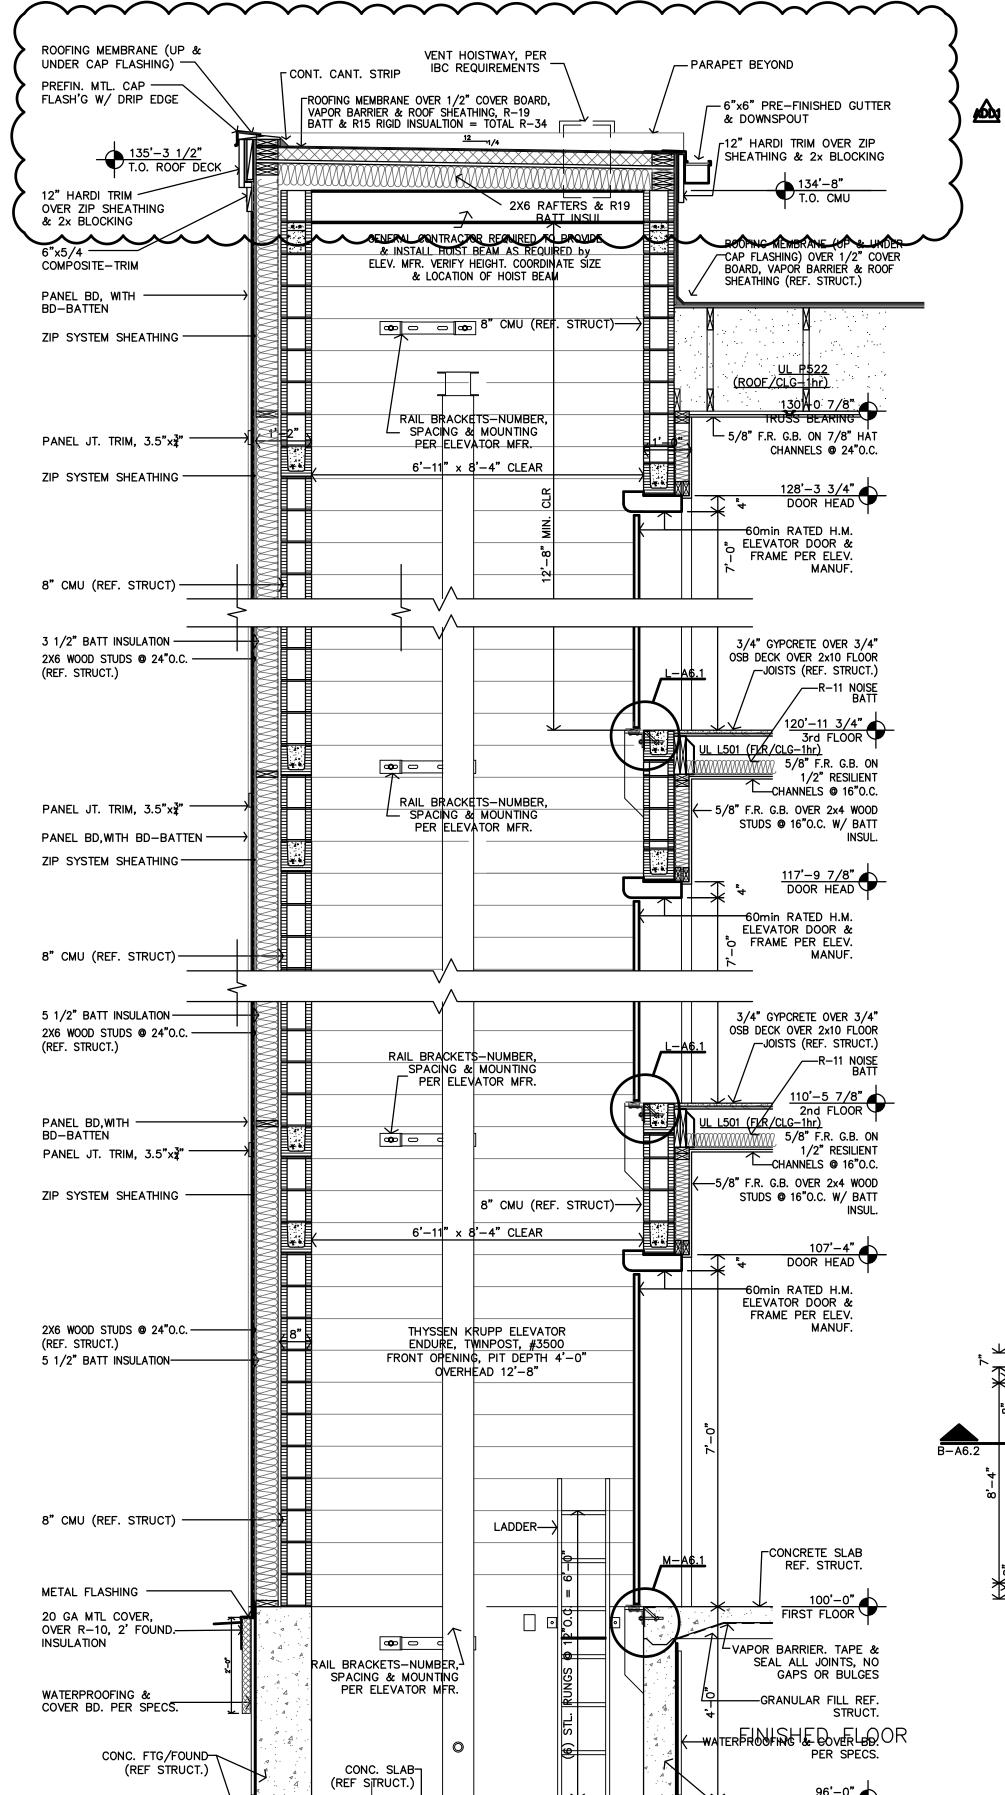

ROOFING MEMBRANE (UP & UNDER CAP FLASHING) OVER 1/2" COVER BOARD, VAPOR BARRIER & ROOF SHEATHING (REF. STRUCT.)

5/8" TYPE X G.B. OVER 1/2" SOUND-

3 1/2" BATT INSULATION—

ONLY)

5/8" TYPE X G.B. OVER 1/2

TYPE X M.R. G.B. @ WET ARÉAS

RESILANT CHANNELS @ 24"O.C. (5/8"

- 1 INSTALL RECEPTACLE ON WALL OF ELEVATOR PIT. VERIFY EXACT LOCATION WITH ELEVATOR EQUIPMENT INSTALLER.
   2 SWITCH EXHAUST FAN WITH ROOM LIGHTS.
- 3 PROVIDE NEMA6-20R RECEPTACLE FOR CORD AND PLUG CONNECTION OF PTAC. VERIFY RECEPTACLE
  CONFIGURATION WITH PTAC SUPPLIED BY MECHANICAL CONTRACTOR. INSTALL RECEPTACLE CONCEALED IN UNIT
- 4 ROUTE CIRCUIT THROUGH CONTACTOR INDICATED ON DETAIL 2:E6.1.
- 5 PROVIDE 30A/2P, SINGLE THROW, MANUAL MOTOR CONTROLLER SNAP SWITCH IN NEMA 1 ENCLOSURE. HUBBELL #HBL7842D OR EQUAL. MAKE FINAL FLEXIBLE CONNECTION TO BLOWER COIL/ELECTRIC HEAT.
- 6 ROUTE 120V CIRCUIT FOR HOT WATER RECIRCULATION PUMP THROUGH ADJACENT AQUASTAT. PROVIDE 20A/1P SNAP SWITCH ADJACENT TO PUMP AND MAKE FINAL FLEXIBLE CONNECTION. COORDINATE WITH PLUMBING CONTRACTOR. 7 30A/2P NON-FUSED DISCONNECT SWITCH IN NEMA 3R ENCLOSURE. MAKE FINAL CONNECTION TO EQUIPMENT IN LFMC
- 8 120V POWER FOR FIRE SPRINKLER SYSTEM FLOW SWITCH(ES) AND BELL. PROVIDE #8 CU BONDING JUMPER FROM CIRCUIT EQUIPMENT GROUNDING CONDUCTOR TO METAL SPRINKLER SYSTEM PIPING AT AN ACCESSIBLE LOCATION PER NEC 250.104(B). COORDINATE WORK WITH FIRE SPRINKLER SYSTEM INSTALLER.
- 9 PROVIDE 120V POWER CONNECTION TO ELEVATOR SUMP PUMP ALARM PANEL AND 1" CONDUIT WITH PULL STRING STUBBED INTO ELEVATOR PIT FOR CONTROL CABLING. COORDINATE ALL WORK WITH PLUMBING CONTRACTOR.
- STUBBED INTO ELEVATOR PIT FOR CONTROL CABLING. COORDINATE ALL WORK WITH PLUMBING CONTRACTOR

  2-HOUR DIAL TIMER OVERRIDE SWITCH FOR SWITCHED RECEPTACLES. SEE 2:E6.1.
- 11 ONE RECEPTACLE SHALL BE CONNECTED TO CIRCUIT P1:2 (UNCONTROLLED) AND THE OTHER RECEPTACLES SHALL BE CONNECTED TO CIRCUIT P1:4 (CONTROLLED). CONTROLLED RECEPTACLE SHALL BE MARKED IN ACCORDANCE WITH NEC. 406-3(F)
- 12 TIMECLOCK AND CONTACTORS FOR EXTERIOR LIGHTING AND OFFICE RECEPTACLE CONTROL, RE: 2:E6.1.
   13 INSTALL LUMINAIRE ON WALL OF ELEVATOR PIT. VERIFY EXACT LOCATION WITH ELEVATOR EQUIPMENT INSTALLER.
- INSTALL LIGHT SWITCH ADJACENT TO PIT LADDER AT 48" ABOVE FLOOR LANDING.
- 14 ELECTRIC SERVICE EQUIPMENT, SEE RISER DIAGRAM ON SHEET E6.2.

#### **GENERAL ELECTRICAL NOTES**

H. DEFINITION OF TERMS

- A. ELECTRICAL EQUIPMENT AND DEVICES SHALL BE "LISTED" AND "IDENTIFIED" AS RATED FOR A MINIMUM OF 75°C CONDUCTOR TERMINATION.
- B. THE CIRCUITING OF ALL LIGHT AND RECEPTACLE OUTLETS HAS BEEN SHOWN ON THE PLANS, AND THE CONTRACTOR SHALL FOLLOW THIS CIRCUITING LAYOUT .
- C. CIRCUIT ALL EMERGENCY LIGHTS, NIGHT LIGHTS AND EXIT LIGHTS TO AN UNSWITCHED HOT CONDUCTOR, UPSTREAM OF ALL CONTROLS.
- D. WALL MOUNTED HVAC CONTROL DEVICES (THERMOSTATS, TEMPERATURE SENSORS, ETC) SHALL BE PROVIDED BY MECHANICAL CONTRACTOR. UNLESS NOTED OTHERWISE, ELECTRICAL CONTRACTOR SHALL PROVIDE SINGLE GANG WALL BOX AT 46" AFF AND 1/2" CONDUIT STUBBED OUT TO ABOVE ACCESSIBLE CEILING WITH NYLON BUSHINGS AND PULLSTRING IN RACEWAY. REFER TO MECHANICAL DRAWINGS FOR LOCATIONS OF DEVICES.
- E. COORDINATE INSTALLATION OF ELECTRICAL WORK ABOVE THE CEILING TO PROVIDE THE GREATEST POSSIBLE CLEARANCE FOR INSTALLATION OF PLUMBING AND MECHANICAL INSTALLATION. CONDUITS SHALL BE ROUTED THROUGH JOIST WEBS WHERE POSSIBLE.
- F. VERIFY EXACT PLACEMENT OF ALL DEVICES SHOWN ON THE ELECTRICAL CONSTRUCTION DOCUMENTS WITH ARCHITECTURAL, MECHANICAL AND PLUMBING DRAWINGS PRIOR TO FINAL PLACEMENT.
- G. PROVIDE TAMPER PROOF RECEPTACLES IN DWELLING UNITS PER NEC REQUIREMENTS.

TOTAL TANK ENTROOF NEOET MOLEO IN DWELLING ONTO LE

\* SHALL - ACTION THAT IS REQUIRED WITHOUT OPTION OR QUALIFICATION.

\* FURNISH -CONTRACTOR SHALL BE RESPONSIBLE FOR OBTAINING.

\* INSTALL - CONTRACTOR SHALL BE RESPONSIBLE FOR LABOR AND CONSTRUCTION EQUIPMENT NECESSARY TO SET IN PLACE, CONNECT, CALIBRATE AND TEST EQUIPMENT FURNISHED BY HIM OR OTHERS.

\* PROVIDE -CONTRACTOR SHALL FURNISH AND INSTALL

LST Consulting Engineers, PA

MANHATTAN

4809 Vue Du Lac Place, Suite 201

Manhattan, KS 66503

785.587.8042

Project 24034

PROJECT SHALL COMPLY WITH ALL REQUIREMENTS OF 2021 IECC
-NOTE: OUTLET BOXES ON EXTERIOR WALL SHALL BE AIR-TIGHT
BOXES PER SECTION 402.6

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AT GREEN MEADO

RESIDENCE

**NEW SENIOR LIVING** 

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SAN ANGELO,

TIMOTEY C. TREDWAY

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11-27-2024 REVISIONS:

1 Addendum #1 2024-11-27


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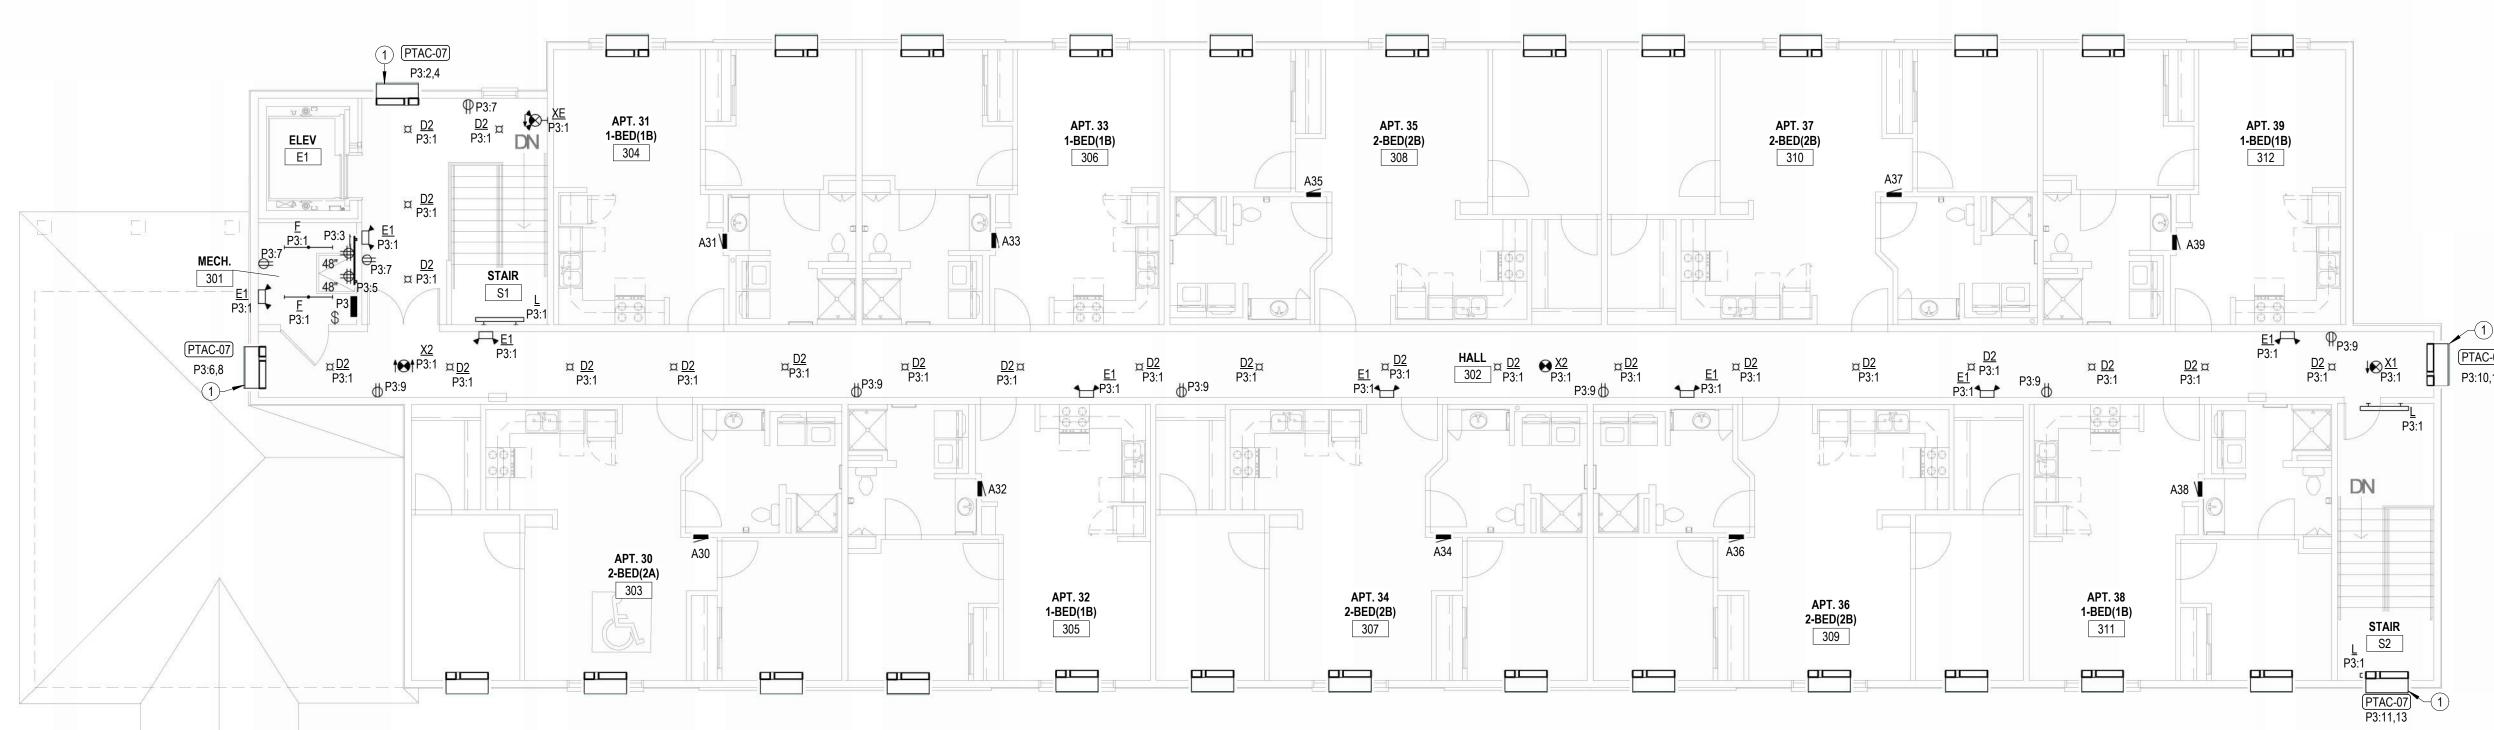
 JOB:
 24-3395

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 24-3395


E1.1



1 FIRST FLOOR POWER PLAN
E1.1 1/8" = 1'-0"

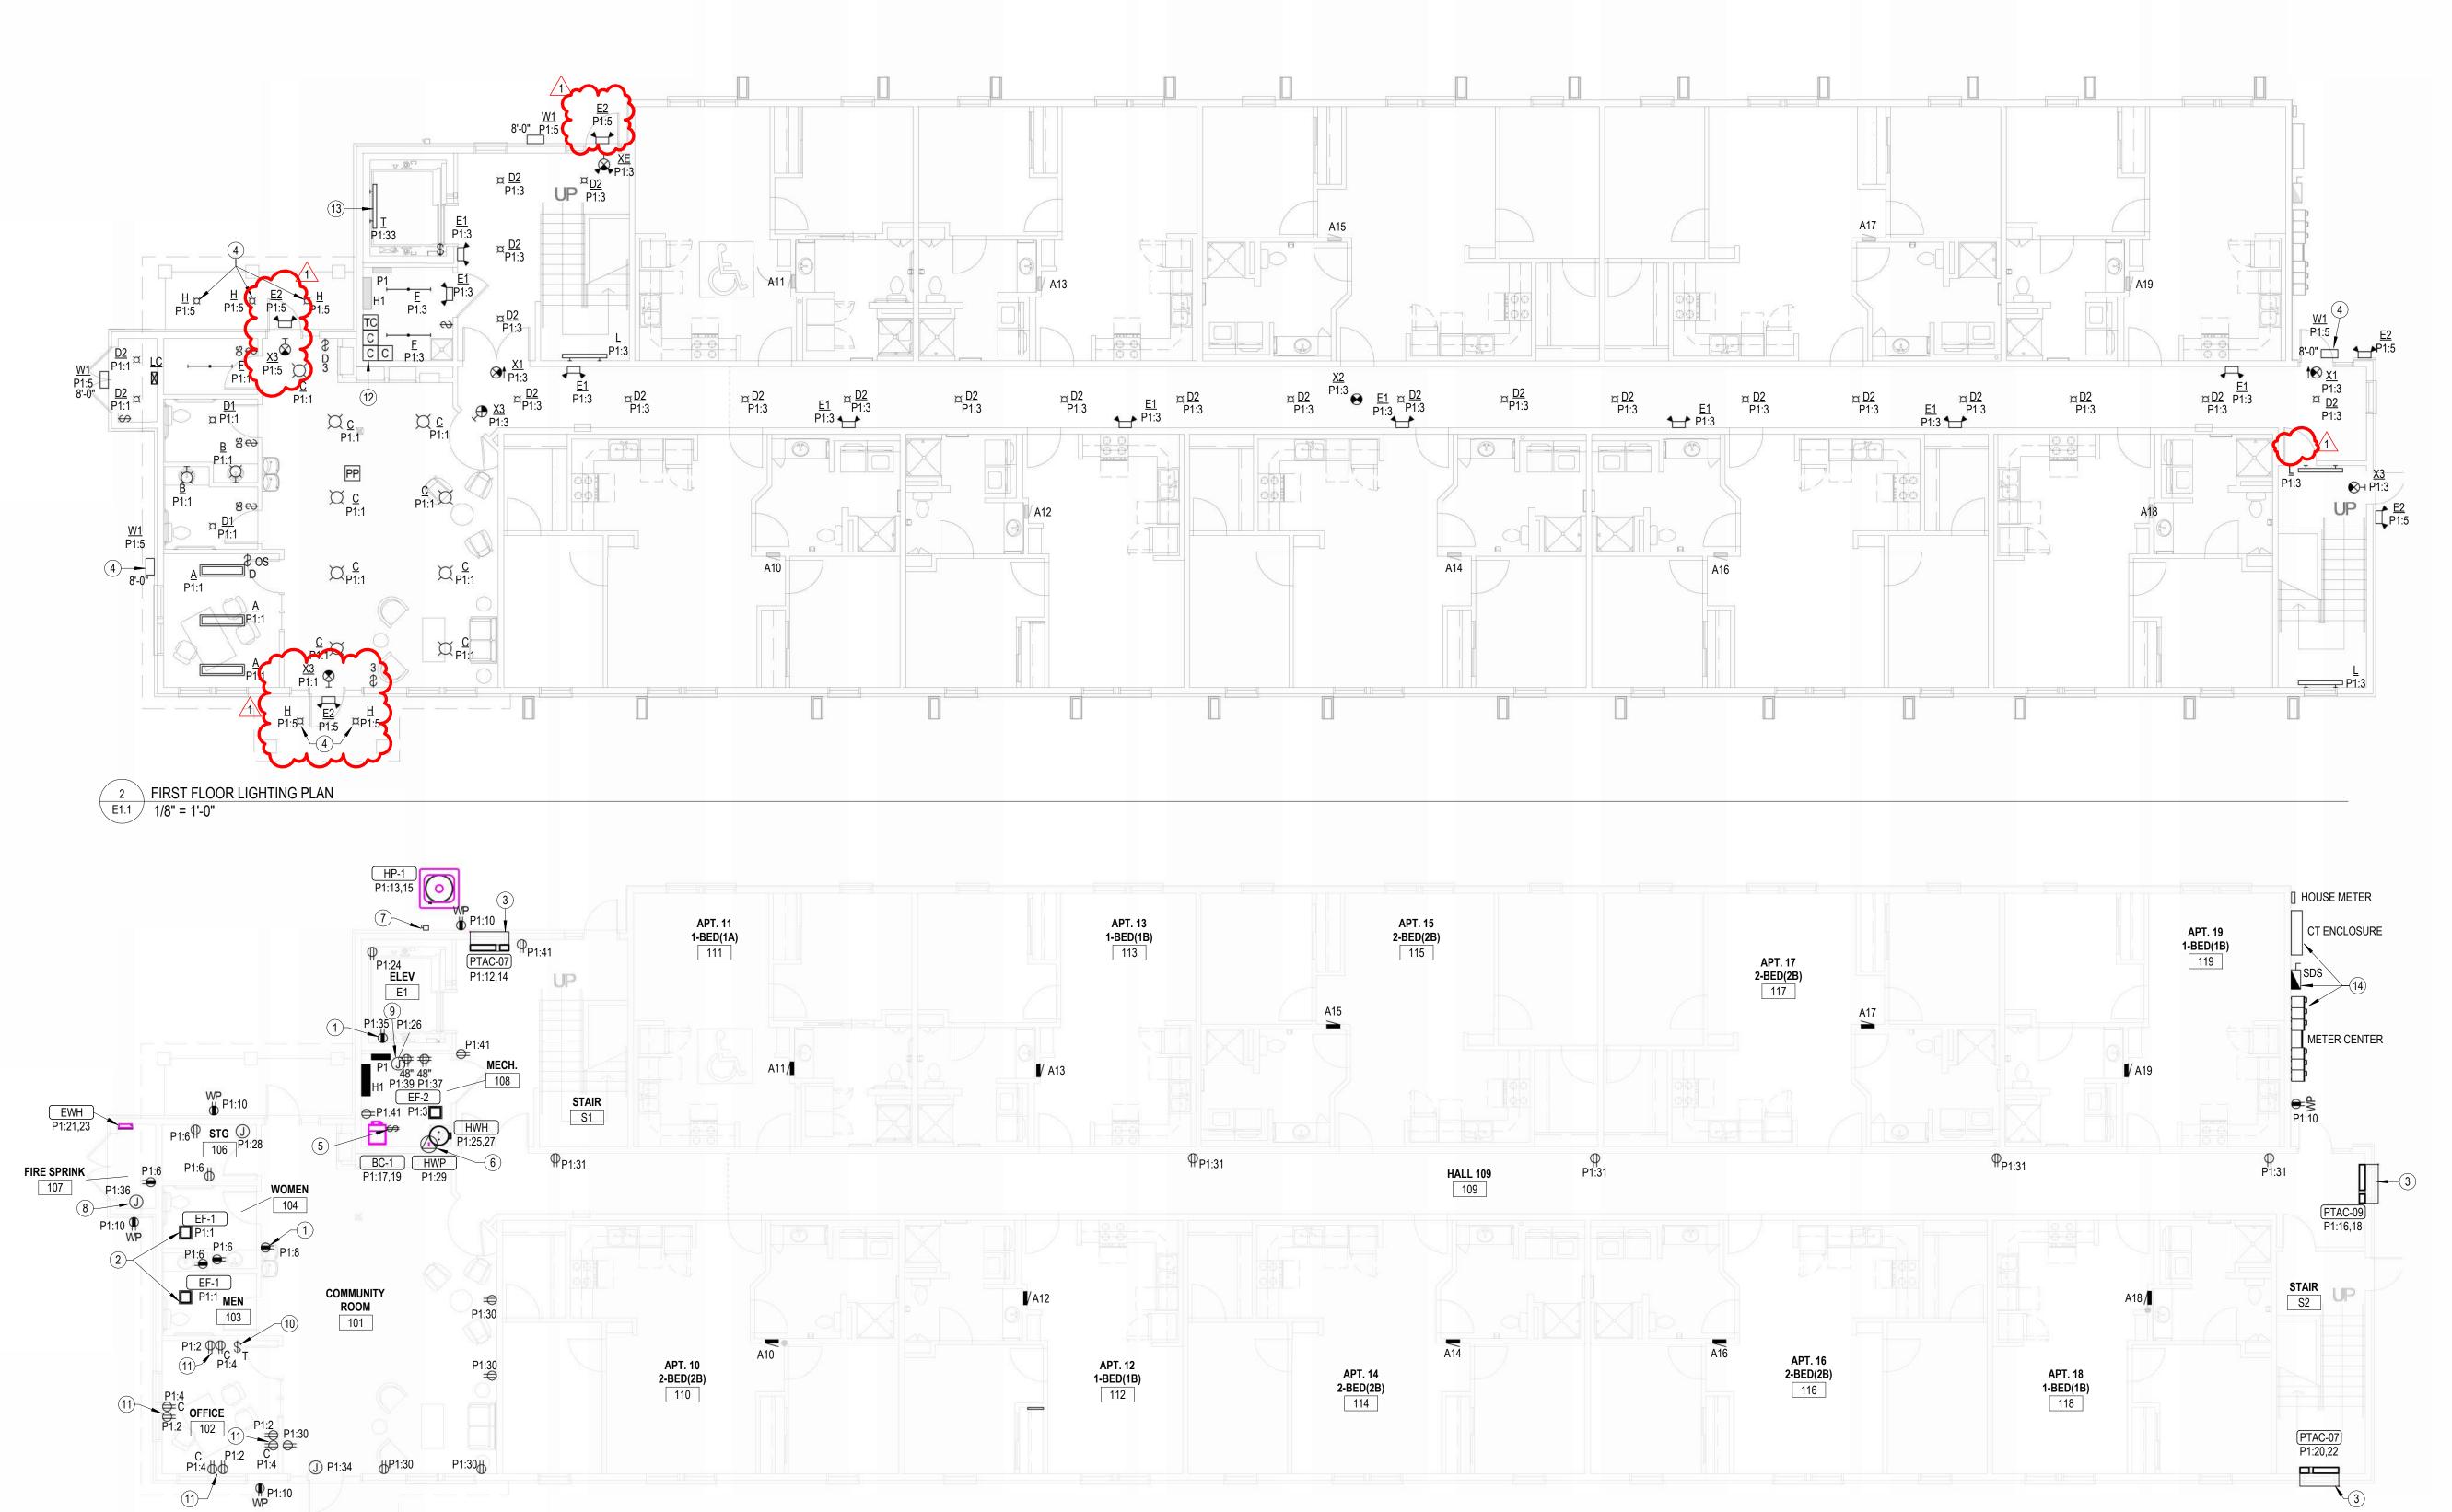

2 THRID FLOOR ELECTRICAL PLAN E1.2 / 1/8" = 1'-0"

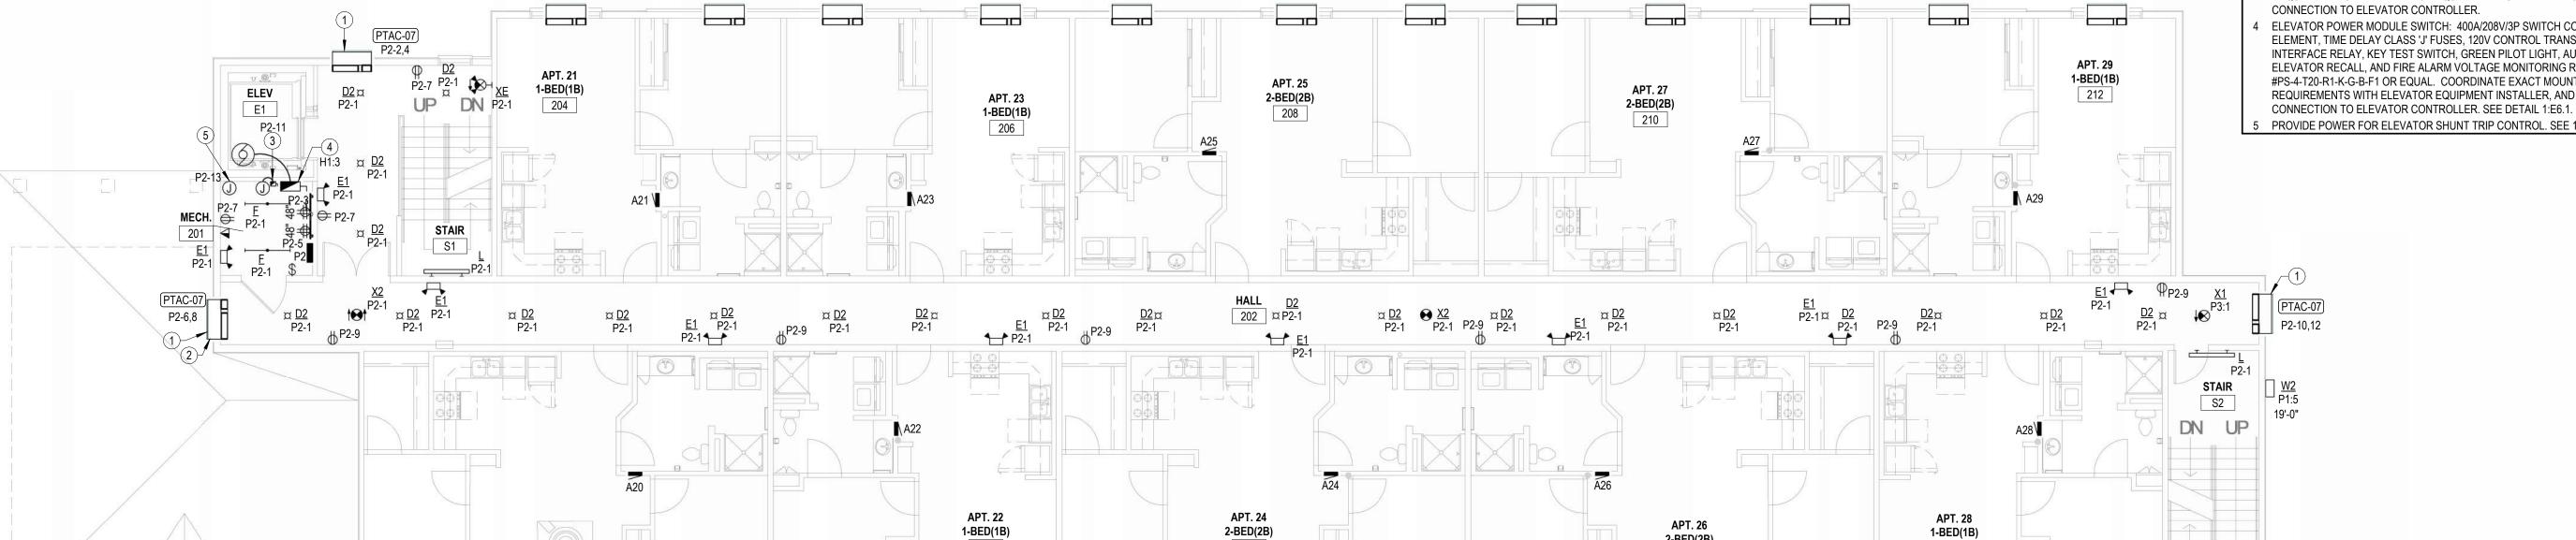

205

207

2-BED(2B)

209


211

SECOND FLOOR ELECTRICAL PLAN 1 SECOND FL E1.2 1/8" = 1'-0"

# NOTES BY SYMBOL

7

- PROVIDE NEMA6-20R RECEPTACLE FOR CORD AND PLUG CONNECTION OF PTAC. VERIFY RECEPTACLE CONFIGURATION WITH PTAC SUPPLIED BY MECHANICAL CONTRACTOR. INSTALL RECEPTACLE CONCEALED IN UNIT SUB-BASE.
- INSTALL TOP OF PTAC 12" BELOW FINISHED CEILING. COORDINATE INSTALLATION WITH
- 30A DISCONNECT SWITCH, LOCKABLE IN "OFF" POSITION, WITH SOLID NEUTRAL AND (1) 20A DUAL-ELEMENT, TIME DELAY FUSE IN NEMA 1 ENCLOSURE FOR ELEVATOR CAB LIGHTS & EXHAUST. MOUNT AT 6'-0" AFF TO TOP AND LABEL WITH CORRESPONDING ELEVATOR CAR NUMBER AND CIRCUIT NUMBER. COORDINATE EXACT MOUNTING LOCATION AND REQUIREMENTS WITH ELEVATOR EQUIPMENT INSTALLER. PROVIDE FINAL ELECTRICAL
- CONNECTION TO ELEVATOR CONTROLLER. ELEVATOR POWER MODULE SWITCH: 400A/208V/3P SWITCH COMPLETE WITH 225A DUAL ELEMENT, TIME DELAY CLASS 'J' FUSES, 120V CONTROL TRANSFORMER, FIRE ALARM SAFETY INTERFACE RELAY, KEY TEST SWITCH, GREEN PILOT LIGHT, AUXILIARY CONTACTS FOR ELEVATOR RECALL, AND FIRE ALARM VOLTAGE MONITORING RELAY. EATON BUSSMAN #PS-4-T20-R1-K-G-B-F1 OR EQUAL. COORDINATE EXACT MOUNTING LOCATION AND REQUIREMENTS WITH ELEVATOR EQUIPMENT INSTALLER, AND PROVIDE FINAL ELECTRICAL
- 5 PROVIDE POWER FOR ELEVATOR SHUNT TRIP CONTROL. SEE 1:E6.1 FOR MORE INFORMATION.

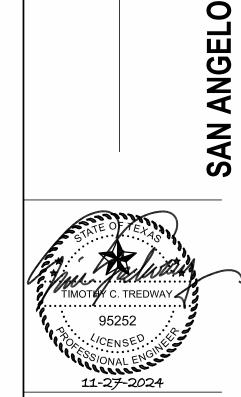

REVISIONS:

1 Addendum #1 2024-11-27

11/22/2024 DATE: 24-3395 SHEET NO.:

E1.2

**FACILITY NEW SENIOR LIVING** 

**MEADOW** 

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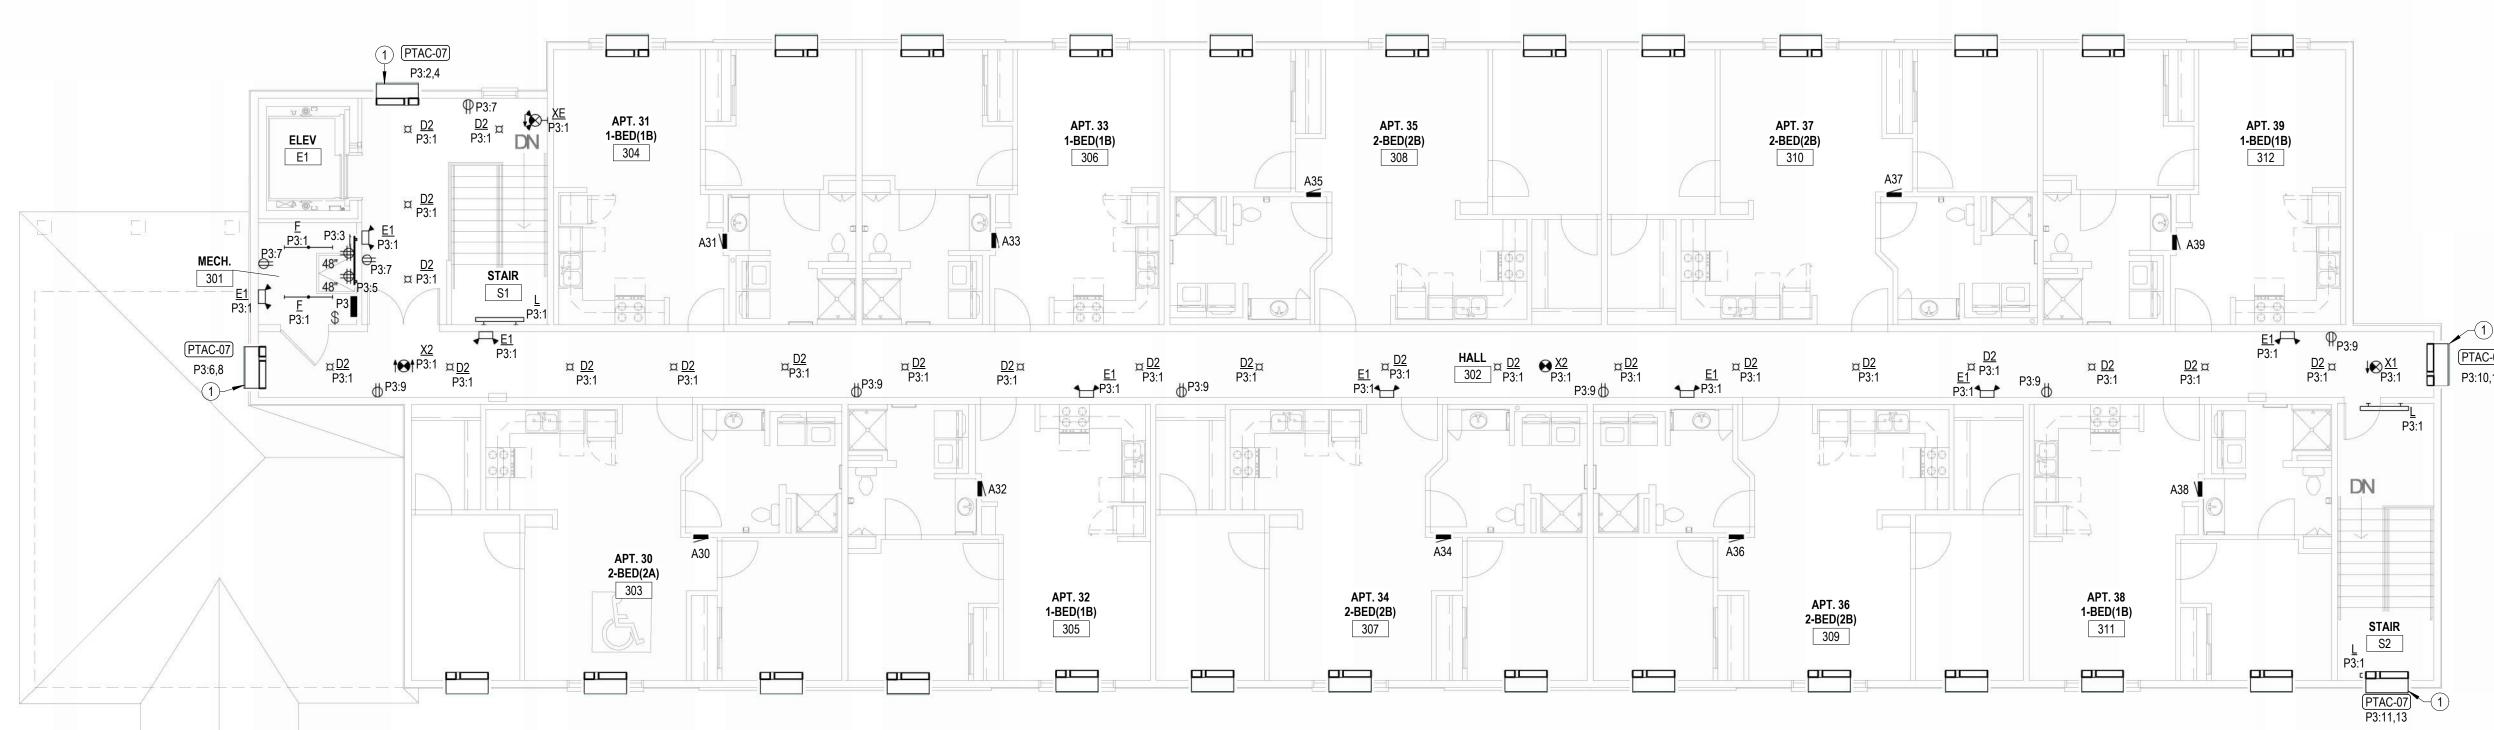
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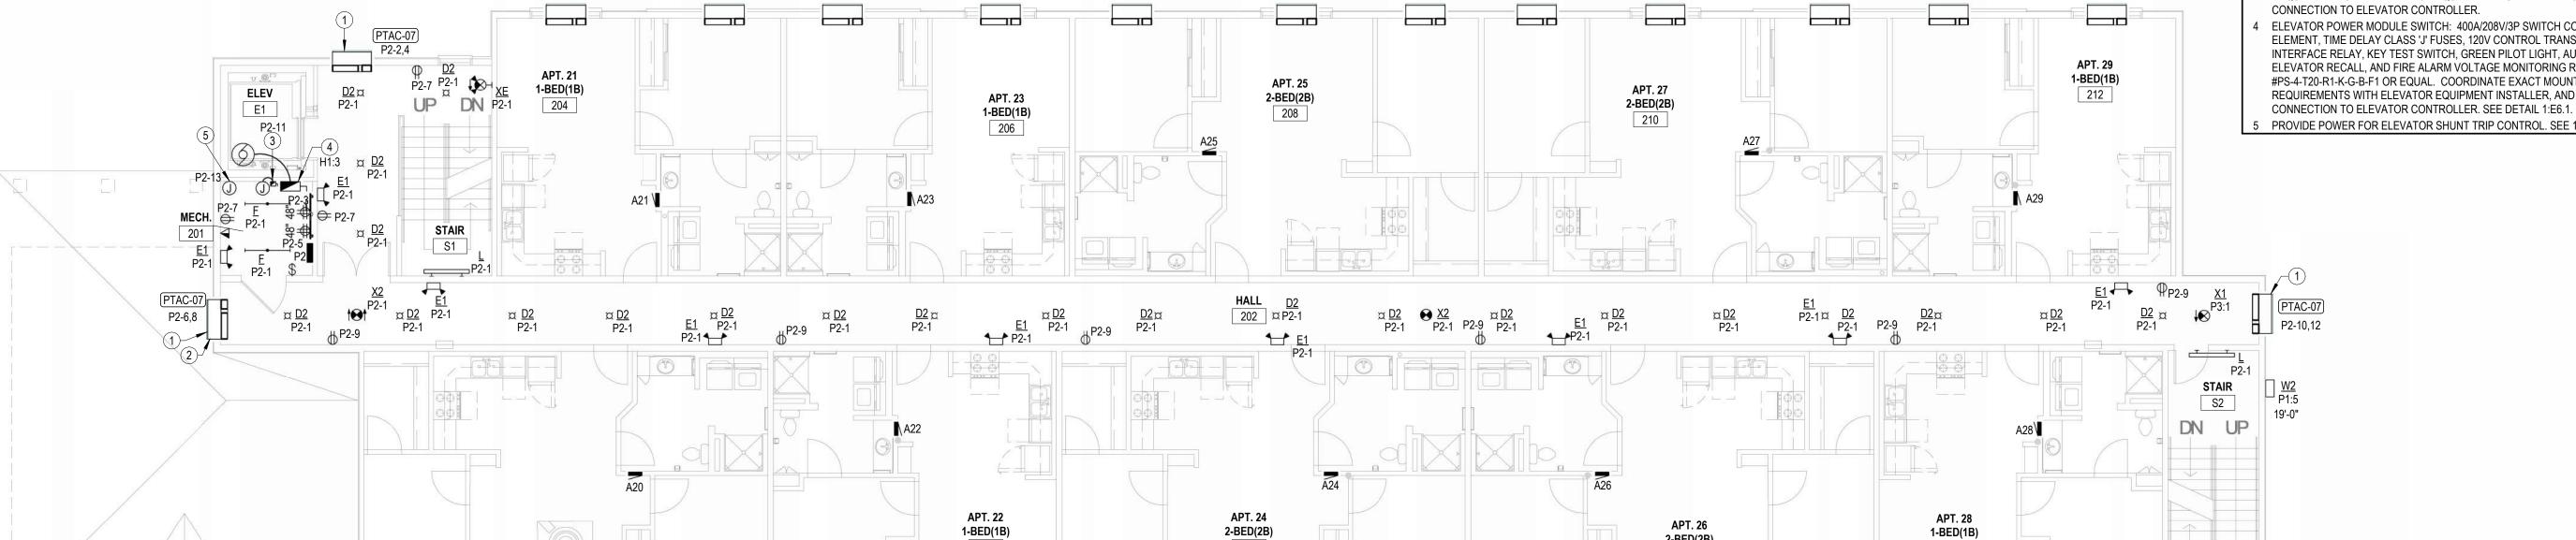
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2 THRID FLOOR ELECTRICAL PLAN E1.2 / 1/8" = 1'-0"



205

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2-BED(2B)

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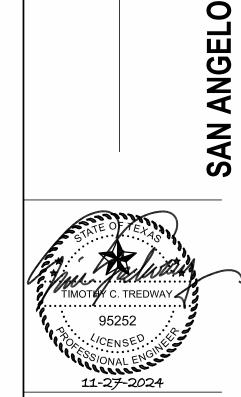
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E1.2

**FACILITY NEW SENIOR LIVING** 

**MEADOW** 

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### **GENERAL TELECOMMUNICATIONS NOTES**

A. PROVIDE COMPLETE WIRED PHONE AND CATV OUTLETS IN APARTMENT UNITS AS INDICATED ON SHEET E4.1.

B. AT TELECOMMUNICATIONS OUTLETS IN COMMON AREAS, PROVIDE 4" SQUARE x 2-1/8" DEEP BOX WITH 1-GANG DEVICE RING AND (1) 1" CONDUIT STUBBED INTO MECHANICAL ROOM 107.

C. PROVIDE NYLON BUSHINGS FOR ALL CONDUIT ENDS NOT CONNECTED TO A BOX OR FITTING TO PROTECT CABLING FROM DAMAGE.

D. PROVIDE BLANK, STAINLESS STEEL COVER PLATES FOR ALL COMMON AREA TELECOM OUTLETS NOT ACTIVATED BY OWNER.


E. PROVIDE SUITABLE PULL STRING IN ALL CONDUITS.


F. ALL TELECOM DATA CABLING, JACKS, CONNECTORS, TERMINATIONS, EQUIPMENT AND TESTING SHALL BE PROVIDED BY OWNER.

#### NOTES BY SYMBOL

- PROVIDE (2) CAT 5e UTP, NEC TYPE 'CMP' CABLES (SUPERIOR ESSEX #51-241-48 OR EQUAL) IN 3/4" CONDUIT FROM FACP TO MAIN TELECOM TERMINAL BOARD FOR CONNECTION TO FA SYSTEM DACT FOR REMOTE MONITORING.
- SMOKE DETECTOR AND ADDRESSABLE RELAY FOR CONTROL OF ELECTROMAGNETIC DOOR HOLDERS. DOORS SHALL RELEASE UPON DETECTION OF SMOKE. PROVIDE ADDRESSABLE FIRE ALARM RELAYS AND MONITORING MODULES FOR ALL FIRE SPRINKLER FLOW SWITCHES, TAMPER SWITCHES AND BELL/GONG. COORDINATE QUANTITIES
- AND LOCATIONS WITH FIRE SPRINKLER CONTRACTOR. SMOKE DETECTOR AND HEAT DETECTOR IN ELEVATOR PIT FOR RECALL AND SHUT-DOWN. SEE
- DETAIL 1, SHEET E6.1. ELEVATOR LOBBY SMOKE DETECTOR FOR ELEVATOR RECALL. SEE DETAIL 1, SHEET E6.1.
- FIRE ALARM ADDRESSABLE CONTROL MODULE FOR CONTROL OF APARTMENT UNIT'S NOTIFICATION APPLIANCE CIRCUIT. MODULE SHALL BE PROGRAMMED TO ACTIVATE APARTMENT UNIT'S NOTIFICATION APPLIANCES UPON GENERAL BUILDING FIRE ALARM AND UPON ACTIVATION OF ANY SMOKE DETECTOR OR CO DETECTOR WITHIN APARTMENT UNIT.
- MOUNT FLUSH IN WALL AT 8'-0" AFF. FIRE ALARM SYSTEM SMOKE DETECTOR.
- PROVIDE 8' LONG SHEET OF 3/4" ACX FIRE RETARDANT PLYWOOD INSTALLED VERTICALLY WITH BOTTOM AT 6" AFF, WIDTH AS REQUIRED. PLYWOOD SHALL BE PERMANENTLY FASTENED TO THE WALL BY MEANS OF WALL ANCHORS UTILIZING GALVANIZED, ZINC PLATED, OR STAINLESS STEEL HARDWARE WITH A FLAT HEAD. FINISHED INSTALLATION SHALL HAVE FLUSH APPEARANCE WITH COUNTERSUNK SCREW HEADS TO PREVENT SPLITTING OF THE PLYWOOD. DRYWALL SCREWS ARE NOT ACCEPTABLE. PAINT WITH TWO COATS OF LIGHT GRAY FIRE RETARDANT SEALER PRIOR TO INSTALLATION OF ANY EQUIPMENT.
- 4" EMT CONDUIT SLEEVES THROUGH 2ND AND 3RD FLOOR FOR COMMUNICATIONS CABLING. PROVIDE WITH FIRESTOPPING FITTINGS (WIREMOLD #FS4R-RED) AT BOTH ENDS.
- 0 TELECOMMUNICATIONS GROUND BAR SHALL BE 13-1/4"W x 2"H x 1/4" THICK ELECTRO-TIN PLATED COPPER BUS BAR, COMPLETE WITH INSULATED STAND-OFFS AND STAINLESS STEEL BRACKETS, ERICO #TGBA14L06PT OR EQUAL. MOUNT AT 18" AFF. ALL CONNECTIONS TO GROUND BAR SHALL BE MADE USING COMPRESSION TYPE LUGS.
- 11 PROVIDE 1" CONDUIT WITH PULL STRING FROM TELECOM OUTLET TO MAIN TELEPHONE TERMINAL BOARD IN MECH 108 12 EMT CONDUIT SLEEVE(S) THROUGH WALL WITH NYLON BUSHINGS FOR COMMUNICATIONS CABLING. QUANTITY AND SIZE AS REQUIRED. INSTALL ABOVE ACCESSIBLE CEILING. WHERE CONDUITS PENETRATE FIRE WALL, PROVIDE WITH FIRESTOPPING FITTINGS (WIREMOLD #FS4R-RED) AT BOTH ENDS.
- 13 PROVIDE PUSH BUTTON ROUGH-IN AND PREP DOOR JAM WITH RACEWAY AS INDICATED IN DETAL 3:M6.1 FOR AUTOMATIC DOOR OPENER. COORDINATE EXACT REQUIREMENTS WITH
- 14 PROVIDE (2) 3" CONDUITS FOR COMMUNICATIONS SERVICES. PROVIDE PULL STRING IN EACH RACEWAY.

15 SEE SITE PLAN FOR CONTINUATION.

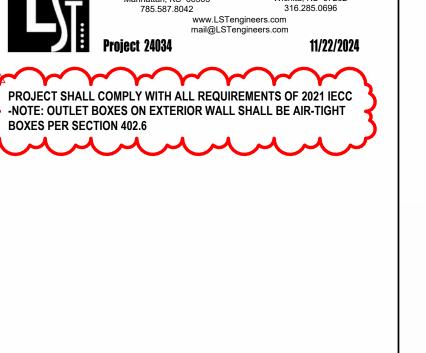

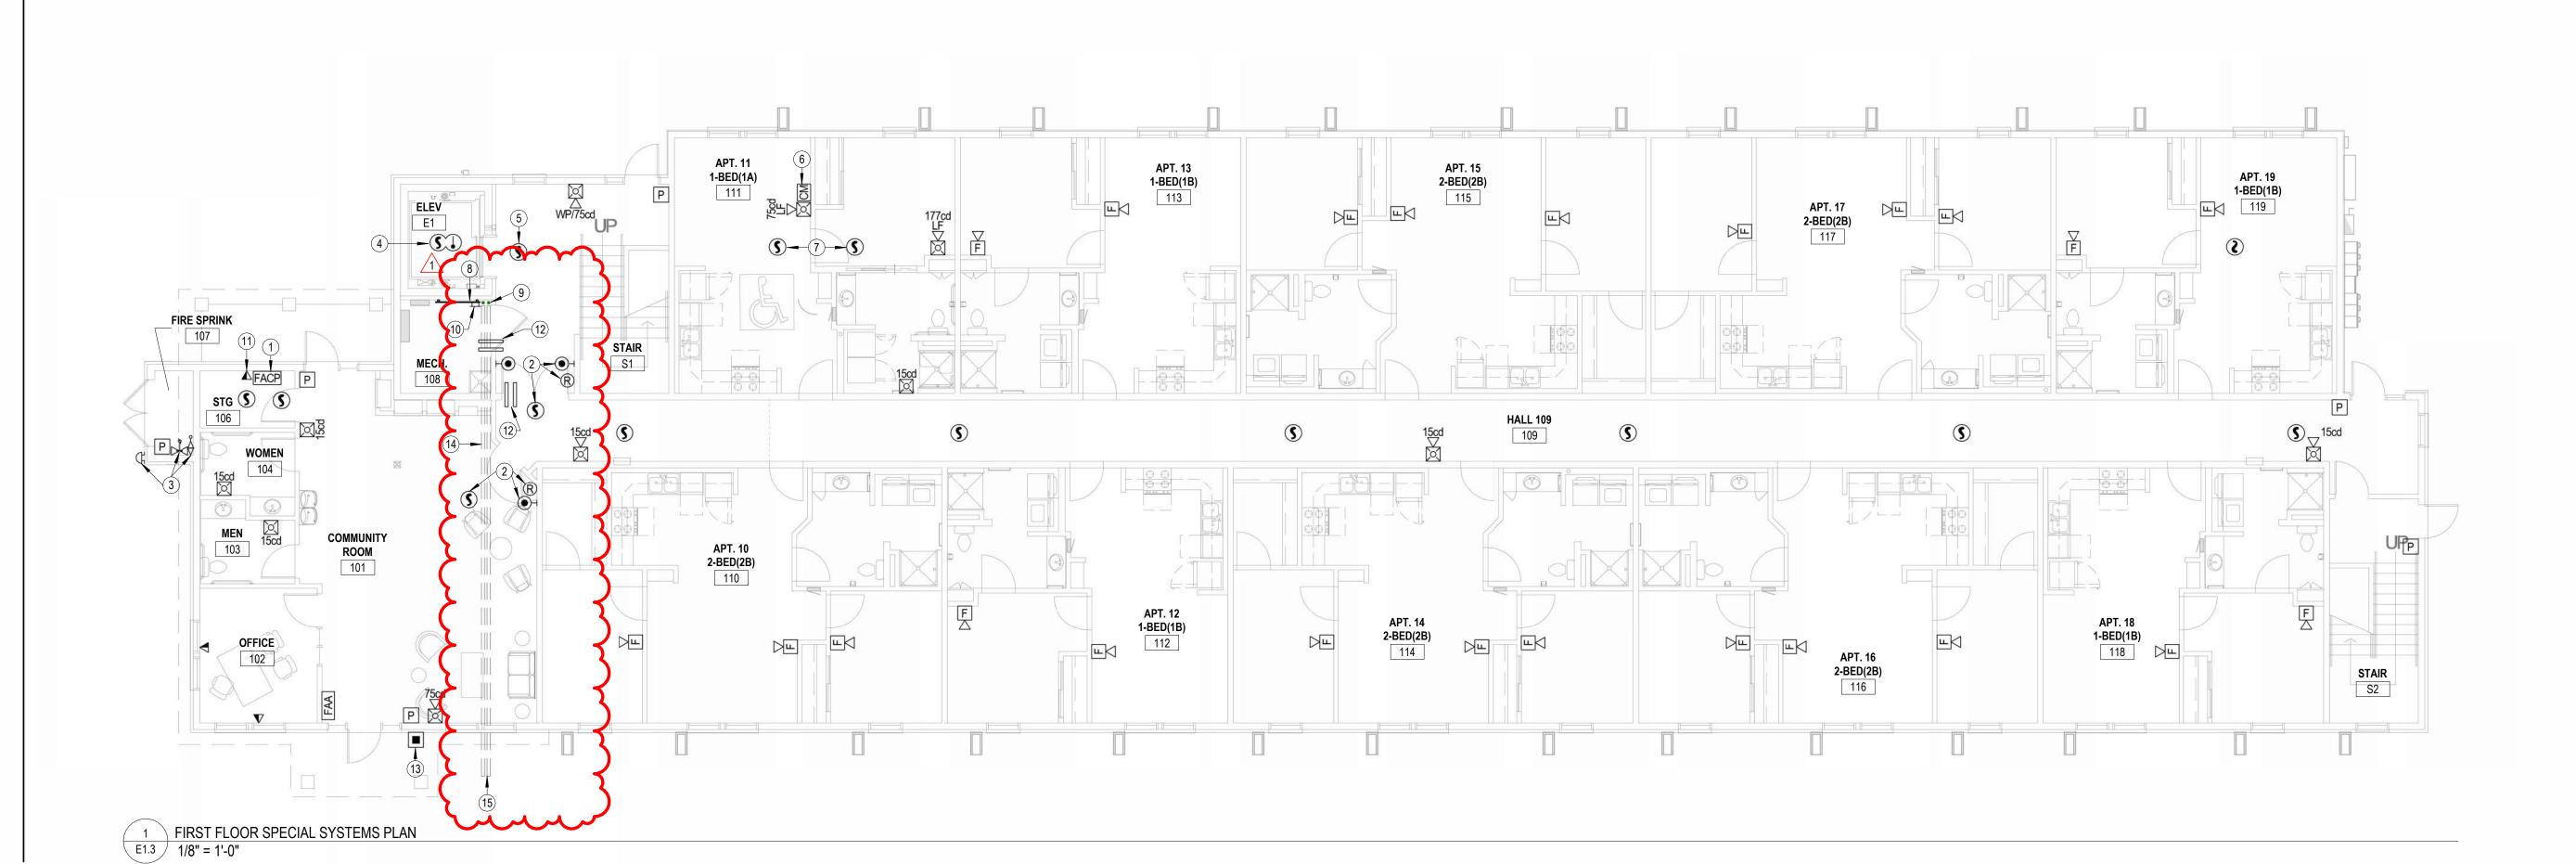

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RESIDENCE AT GI

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**NEW SENIOR LIV** 

SAN ANGELO,

11-27-2024

1 Addendum #1 2024-11-27

24-3395

SHEET NO.:

E1.3

-NOTE: OUTLET BOXES ON EXTERIOR WALL SHALL BE AIR-TIGHT

# NOTES BY SYMBOL


- 1 SMOKE DETECTOR AND ADDRESSABLE RELAY FOR CONTROL OF ELECTROMAGNETIC DOOR HOLDERS. DOORS SHALL RELEASE UPON DETECTION OF SMOKE.
- SMOKE DETECTOR AND HEAT DETECTOR AT TOP OF ELEVATOR HOISTWAY FOR RECALL AND SHUT-DOWN. SEE DETAIL 1, SHEET E6.1.

BOXES PER SECTION 402.6


- B ELEVATOR LOBBY SMOKE DETECTOR FOR ELEVATOR RECALL. SEE DETAIL 1, SHEET E6.1.
  FIRE ALARM ADDRESSABLE CONTROL MODULE FOR CONTROL OF APARTMENT UNIT'S
- 4 FIRE ALARM ADDRESSABLE CONTROL MODULE FOR CONTROL OF APARTMENT UNIT'S NOTIFICATION APPLIANCE CIRCUIT. MODULE SHALL BE PROGRAMMED TO ACTIVATE APARTMENT UNIT'S NOTIFICATION APPLIANCES UPON GENERAL BUILDING FIRE ALARM AND UPON ACTIVATION OF ANY SMOKE DETECTOR OR CO DETECTOR WITHIN APARTMENT UNIT. MOUNT FLUSH IN WALL AT 8'-0" AFF.
- 5 FIRE ALARM SYSTEM SMOKE DETECTOR.
- 6 PROVIDE 8' LONG SHEET OF 3/4" ACX FIRE RETARDANT PLYWOOD INSTALLED VERTICALLY WITH BOTTOM AT 6" AFF, WIDTH AS REQUIRED. PLYWOOD SHALL BE PERMANENTLY FASTENED TO THE WALL BY MEANS OF WALL ANCHORS UTILIZING GALVANIZED, ZINC PLATED, OR STAINLESS STEEL HARDWARE WITH A FLAT HEAD. FINISHED INSTALLATION SHALL HAVE FLUSH APPEARANCE WITH COUNTERSUNK SCREW HEADS TO PREVENT SPLITTING OF THE PLYWOOD. DRYWALL SCREWS ARE NOT ACCEPTABLE. PAINT WITH TWO COATS OF LIGHT GRAY FIRE RETARDANT SEALER PRIOR TO INSTALLATION OF ANY EQUIPMENT.
- 7 TELECOMMUNICATIONS GROUND BAR SHALL BE 13-1/4"W x 2"H x 1/4" THICK ELECTRO-TIN PLATED COPPER BUS BAR, COMPLETE WITH INSULATED STAND-OFFS AND STAINLESS STEEL BRACKETS, ERICO #TGBA14L06PT OR EQUAL. MOUNT AT 18" AFF. ALL CONNECTIONS TO GROUND BAR SHALL BE MADE USING COMPRESSION TYPE LUGS.

  8 4" EMT CONDUIT SLEEVES THROUGH 2ND AND 3RD FLOOR FOR COMMUNICATIONS CABLING.
- PROVIDE WITH FIRESTOPPING FITTINGS (WIREMOLD #FS4R-RED) AT BOTH ENDS.
- 9 ADDRESSABLE FIRE ALARM RELAYS FOR ELEVATOR RECALL, FIREMAN'S HAT, AND POWER SHUNT-TRIP, AND ADDRESSABLE MONITORING MODULE FOR MONITORING OF SHUNT TRIP VOLTAGE.
   9 EMT CONDUIT SLEEVE(S) THROUGH WALL WITH NYLON BUSHINGS FOR COMMUNICATIONS
- 10 EMT CONDUIT SLEEVE(S) THROUGH WALL WITH NYLON BUSHINGS FOR COMMUNICATIONS CABLING. QUANTITY AND SIZE AS REQUIRED. INSTALL ABOVE ACCESSIBLE CEILING. WHERE CONDUITS PENETRATE FIRE WALL, PROVIDE WITH FIRESTOPPING FITTINGS (WIREMOLD #FS4P-RED) AT ROTH ENDS

ELEVATOR MACHINE ROOM SMOKE AND HEAT DETECTORS FOR ELEVATOR RECASHUT-DOWN. SEE DETAIL 1, SHEET E6.1.

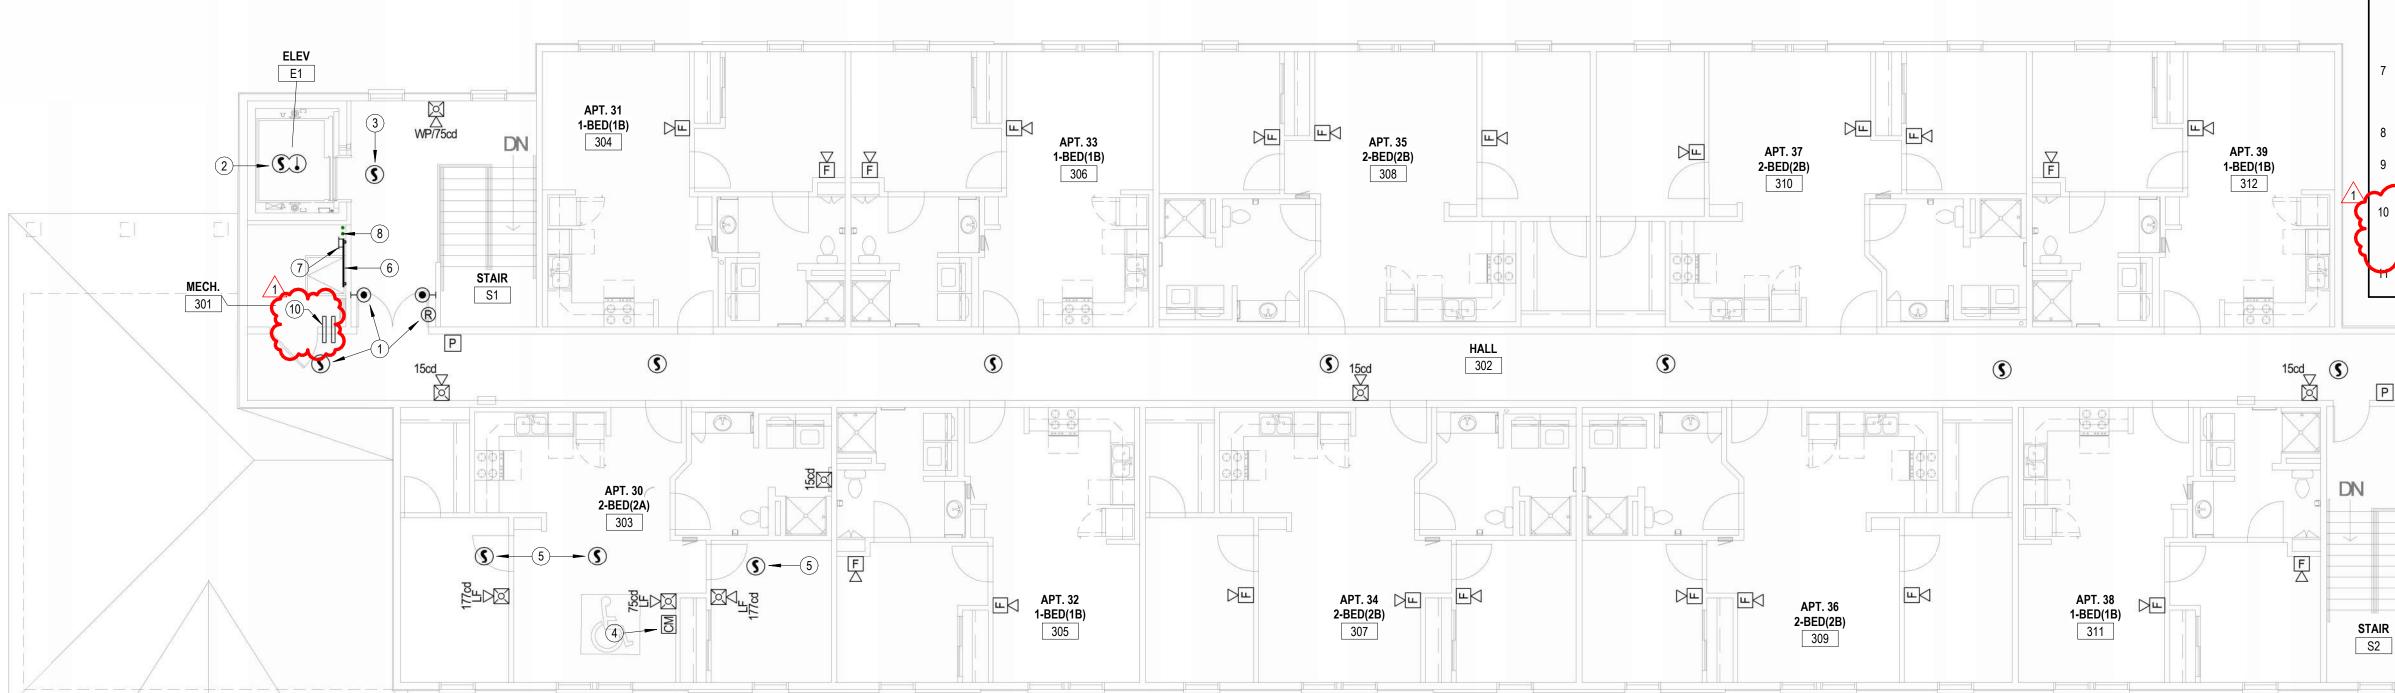

2 THRID FLOOR SPECIAL SYSTEMS PLAN
1/8" = 1'-0"

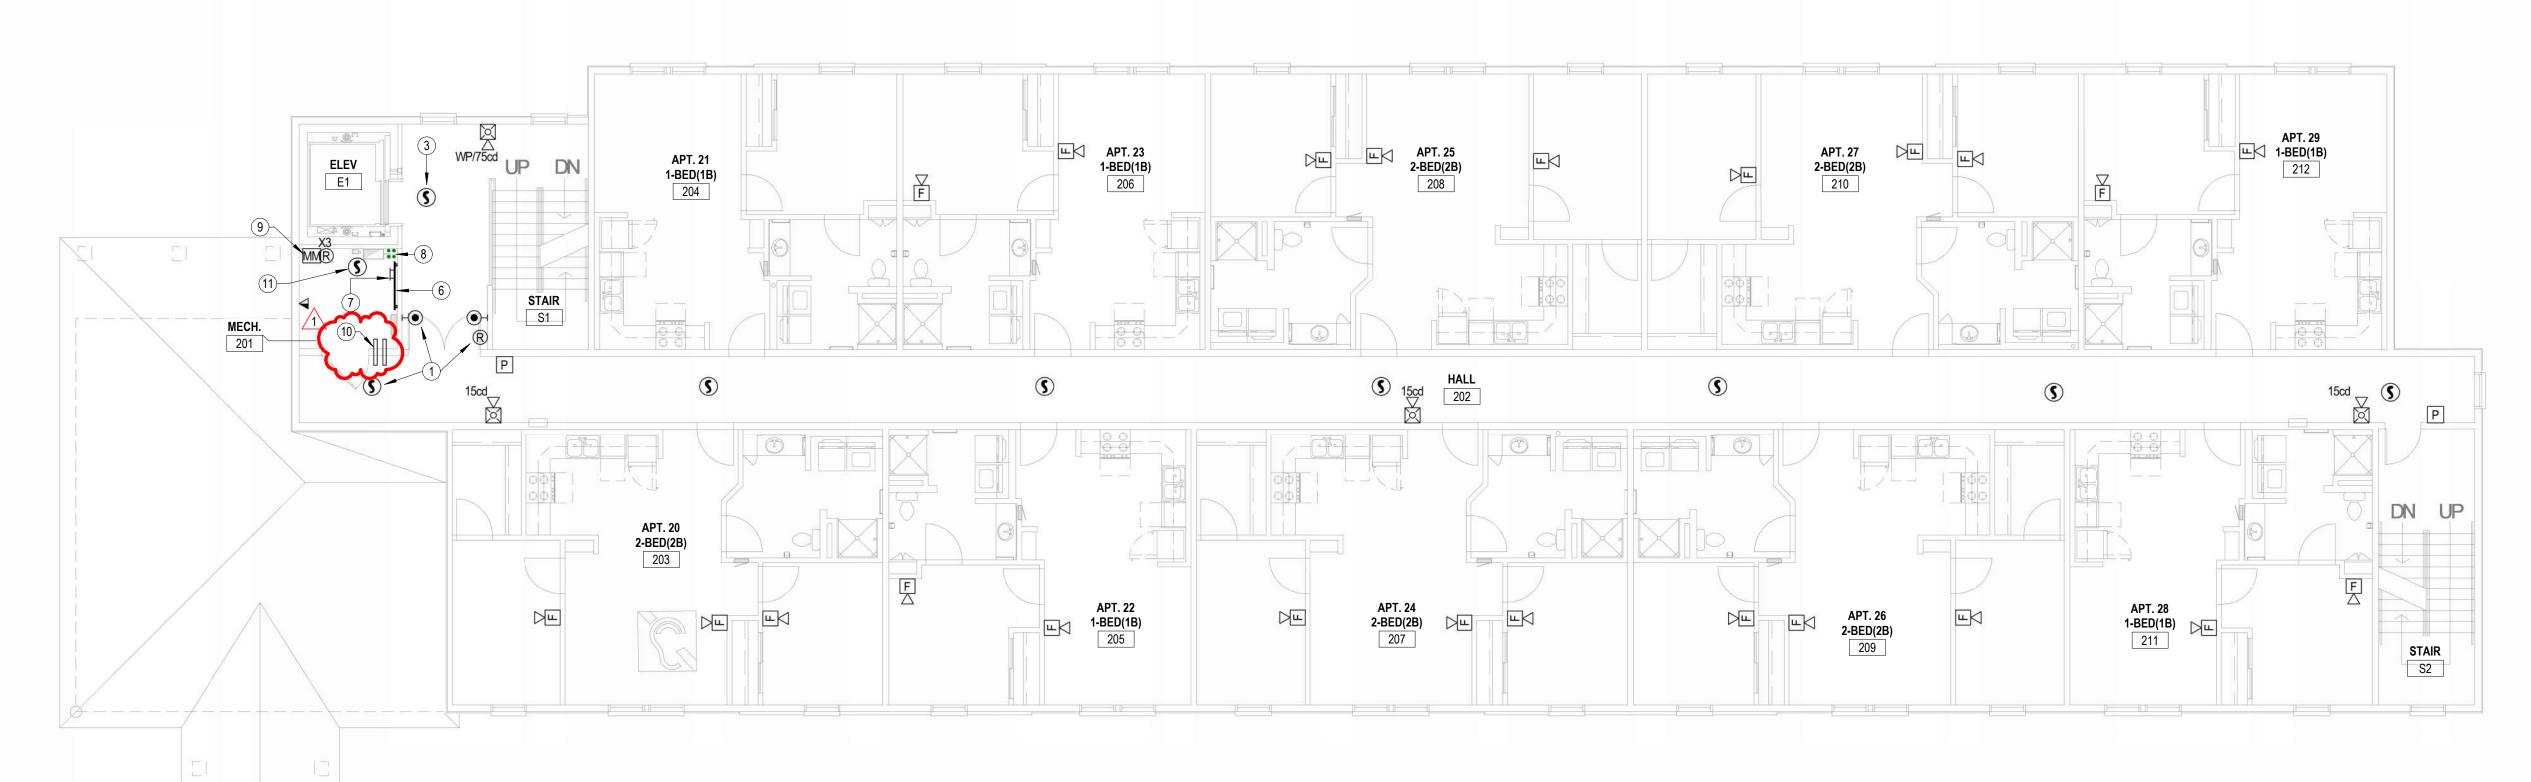

1 SECOND FLOOR SPECIAL SYSTEMS PLAN E1.4 1/8" = 1'-0"

MEADOW

SGIII

**NEW SENIOR LIVING FACILITY** 

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**DATE**: 11/22/2024 **JOB**: 24-3395

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RESIDENCE

DATE: 11/22/2024

24-3395 SHEET NO.:

**E4.1** 

| LST Consulting Engineers, PA MANHATTAN

4809 Vue Du Lac Place, Suite 201

Manhattan, KS 66503

785.587.8042

125 S. Washington, Suite 150


Wichita, KS 67202


316.285.0696 www.LSTengineers.com mail@LSTengineers.com PROJECT SHALL COMPLY WITH ALL REQUIREMENTS OF 2021 IECC -NOTE: OUTLET BOXES ON EXTERIOR WALL SHALL BE AIR-TIGHT **BOXES PER SECTION 402.6** 

# NOTES BY SYMBOL

- PROVIDE NEMA6-20R RECEPTACLE FOR CORD AND PLUG CONNECTION OF PTAC. VERIFY RECEPTACLE CONFIGURATION WITH PTAC SUPPLIED BY MECHANICAL CONTRACTOR. INSTALL RECEPTACLE CONCEALED IN UNIT SUB-BASE.
- PROVIDE RECEPTACLE BELOW COUNTER FOR CORD AND PLUG CONNECTION OF DISHWASHER. PROVIDE CORD AND GROUNDING PLUG AS REQUIRED.
- SWITCHED RECEPTACLE BELOW COUNTER FOR GARBAGE DISPOSAL. COORDINATE EXACT LOCATION OF SWITCH WITH ARCHITECT.
- IN ACCESSIBLE UNITS, INSTALL COUNTERTOP RECEPTACLES A MINIMUM 36" AWAY FROM CORNER PER FAIR HOUSING ACT DESIGN MANUAL CHAPTER 5 'SIDE REACH OVER AN OBSTRUCTION' REQUIREMENTS. WHERE AN OBSTRUCTION PREVENTS 36" DISTANCE REQUIREMENT, INSTALL RECEPTACLE AS FAR FROM CORNER AS POSSIBLE.PROVIDE ADDITIONAL OUTLETS WITHIN 36" OF CORNER TO ENSURE COMPLIANCE WITH NEC PACING REQUIREMENTS.
- PROVIDE 120V CONNECTION TO RANGE HOOD/MICROWAVE. STANDARD AND ADAPTABLE UNITS WILL HAVE MICROWAVE ABOVE RANGE. ACCESSIBLE UNITS WILL HAVE RANGE HOOD. COORDINATE EXACT ELECTRICAL ROUGH-IN REQUIREMENTS WITH EQUIPMENT PROVIDED. IF EQUIPMENT IS CORD AND PLUG, PROVIDE RECEPTACLE INSIDE CABINET ABOVE RANGE.
- PROVIDE SWITCH IN ACCESSIBLE UNITS FOR CONTROL OF RANGE HOOD 7 PROVIDE 30A/2P SNAP SWITCH AND CONNECT WATER HEATER. INSTALL SWITCH ADJACENT TO
- WATER HEATER. 8 CONNECT EXHAUST FAN/LIGHT PROVIDED BY MECHANICAL CONTRACTOR.
- 9 SWITCH CLOSEST TO DOOR SHALL CONTROL ALL LIGHTS IN BATHROOM, AND THE OTHER SWITCH SHALL CONTROL THE EXHAUST FAN.
- 0 PROVIDE TIMER SWITCH EQUAL TO AIR CYCLER 'SMART EXHAUST' FOR CONTROL OF EXHAUST FAN. SET SWITCH PER MANUFACTURER'S INSTRUCTIONS TO OPERATE FAN AS INDICATED
- 1 BEDROOM: 26 MINUTES PER HOUR 2 BEDROOM: 38 MINUTES PER HOUR
- 1 PROVIDE PRESET SLIDE DIMMER COMPATIBLE WITH ASSOCIATED LIGHT FIXTURES.
- 12 COORDINATE FINAL LOCATIONS OF ALL CATV AND PHONE OUTLETS WITH OWNER. TELECOM DISTRIBUTION DEVICE APPROXIMATELY 4'-0" AFF. COORDINATE EXACT
- PECUIREMENTS WITH TILLING PROVINGER SELECTED BY WIMER. 4 PROVIDE PUSH BUTTON AT 48" AFF FOR ANNUNCIATOR SYSTEM AT ALL ACCESSIBLE APARTMENTS AND ALSO AT APARTMENTS DESIGNATED FOR HEARING-IMPAIRED. REFER TO ARCH DRAWINGS FOR APPLICABLE ROOMS. REFER TO DETAIL 4, SHEET E6.1.
- PROVIDE DOOR ANNUNCIATOR SYSTEM A/V HORN/STROBE DEVICE AND LOW VOLTAGE TRANSFORMER AT ALL ACCESSIBLE APARTMENTS AND ALSO AT APARTMENTS DESIGNATED FOR HEARING-IMPAIRED GUESTS. REFER TO ARCH DRAWINGS FOR APPLICABLE ROOMS. INSTALL HORN/STROBE APPLIANCE AT 80" AFF PER ADA. INSTALL TRANSFORMER IN DOUBLE GANG JUNCTION BOX ABOVE HORN/STROBE WITH BLANK COVER LATE AND PROVIDE LOW VOLTAGE CONTROL WIRING. REFER TO DETAIL 4, SHEET E6.1. PROVIDE ENGRAVED SIGN AT




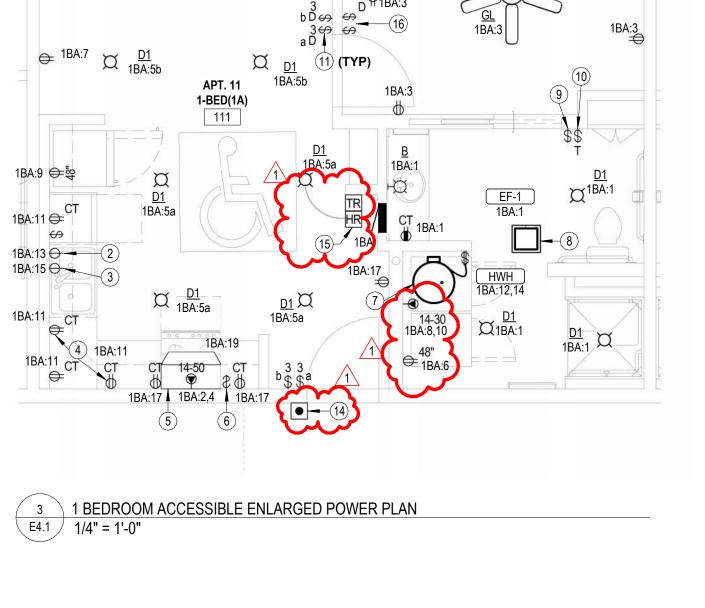

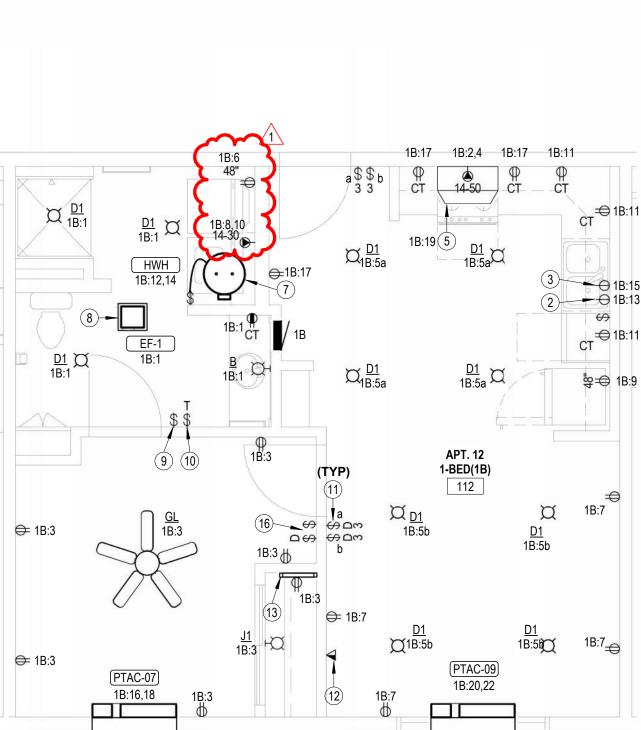



1 BEDROOM ENLARGED POWER PLAN
1/4" = 1'-0"


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2BA:11 \ 2BA:13

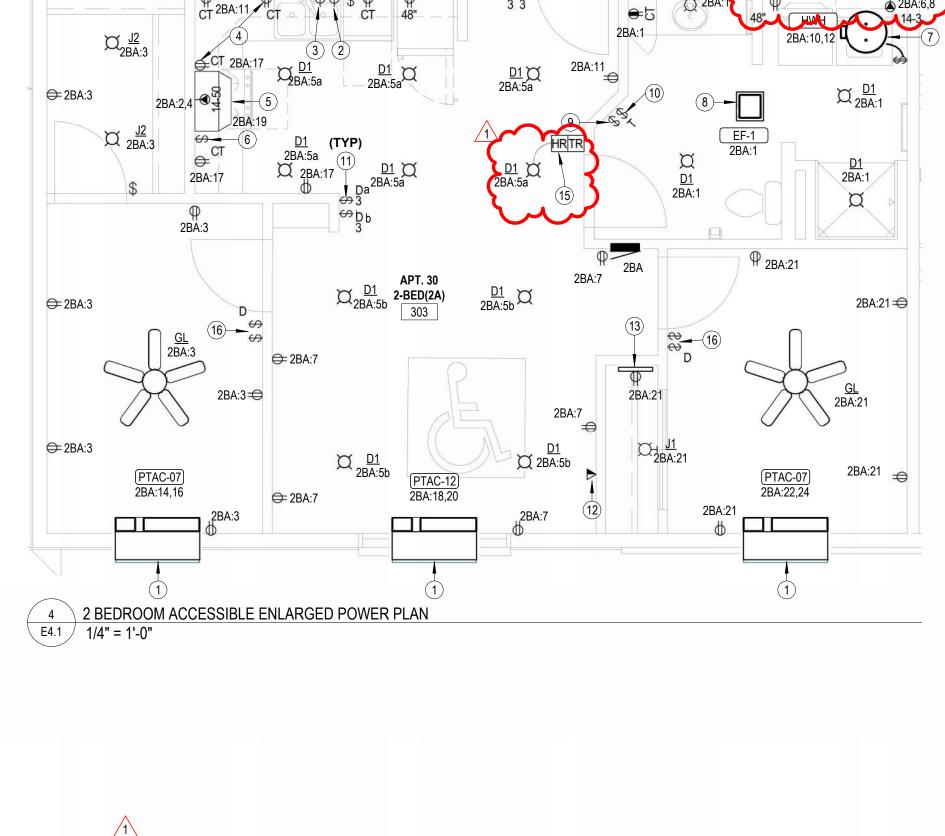



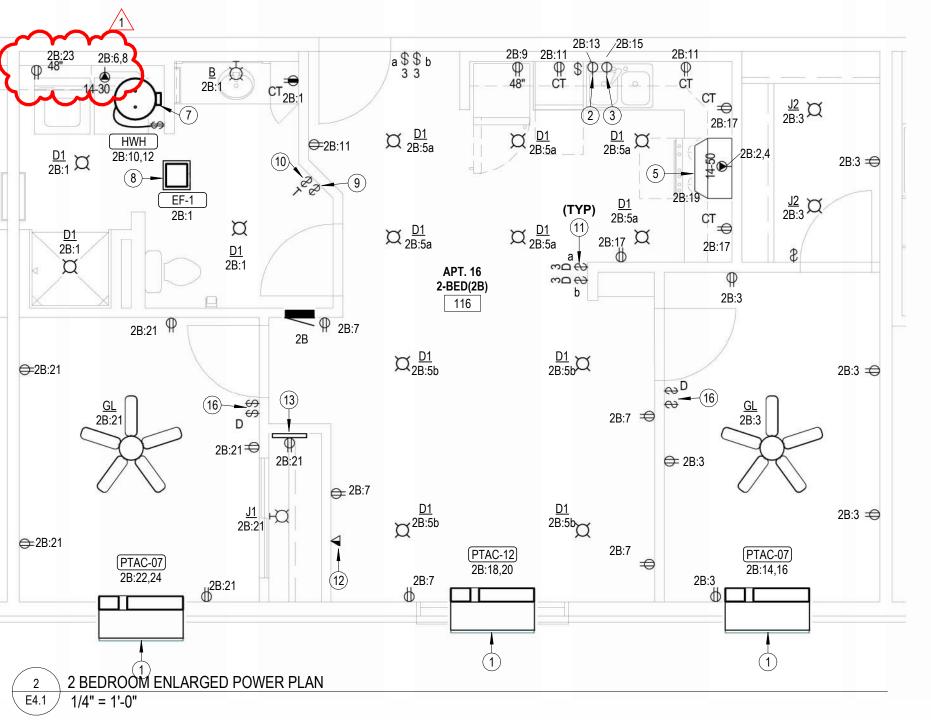


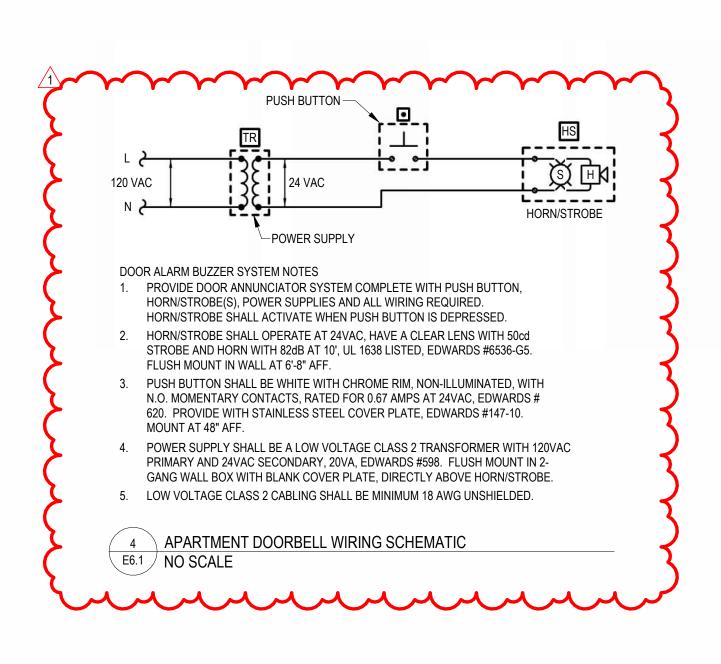

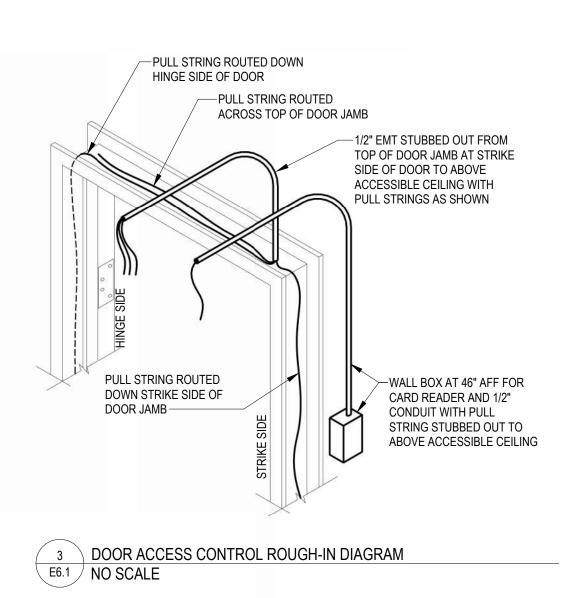
| ID | Manufacturer | Model Number                                     | CCT    | Lumens  | Watts | Mounting             | Finish | Driver     | Description  | Notes  |
|----|--------------|--|--------|---------|-------|----------------------|--------|------------|--|--------|
| Α  | LITHONIA     | FMFL-30840-CAML-WH                               | 3000 K | 2800 lm | 35 W  | SURFACE              | WHITE  | STANDARD   | LED DECORATIVE SURFACE   |        |
| В  | SEAGULL      | FML-WL-48-35                                     | 3000 K |         | 29 W  | SURFACE WALL         | WHITE  | STANDARD   | 3 LAMP VANITY LIGHT  |        |
| С  | LITHONIA     | FMML-13-830-DDBT                                 | 3000 K | 1900 lm | 28 W  | CEILING SURFACE      | WHITE  | STANDARD   | 13" ROUND LED SURFACE MOUNT  |        |
| D1 | HALO         | SDMR-6-930-WH                                    | 3000 K | 600 lm  | 10 W  | CEILING SURFACE      | WHITE  | STANDARD   | 6" ROUND SURFACE MOUNTED DOWNLIGHT   | 6      |
| D2 | HALO         | SDMR-12-930-WH                                   | 3000 K | 1200 lm | 16 W  | CEILING SURFACE      | WHITE  | STANDARD   | 6" ROUND SURFACE MOUNTED DOWNLIGHT   |        |
| E1 | LITHONIA     | ELM6L UVOLT LTP                                  |        |         | 3 W   | SURFACE WALL         | WHITE  |            | LED DUAL-HEAD EMERGENCY LIGHT  | 1      |
| E2 | LITHONIA     | AFB-OEL-DDBTXD-UVOLT-N-WT                        |        |         | 3 W   | SURFACE WALL         | BRONZE |            | DIE-CAST ALUMINUM EMERGENCY LIGHT WITH POLYCARBONATE LENS, INTEGRAL BATTERY                              | 1,2,3  |
| F  | LITHONIA     | CSS-L48-4000LM-MVLOT-40K-80CRI                   | 3000 K | 4298 lm | 34 W  | SURFACE              | WHITE  | STANDARD   | 4' LENSED LED STRIP LIGHT  |        |
| G  | SEAGULL      | 15030EN-829                                      |        |         | 20 W  | CEILING<br>SUSPENDED | BRONZE | STANDARD   | 52" DIAMETER CEILING FAN WITHOUT LED LIGHT KIT   |        |
| GL | SEAGULL      | 15030EN-829                                      | 3000 K |         | 20 W  | CEILING<br>SUSPENDED | BRONZE | STANDARD   | 52" DIAMETER CEILING FAN WITH LED LIGHT KIT  |        |
| Н  | LIGHTOLIER   | P6RDL15940MCL-Z10U                               | 4000 K | 1500 lm | 12 W  | CEILING SURFACE      | WHITE  | STANDARD   | 6" ROUND SURFACE MOUNTED DOWNLIGHT   | 4      |
| J1 | HALO         | SDMR-6-930-WH                                    | 3000 K | 600 lm  | 10 W  | SURFACE WALL         | WHITE  | STANDARD   | 6" ROUND SURFACE MOUNTED DOWNLIGHT   | 5      |
| J2 | HALO         | SDMR-6-930-WH                                    | 3000 K | 600 lm  | 10 W  | CEILING SURFACE      | WHITE  | STANDARD   | 6" ROUND SURFACE MOUNTED DOWNLIGHT   | 5      |
| L  | LITHOINA     | WL4-40L-EZ1-LP830-MSD7-DIM50-E10<br>WLCP         | 3000 K | 3927 lm | 40 W  | SURFACE WALL         | WHITE  | STANDARD   | 4 FT. WALL MOUNTED STAIRWELL LIGHT WITH EMERGENCY BATTERY BACKUP   | 9      |
| R1 | LITHONIA     | DSX0-LED-P3-40K-T2M-MVOLT-HS                     | 4000 K | 8565 lm | 69 W  | ROUND POLE           | BLACK  | LED DRIVER | LED AREA LIGHT, SINGLE HEAD FULL CUT-OFF WITH IES TYPE II DISTRIBUTION AND HOUSE SIDE SHEILD             | 3,7,8  |
| R2 | LITHONIA     | DSX0-LED-P3-40K-RCCO-MVOLT                       | 4000 K | 6194 lm | 69 W  | ROUND POLE           | BLACK  | LED DRIVER | LED AREA LIGHT, SINGLE HEAD FULL CUT-OFF WITH RIGHT SIDE CUT OFF DISTRIBUTION.                           | 3,7,8  |
| R3 | LITHONIA     | DSX0-LED-P3-40K-LCCO-MVOLT                       | 4000 K | 6194 lm | 69 W  | ROUND POLE           | BLACK  | LED DRIVER | LED AREA LIGHT, SINGLE HEAD FULL CUT-OFF WITH LEFT SIDE CUT OFF DISTRIBUTION.                            | 3,7,8  |
| R4 | LITHONIA     | DSX0-LED-P1-40K-T2M-MVOLT-HS                     | 4000 K | 4735 lm | 33 W  | ROUND POLE           | BLACK  | LED DRIVER | LED AREA LIGHT, SINGLE HEAD FULL CUT-OFF WITH IES TYPE II DISTRIBUTION AND HOUSE SIDE SHEILD             | 3,8,11 |
| S  | ACCLAIM      | DFB-111-AKEU                                     | 4000 K | 2455 lm | 50 W  | GRADE                | BLACK  | STANDARD   | IP-66 RATED, GRADE MOUNTED LED FLOOR LIGHT   |        |
| T  | LITHOINA     | FEM-L48-4000LM-IMAFL-WD-MVOLT-G<br>Z10-35K-80CRI | 3000 K | 3615 lm | 24 W  | SURFACE WALL         | WHITE  | STANDARD   | 4 FT. FULLY ENCLOSED AND GASKETED INDUSTRIAL FIXTURE WITH FROSTED, RIBBED, IMPACT-RESISTANT ACRYLIC LENS |        |
| W1 | LITHOINA     | MRE-LED-P1-40K-SR3-MVOLT                         | 4000 K | 4667 lm | 20 W  | SURFACE WALL         | BLACK  | STANDARD   | EXTERIOR LED WALL PACK WITH IES TYPE III DISTRIBUTION  | 3      |
| W2 | LITHONIA     | MRE-LED-P3-40K-SR4-MVOLT                         | 4000 K | 4667 lm | 40 W  | SURFACE WALL         | BLACK  | STANDARD   | EXTERIOR LED WALL PACK WITH IES TYPE IV DISTRIBUTION   | 3      |
| X1 | LITHONIA     | EDGR 1 R EL                                      |        |         | 5 W   | CEILING              | WHITE  |            | SINGLE FACE LED EXIT SIGN  | 1,2    |
| X2 | LITHONIA     | EDGR 2 R EL                                      |        |         | 5 W   | CEILING              | WHITE  |            | DOUBLE FACED LED EXIT SIGN   | 1,2    |
| Х3 | LITHONIA     | EDG 1 R EL WM                                    |        |         | 5 W   | WALL                 | WHITE  |            | SINGLE FACE LED EXIT SIGN  | 1,2    |
| XE | LITHONIA     | LHQM LED R HO                                    |        |         | 4 W   | WALL                 | WHITE  |            | COMBO EXIT/EMERGENCY LIGHTING UNIT   | 1,2    |

- ALL LED FIXTURES SHALL ADHERE TO LM79 AND LM80 STANDARDS
- PROVIDE MANUFACTURER'S FLANGE KIT WHERE LAY-IN FIXTURES ARE TO BE INSTALLED IN GYP. ALL APARTMENT LIGHT FIXTURES SHALL BE ENERGY STAR CERTIFIED

- PROVIDE FIXTURE WITH EMERGENCY BATTERY INTEGRAL CHARGER WITH SELF-DIAGNOSTIC/SELF-TESTING ELECTRONICS.
- FIXTURE SHALL BE CAPABLE OF WALL OR CEILING MOUNT APPLICATIONS AND SHALL HAVE BREAK-OUT DIRECTIONAL CHEVRONS.
- U.L. LISTED FOR 'WET LOCATION'. 4. U.L LISTED FOR 'DAMP LOCATION'.
- 5. FIXTURE TO COMPLY WITH NEC 410.16(C)(5).
- WHERE INSTALLED IN BATHROOMS TO BE 'DAMP LOCATION' U.L. LISTED, WHERE ABOVE SHOWERS TO BE 'WET LOCATION' U.L. LISTED.
- PROVIDE FIXTURE/POLE ASSEMBLY WITH 20' ROUND STRAIGHT STEEL POLE, BLACK TO MATCH FIXTURE. FIXTURE HEIGHT SHALL NOT EXCEED ?'-0".
- FIXTURE/POLE ASSEMBLY SHALL BE RATED FOR 100 MPH WIND LOADS. PROVIDE WITH VIBRATION DAMPER PER MANUFACTURER'S RECOMMENDATIONS.
- PROVIDE FIXTURE WITH INTEGRAL OCCUPANCY SENSOR AND CONTROLS TO DIM FIXTURE TO 50% LIGHT OUTPUT WITH UNOCCUPIED. 10. WHERE INSTALLED IN FIRE RATED ASSEMBLY, PROVIDE FIRE RATED RECSSED LIGHT COVER EQUAL TO TENMAT FF109. VERIFY RATING REQUIREMENTS WITH ARCHITECT. 11. PROVIDE FIXTURE/POLE ASSEMBLY WITH 10' ROUND STRAIGHT STEEL POLE, BLACK TO MATCH FIXTURE. FIXTURE HEIGHT SHALL NOT EXCEED ?'-0".

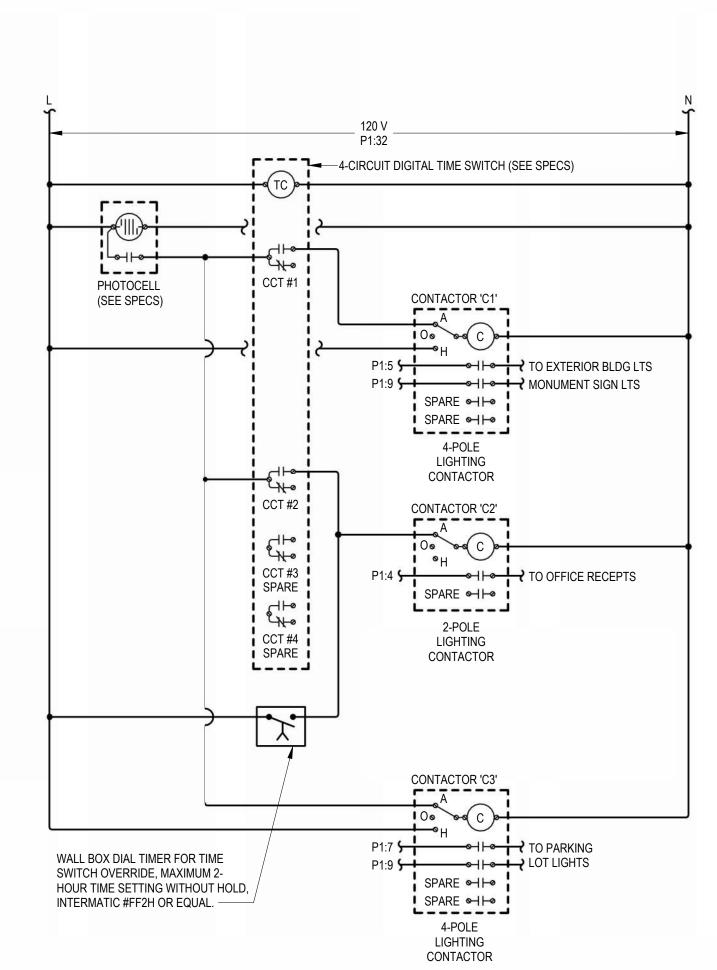



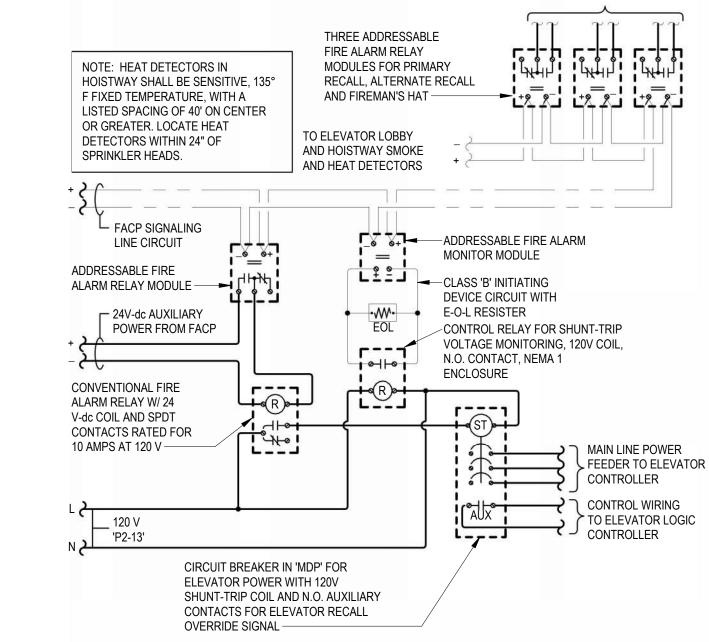

## ELEVATOR RECALL AND SHUT-DOWN SEQUENCE OF OPERATION:

- 1. UPON SENSING SMOKE FROM ONE OR MORE ELEVATOR LOBBY OR HOISTWAY, THE SMOKE DETECTOR SHALL SIGNAL THE FIRE ALARM CONTROL PANEL, WHICH WILL FORWARD THE SIGNAL TO THE ELEVATOR LOGIC CONTROLLER VIA ADDRESSABLE RELAY MODULES TO RECALL ELEVATOR CAB TO THE PRIMARY RECALL FLOOR. IF PRIMARY RECALL FLOOR'S LOBBY SMOKE DETECTOR SENSES SMOKE AT THAT FLOOR, THE ELEVATOR CONTROLLER WILL SEND THE ELEVATOR CAB TO THE NEXT FLOOR CLEAR OF SMOKE. ONCE THE ELEVATOR CAB HAS REACHED THE DESIGNATED FLOOR. THE ELEVATOR CAB DOORS WILL OPEN AND THE CONTROLLER WILL LOCK THE ELEVATOR CAB AT THAT FLOOR, DISABLING THE ELEVATOR CAB CONTROLS, UNLESS A FIREMAN'S KEY IS USED TO OVERRIDE AUTOMATIC CONTROLS.
- 2. ALL SMOKE DETECTORS ASSOCIATED WITH ELEVATOR RECALL (LOBBY AND HOISTWAY) SHALL TRANSMIT A SEPARATE AND DISTINCT VISIBLE ANNUNCIATION AT THE FIRE ALARM CONTROL PANEL.
- 3. UPON SENSING A HEAT ALARM CONDITION IN THE ELEVATOR HOISTWAY, THE HEAT DETECTOR SHALL SIGNAL THE FIRE ALARM CONTROL PANEL. WHICH WILL FORWARD THE SIGNAL TO THE ADDRESSABLE RELAY MODULE TO ACTIVATE (VIA A CONVENTIONAL FIRE ALARM RELAY) THE SHUNT-TRIP BREAKER POWERING THE ELEVATOR SO AS TO DISCONNECT POWER TO THAT CIRCUIT. THIS IS TO BE A NON-AUTO RESET SWITCH. WHEN THE SPRINKLER HEAD HAS REACHED ITS CRITICAL TEMPERATURE OF 165° F., THE HEAD WILL BEGIN DISCHARGE OF

ELEVATOR RECALL AND SHUT-DOWN WIRING DIAGRAM E6.1 NO SCALE

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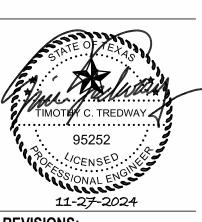
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CONTROL WIRING

TO ELEVATOR LOGIC CONTROLLER

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Addendum #1 2024-11-27

DATE: 11/22/2024

24-3395 **SHEET NO.:** 

## NOTES BY SYMBOL

- MOUNT HEAT PUMP ON LEVEL 3-1/2" THICK CONCRETE PAD. COORDINATE WITH G.C. PROVIDE UL LISTED DRYER BOX EQUAL TO IN-O-VATE TECHNOLOGIES IN WALL INSTALLED IN ACCORDANCE WITH MANUFACTURER'S RECOMMENDATIONS, AND ROUTE 4"Ø DRYER EXHAUST DUCT TO WALL CAP WITH BACKDRAFT DAMPER. MAXIMUM ALLOWABLE EQUIVALENT DUCT LENGTH = 35'. UTILIZE LONG RADIUS SMOOTH ELBOWS WHERE REQUIRED. MAXIMUM EQUIVALENT DUCT LENGTH MAY BE INCREASE WHERE DRYER MANUFACTURER'S INSTALLATION INSTRUCTIONS ALLOW, AND DOCUMENTATION IS PROVIDED TO CODE OFFICIAL PRIOR TO CONCEALMENT INSPECTION. COORDINATE EXACT REQUIREMENTS WITH EQUIPMENT PROVIDED. PROVIDE PERMANENT LABEL IDENTIFYING EQUIVALENT LENGTH OF DRYER DUCT INSTALLED PER IMC 504. NOTE: ANNULAR SPACE AROUND DUCT IS TO BE SEALED AT ALL PENETRATIONS OF FLOORS AND CEILINGS WITH U.L. LISTED FIRE STOPPING SYSTEM. ROUTE 6" DIAMETER OUTDOOR AIR DUCT TO SOFFIT VENT WITH BIRDSCREEN, AND BALANCE
  - OUTDOOR AIR TO 85 CFM.
- PROVIDE WALL MOUNTED THERMOSTAT FOR EACH PTAC IN APARTMENTS. COORDINATE FINAL LOCATION WITH OWNER.
- ROUTE 4"Ø EXHAUST DUCT TO MANUFACTURER'S ROOF JACK WITH BACKDRAFT DAMPER AND BIRD SCREEN, COORDINATE ROUTING WITH STRUCTURE.
- ROUTE 4"Ø EXHAUST DUCT TO MANUFACTURER'S WALL CAP WITH BACKDRAFT DAMPER, COORDINATE ROUTING WITH STRUCTURE.
- ROUTE REFIRIGERANT PIPING FROM BLOWER COIL TO HEAT PUMP. CONCEAL PIPING IN WALLS AND ABOVE CEILINGS. UTILIZE WALL PENETRATION ASSEMBLE EQUAL TO AIREX TITAN OUTLET.

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1 Addendum #1 2024-11-27


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SHEET NO.:

M1.1

PTAC-09 PTAC-07




1 FIRST FLOOR HVAC PLAN
M1.1 1/8" = 1'-0"

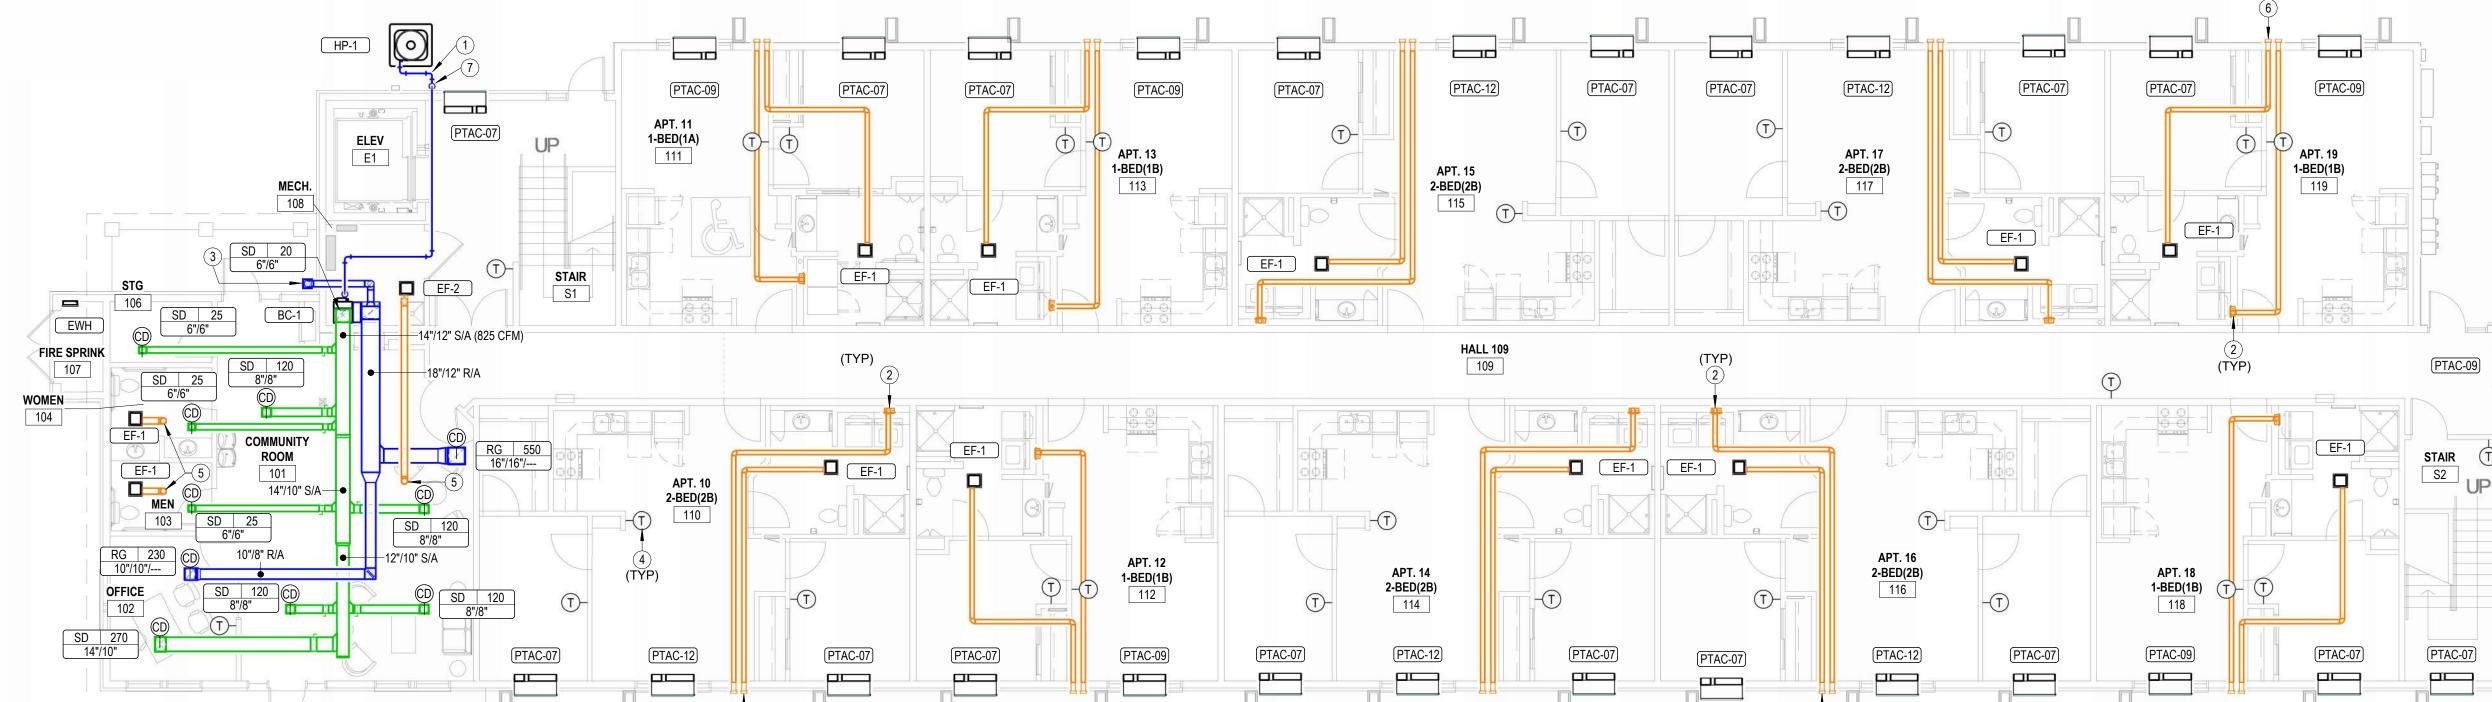LOCATION WITH OWNER.


COORDINATE ROUTING WITH STRUCTURE. PROVIDE UL LISTED DRYER BOX EQUAL TO IN-O-VATE TECHNOLOGIES IN WALL INSTALLED IN ACCORDANCE WITH MANUFACTURER'S RECOMMENDATIONS, AND ROUTE 4"Ø DRYER EXHAUST DUCT TO WALL CAP WITH BACKDRAFT DAMPER. MAXIMUM ALLOWABLE EQUIVALENT DUCT LENGTH = 35'. UTILIZE LONG RADIUS SMOOTH ELBOWS WHERE REQUIRED. MAXIMUM EQUIVALENT DUCT LENGTH MAY BE INCREASE WHERE DRYER MANUFACTURER'S

INSTALLATION INSTRUCTIONS ALLOW, AND DOCUMENTATION IS PROVIDED TO CODE OFFICIAL PRIOR TO CONCEALMENT INSPECTION. COORDINATE EXACT REQUIREMENTS WITH EQUIPMENT PROVIDED. PROVIDE PERMANENT LABEL IDENTIFYING EQUIVALENT LENGTH OF DRYER DUCT INSTALLED PER IMC 504. NOTE: ANNULAR SPACE AROUND DUCT IS TO BE SEALED AT ALL PENETRATIONS OF FLOORS AND CEILINGS WITH U.L. LISTED FIRE STOPPING SYSTEM.

PROVIDE WALL MOUNTED THERMOSTAT FOR EACH PTAC IN APARTMENTS. COORDINATE FINAL

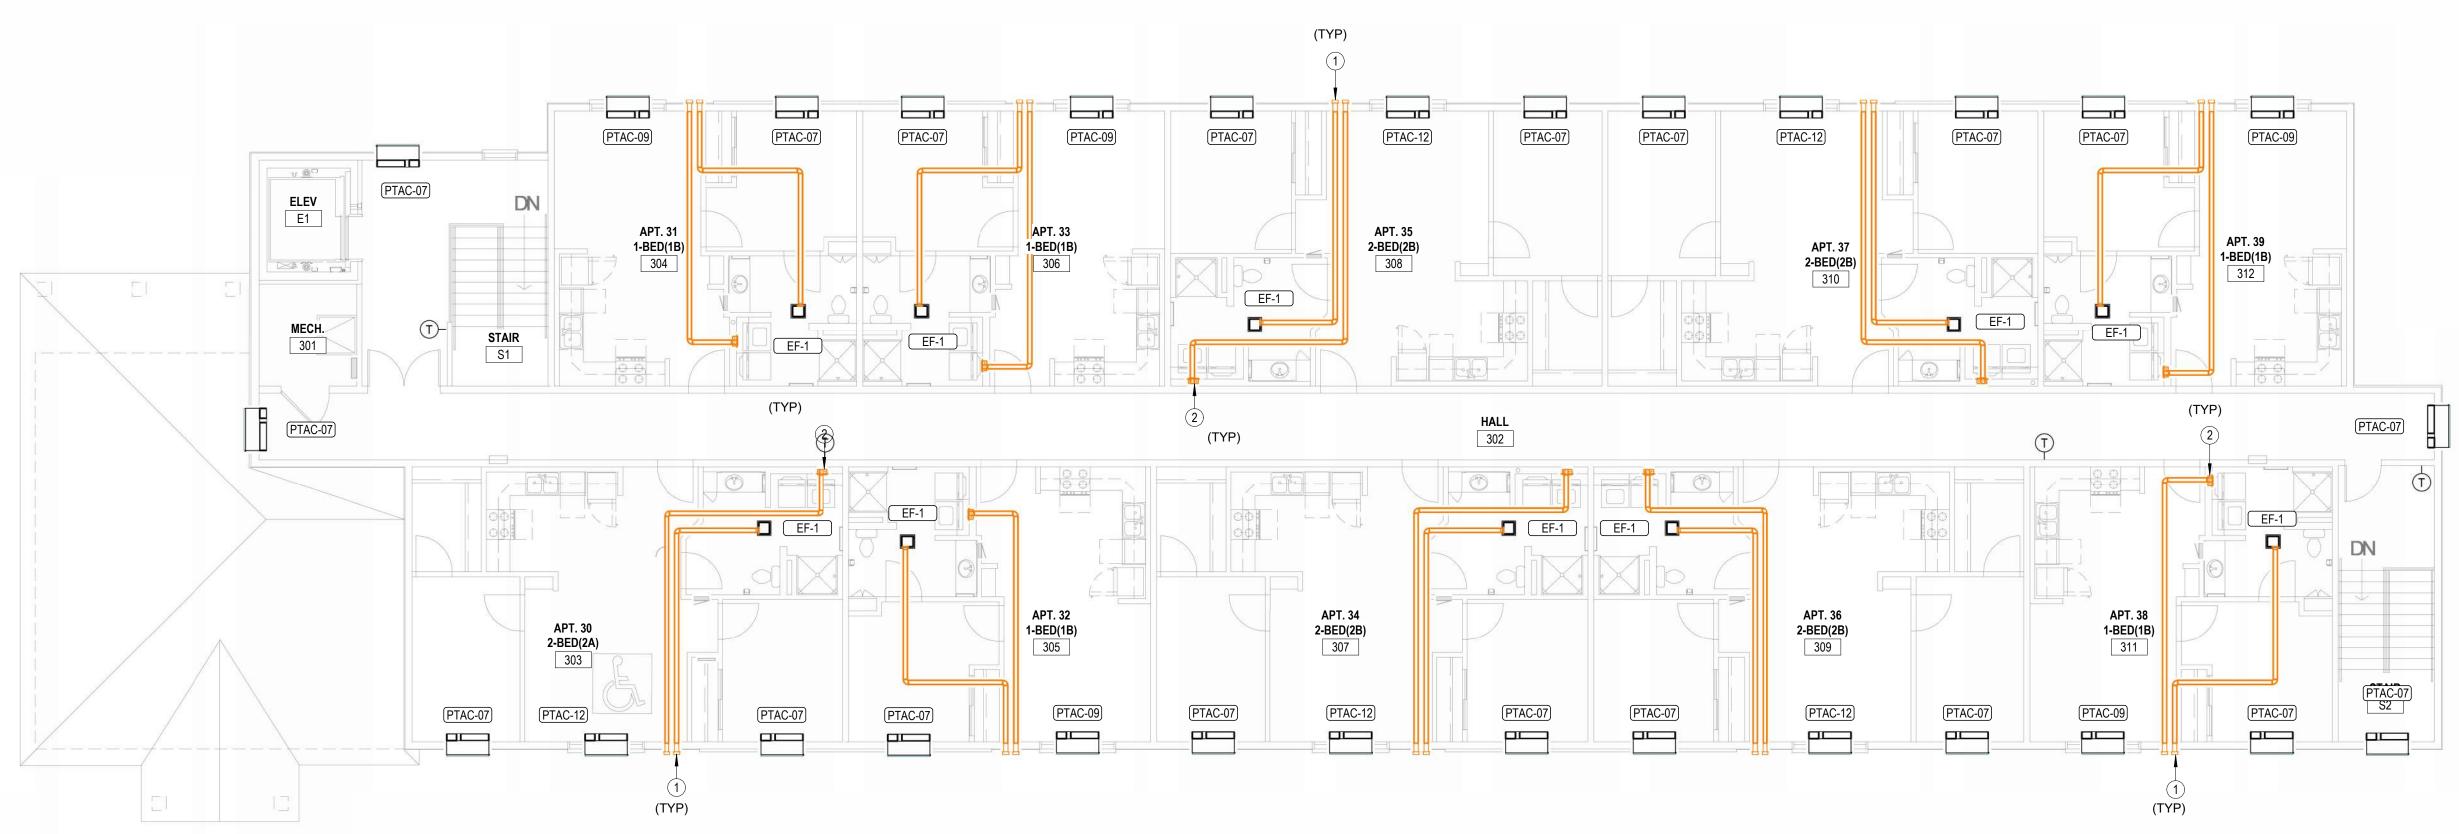

2 THIRD FLOOR HVAC PLAN
1/8" = 1'-0"

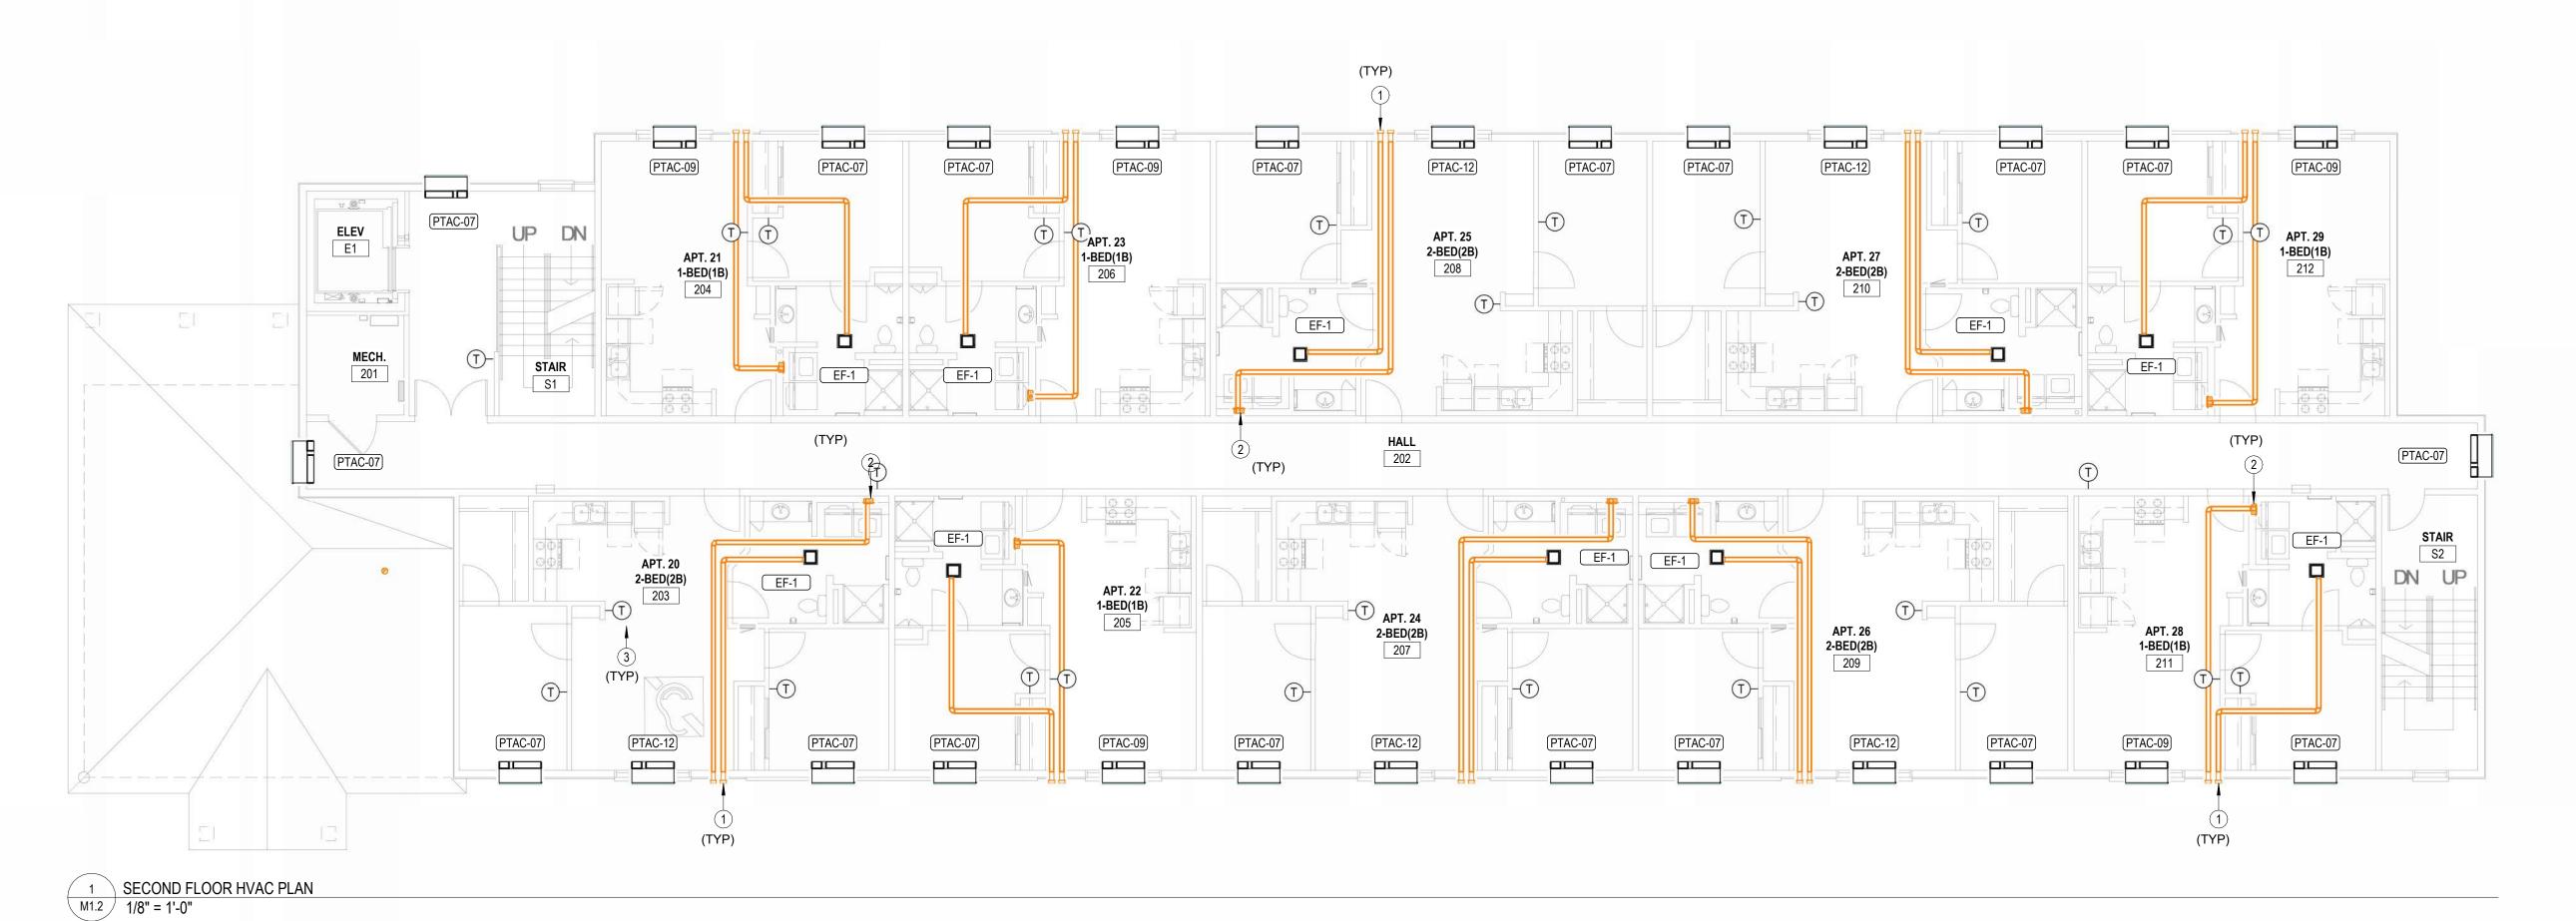

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1 Addendum #1 2024-11-27

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24-3395 SHEET NO.:

M1.2


-NOTE: DOMESTIC HOT WATER PIPING INSULATION SHALL BE

# NOTES BY SYMBOL

ELECTRICAL EQUIPMENT SHOWN FOR COORDINATION. DO NOT ROUTE PIPING ABOVE OR BELOW EQUIPMENT, AND MAINTAIN WORKING CLEARANCE SHOWN.

MINIMUM R-3.

- FIRE PROTECTION SERVICE ENTRANCE. INSTALL IN ACCORDANCE WITH NFPA 13. COORDINATE LOCATION OF ALL VALVES AND APPURTENANCES WITH AHJ. SEE 1:P6.1 FOR MORE INFORMATION.
- PROVIDE SHUT-OFF VALVE AT WATER SERVICE ENTRANCE WITH PRESSURE REDUCING VALVE SET TO 80 PSI IF REQUIRED. COORDINATE REQUIREMENTS WITH CITY OF SAN ANGELO.
- HOT WATER RECIRC LOOP SHALL DROP IN WALL TO LIMIT HOT WATER BRANCH TO PUBLIC LAVATORY TO 2 FT MAX.
- ROUTE DOMESTIC WATER PIPING IN SOFFIT, COORDINATE EXACT REQUIREMENTS
- SEE ENLARGED DOMESTIC WATER PLANS FOR CONTINUATION.

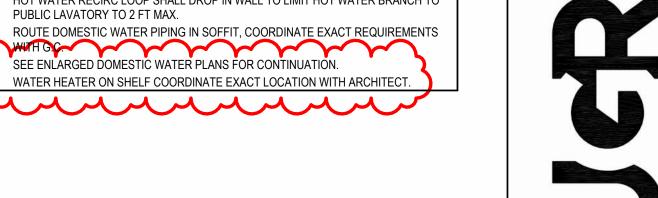

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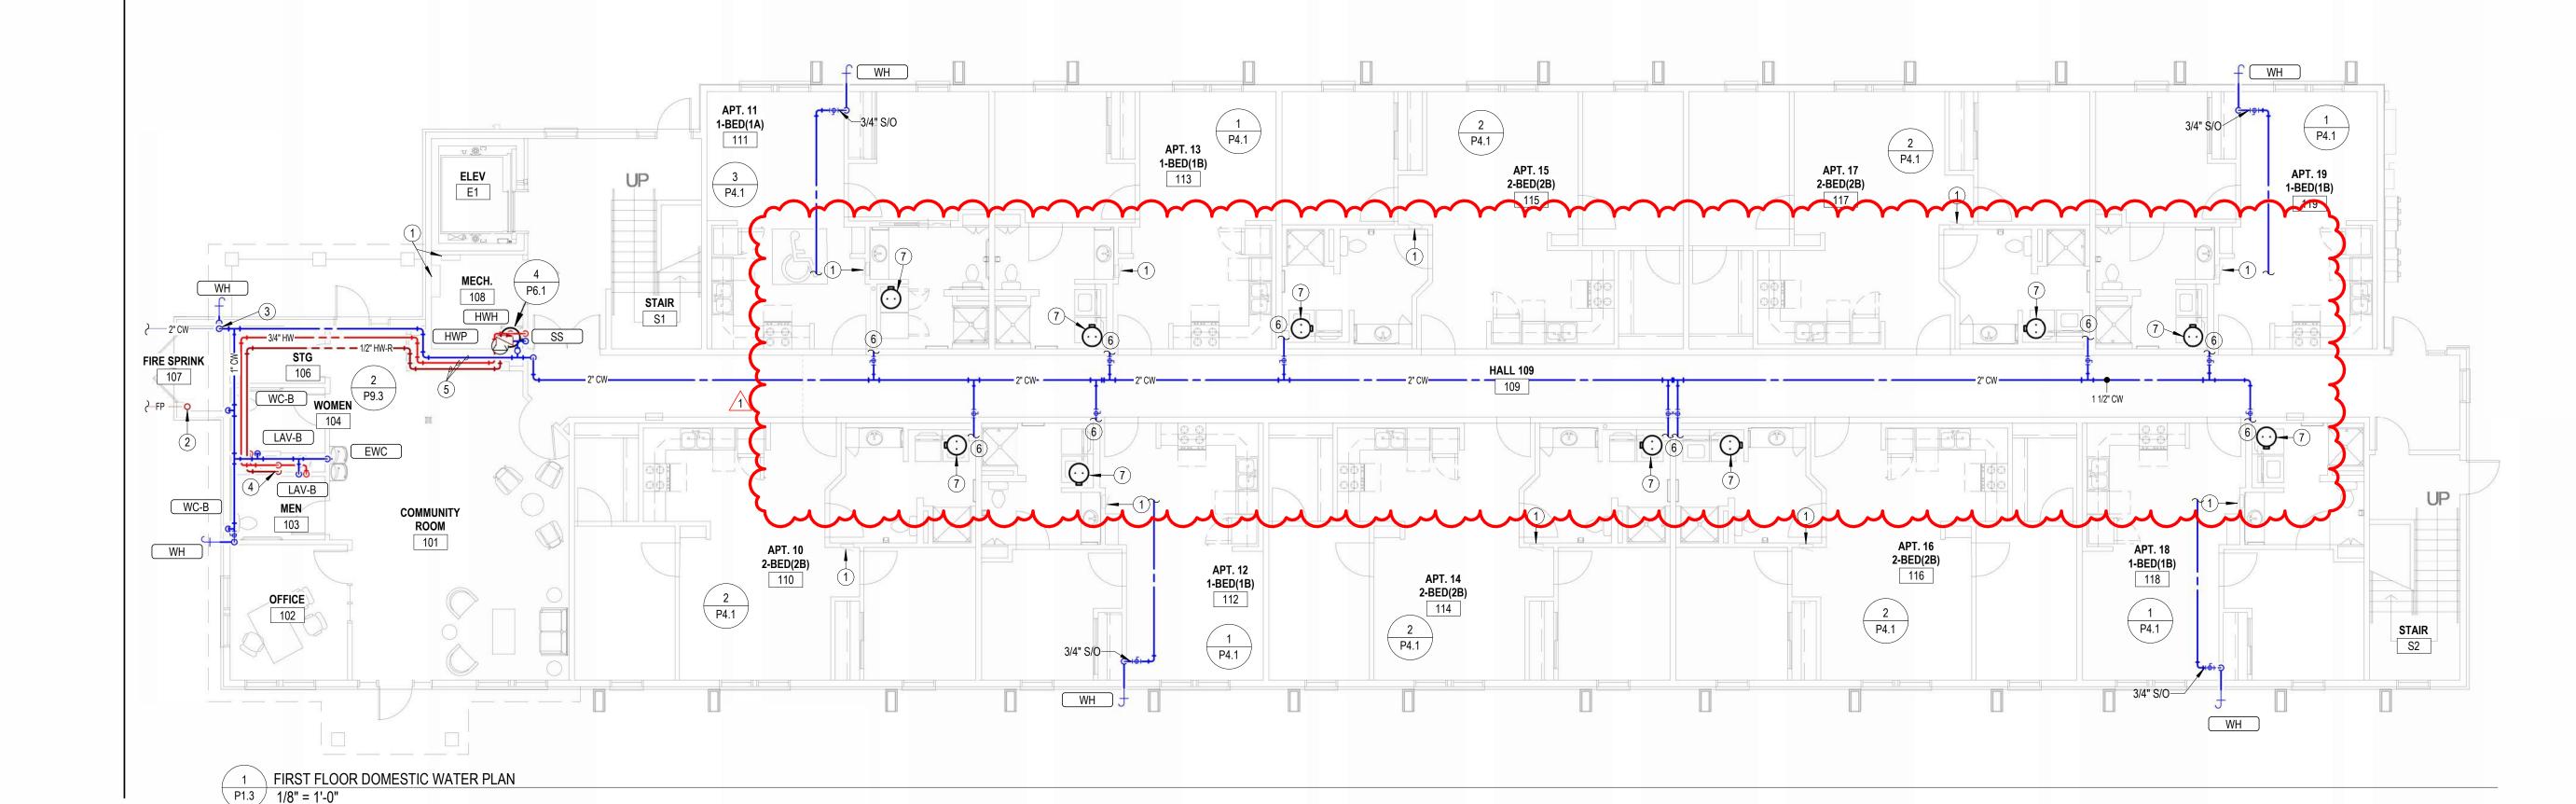
SAN ANGELO,

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11-27-2024 REVISIONS: 1 Addendum #1 2024-11-27

DATE: 11/22/2024 24-3395


P1.3




# NOTES BY SYMBOL

ELECTRICAL EQUIPMENT SHOWN FOR COORDINATION. DO NOT ROUTE PIPING ABOVE OR BELOW EQUIPMENT, AND MAINTAIN WORKING CLEARANCE SHOWN.
 PROVIDE 1" WATER SERVICE TO APARTMENT WITH SHUT-OFF VALVE. SEE TYPICAL APARTMENT RISER DIAGRAM ON SHEET P9.2 FOR ADDITIONAL INFORMATION.
 SEE ENLARGED DOMESTIC WATER PLANS FOR CONTINUATION.

4 WATER HEATER ON SHELF COORDINATE EXACT LOCATION WITH ARCHITECT

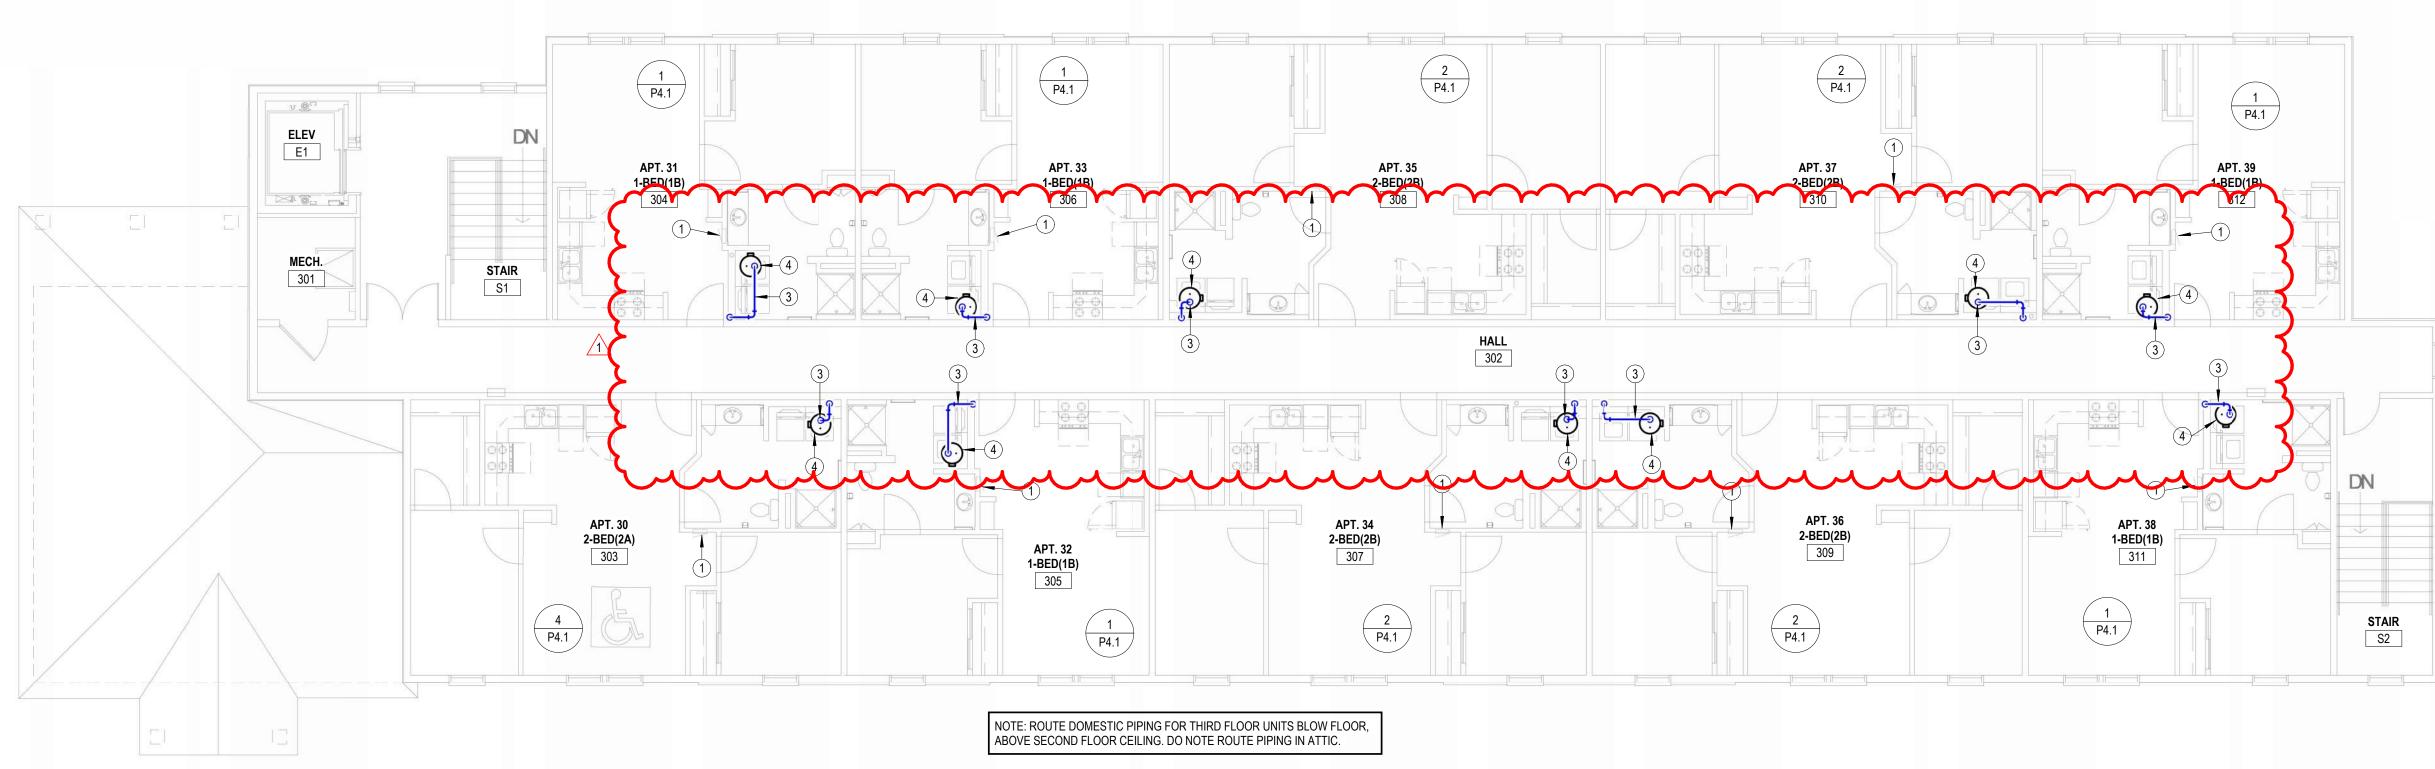

2 THIRD FLOOR DOMESTIC WATER PLAN
P1.4 1/8" = 1'-0"

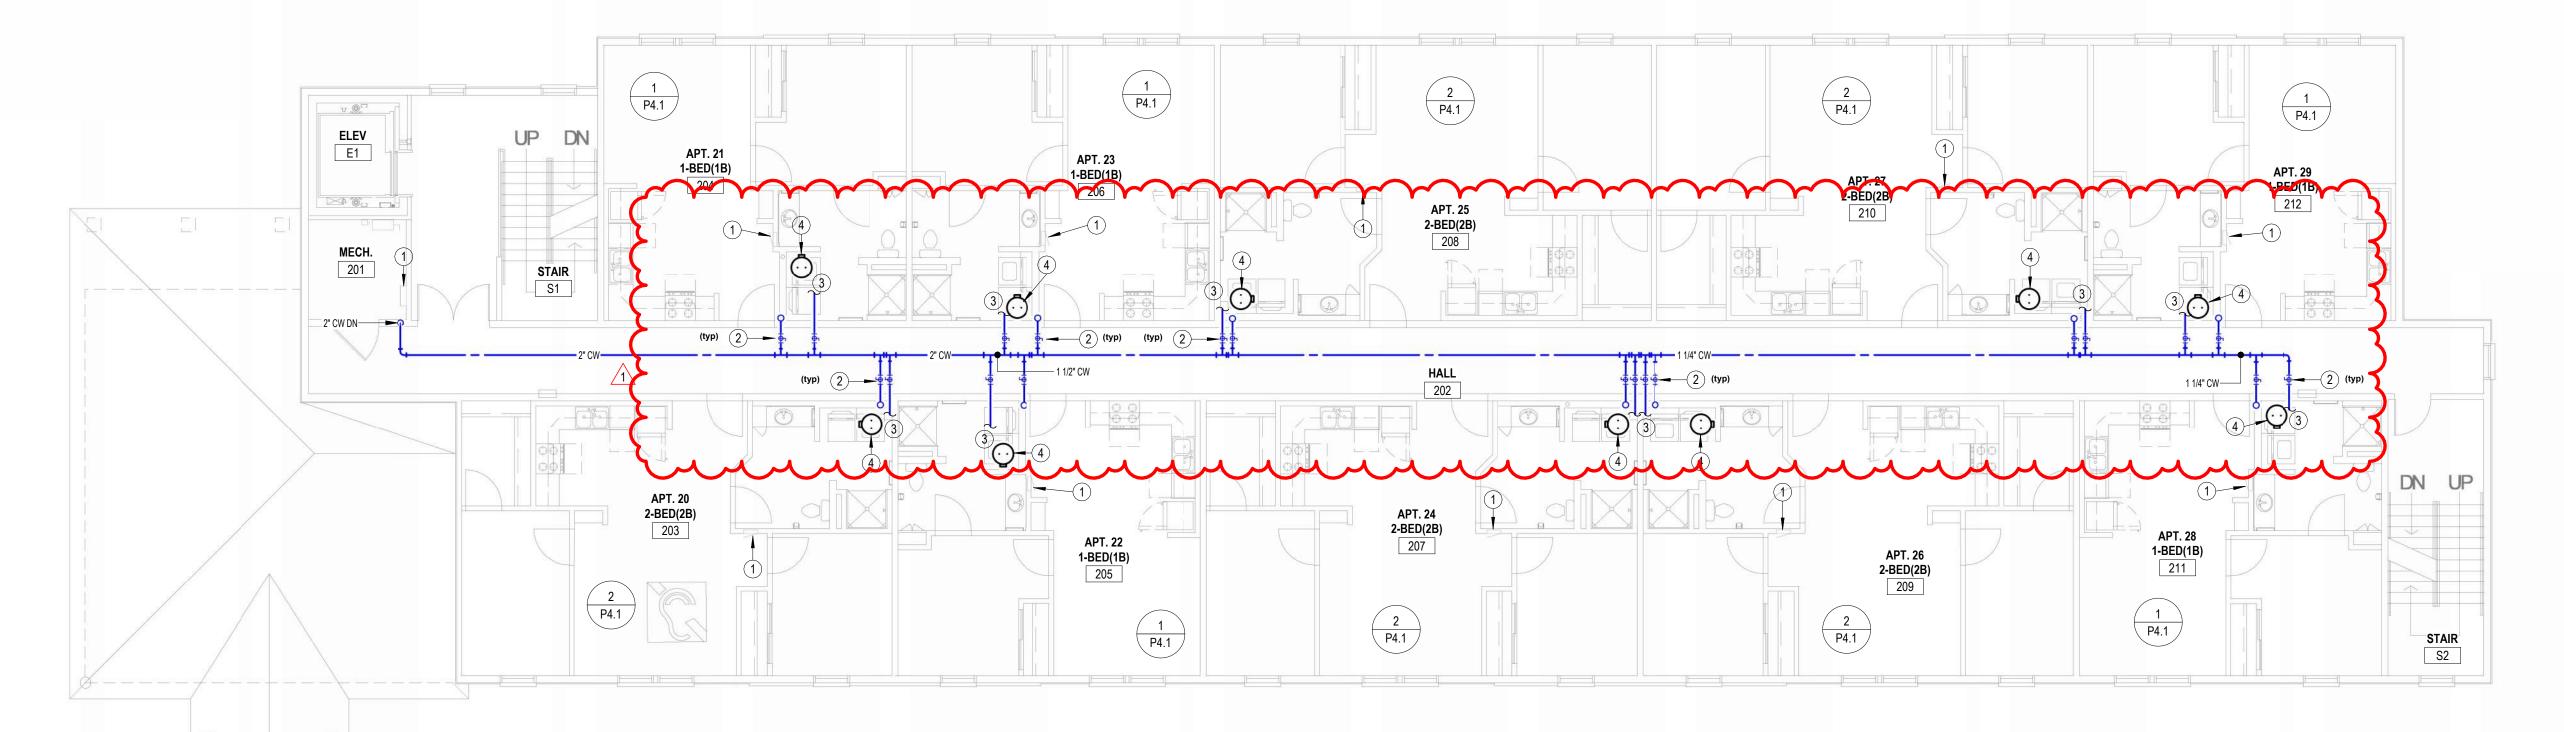

1 SECOND FLOOR DOMESTIC WATER PLAN
P1.4 1/8" = 1'-0"

JonesGillamRenz

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Ilina, KS 67401 Kansas City, MO 641C

S5.827.0386 jgr@jgrarchitects.com

MEADOW

REEN

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AT

RESIDENCE

**NEW SENIOR LIVING FACILITY** 

SAN ANGELO,

TIMOTHY C. TREDWAY

95252

O. C. CENSE

11-27-2024

11-27 REVISIONS:

REVISIONS:

1 Addendum #1 2024-11-27


DATE: 11/22/2024 JOB: 24-3395

JOB: SHEET NO.:


P1.4

# NOTES BY SYMBOL

- ELECTRICAL EQUIPMENT SHOWN FOR COORDINATION. DO NOT ROUTE PIPING ABOVE OR BELOW EQUIPMENT, AND MAINTAIN WORKING CLEARANCE SHOWN.
- PROVIDE 1/2" VALVED BRANCH BELOW SINK AND CONNECT DISHWASHER. ROUTE PIPING ALONG BACK OF CABINETRY, COORDINATE EXACT ROUTING WITH G.C. COORDINATE EXACT REQUIREMENTS WITH DISHWASHER PROVIDED.

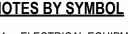

- SEE OVERALL DOMESTIC WATER PLANS FOR CONTINUATION.

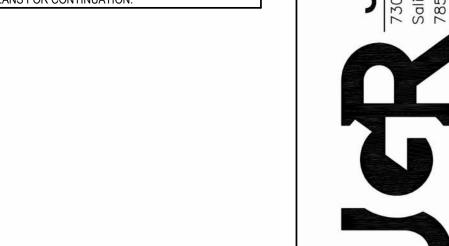

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**FACILITY** 

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SAN ANGELO,


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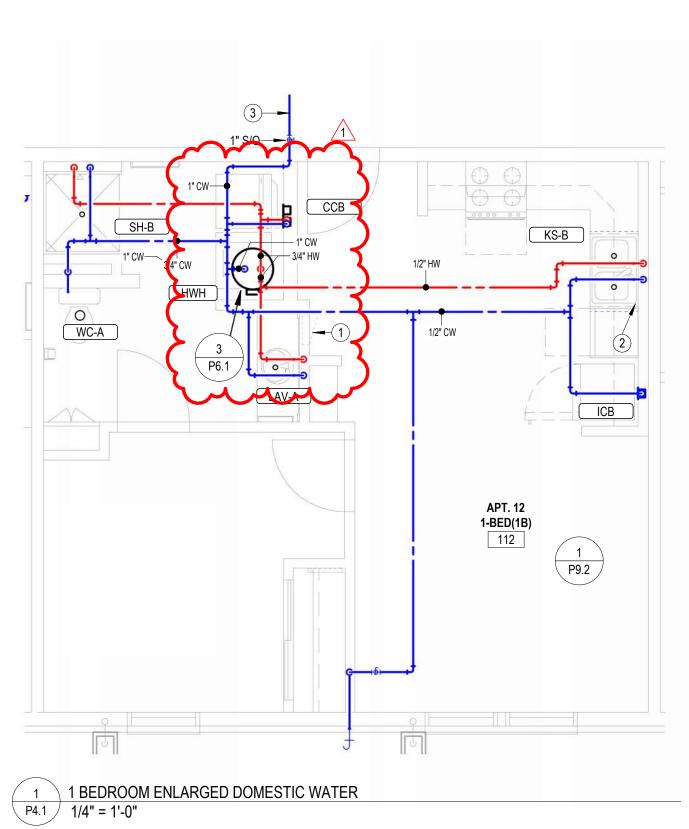
REVISIONS: 1 Addendum #1 2024-11-27


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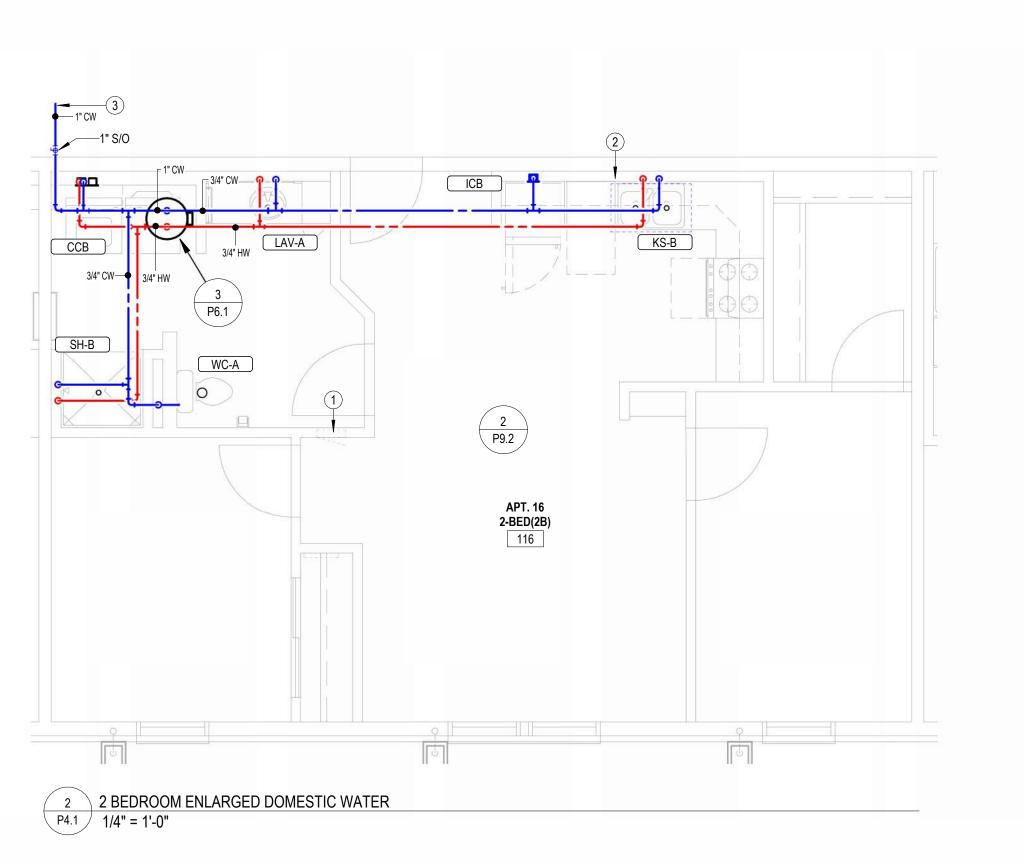
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P4.1







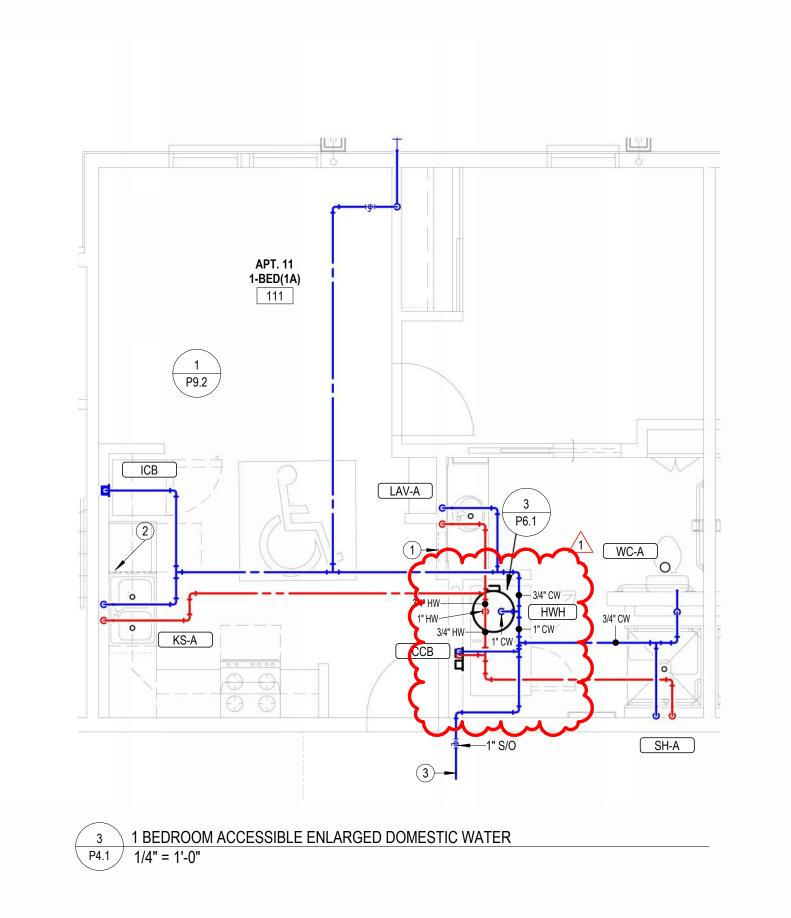

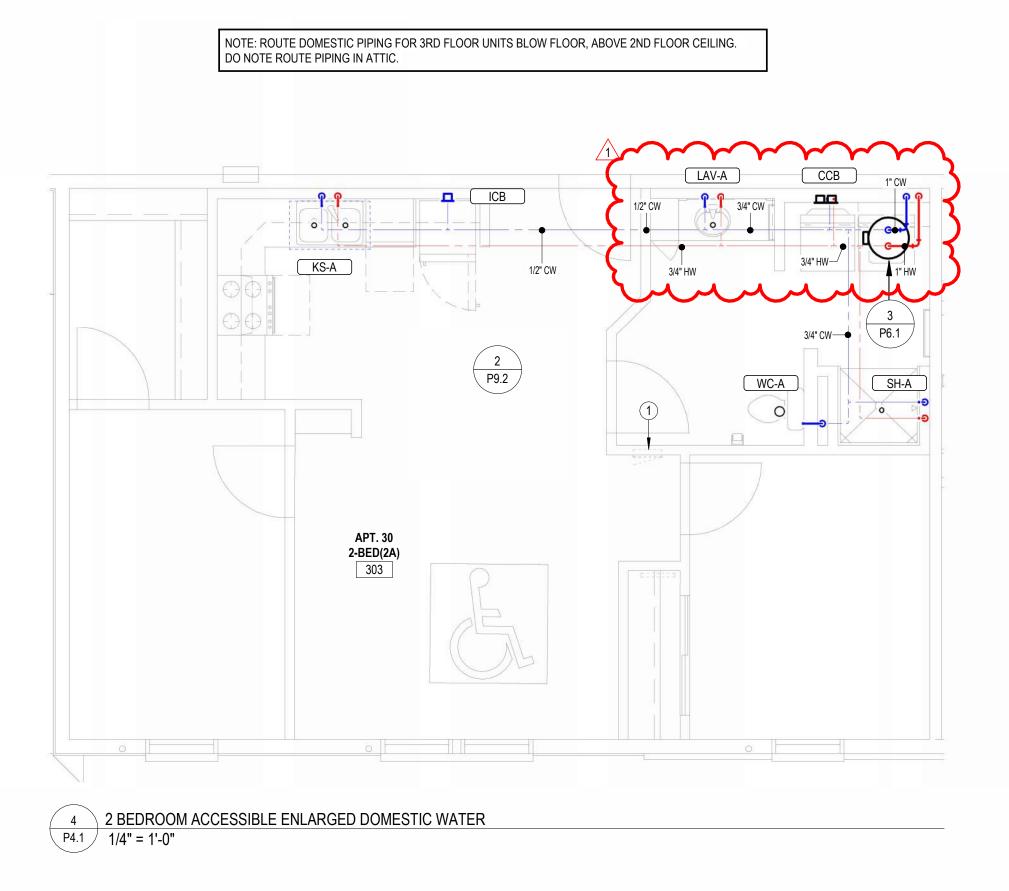**MEADOW** 

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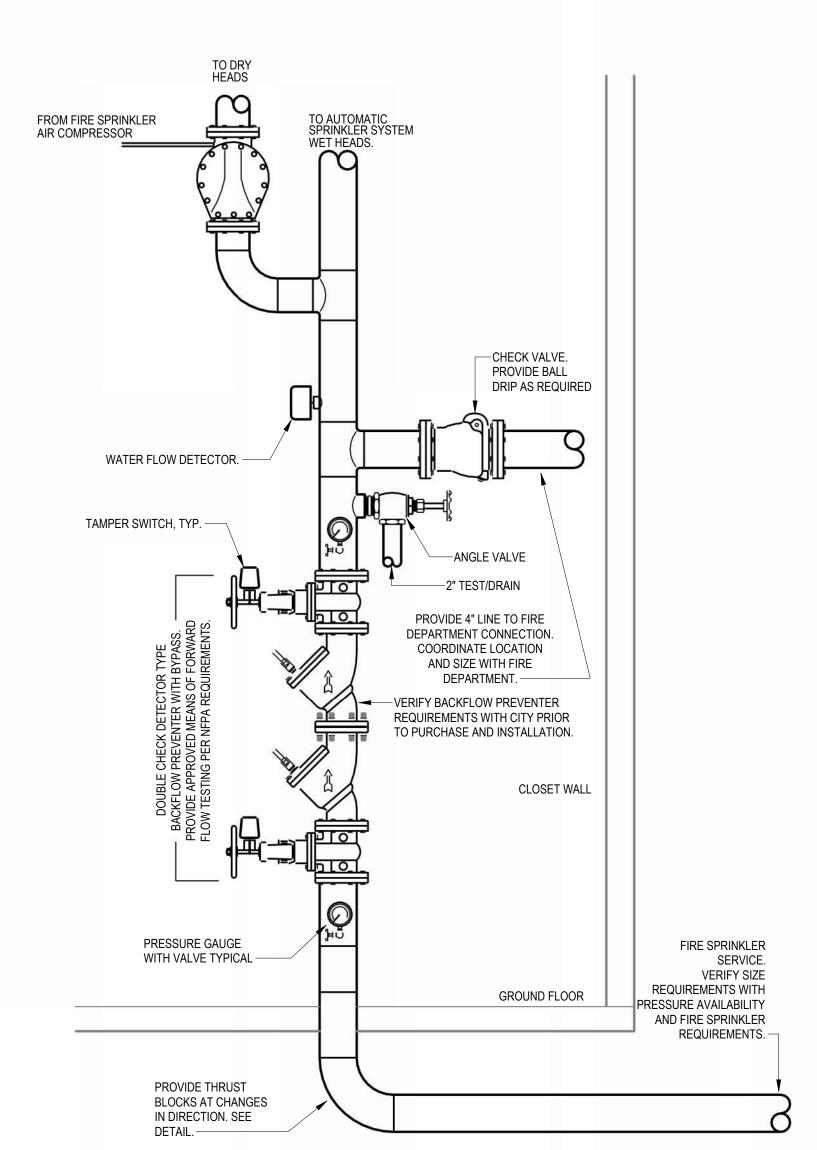
REVISIONS:

1 Addendum #1 2024-11-27

11/22/2024 DATE: 24-3395 SHEET NO.:

-PROVIDE CLAMP-ON AQUASTS FOR CONTROL OF CIRCULATION PUMP. CONTINUATION —UNION (TYP.) ISOLATION VALVE (TYP.) -CHECK VALVE -EXPANSION TANK EQUAL TO WATTS MODEL 'PLT-5'. — —PIPE TO 'FD' **⊕** PROVIDE SHELF TO PROVIDE T & P RELIEF VALVE MOUNT 'HWH' ROUTE 3/4" PIPE FROM VALVE TO FLOOR DRAIN. —

4 WATER HEATER ON SHELF PIPING DIAGRAM P6.1 NOT TO SCALE



1 FIRE PROTECTION RISER DIAGRAM NOT TO SCALE

| Plumb  | ing Fixture S    | Schedule            |  |     |   |               |                     |                   |        |        |        |           |
|--------|------------------|---------------------|--|-----|---|---------------|---------------------|-------------------|--------|--------|--------|-----------|
| Mark   | Manufacturer     | Model               | Description  | ADA | Trim Manufacturer M/N   |               | Domesti<br>onnectio | -                 | Drain- | -Waste | e-Vent | Notes     |
| IVIAIR | Manufacturer     | Wiodei              | Description  | ADA | Triii Manuacturer W/N   | Cold<br>Water |                     | Piping<br>Size(s) |        |        |        | Notes     |
| CCB    | IPS CORP.        | W4700               | Washing machine box with 2" PVC/ABS drain coupling and kockout test cap. Two, 1/4 turn adaptor ball valves, sweat connection.  |     |   | Yes           | Yes                 | 1/2"              | 2"     | 2"     | 2"     |           |
| EWC    | Elkay            | EMABFTLDDWSLK       | Dual Height, self-contained water cooler with stainless steel basin, front and side push bar actuator, lead-free, 120v. Provide with EZH20 bottle filling station, and model 98313C accessory apron.   | Yes |   | Yes           | No                  | 1/2"              | 1 1/4" | 2"     | 2"     | 1         |
| FD     | Sioux Chief      | 833                 | Adjustable floor drain with nickel bronze strainer. Provide Proset trap protection device.   |     |   |               |                     |                   | 3"     |        |        |           |
| FS     | Sioux Chief      | 861                 | PVC floor sink with PVC strainer. Porvide Proset Trapgaurd trap protection device.   |     |   |               |                     |                   | 4"     |        |        |           |
| ICB    | IPS CORP.        | FRIB12              | Jee maker connection box with 1/4 urn half valve and 1/2" weat exppense median.  |     |   | Yes           | No                  | 1/2"              | 2"     |        |        |           |
| KS-A   | JUST             | DL-ADA-2233-A-GF    | Two compartment 20 GA stainless steel sink, self rimming, 14"x16"x5"D inside, fully undercoated, faucet holes as required, and drain hole center rear. Single handle kitchen sink faucet with hose spray, and basket strainer. IN-SINK-ERator: "Badger 5" garbage disposal, 1/2hp, 120V cord and plug connected  | Yes | Kohler / K-10412  | Yes           | Yes                 | 1/2"              | 2"     | 2"     | 2"     | 1,2,3,4,5 |
| KS-B   | JUST             | DL-2233-A-GR        | Two compartment 20 GA stainless steel sink, self rimming, 14"x16"x8"D inside, fully undercoated, faucet holes as required. Single handle kitchen sink faucet with hose spray, and basket strainer. IN-SINK-ERator: "Badger 5" garbage disposal, 1/2hp, 120V cord and plug connected.   | No  | Kohler / K-10412  | Yes           | Yes                 | 1/2"              | 2"     | 2"     | 2"     | 1,2,3,4,5 |
| LAV-A  | KOHLER           | 2196-4-0            | 20 W x 17 Self-Rimming ravatory. Faucet noles On 4" Centers. Single handled 0.5 GPM faucet. Provided with pop-drain.   | Yes | Kohler / 1518-4NDRA   | Yes           | Yes                 | 1/2"              | 2"     | 2"     | 2"     | 1,2,3     |
| LAV-B  | KOHLER           | 2196-4-0            | 20"W x 17" Self-Rimming lavatory. Faucet holes On 4" Centers. Single handled 0.5 GPM faucet. Provide with grid drain, point of use thermostatic mixing valve, and chrome plated or braided stainless steel domestic water supply lines.  | Yes | Kohler / 1518-4NDRA   | Yes           | Yes                 | 1/2"              | 2"     | 2"     | 2"     | 1,2,3     |
| SH-A   | AQUA BATH<br>CO. | C4136BF-OT-FUS 3/4" | Center drain option, reinforced fiberglass ADA roll-in shower, 36"Wx36"Dx80"H with integral soap/toiletry shelves and grab bars in accordance with ADA requirements, fold-up seat, right or left hand rough-in as required, white finish. Provide with collapsible dam. Entire assembly shall have nickel finish. Max 2.0 GPM  | Yes | Kohler / K-8304-KS pressure<br>balancing valve with integral<br>temperature limits and stops /<br>K-TS10583-4 valve trim / K-22173<br>wall supply elbow / K-9514 60" hose<br>/ K-22163 hand shower / K-8524 and<br>K-349 slide bar. | Yes           | Yes                 | 1/2"              | 2"     | 2"     | 2"     | 1         |
| SH-B   | AQUA BATH<br>CO. | C4136BF-OT-FUS 3/4" | Center drain option, reinforced fiberglass ADA base model shower, 36"Wx36"Dx80"H with integral soap/toiletry shelves in accordance with ADA requirements, right or left hand rough-in as required, white finish. Provide with collapsible dam and blocking for grab bars and seat to be added at tenant's request. Entire assembly shall have nickel finish. Max 2.0 GPM                           | Yes | Kohler / K-8304-KS pressure<br>balancing valve with integral<br>temperature limits and stops /<br>K-TS10583-4 valve trim  | Yes           | Yes                 | 1/2"              | 2"     | 2"     | 2"     |           |
| SS     | FIAT             | MSB-2424            | One piece molded stone mop basin, 24" square, stainless steel integral drain body with caulk connection, stainless steel wall gaurds. Faucet with hose thread outlet, vacuum breaker, pail hook, wall brace, and metal lever handels.  | No  | Delta / 28T9  | Yes           | Yes                 | 3/4"              | 3"     | 3"     | 3"     | 4         |
| WC-A   | KOHLER           | 5296 Highline       | Two piece, 12" rough-in, elongated 16-1/2" high bowl, siphon jet flushing action, actuator located on open side of room. Elongated closed front seat and cover. Provide with 1/4" brass ball valve at wall connection.   | No  | Kohler / K-5588   | Yes           | No                  | 1/2"              | 4"     | 2"     | 2"     | 1         |
| WC-B   | KOHLER           | 5296 Highline       | Two piece, 12" rough-in, elongated 16-1/2" high bowl, siphon jet flushing action, actuator located on open side of room. Elongated closed front seat and cover. Provide with 1/4" brass ball valve at wall connection.   | Yes | Kohler / K-5588   | Yes           | No                  | 1/2"              | 4"     | 2"     | 2"     | 1         |
| WH     | Woodford         | 67                  | Non-Freeze Type Wall Hydrant, With Double Check Backflow Preventer, Valve On The Inside Of The Wall, Spout With Backflow Preventer And Loose Key Socket On The Outside Of The Wall. Make Arrangements With The General Contractor To Provide The Necessary Recess In The Wall. Where A Riser To A Wall Hydrant Occurs In An Outside Wall The Contractor Shall Insulate The Chase With 2" Styrofoam |     |   | Yes           | No                  | 3/4"              |        |        |        |           |

• Provide fixtures with all trim necesary for complete installation.

• All toilets, lavatory faucets, showerheads, and kitchen faucets shall have EPA's WaterSense label.

1. In areas open to the public, fixture and installation to meet requirements of Americans with Disabilities Act. In apartments, fixture and installation to meet requirements of the Fair Housing Act.

1. Provide wall hung platform for water heater equal to Holdrite #60SWHP-W. Coordinate exact location and mounting with height with architect.

2. Pump shall have controls to prevent startup within 5 minutes from the end of the previous heating cycle. hot water recirculation system shall meet all requirements of 2015 IECC.

Insulation On All Sides Of The Chase, Except The Inside Wall Of The Chase. Provide Shutoff Valve In Accessible Location.

2. Provide Dearborn supplies with stops and escutcheon plate, 1-1/4" cast brass p-trap.

3. Insulate water and waste piping below fixture. Utilize insulation kit equivalent to LavGuard by Truebro. 4. Trim shall be provided with polished chrome finish.

5. Insulate water and waste piping below sink. Utilize insulation kit equivalent to LavGuard by Truebro. Provide Plumberex model #3071WD-N waste disposal cover.

| Mark | Manufacturer   | Model  | Specification   | Notes |
|------|----------------|--------|---|-------|
| HWH  | AO Smith       | ENJ-40 | 40 Gallon electric water heater, 0.93 UEF, 4500 watts, 208v heating element, 21 GPH recovery @ 90°F temp rise. Supplied with temperature and pressure relief valve and brass drain valve. Water shall have temperature controls set to limit supply temperature to 120°F or less. Provide wall hung platform for water heater equal to Holdrite #60-SWHP-W. Coordinate exact location a mounting height with Architect. | r 1   |
| HWP  | Bell & Gossett | NBF-33 | Circulation pump, bronze body, 10 GPM @ 10' head, 120 VAC. Provide clamp-on aquastat for pump control.  | 2     |

