

NOTES

- 1. PRIOR TO DEMOLITION ACTIVITIES, CONTRACTOR TO NOTIFY THE ENGINEER IMMEDIATELY SHOULD THERE BE ANY DISCREPANCIES OR IF THE EXISTING CONDITIONS VARY FROM THOSE SHOWN ON THESE PLANS.
- 2. ALL MATERIALS REMOVED FROM THE SITE SHALL BE DISPOSED OF PER LOCAL AND STATE REQUIREMENTS.
- 3. CONTRACTOR TO COORDINATE WITH FRANCHISE UTILITY PROVIDERS FOR REMOVAL/RELOCATION OF EXISTING SERVICES.
- 4. REF: ELECTRICAL SITE PLAN DEMO FOR ALL ELECTRICAL DEMOLITION ITEMS.
- 5. CONTRACTOR SHALL BE RESPONSIBLE TO REPAIR AND REPLACE EXISTING CONCRETE SIDEWALK, CURB, AND ANY EXISTING PAVEMENT DAMAGED DURING CONSTRUCTION.
- 6. CONTRACTOR SHALL OBTAIN ALL PERMITS NECESSARY PRIOR TO THE START OF CONSTRUCTION, INCLUDING BUT NOT LIMITED TO, RIGHT-OF-WAY, HAULING AND LAND DISTURBANCE PERMITS WITH THE APPROPRIATE LOCAL JURISDICTION.
- 7. TREE REMOVAL TO INCLUDE THE REMOVAL AND BACKFILL OF THE ROOT BALL. LANDSCAPING ITEMS INCLUDING FENCE PROTECTION ARE SHOWN ON THIS PLAN FOR VISUAL PURPOSES ONLY. REF: LANDSCAPING PLANS FOR ALL TREE PRESERVATION, PROTECTION AND REMOVAL DESIGN ITEMS.



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EXISTING SANITARY SEWER
EXISTING WATER LINE
EXISTING STORM SEWER
EXISTING UNDERGROUND ELECTRIC
EXISTING OVERHEAD ELECTRIC
EXISTING GAS LINE
EXISTING FIBER OPTIC CABLE
EXISTING UNDERGROUND TELEPHONE
EXISTING TV LINE
EXISTING LIGHT POLE
EXISTING GRADES
UTILITY REMOVAL / ABANDONMENT (BY OTHERS)

SIDEWALK, CURB & GUTTER REMOVAL



DATUM: THE HORIZONTAL DATUM IS BASED ON THE KANSAS COORDINATE SYSTEM OF 1983(2011), SOUTH ZONE. COORDINATES SHOWN HAVE BEEN MODIFIED TO THE GROUND USING A COMBINED ADJUSTMENT FACTOR OF 1.0001200144. STATE PLANE COORDINATES CAN BE CALCULATED BY MULTIPLYING THE SHOWN VALUES BY 0.99988.

ALL ELEVATIONS SHOWN ARE BASED ON THE NAVD 88 VERTICAL DATUM.

CONTROL POINTS (GND):

N: 1685568.193 E: 1708413.190 EL: 1332.085 5\8" REBAR WITH ALUM MKEC CONTROL POINT CAP

CP113 N: 1686310.274 E: 1709966.071 EL: 1336.36 "+" CUT IN CURB RETURN AT NW CORNER OF ENTRANCE TO WEST APPROXIMATELY 600FT SOUTH OF DOUGLAS AND YORKTOWN


CP114 N: 1686682.077 E: 1709988.168 EL: 1332.09 "+" CUT ON NW CORNER OF INLET ON WEST SIDE OF YORKTOWN APPROXIMATELY 250FT SOUTH OF DOUGLAS AND YORKTOWN

CP115 N: 1685088.627 E: 1709991.875 EL: 1332.97 "+" CUT IN CURB RETURN AT NW CORNER OF ENTRANCE TO FOUNDERS PKWY AND YORKTOWN

BENCHMARKS: CP110

N: 1685568.193 E: 1708413.190 EL: 1332.085 5\8" REBAR WITH ALUM MKEC CONTROL POINT CAP

<u>NOTE:</u> ALL CONTROL POINTS SHOWN HAVE ELEVATIONS ESTABLISHED USING STANDARD SURVEYING PROCEDURES AND CAN BE USED AS TEMPORARY BENCHMARKS. WHEN USING A CONTROL POINT AS A TEMPORARY BENCHMARK, IT IS RECOMMENDED THAT CROSS-CHECKS BE MADE TO OTHER CONTROL POINTS OR BENCHMARKS TO CONFIRM ELEVATIONS PRIOR TO USE.

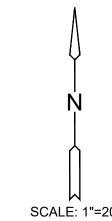

WARNING EXISTING UNDERGROUND UTILITIES IN THE AREA CONTRACTOR IS RESPONSIBLE FOR DETERMINING THE HORIZONTAL AND VERTICAL LOCATION OF ALL UTILITIES PRIOR TO CONSTRUCTION. CONTRACTOR IS RESPONSIBLE FOR ANY REPAIRS TO EXISTING UTILITIES DUE TO DAMAGE INCURRED DURING CONSTRUCTION. CONTRACTOR SHALL NOTIFY THE ENGINEER OF ANY DISCREPANCIES ON THE PLANS.

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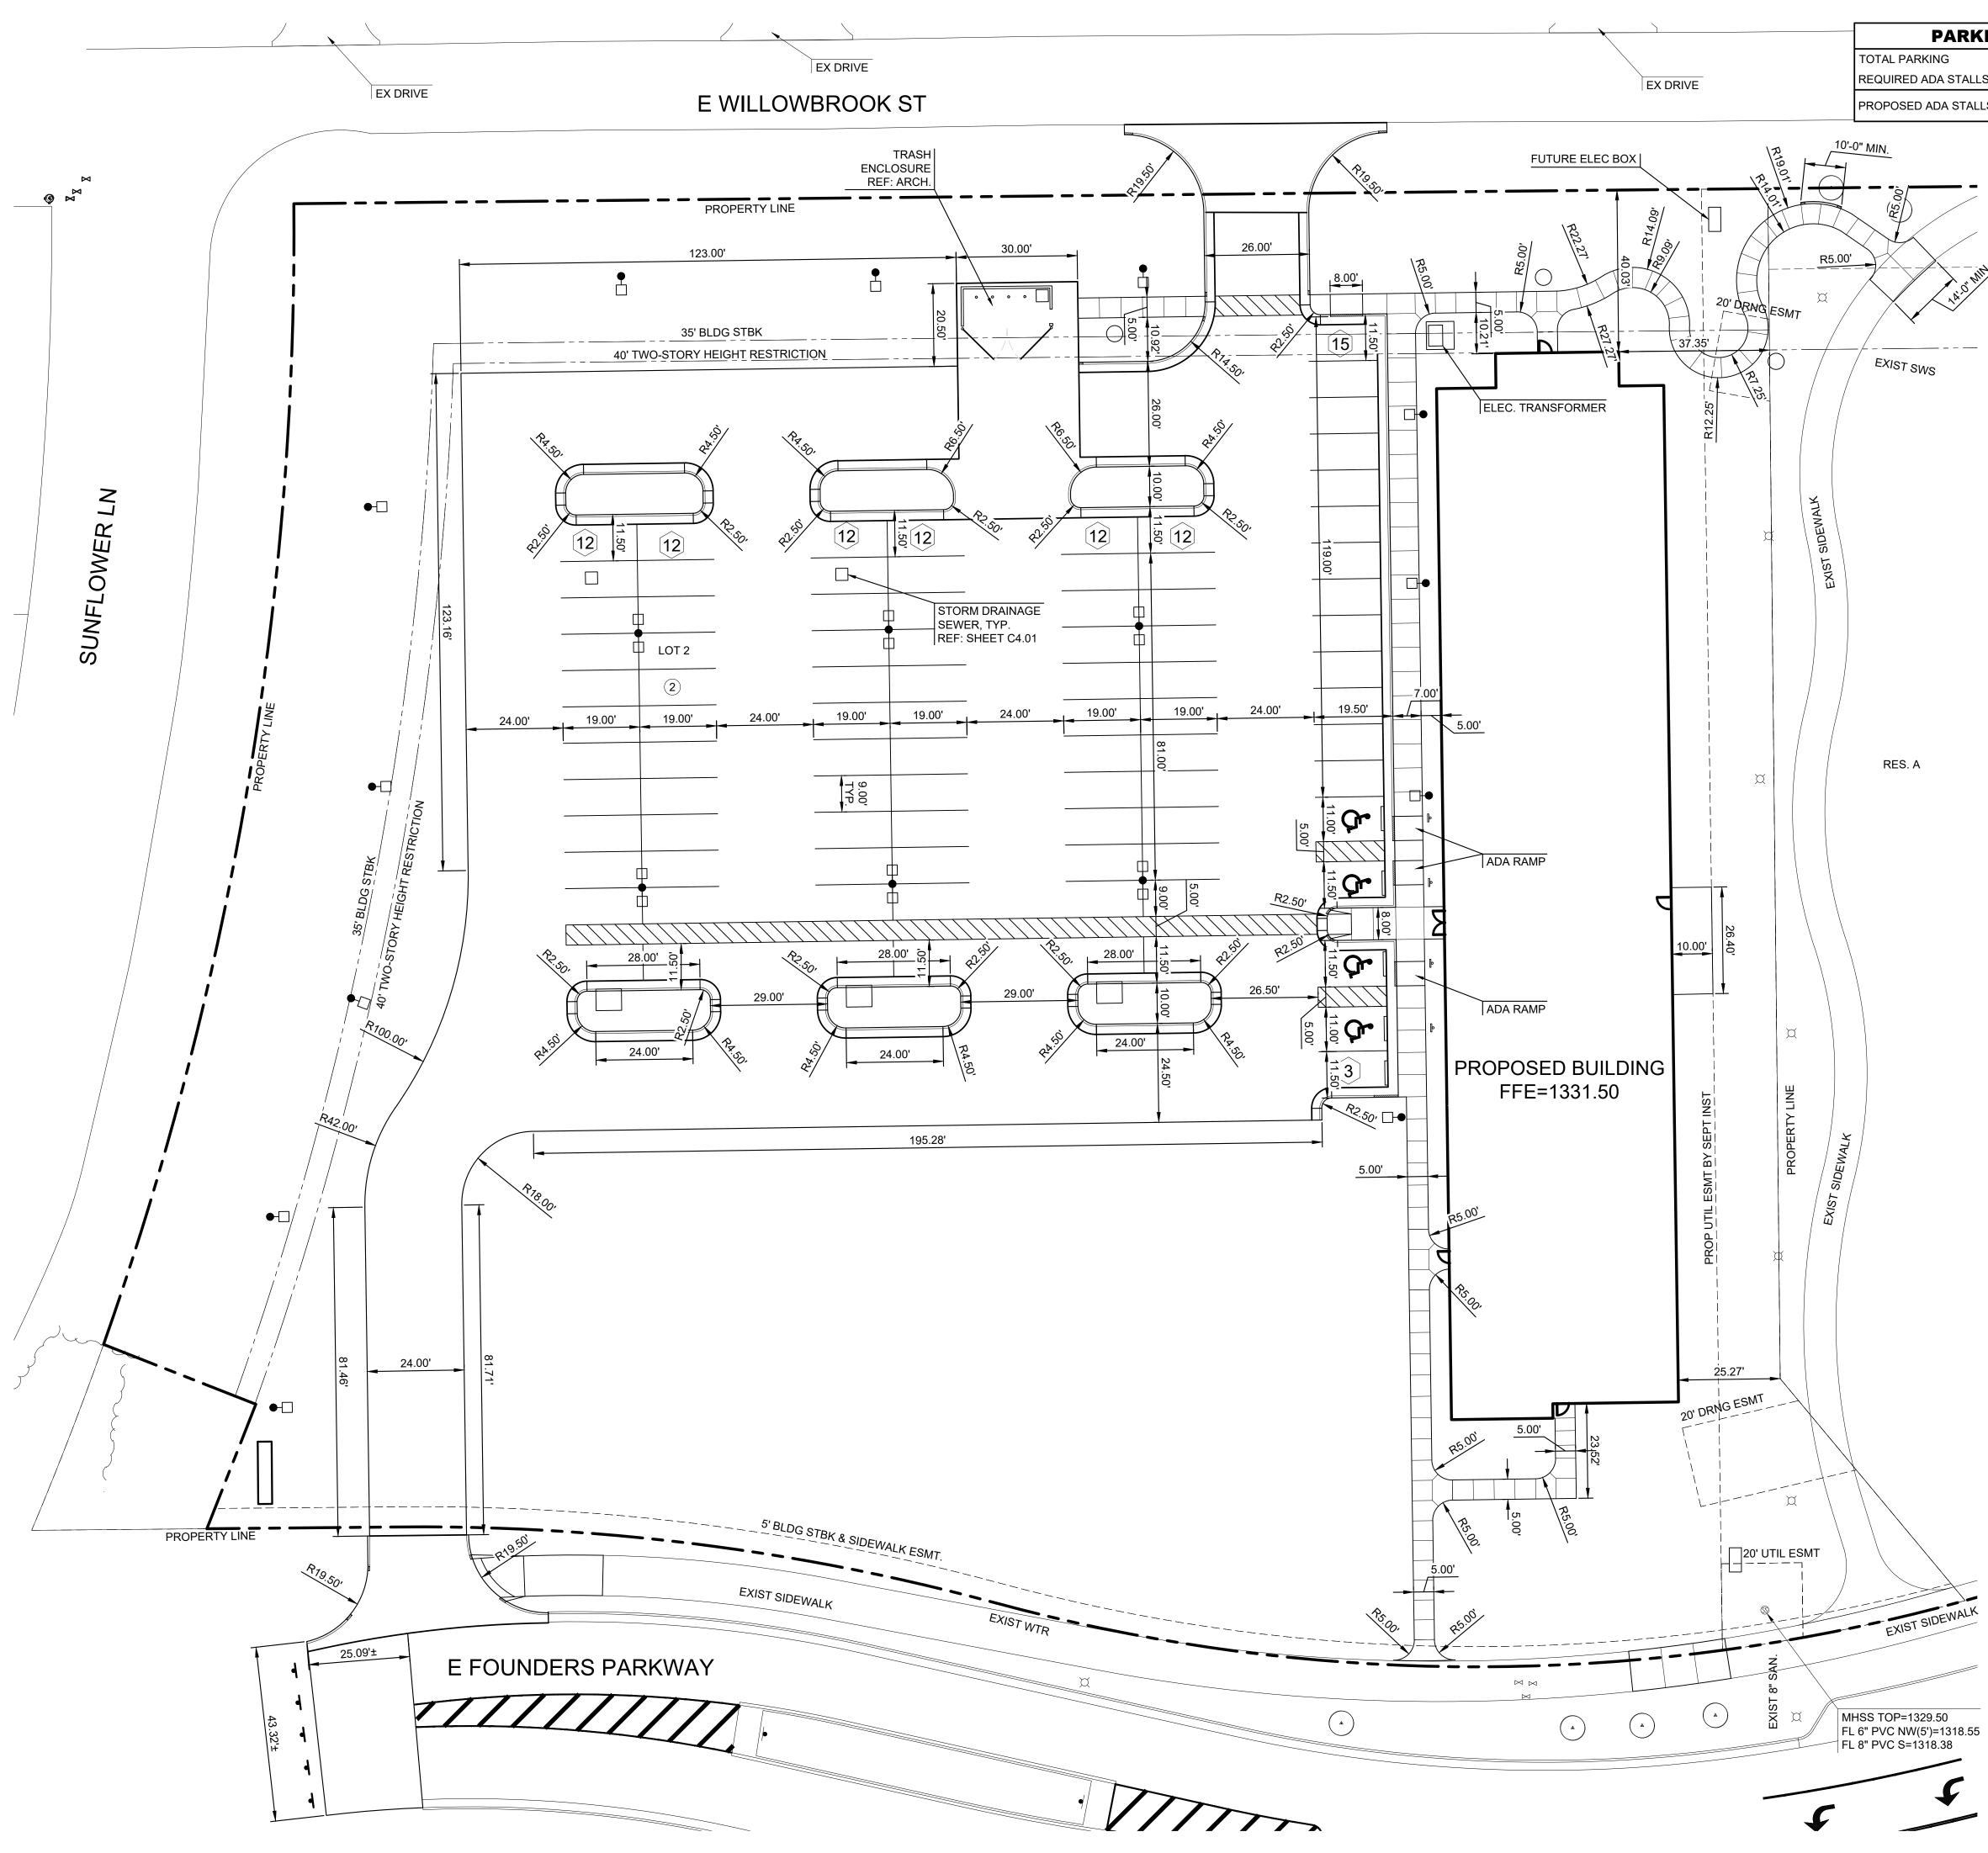
TRAVIS M. B. BAILEY KS PE 28740 FOR PERMIT ONLY 01/03/25 **REVISION:**

DATE:	1-3-2025	- - @
JOB:	24–3385	
SHEET NO .:		

C1.01

SCALE: 1"=20'





PARKING	SUMMARY
OTAL PARKING	90 SPACES
REQUIRED ADA STALLS	4 SPACES
ROPOSED ADA STALLS	4 SPACES

NOTES

- 1. UNLESS OTHERWISE NOTED, MATERIALS AND CONSTRUCTION SHALL BE IN ACCORDANCE WITH STANDARD SPECIFICATIONS OF AUTHORITY HAVING JURISDICTION
- 2. ALL DIMENSIONS ARE TO BACK OF CURB, UNLESS OTHERWISE NOTED.
- 3. UNLESS OTHERWISE NOTED, STANDARD PARKING STALLS ARE 9'X19', MEASURE TO THE FACE OF CURB.
- 4. UNLESS OTHERWISE NOTED, ADA PARKING STALLS ARE 11'X19', MEASURE TO THE FACE OF CURB. 5. BUILDING FOOTPRINT AS SHOWN IS THE OUTSIDE FACE OF THE ARCHITECTURAL PLANS. REFER TO ARCHITECTURAL PLANS FOR EXACT BUILDING DIMENSIONS.
- 6. REFER TO GEOTECHNICAL REPORT PREPARED FOR THIS PROJECT BY TERRACON, PROJECT #01245160 DATED NOVEMBER 4, 2024. CONTRACTOR SHALL REFER TO REPORT FOR RECOMMENDED PAVEMENT THICKNESS. SUBGRADE PREPARATION AND TRENCH BACKFILLING. IF ANY DISCREPANCIES ARISE BETWEEN THE PLANS, SPECIFICATIONS AND GEOTECHNICAL REPORT, THEN THE MORE STRINGENT REQUIREMENT SHALL GOVERN.
- 7. CONTRACTOR TO DRILL & EPOXY #4 BARS (L=2'-0"; MIN. 9" EMBED) @ 24" O.C. INTO EXIST. CONCRETE PAVEMENT AND CURB & GUTTER WHEREVER PROPOSED ABUTS EXISTING.
- 8. AGGREGATE BASE UNDER PAVEMENT SHALL EXTEND A MINIMUM OF 1' BEYOND THE BACK OF CURB. 9. PARKING STRIPING SHALL BE 4" WIDE, WHITE IN COLOR.
- 10. ADA PARKING STALL LOADING AISLE STRIPING SHALL BE 4" WIDE, 2' O.C. @ 45° ANGLE, WHITE IN COLOR.
- 11. PAVEMENT MARKINGS SHALL BE AN UNDILUTED ALKYD TRAFFIC PAINT. APPLY PAINT WITH MECHANICAL EQUIPMENT TO PRODUCE PAVEMENT MARKINGS WITH UNIFORM. STRAIGHT EDGES. APPLY AT MANUFACTURER'S RECOMMENDED RATE TO PROVIDE A MINIMUM WET FILM THICKNESS OF 15 MILS. FOLLOW MANUFACTURER'S RECOMMENDATIONS FOR SURFACE PREPARATION AND APPLICATION.
- 12. IT IS IMPORTANT BOTH FUNCTIONALLY AND AESTHETICALLY FOR JOINTS IN CURB & GUTTER AND ABUTTING CONCRETE PAVEMENT TO HAVE A CONSISTENT PATTERN.
- 13. JOINT SPACING SHOULD BE THOUGHT OUT AND ESTABLISHED PRIOR TO PLACING ANY CONCRETE. THIS INCLUDES JOINTING IN THE CURB & GUTTER ON BOTH SIDES OF PROPOSED CONCRETE PAVEMENT AND ON CURVES, DRIVES, ROUNDABOUTS, WHEELCHAIR RAMPS, ETC.
- 14. PEDESTRIAN CONCRETE SIDEWALKS SHALL RECEIVE HAND TOOLED JOINTS.
- 15. THE PAVING PLANS, DETAILS, SPECIFICATIONS AND NOTES CONTAIN SPECIFIC REQUIREMENTS FOR JOINTING. THE FOLLOWING ITEMS SHALL SERVE AS GUIDELINES FOR THE CONTRACTOR WHEN DEVELOPING THE JOINTING PLAN:
- 15.1. JOINTING IN PAVEMENT SHALL BE AT RIGHT ANGLES TO CURB LINES WHEREVER POSSIBLE 15.2. JOINT SPACING IN PAVEMENT SHALL GENERALLY NOT EXCEED 24 TIMES THE PAVEMENT
- THICKNESS 15.3. JOINTS IN PAVEMENT SHALL NOT CREATE "L" SHAPED OR ODD SHAPED SECTIONS OR SECTIONS WITH NARROW POINTED PORTIONS THAT COULD BE SUBJECT TO CRACKING AND BREAKING
- 15.4. CONTRACTION JOINT SPACING SHALL GENERALLY NOT EXCEED 1.5 TIMES LONGITUDINAL JOINT SPACING 16. CONTRACTOR SHALL BE RESPONSIBLE FOR REQUIRED TRAFFIC CONTROL NECESSARY ON
- SURROUNDING STREETS FOR CONSTRUCTION. TRAFFIC CONTROL SHALL COMPLY WITH THE LATEST EDITION OF MUTCD AND AUTHORITIES HAVING JURISDICTION STANDARDS AND SPECIFICATIONS.

LEGEND	
13	PARKING STALL COUNT
LOT 2	LOT & BLOCK NUMBER
2	

CONTROL POINTS

DATUM: THE HORIZONTAL DATUM IS BASED ON THE KANSAS COORDINATE SYSTEM OF 1983(2011), SOUTH ZONE. COORDINATES SHOWN HAVE BEEN MODIFIED TO THE GROUND USING A COMBINED ADJUSTMENT FACTOR OF 1.0001200144. STATE PLANE COORDINATES CAN BE CALCULATED BY MULTIPLYING THE SHOWN VALUES BY 0.99988.

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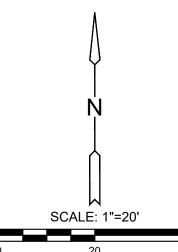
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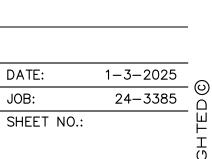
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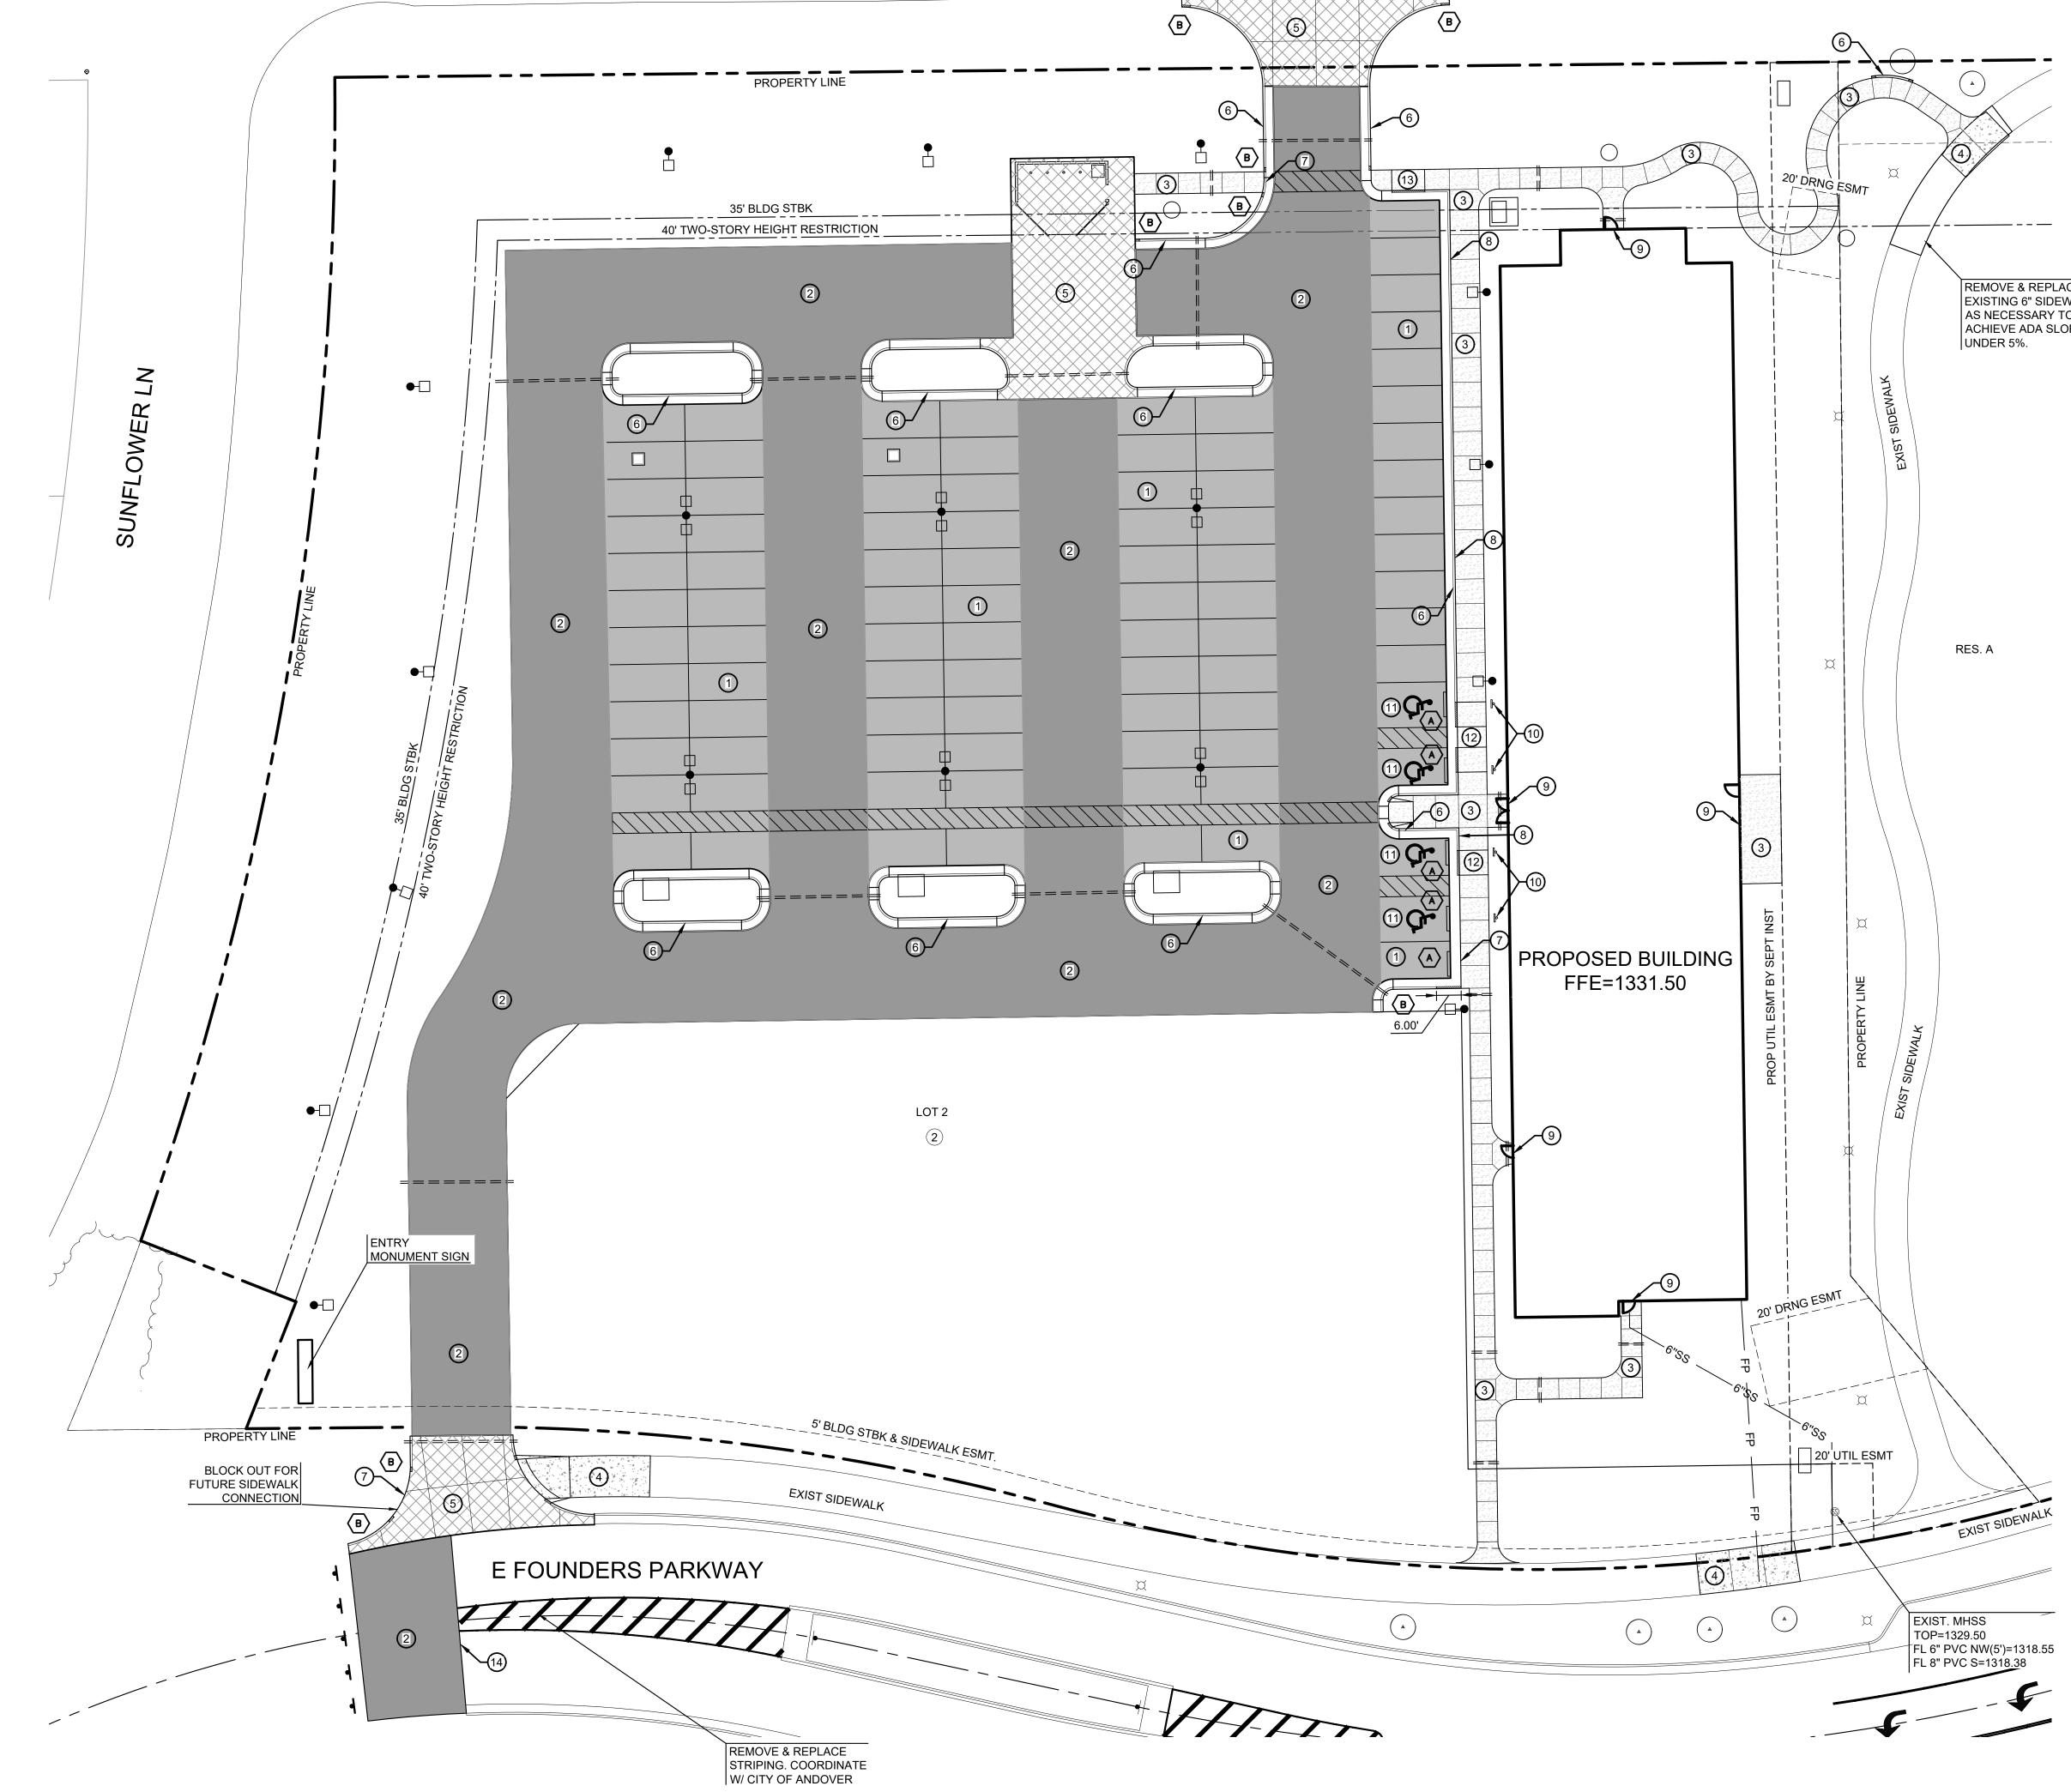
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REVISION:	



C2.01

















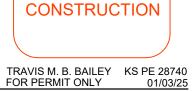

REVISION:

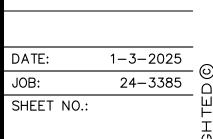

C2.02

11	ACCESSIBLE PARKING MARKING	ACCESSIBLE PARKING MARKING	C2.53
12	ADA RAMP	WHEEL CHAIR RAMP DETAILS/SECTIONS	C2.53
13	ADA RAMP	WHEEL CHAIR RAMP DETAILS/SECTIONS	C2.53
14	ASPHALTIC PAVEMENT CONNECTION	TYPICAL SECTION: ASPHALTIC PAVEMENT CONNECTION	C2.51
SITE FURNISHINGS WHEEL STOP MANUFACTURER: TRAFFIC SAFETY STORE PRODUCT #: PBRTSS6WHDS - 6' RUBBER PARKING BLOCK COMMENTS: ENSURE WHITE STRIPING ON PARKING BLOCK. INSTALL PER MANUFACTURER'S DETAILS AND SPECIFICATIONS. LEGEND			
		5.5" ASPHALTIC PAVEMENT	
		7.5" ASPHALTIC PAVEMENT	
		4" CONCRETE SIDEWALK	
4		6" CONCRETE SIDEWALK	
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8" CONCRETE PAVEMENT PROPOSED IRRIGATION SLEEVE

WHEEL STOP (REF: NOTE THIS SHEET)

1' CURB TRANSITION UNLESS NOTED

В **CONTROL POINTS**

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DETAIL LEGEND

DESCRIPTION

TYPICAL SECTION: 5.5" ASPHALT

PAVEMENT ON 9" BASE

TYPICAL SECTION: 7.5" ASPHALT

PAVEMENT ON 9" BASE

TYPICAL SECTION: 4" CONCRETE

TYPICAL SECTION: 6" CONCRETE

SIDEWALK

TYPICAL SECTION: 8" CONCRETE

TYPICAL SECTION: 6" CURB &

GUTTER

FLUSH CURB & GUTTER

TYPICAL CONCRETE SIDEWALK AT

CURB

EXPANSION JOINT AT BUILDING

ACCESSIBLE PARKING SIGN

PAVEMENT

SIDEWALK

SHEET

C2.51

C2.51

C2.52

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DETAIL

5.5" ASPHALTIC

7.5" ASPHALTIC

PAVEMENT

4" CONCRETE

SIDEWALK

6" CONCRETE

SIDEWALK

8" CONCRETE

PAVEMENT

6" CURB & GUTTER

FLUSH CURB

AT CURB

EXPANSION JOINT @

BUILDING ACCESSIBLE PARKING

SIGN

CONCRETE SIDEWALK

PAVEMENT

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600FT SOUTH OF DOUGLAS AND YORKTOWN CP114 N: 1686682.077 E: 1709988.168 EL: 1332.09 "+" CUT ON NW CORNER OF INLET ON WEST SIDE OF YORKTOWN APPROXIMATELY

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BENCHMARKS: CP110


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REMOVE & REPLACE EXISTING 6" SIDEWALK AS NECESSARY TO ACHIEVE ADA SLOPES



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DATE: JOB: SHEET NO.: C2	1-3-2025 24-3385 .51	COPYRIGHTED©

EXIST. ASPHALT PAVEMENT

2'-0"

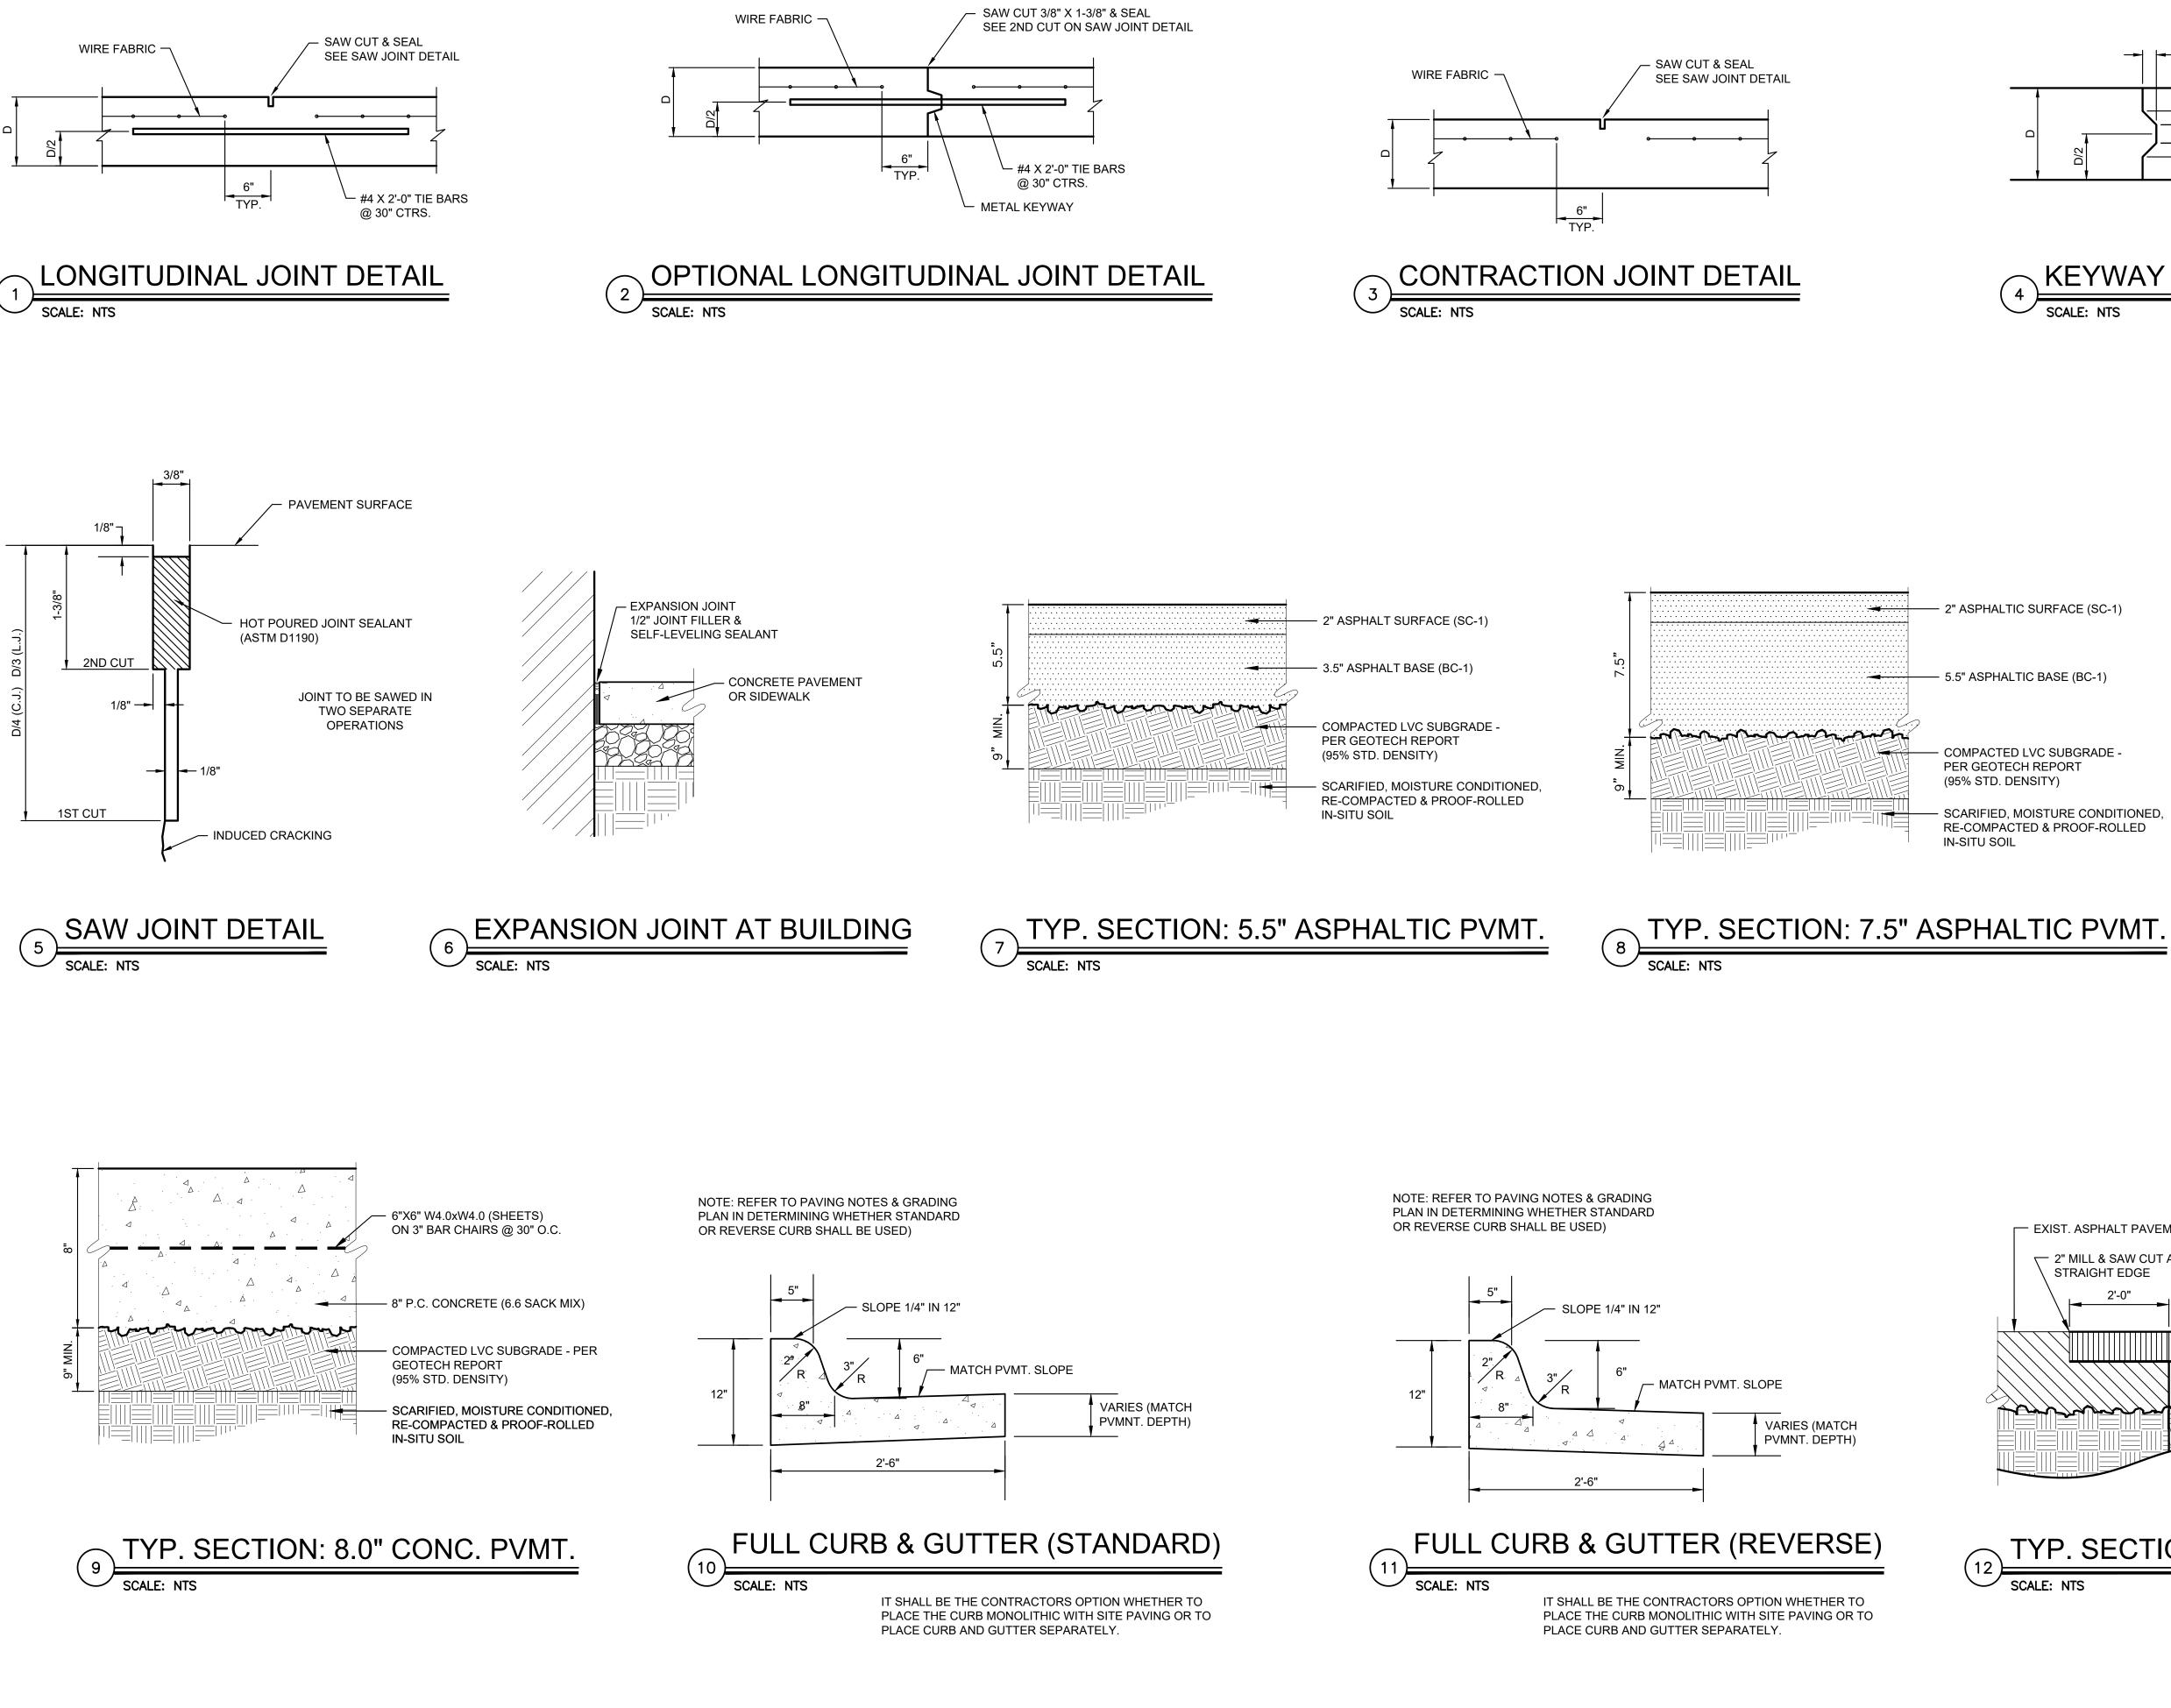many have the second and the second

2" MILL & SAW CUT AND PROVIDE SMOOTH STRAIGHT EDGE

— TENSAR GLASGRID 8502 (OR APPD. EQUAL)

– ASPHALT SURFACE COURSE (SC-1)

— ASPHALT BASE COURSE (BC-1)


- MODIFIED SUBGRADE

(98% STD. DENSITY)


(5' WIDE ROLL)

12 TYP. SECTION: A.C. PVMT. CONNECTION SCALE: NTS


- —— SCARIFIED, MOISTURE CONDITIONED, RE-COMPACTED & PROOF-ROLLED IN-SITU SOIL
- COMPACTED LVC SUBGRADE -PER GEOTECH REPORT (95% STD. DENSITY)
- 5.5" ASPHALTIC BASE (BC-1)
- 2" ASPHALTIC SURFACE (SC-1)

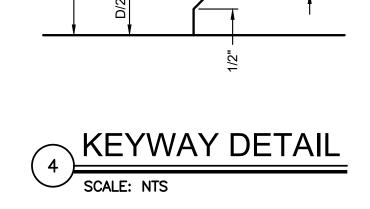


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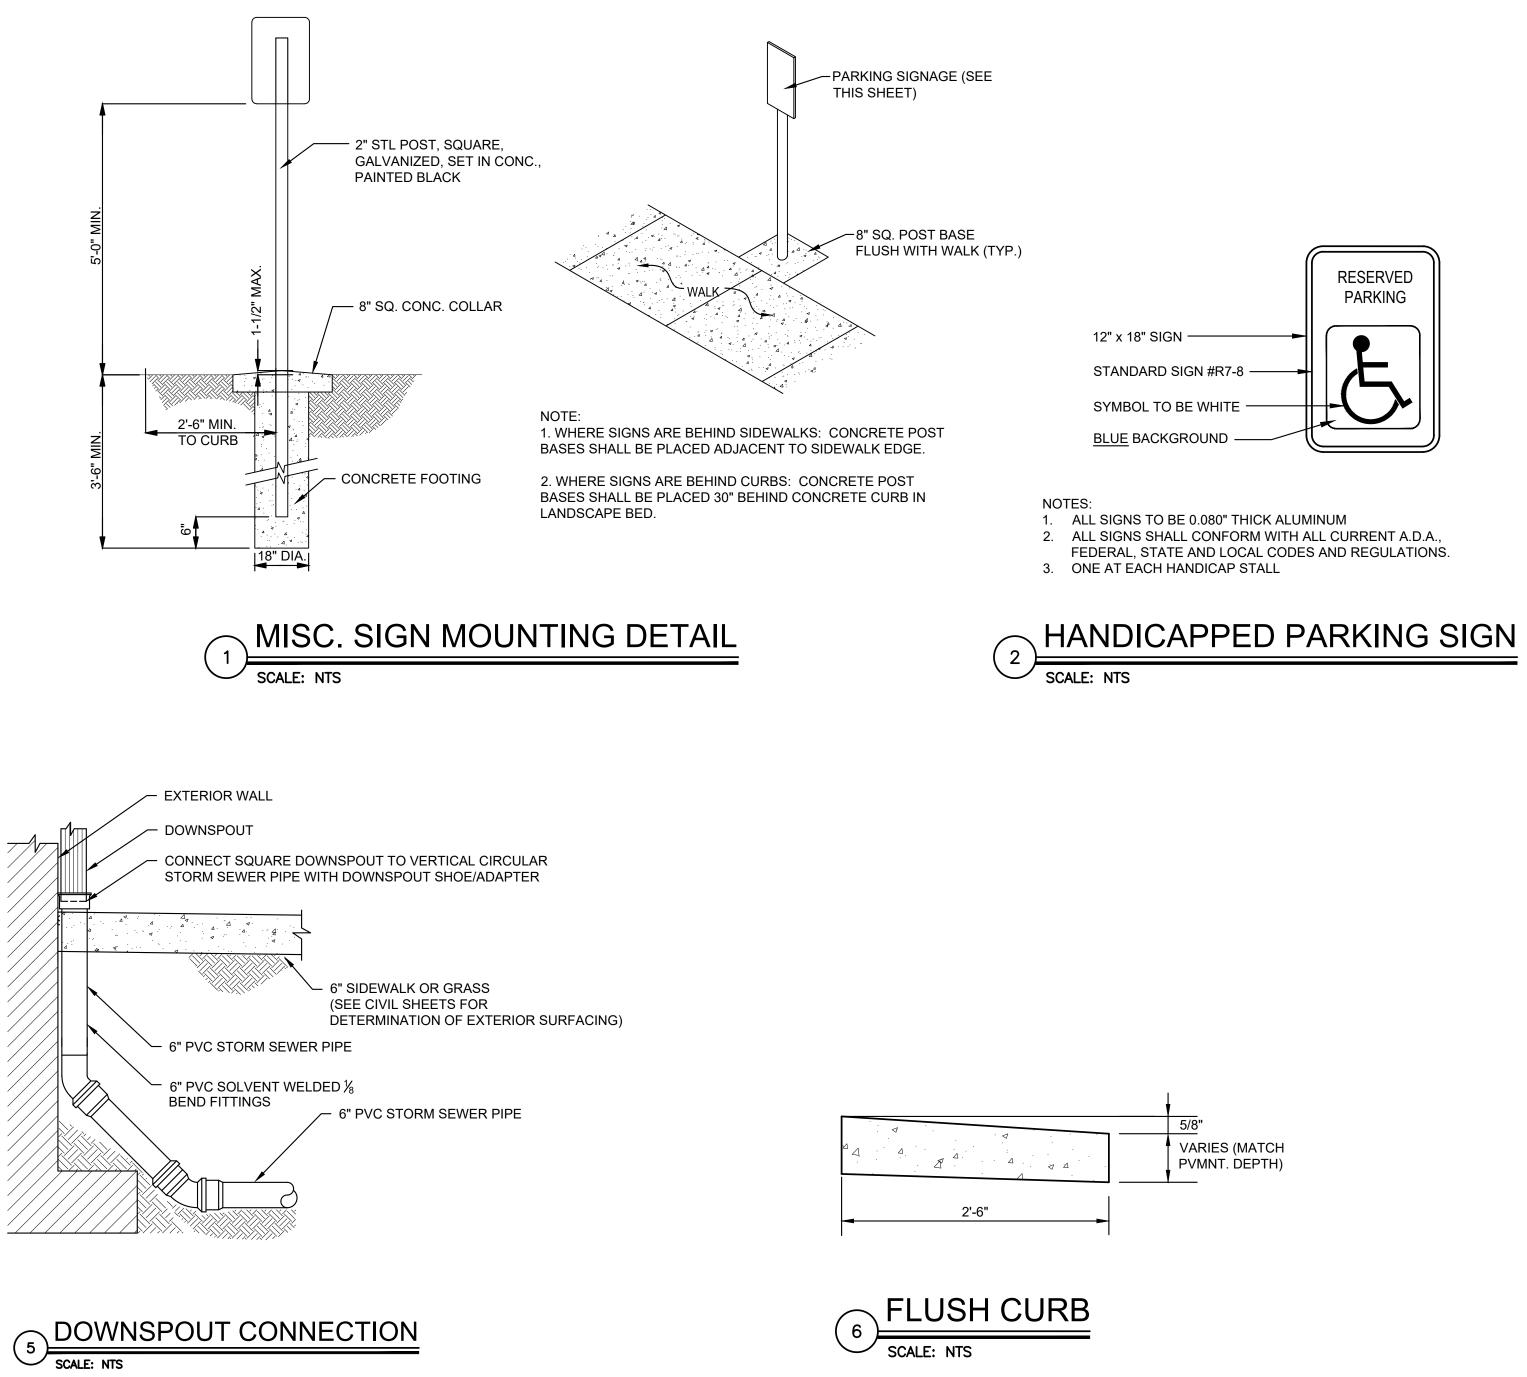


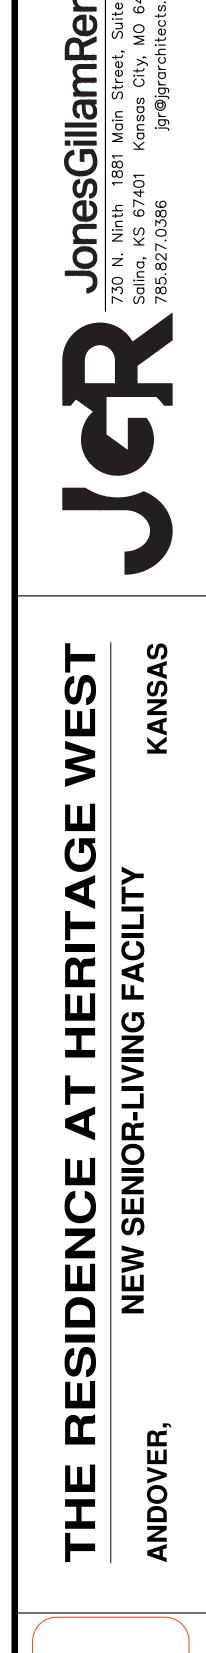
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JonesGillamRenz	730 N. Ninth 1881 Main Street, Suite 301 Salina, KS 67401 Kansas City, MO 64108 785.827.0386 jgr@jgrarchitects.com
THE RESIDENCE AT HERITAGE WEST	ANDOVER, NEW SENIOR-LIVING FACILITY KANSAS
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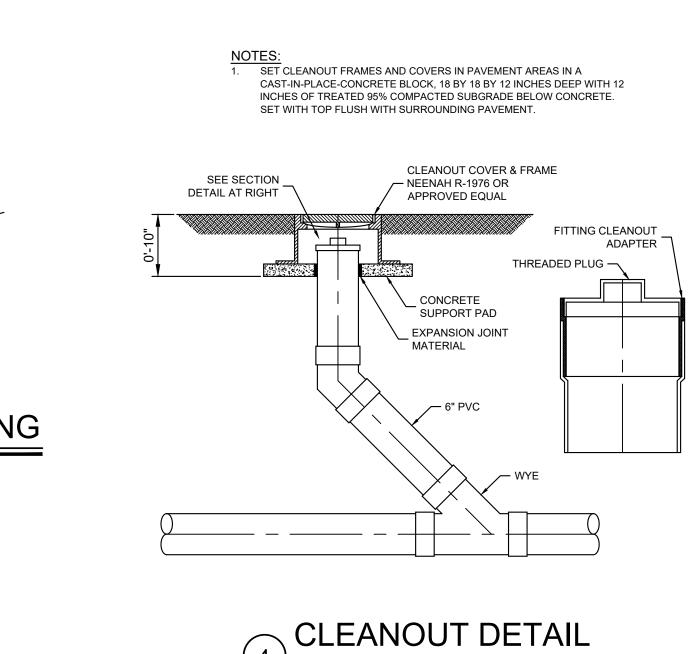




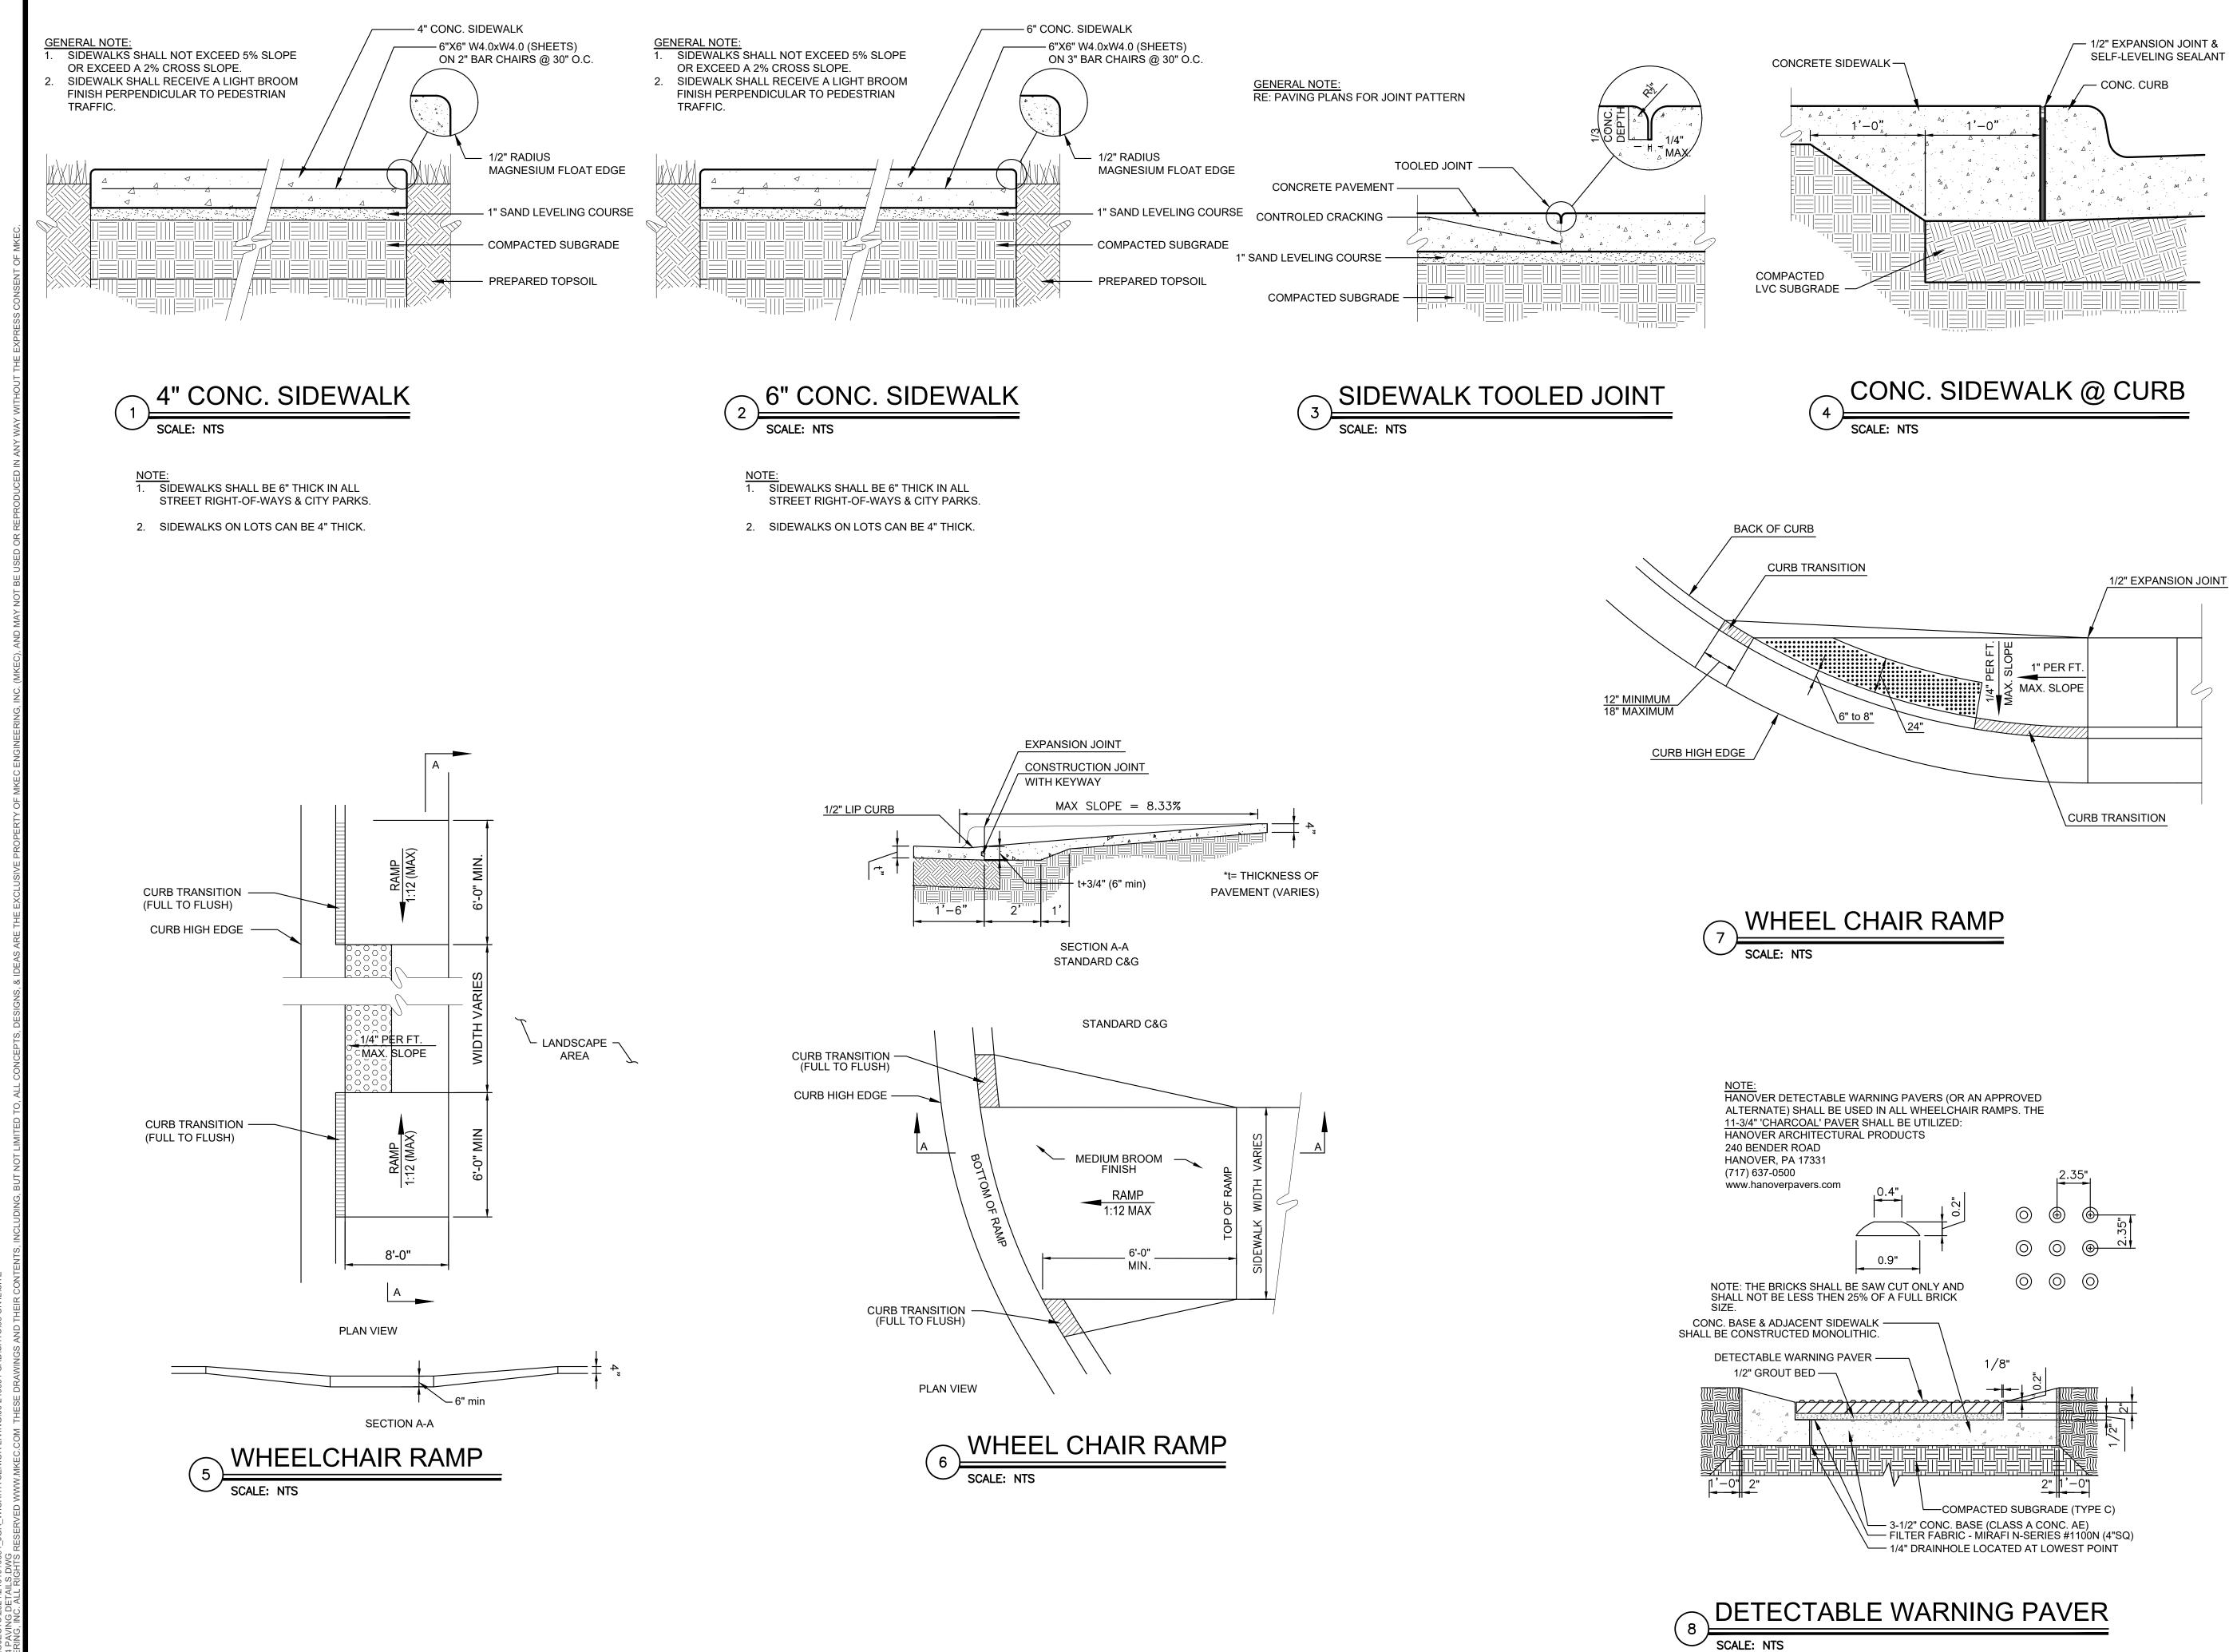




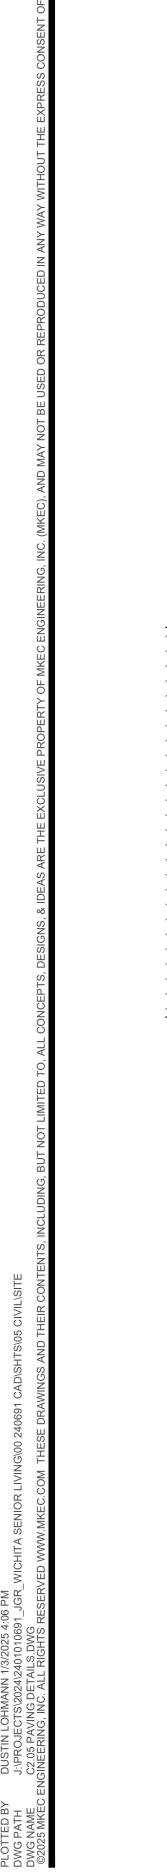

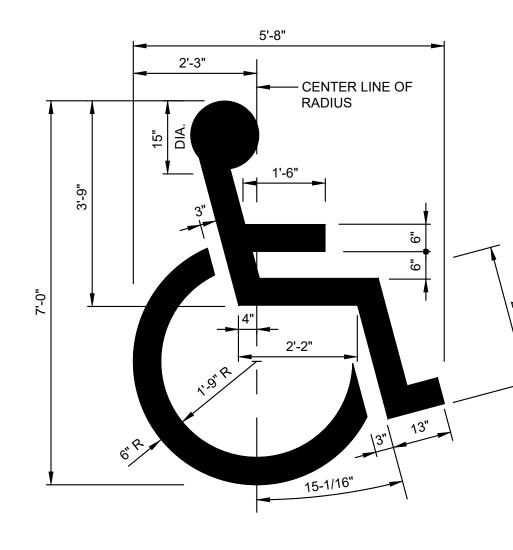

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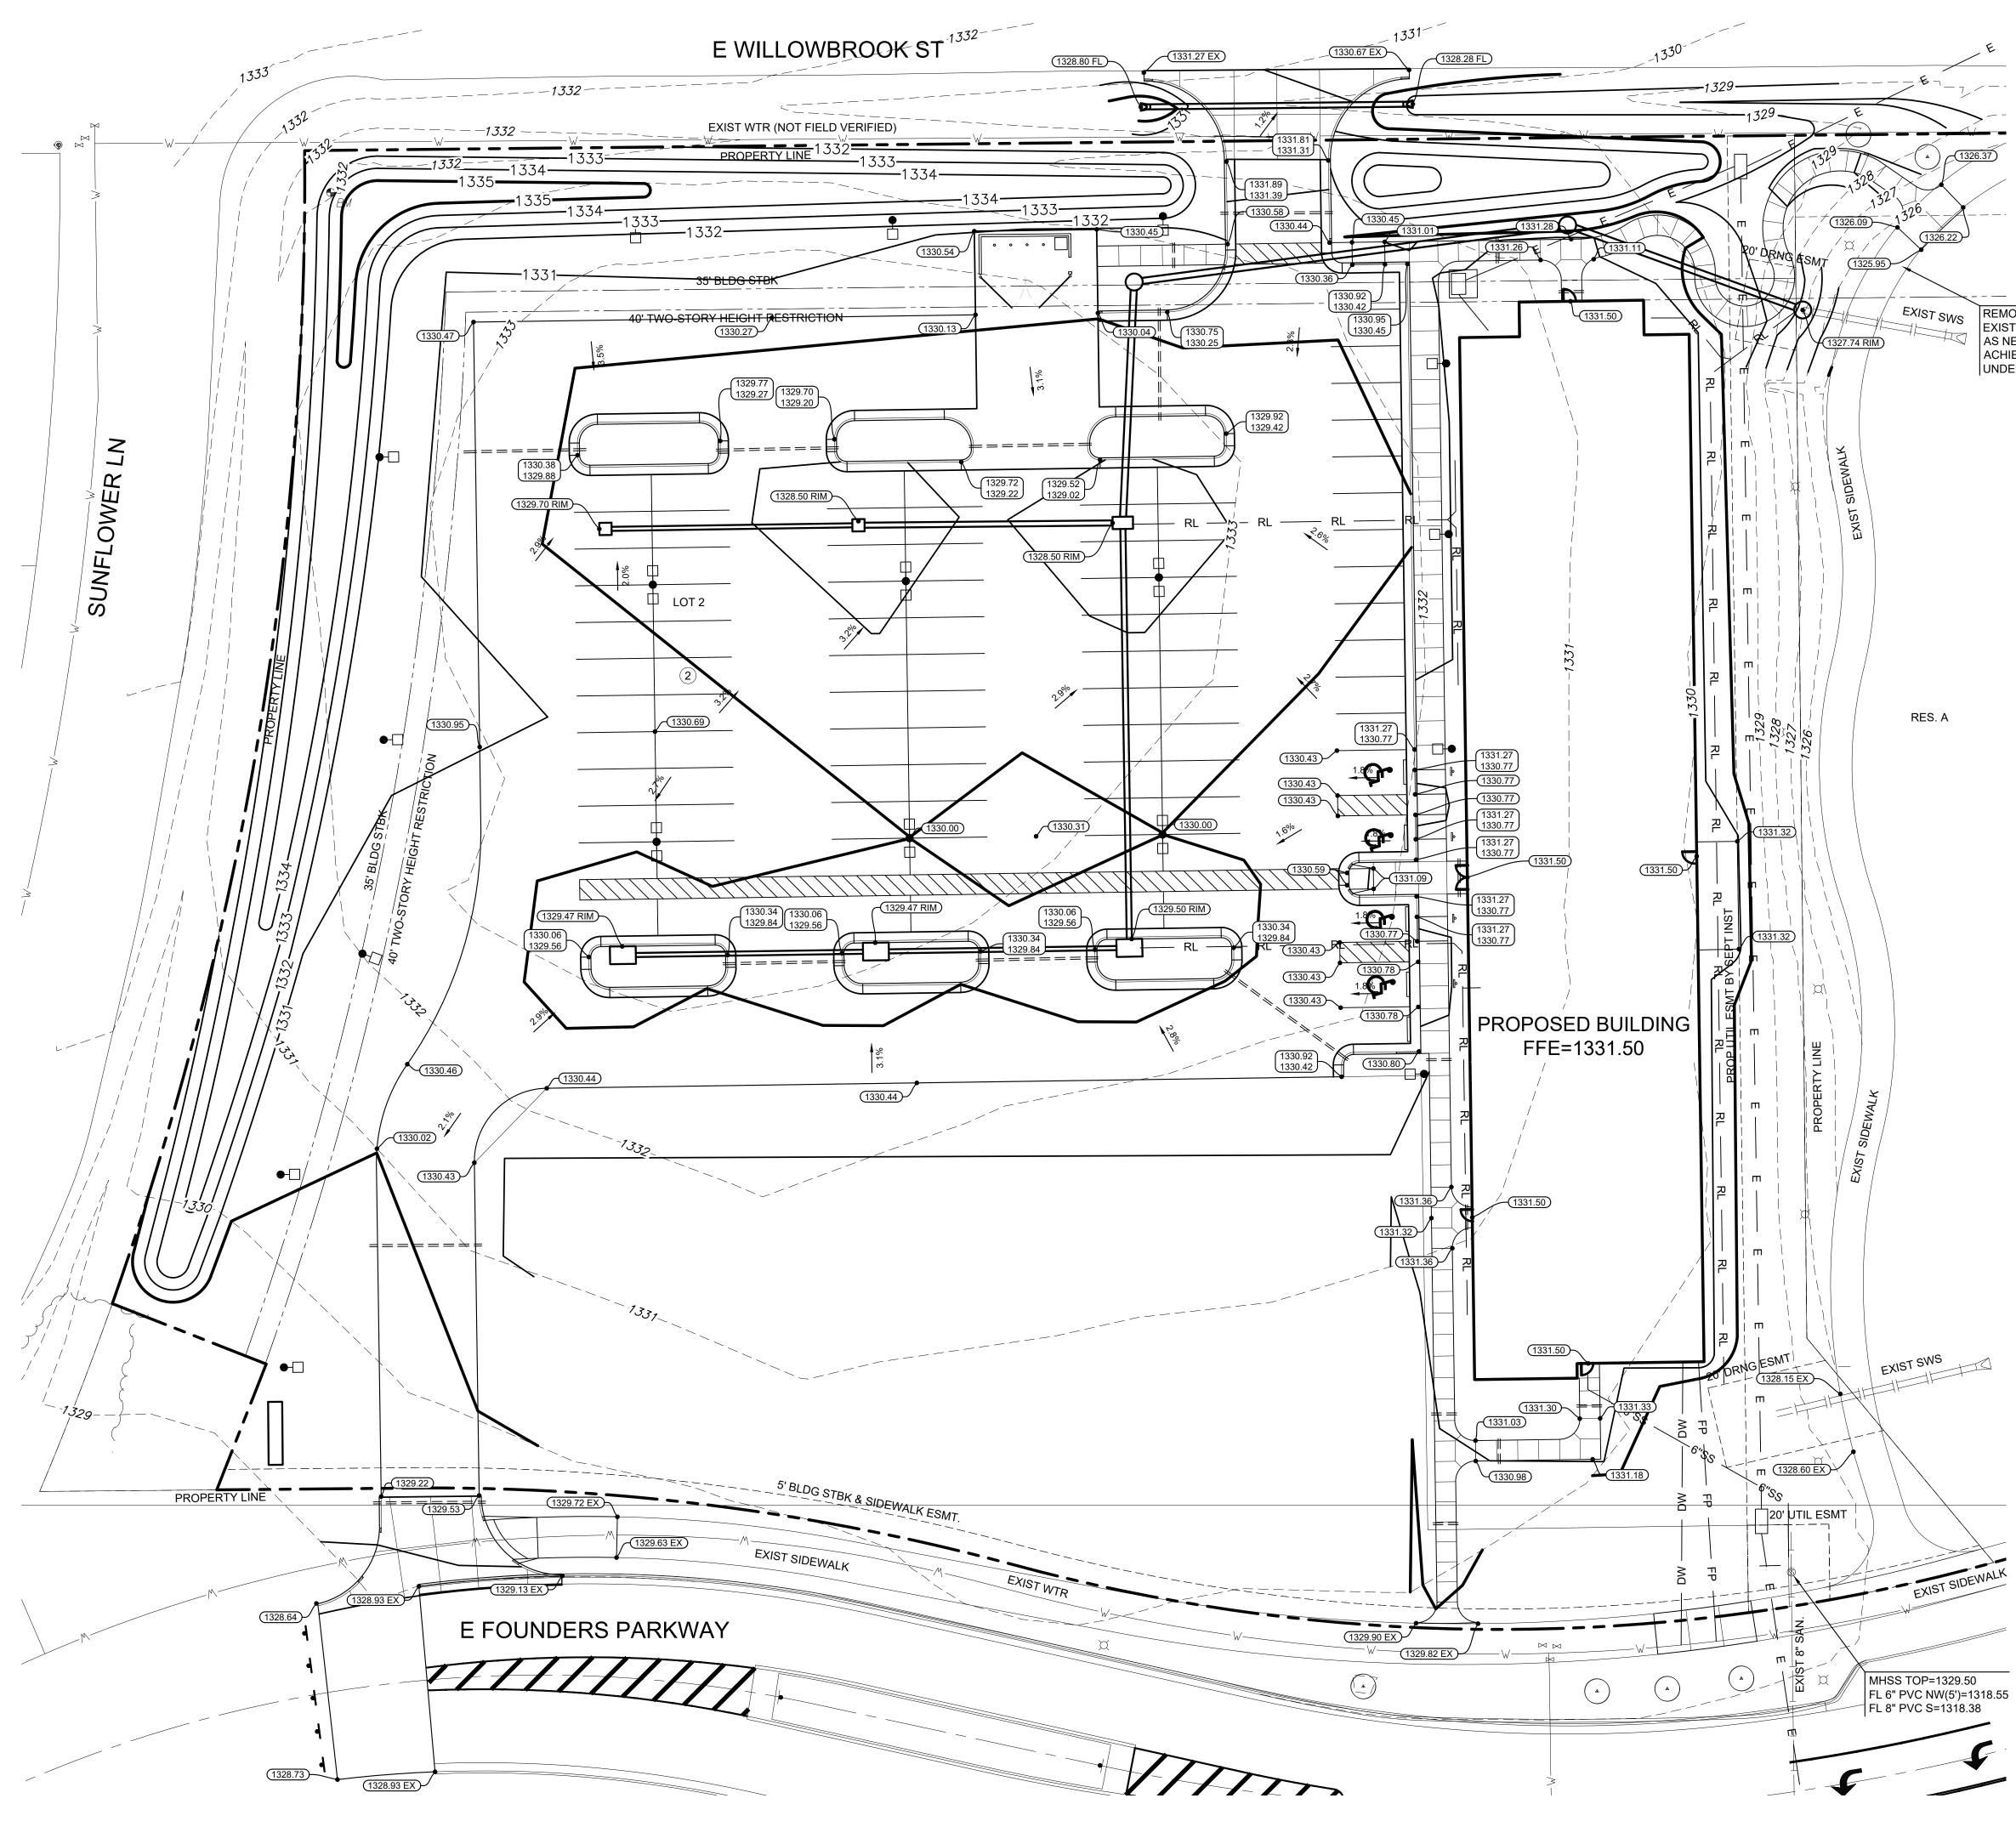


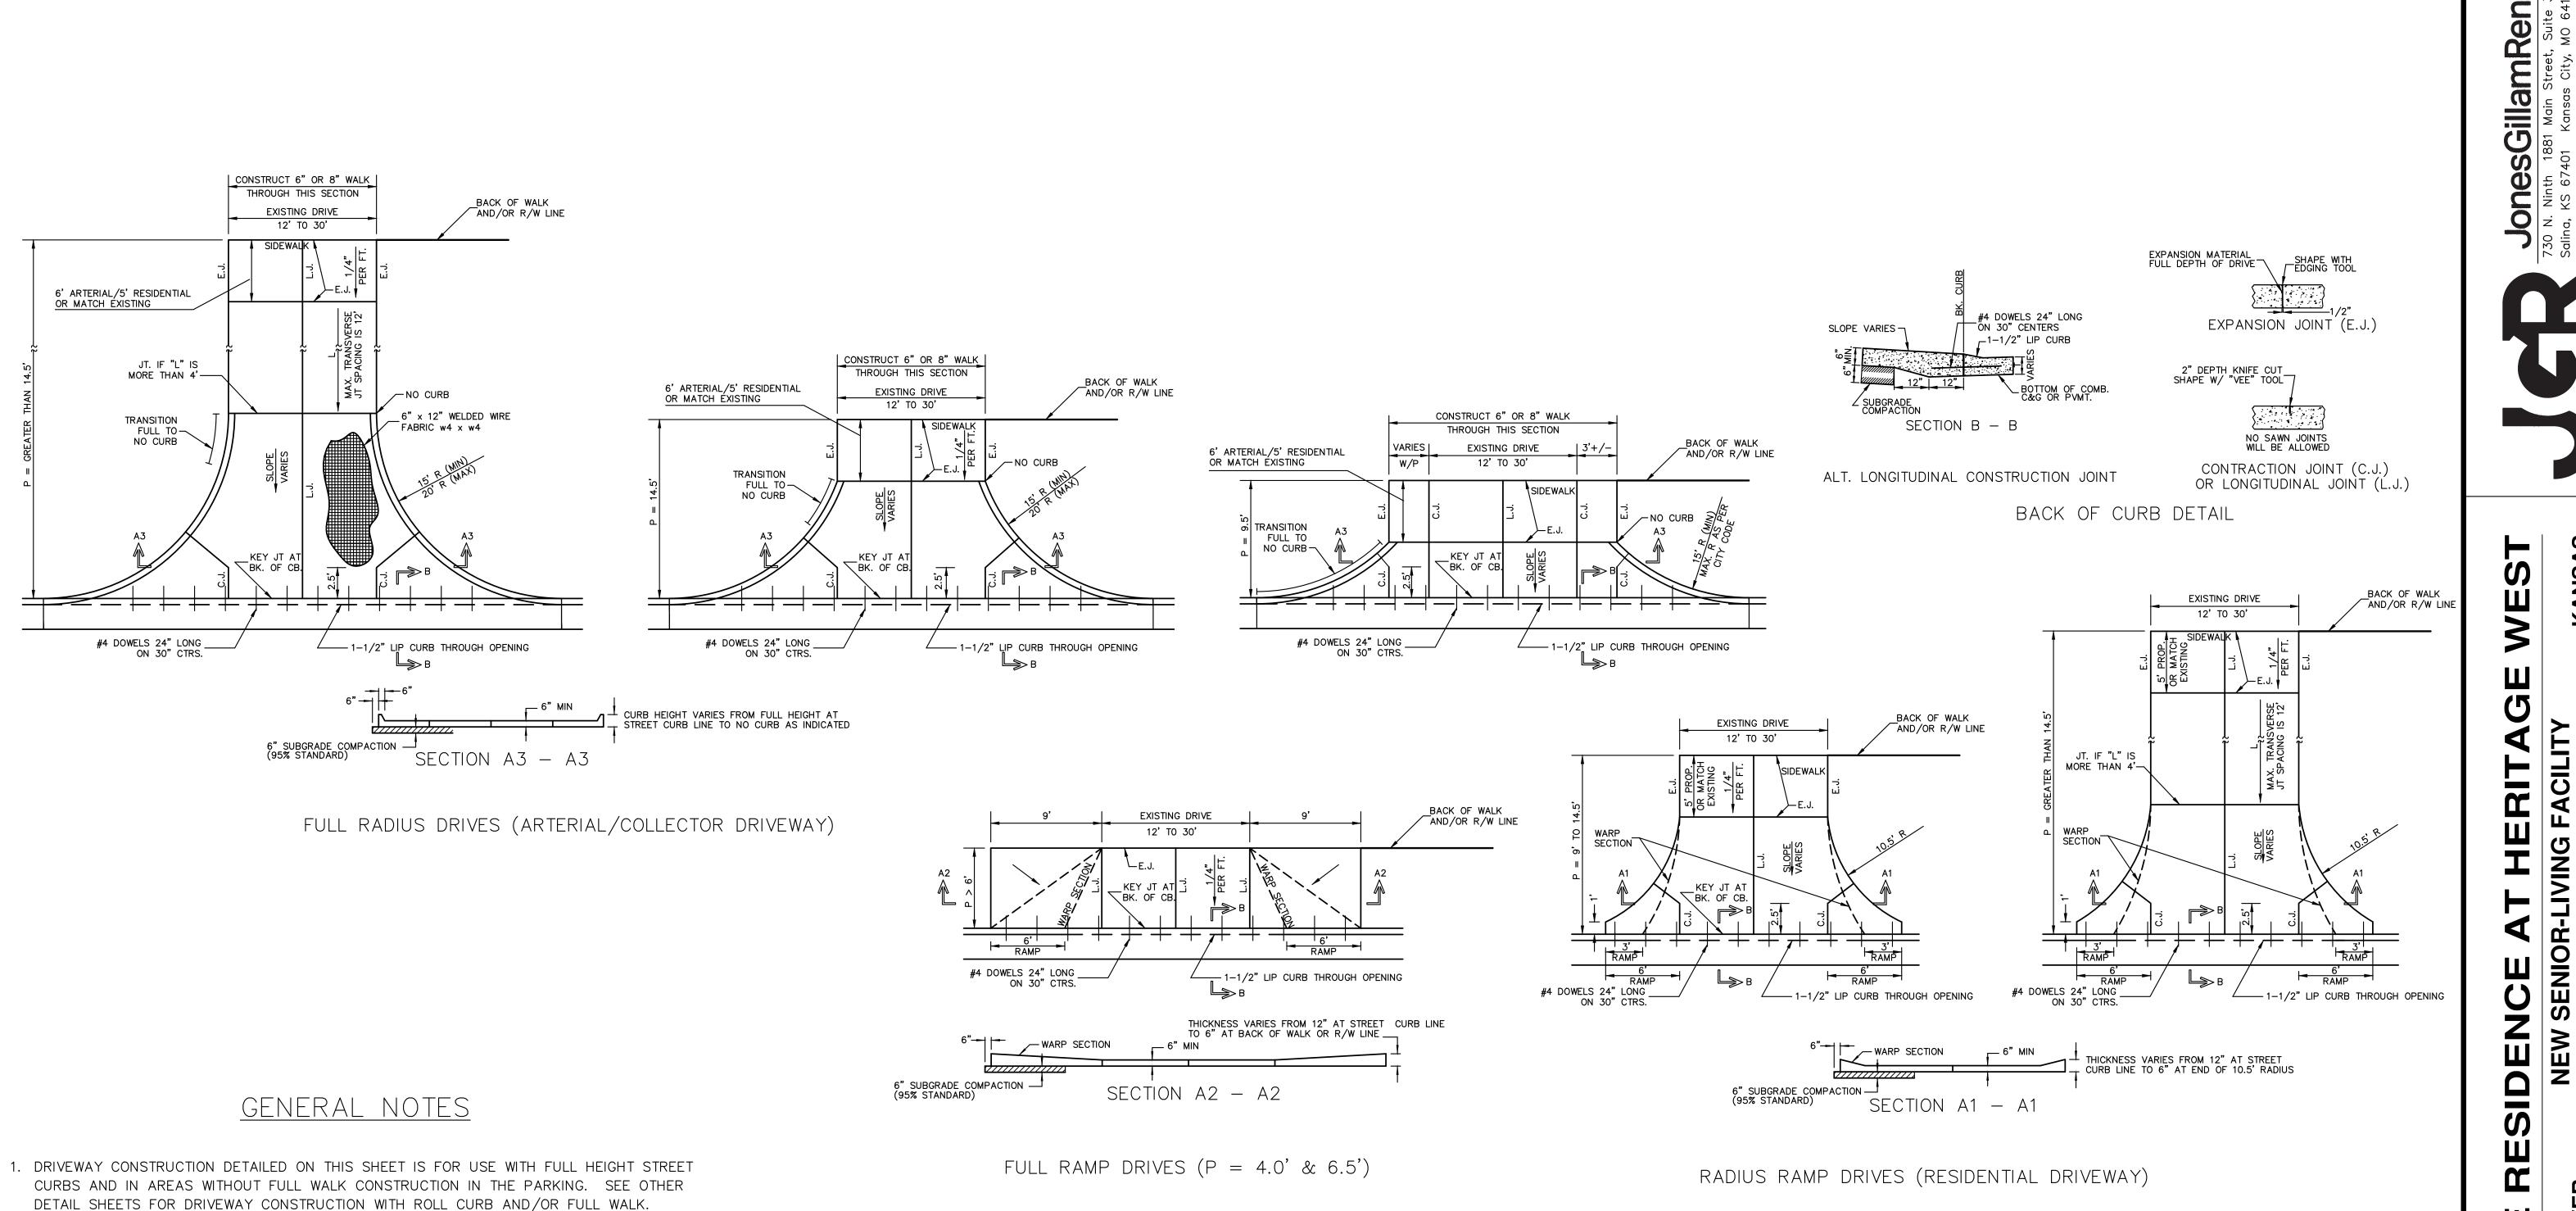- DETAIL SHEETS FOR DRIVEWAY CONSTRUCTION WITH ROLL CURB AND/OR FULL WALK.
- 2. ONE LONGITUDINAL JOINT SHALL BE CONSTRUCTED ALONG THE CENTERLINE OF DRIVES HAVING A WIDTH DIMENSION OF 24' OR LESS. TWO LONGITUDINAL JOINTS SHALL BE CONSTRUCTED WITH EQUAL SPACINGS NOT TO EXCEED 10' FOR DRIVES WITH A WIDTH DIMENSION GREATER THAN 24'.
- 3. DRIVEWAY WIDTH DENOTED AS WIDTH ON THE DETAIL DRAWINGS SHALL BE A MINIMUM OF 12' AND A MAXIMUM OF 30'. THE MAXIMUM OPENING FOR RADIUS TYPE DRIVES WITH CURBS THROUGH THE RADIUS SHALL NOT EXCEED 52' AT THE STREET CURB LINE.
- 4. CONTRACTION JOINT SPACING IN THE DRIVEWAY WALK SECTION SHALL BE A MINIMUM OF 3' AND A MAXIMUM OF 6' AND ARE TO BE EQUALLY SPACED WITHIN THIS RANGE. WALK SECTION SHALL BE CONSTRUCTED TO THE SAME THICKNESS AS THE DRIVEWAY.
- 5. ADDITIONAL THICKNESS OF DRIVE AS INDICATED IN THE DRAWINGS WILL NOT BE PAID FOR DIRECTLY AND THIS COST SHALL BE INCLUDED IN THE UNIT PRICE BID FOR THE DRIVEWAY CONSTRUCTION.
- 6. ONE HALF INCH EXPANSION JOINTS SHALL BE INSTALLED WHEREVER DRIVE CONSTRUCTION ABUTS SIDEWALK. ONE HALF INCH EXPANSION JOINTS SHALL ALSO BE INSTALLED ALONG THE PROPERTY LINE AND/OR BACK OF WALK LINE WHEN DRIVE CONSTRUCTION ALONG THIS LINE ABUTS CONCRETE PARKING LOTS OR CONCRETE DRIVE EXTENSION.
- 7. DRIVEWAYS ONLY ON RESIDENTIAL PROPERTIES ONLY CAN BE CONSTRUCTED WITH 6" IN THICKNESS AND CAN BE WITHOUT REINFORCEMENT.
- 8. ALL DRIVEWAYS TO NONRESIDENTIAL PROPERTY SHALL BE A MINIMUM OF 8" IN THICKNESS AND SHALL HAVE REINFORCEMENT WITH 6"x12", W4xW4.

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DATE: JOB: SHEET NO.: C2	1-3-2025 24-3385 .54	

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REMOVE & REPLACE EXISTING 6" SIDEWALK AS NECESSARY TO ACHIEVE ADA SLOPES UNDER 5%.

NOTES

- 1. ALL SPOT ELEVATIONS REPRESENT FINISHED SURFACE OR FLOW LINE GRADES, UNLESS OTHERWISE NOTED. TOP OF CURB ELEVATIONS WILL BE 6" ABOVE THE FLOW LINE ELEVATIONS, UNLESS OTHERWISE NOTED.
- 2. ALL CURB SPOT ELEVATIONS ARE EDGE OF PAVEMENT UNLESS OTHERWISE NOTED.
- 3. SPOT ELEVATIONS SHALL TAKE PRECEDENCE OVER SLOPE LABELS AT ALL TIMES.
- GRADES IN ALL SIDEWALK, ACCESSIBLE ROUTES, INCLUDING DRIVEWAYS CROSSINGS SHALL CONFORM TO ALL APPLICABLE ACCESSIBLE STANDARDS: NOT TO EXCEED 5% ALONG TRAVEL PATH WITH NOT MORE THAN 2% CROSS SLOPE AND NOT TO EXCEED 2% IN ANY DIRECTION IN ACCESSIBLE PARKING AREAS. 5. MAXIMUM SLOPE IN TURF AREAS SHALL BE 4:1.
- 6. REFER TO GEOTECHNICAL REPORT PREPARED FOR THIS PROJECT BY TERRACON,
- PROJECT #01245160 DATED NOVEMBER 4, 2024. CONTRACTOR SHALL REFER TO REPORT FOR RECOMMENDED PAVEMENT THICKNESS, SUBGRADE PREPARATION AND TRENCH BACKFILLING. IF ANY DISCREPANCIES ARISE BETWEEN THE PLANS, SPECIFICATIONS AND GEOTECHNICAL REPORT, THEN THE MORE STRINGENT REQUIREMENT SHALL GOVERN.
- 7. SATISFACTORY SOIL AND FILL MATERIAL SHALL BE PROVIDED PER THE GEOTECHNICAL REPORT. SEE GEOTECHNICAL REPORT FOR MAXIMUM FILL LIFT THICKNESS
- 8. CLEAR AND GRUB IMPROVEMENT AREA. REMOVE ALL ORGANIC AND TOPSOIL MATERIAL REGARDLESS OF SIZE AND DEPTH. ALL CLEARED. EXCESS AND WASTE MATERIAL SHALL BECOME CONTRACTORS PROPERTY AND SHALL BE REMOVED FROM THE PROJECT SITE.
- 9. THE CONTRACTOR SHALL BE RESPONSIBLE TO DETERMINE EARTHWORK QUANTITIES. ALL IMPORT AND EXPORT OF SOIL MATERIAL SHALL BE THE RESPONSIBILITY OF THE CONTRACTOR AT THEIR EXPENSE.
- 10. NOTIFY TESTING AGENCY WHEN EXCAVATIONS HAVE REACHED REQUIRED SUBGRADE. SUBGRADE SHALL BE PREPARED AND COMPACTED PER THE GEOTECHNICAL REPORT.
- 11. LANDSCAPING ITEMS INCLUDING FENCE PROTECTION ARE SHOWN ON THIS PLAN FOR VISUAL PURPOSES ONLY. REF: LANDSCAPING PLANS FOR ALL TREE PRESERVATION, PROTECTION AND REMOVAL DESIGN ITEMS.
- 12. SITE GRADING SHALL NOT CAUSE ADVERSE DRAINAGE IMPACTS TO NEIGHBORING PROPERTIES.


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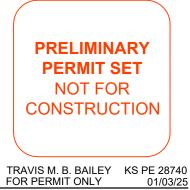
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UGT	EXISTING UNDERGROUND TELEPHONE
TV	EXISTING TV LINE
¢	EXISTING LIGHT POLE
XXXX	EXISTING GRADES
XXXX	PROPOSED GRADES
	GRADING LIMITS
506.50	SPOT ELEVATION
506.50EX	MATCH EXISTING ELEVATION
506.50FL	FLOWLINE
506.50RIM	INLET RIM ELEVATION

SCALE: 1"=20'

WARNING

EXISTING UNDERGROUND UTILITIES IN THE AREA CONTRACTOR IS RESPONSIBLE FOR DETERMINING THE HORIZONTAL AND VERTICAL LOCATION OF ALL UTILITIES PRIOR TO CONSTRUCTION. CONTRACTOR IS RESPONSIBLE FOR ANY REPAIRS TO EXISTING UTILITIES DUE TO DAMAGE INCURRED DURING CONSTRUCTION CONTRACTOR SHALL NOTIFY THE ENGINEER OF ANY DISCREPANCIES ON THE PLANS.




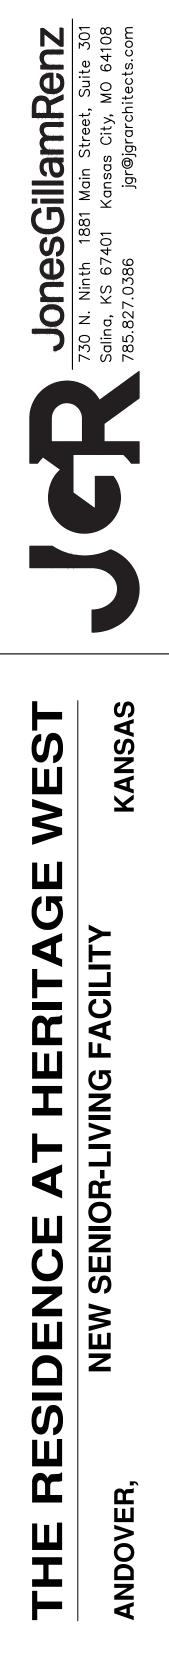


REVISION:

1-3-2025 DATE 24-3385 JOB: SHEET NO .:

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NOTES

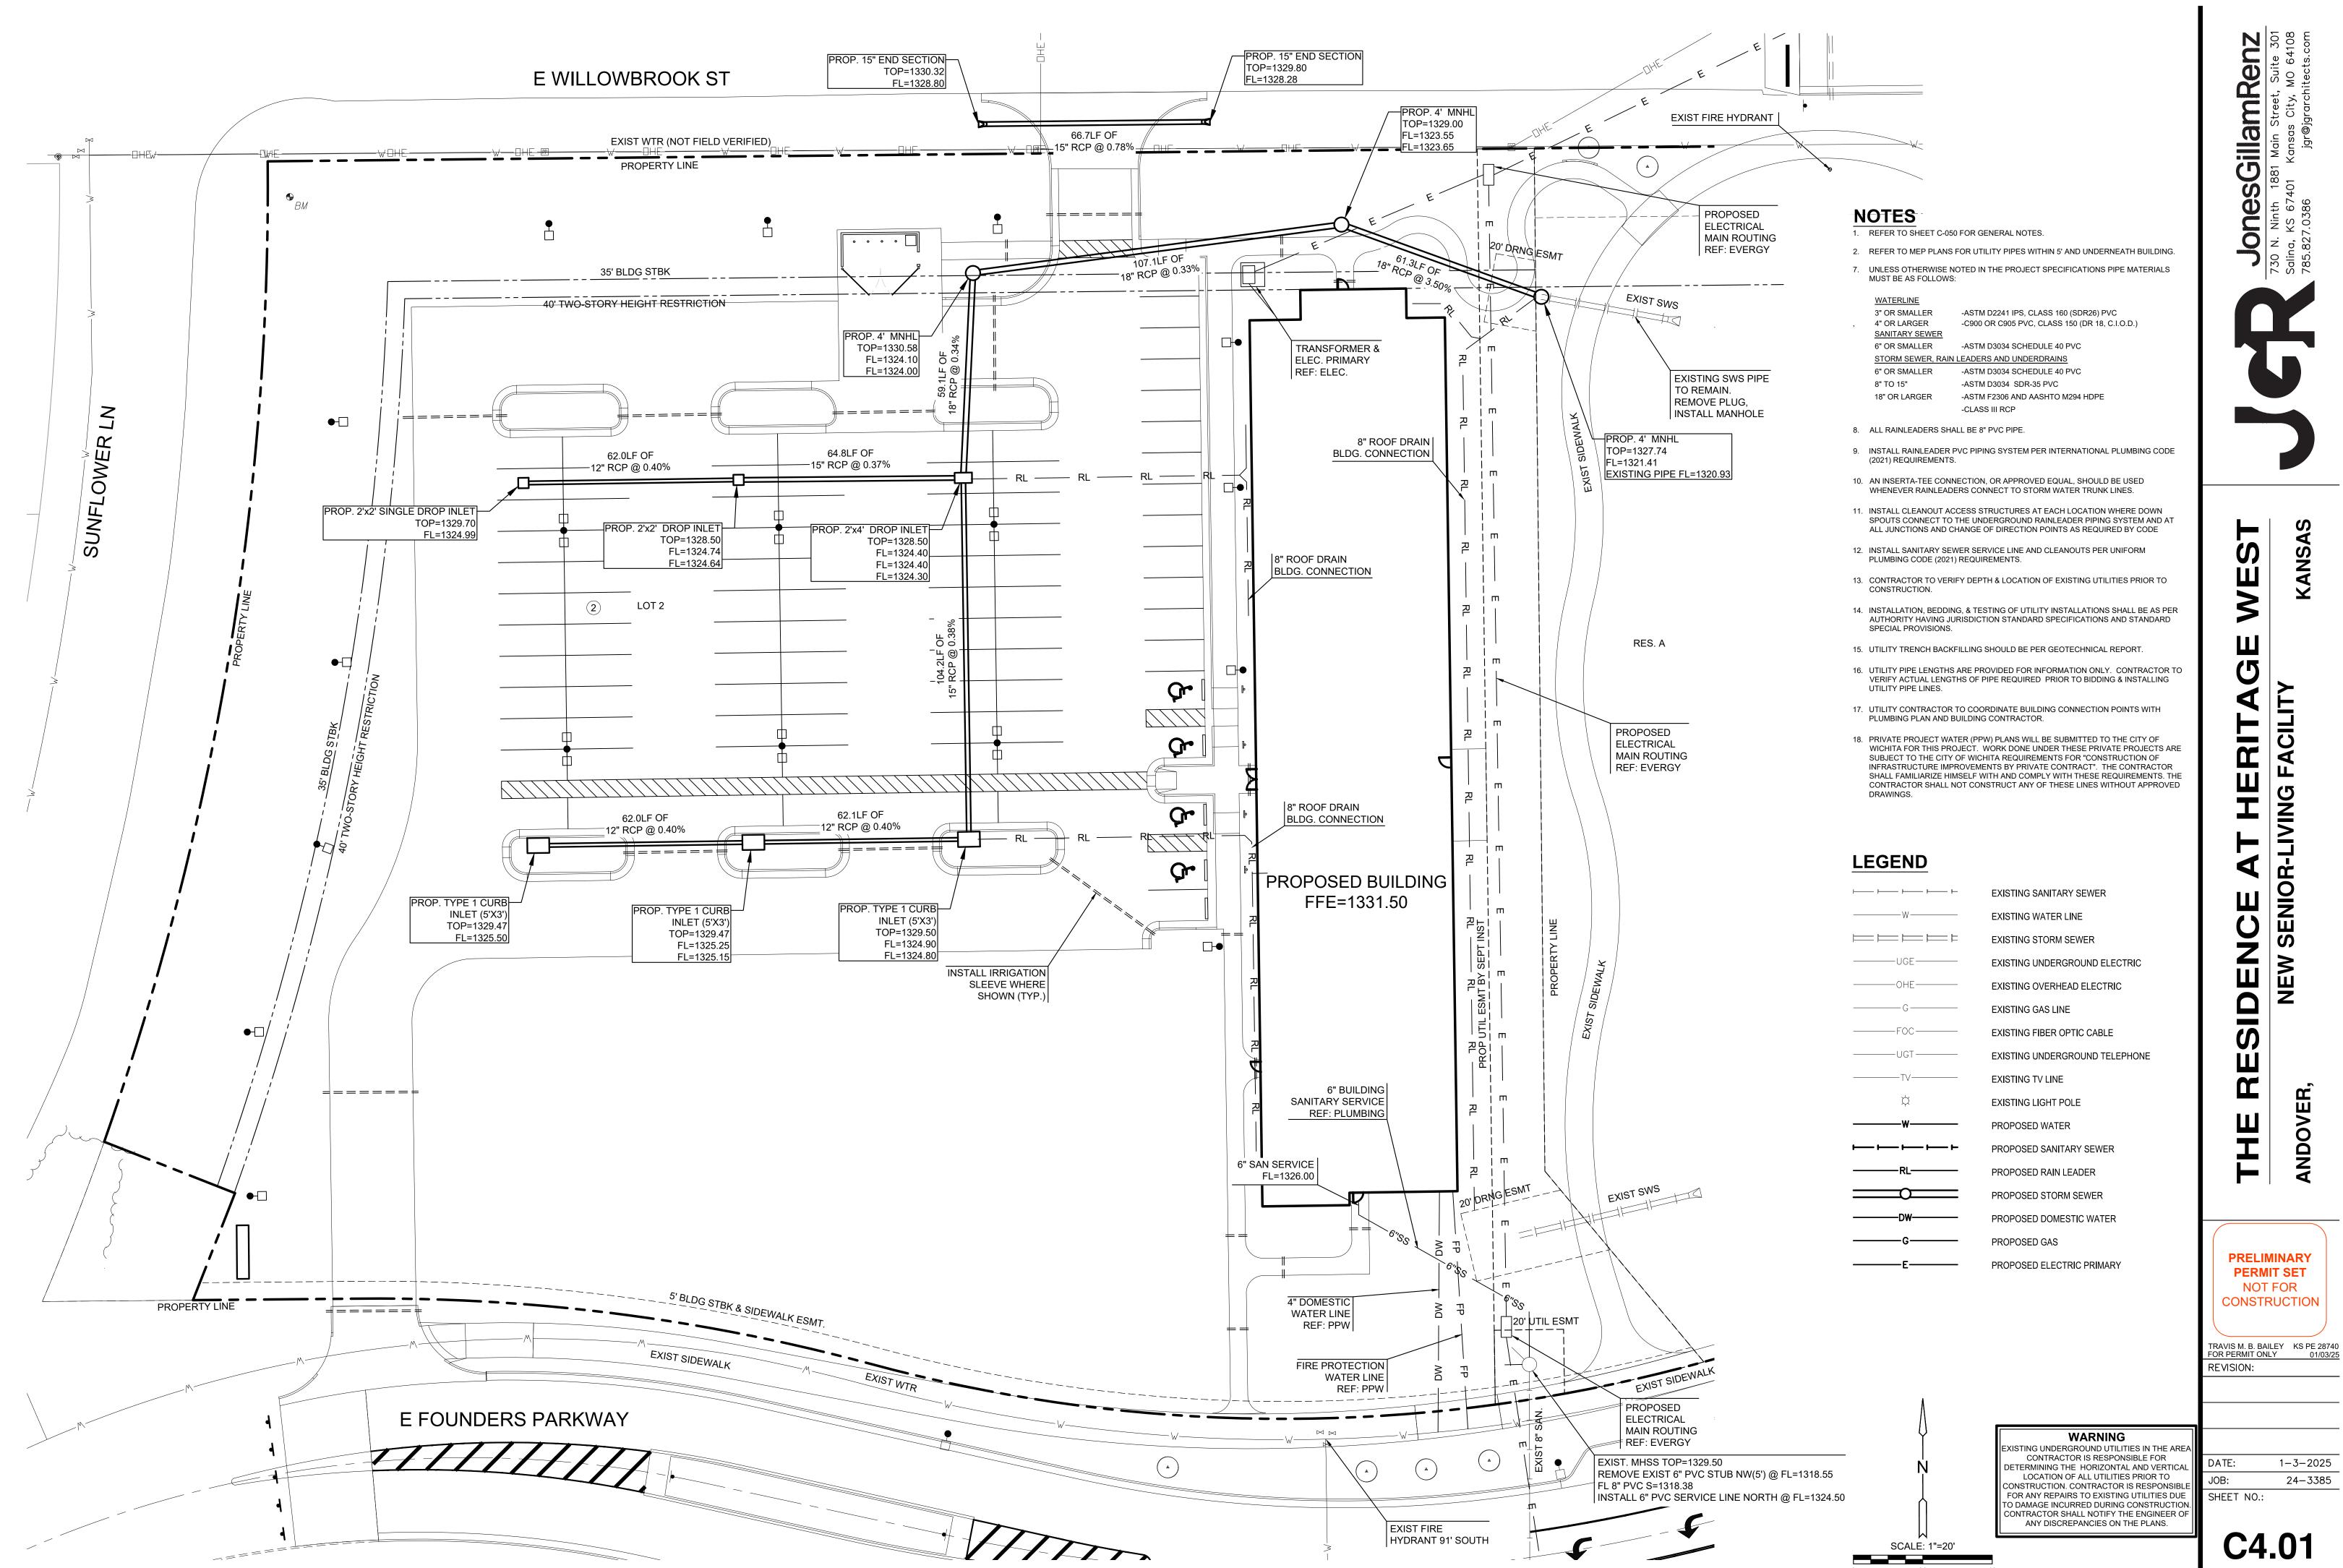2. EROSION CONTROL MEASURES MAY ONLY BE PLACED IN FRONT OF INLETS, OR IN CHANNELS, DRAINAGE WAYS OR BORROW DITCHES AT RISK OF CONTRACTOR. CONTRACTOR SHALL REMAIN LIABLE FOR ANY DAMAGE CAUSED BY THE MEASURES, INCLUDING FLOODING DAMAGE, WHICH MAY OCCUR DUE TO BLOCKED DRAINAGE. AT THE CONCLUSION OF ANY PROJECT, ALL CHANNELS, DRAINAGE WAYS AND BORROW DITCHES IN THE WORK ZONE SHALL BE DREDGED OF ANY SEDIMENT GENERATED BY THE PROJECT OR DEPOSITED AS A RESULT OF EROSION CONTROL MEASURES.

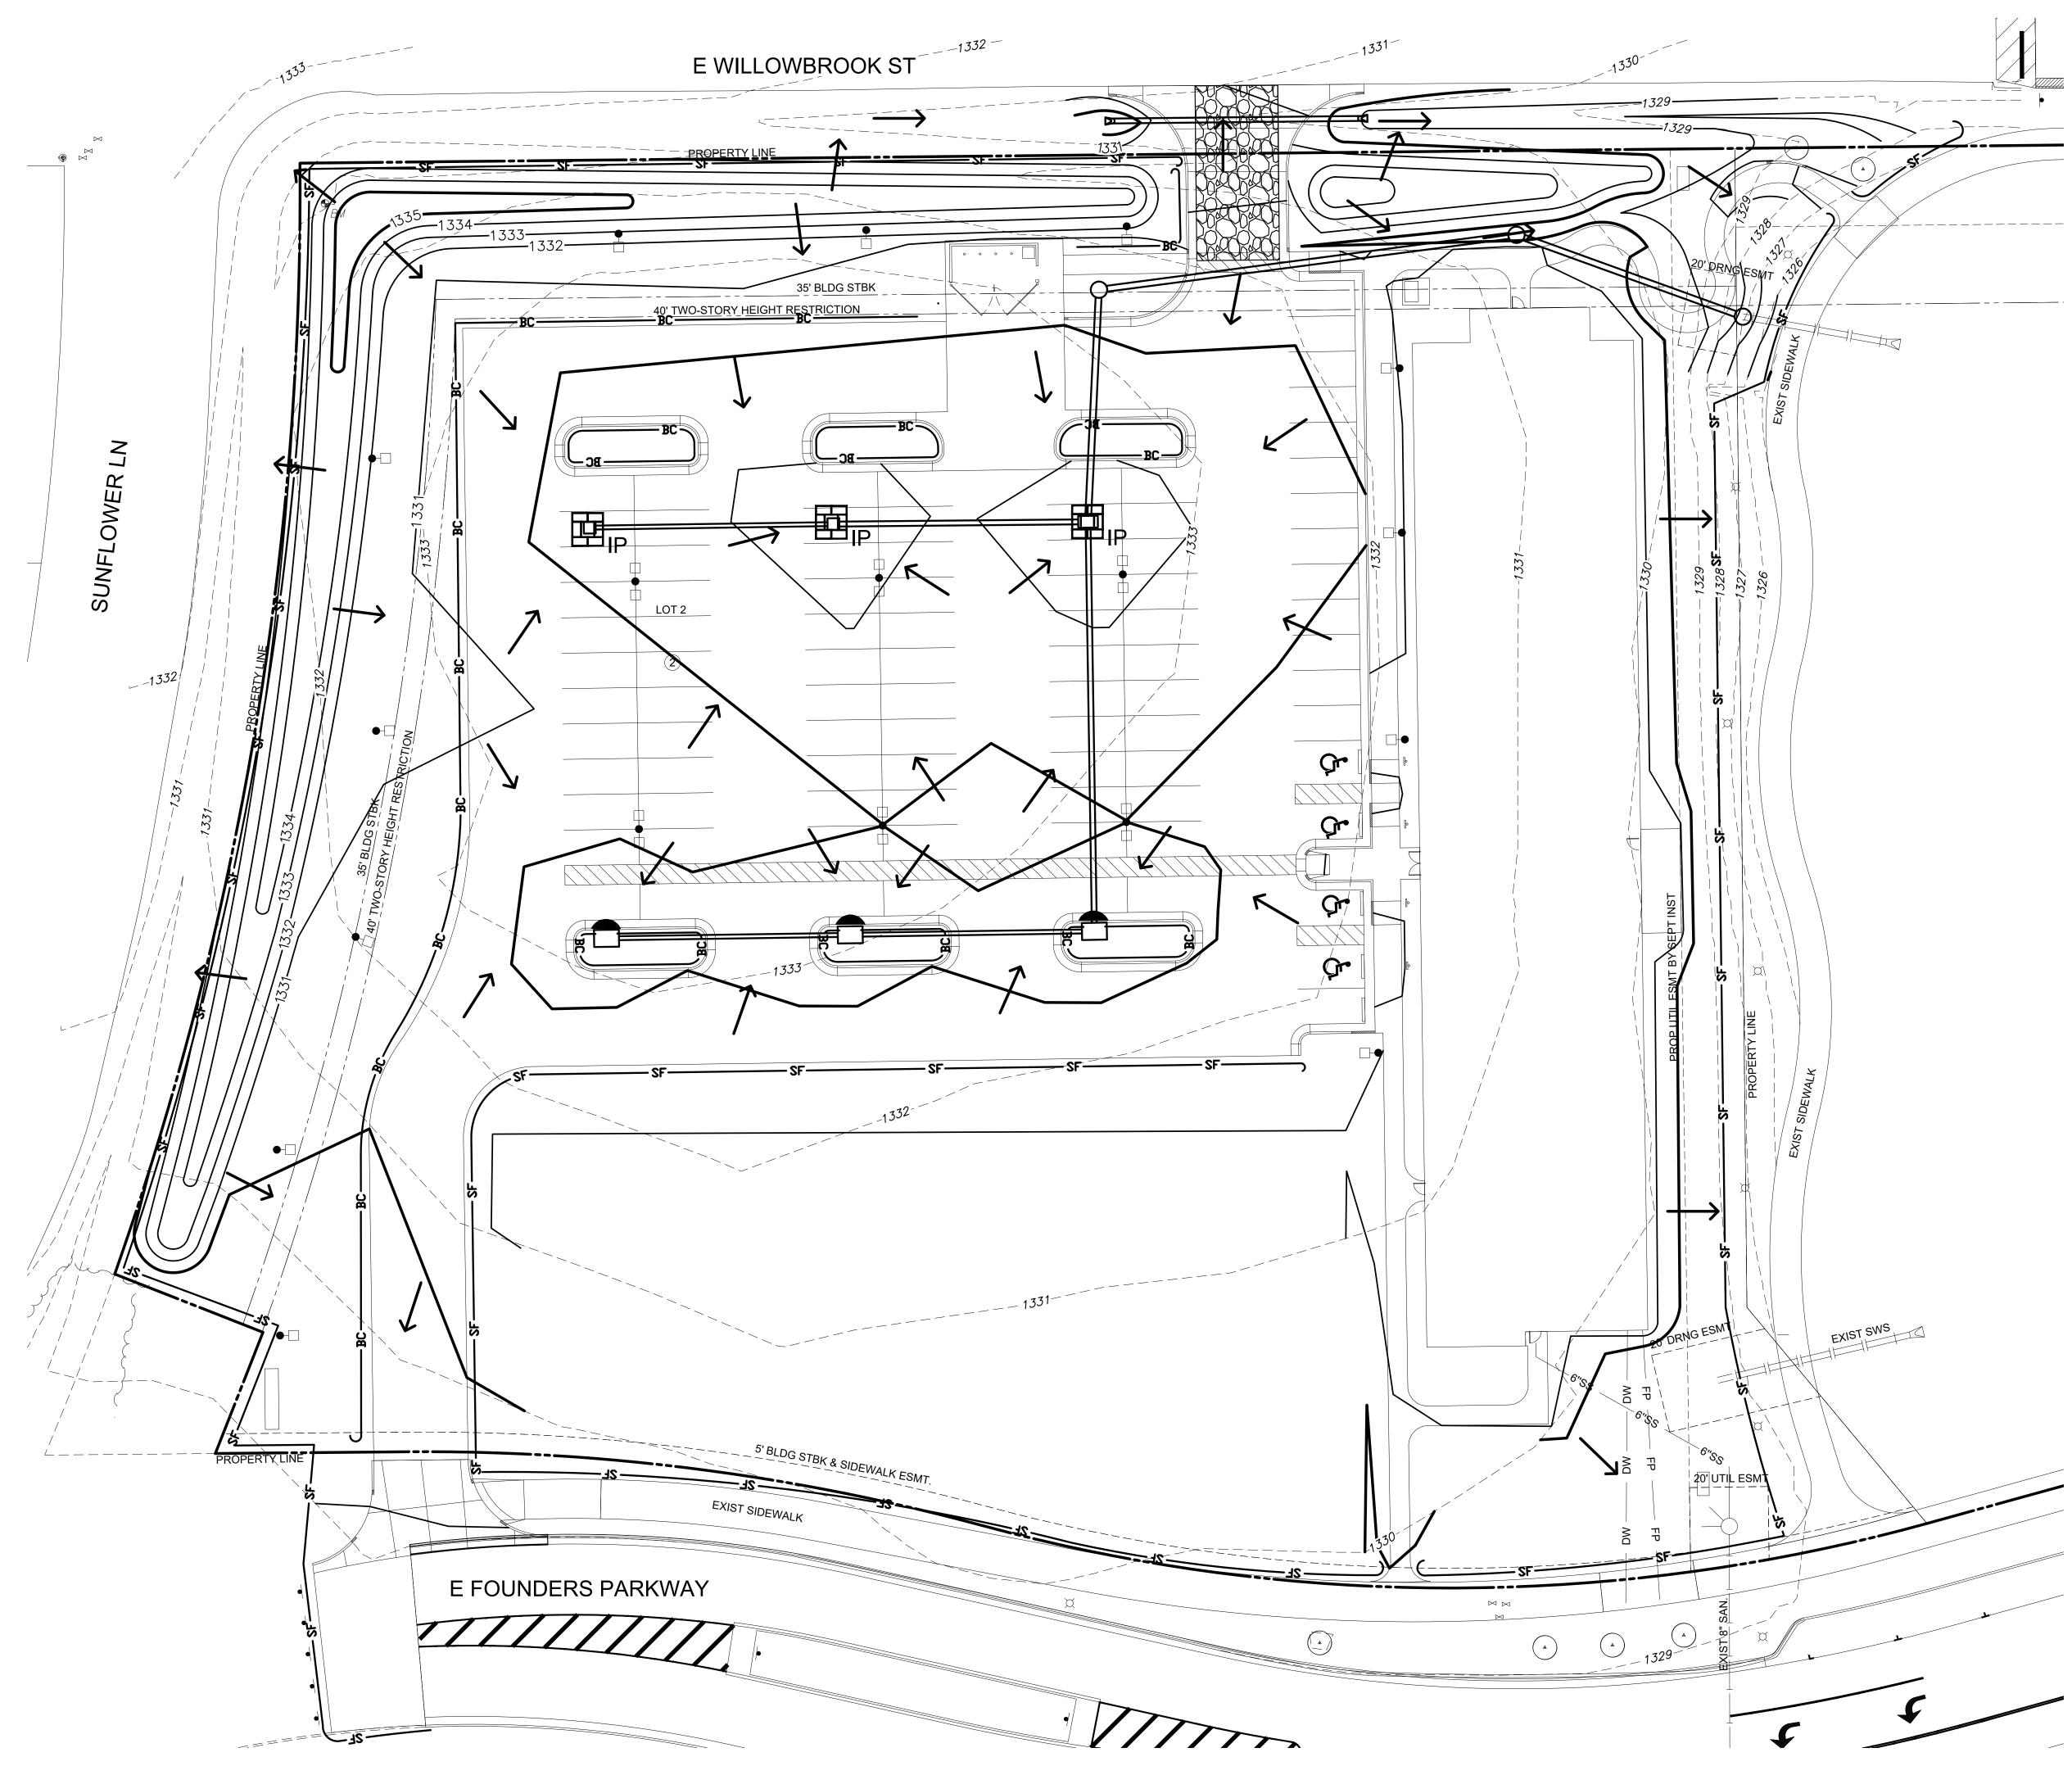1. EROSION CONTROL SHOULD MEET ALL FEDERAL, STATE, COUNTY AND LOCAL CODE STANDARDS.

- 3. SEE SEEDING NOTES FOR DISTURBED AREA STABILIZATION OUTSIDE OF HARDSCAPE AND LANDSCAPE AREAS.
- 4. THE CONTRACTOR SHALL COMPLETE STABILIZATION WHEN SOIL DISTURBING ACTIVITIES CEASE TEMPORARILY AND WILL NOT RESUME FOR 14 DAYS OR MORE.
- 5. CONTRACTOR SHALL PROVIDE EROSION PROTECTION THROUGHOUT PROJECT CONSTRUCTION. THE PLAN PROVIDED HERE WITHIN IS FOR FINAL PROTECTION. VARIOUS PHASES OF THIS PLAN SHALL BE IMPLEMENTED OR MODIFIED TO CONTROL EROSION.
- 6. THE CONTRACTOR(S) ARE RESPONSIBLE FOR EROSION CONTROL IN CONFORMATION WITH THE APPROVED DRAWINGS UNTIL PROJECT COMPLETION.
- 7. ALL EXISTING AND PROPOSED EROSION CONTROL MEASURES SHALL BE INSTALLED PER THE STORMWATER POLLUTION PREVENTION PLAN (SWPPP) AND INFORMATION PROVIDED IN THESE PLANS AND MAINTAINED THROUGHOUT CONSTRUCTION BY THE CONTRACTOR UNTIL THE PROJECT IS COMPLETED AND THE EROSION CONTROL MEASURES ARE NO LONGER NEEDED. THE CONTRACTOR SHALL BE REQUIRED TO COMPLY WITH MAINTENANCE AND/OR REPLACEMENT OF EROSION CONTROL MEASURES AS DETERMINED BY THE ENGINEER UNTIL PROJECT IS ACCEPTED OR THE EROSION CONTROL MEASURES ARE NO LONGER NEEDED.
- 8. IN ORDER TO PREVENT SILT OR SEDIMENT FROM ENTERING ADJACENT PROPERTIES, APPROPRIATE BMP'S SHALL BE IMPLEMENTED WITHIN THE PROJECT.
- 9. ANY MUD TRACKED ONTO ADJACENT PAVED AREAS OR STREETS SHALL BE REMOVED AT THE END OF EACH WORK DAY.
- 10. PER THE REQUIREMENTS OF THE NOI/SWPPP, BMP INSPECTION REPORTS SHALL BE COMPLETED BY THE CONTRACTOR WEEKLY AND WITHIN 24 HOURS AFTER A 1/2" RAIN. REPORTS SHALL BE KEPT WITH THE SWPPP ON SITE.
- 11. LANDSCAPING ITEMS INCLUDING FENCE PROTECTION ARE SHOWN ON THIS PLAN FOR VISUAL PURPOSES ONLY. REF: LANDSCAPING PLANS FOR ALL TREE PRESERVATION, PROTECTION AND REMOVAL DESIGN ITEMS.

EXISTING SANITARY SEWER

EXISTING WATER LINE

- 12. CONTRACTOR SHALL PROVIDE A SIGN NEAR THE ENTRANCE WITH THE FOLLOWING INFORMATION A. CONTACT NAME AND INFORMATION
- B. A COPY OF THE NOIC. LOCATION OF SWPPP
- LEGEND
- $\vdash \hspace{1.5cm} \vdash \hspace{1.5cm} \vdash \hspace{1.5cm} \vdash \hspace{1.5cm} \vdash \hspace{1.5cm} \vdash$ ______W _____

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EXISTING STORM SEWER EXISTING UNDERGROUND ELECTRIC EXISTING OVERHEAD ELECTRIC EXISTING GAS LINE EXISTING FIBER OPTIC CABLE EXISTING UNDERGROUND TELEPHONE EXISTING TV LINE EXISTING LIGHT POLE EXISTING GRADES PROPOSED GRADES SILT FENCE BACK OF CURB PROTECTION

CONSTRUCTION ENTRANCE

FLOW PATH

AREA INLET PROTECTION

CURB INLET PROTECTION

WARNING EXISTING UNDERGROUND UTILITIES IN THE AREA CONTRACTOR IS RESPONSIBLE FOR

DETERMINING THE HORIZONTAL AND VERTICAL LOCATION OF ALL UTILITIES PRIOR TO CONSTRUCTION. CONTRACTOR IS RESPONSIBLE FOR ANY REPAIRS TO EXISTING UTILITIES DUE TO DAMAGE INCURRED DURING CONSTRUCTION CONTRACTOR SHALL NOTIFY THE ENGINEER OF ANY DISCREPANCIES ON THE PLANS.



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TRAVIS M. B. BAILEYKS PE 28740FOR PERMIT ONLY01/03/25


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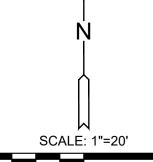
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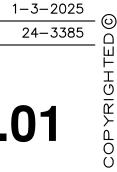
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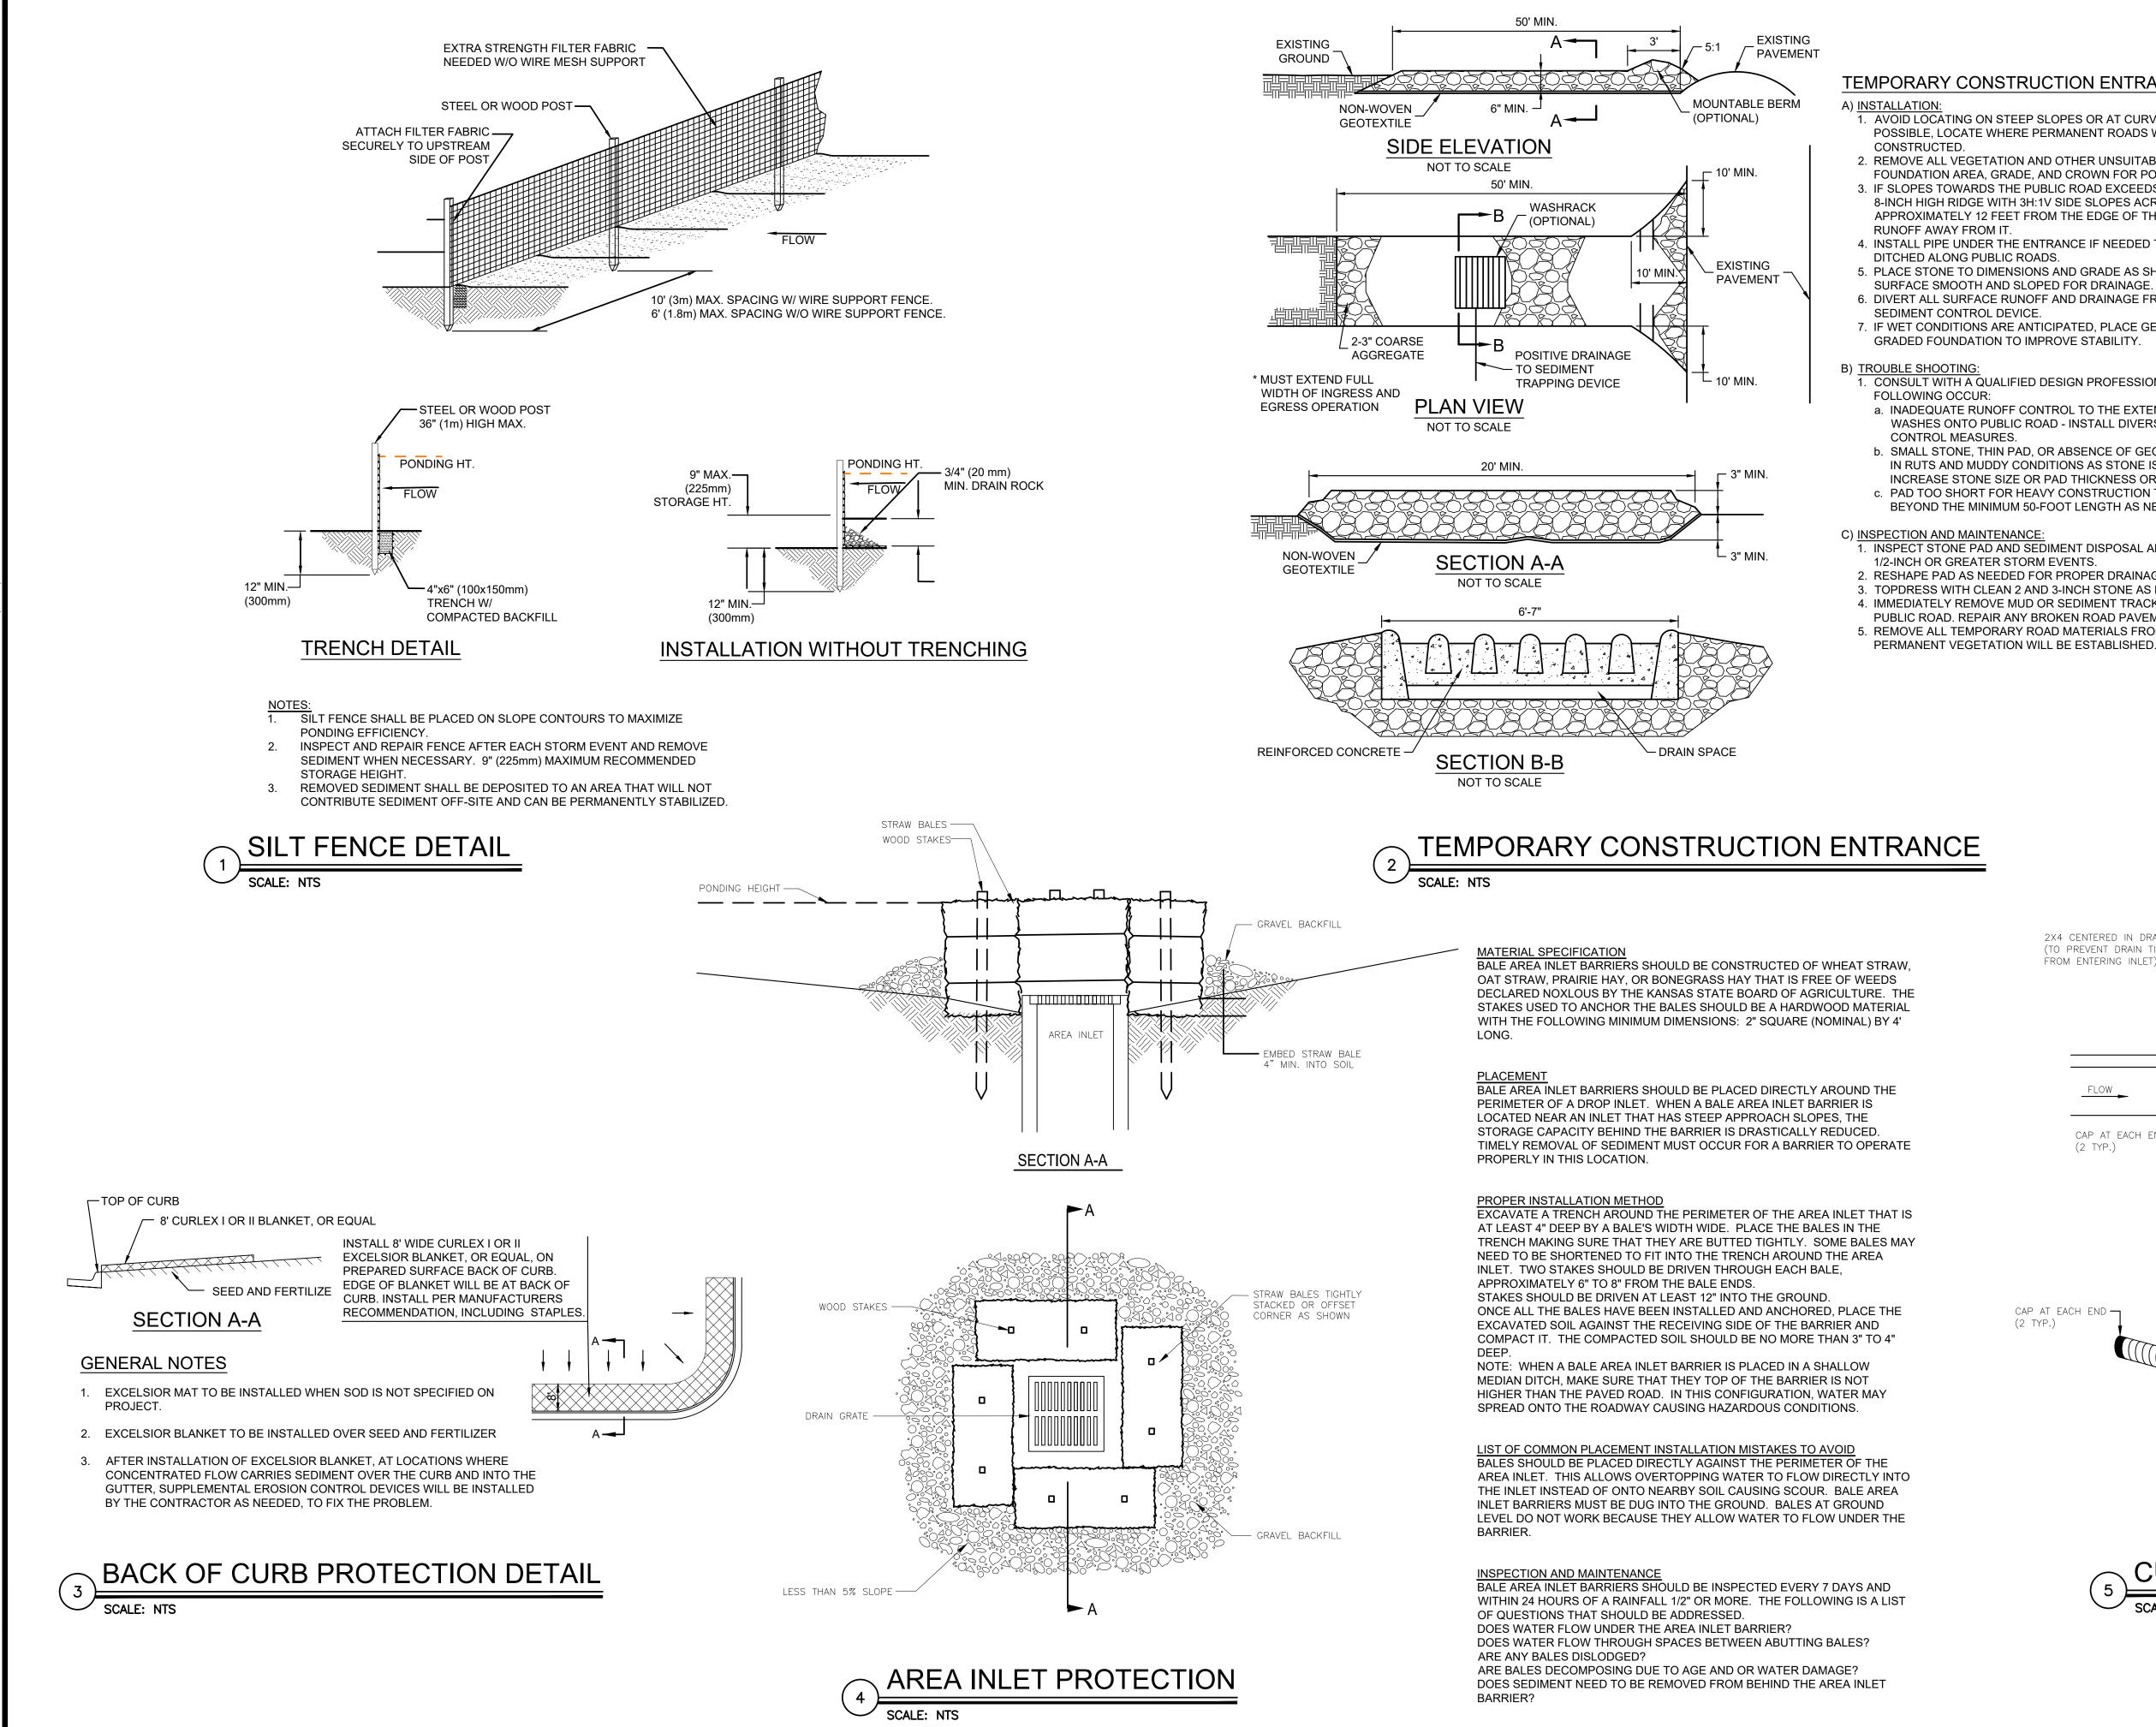
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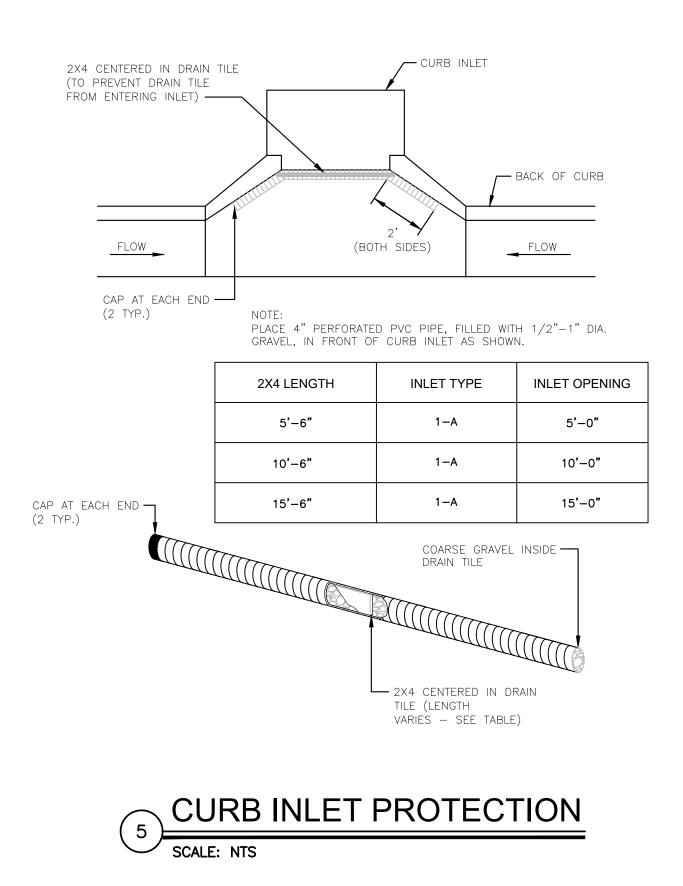
TEMPORARY CONSTRUCTION ENTRANCE PAD NOTES:

1. AVOID LOCATING ON STEEP SLOPES OR AT CURVES ON PUBLIC ROADS. IF POSSIBLE, LOCATE WHERE PERMANENT ROADS WILL EVENTUALLY BE

- 2. REMOVE ALL VEGETATION AND OTHER UNSUITABLE MATERIAL FROM THE FOUNDATION AREA, GRADE, AND CROWN FOR POSITIVE DRAINAGE. 3. IF SLOPES TOWARDS THE PUBLIC ROAD EXCEEDS 2%, CONSTRUCT A 6 TO 8-INCH HIGH RIDGE WITH 3H:1V SIDE SLOPES ACROSS THE FOUNDATION APPROXIMATELY 12 FEET FROM THE EDGE OF THE PUBLIC ROAD TO DIVERT
- 4. INSTALL PIPE UNDER THE ENTRANCE IF NEEDED TO MAINTAIN DRAINAGE DITCHED ALONG PUBLIC ROADS.
- 5. PLACE STONE TO DIMENSIONS AND GRADE AS SHOWN ON PLANS. LEAVE SURFACE SMOOTH AND SLOPED FOR DRAINAGE.
- 6. DIVERT ALL SURFACE RUNOFF AND DRAINAGE FROM THE ENTRANCE TO A SEDIMENT CONTROL DEVICE. 7. IF WET CONDITIONS ARE ANTICIPATED, PLACE GEOTEXTILE FABRIC ON THE
- GRADED FOUNDATION TO IMPROVE STABILITY.


- 1. CONSULT WITH A QUALIFIED DESIGN PROFESSIONAL IF ANY OF THE
- a. INADEQUATE RUNOFF CONTROL TO THE EXTENT THAT SEDIMENT WASHES ONTO PUBLIC ROAD - INSTALL DIVERSIONS OR OTHER RUNOFF CONTROL MEASURES.
- b. SMALL STONE, THIN PAD, OR ABSENCE OF GEOTEXTILE FABRIC RESULTS IN RUTS AND MUDDY CONDITIONS AS STONE IS PRESSED INTO SOIL -INCREASE STONE SIZE OR PAD THICKNESS OR ADD GEOTEXTILE FABRIC. c. PAD TOO SHORT FOR HEAVY CONSTRUCTION TRAFFIC - EXTEND PAD BEYOND THE MINIMUM 50-FOOT LENGTH AS NECESSARY.

- 1. INSPECT STONE PAD AND SEDIMENT DISPOSAL AREA WEEKLY AND AFTER 1/2-INCH OR GREATER STORM EVENTS.
- 2. RESHAPE PAD AS NEEDED FOR PROPER DRAINAGE AND RUNOFF CONTROL. 3. TOPDRESS WITH CLEAN 2 AND 3-INCH STONE AS NEEDED. 4. IMMEDIATELY REMOVE MUD OR SEDIMENT TRACKED OR WASHED ONTO
- PUBLIC ROAD. REPAIR ANY BROKEN ROAD PAVEMENT IMMEDIATELY. 5. REMOVE ALL TEMPORARY ROAD MATERIALS FROM AREAS WHERE

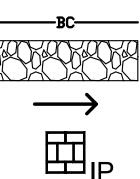





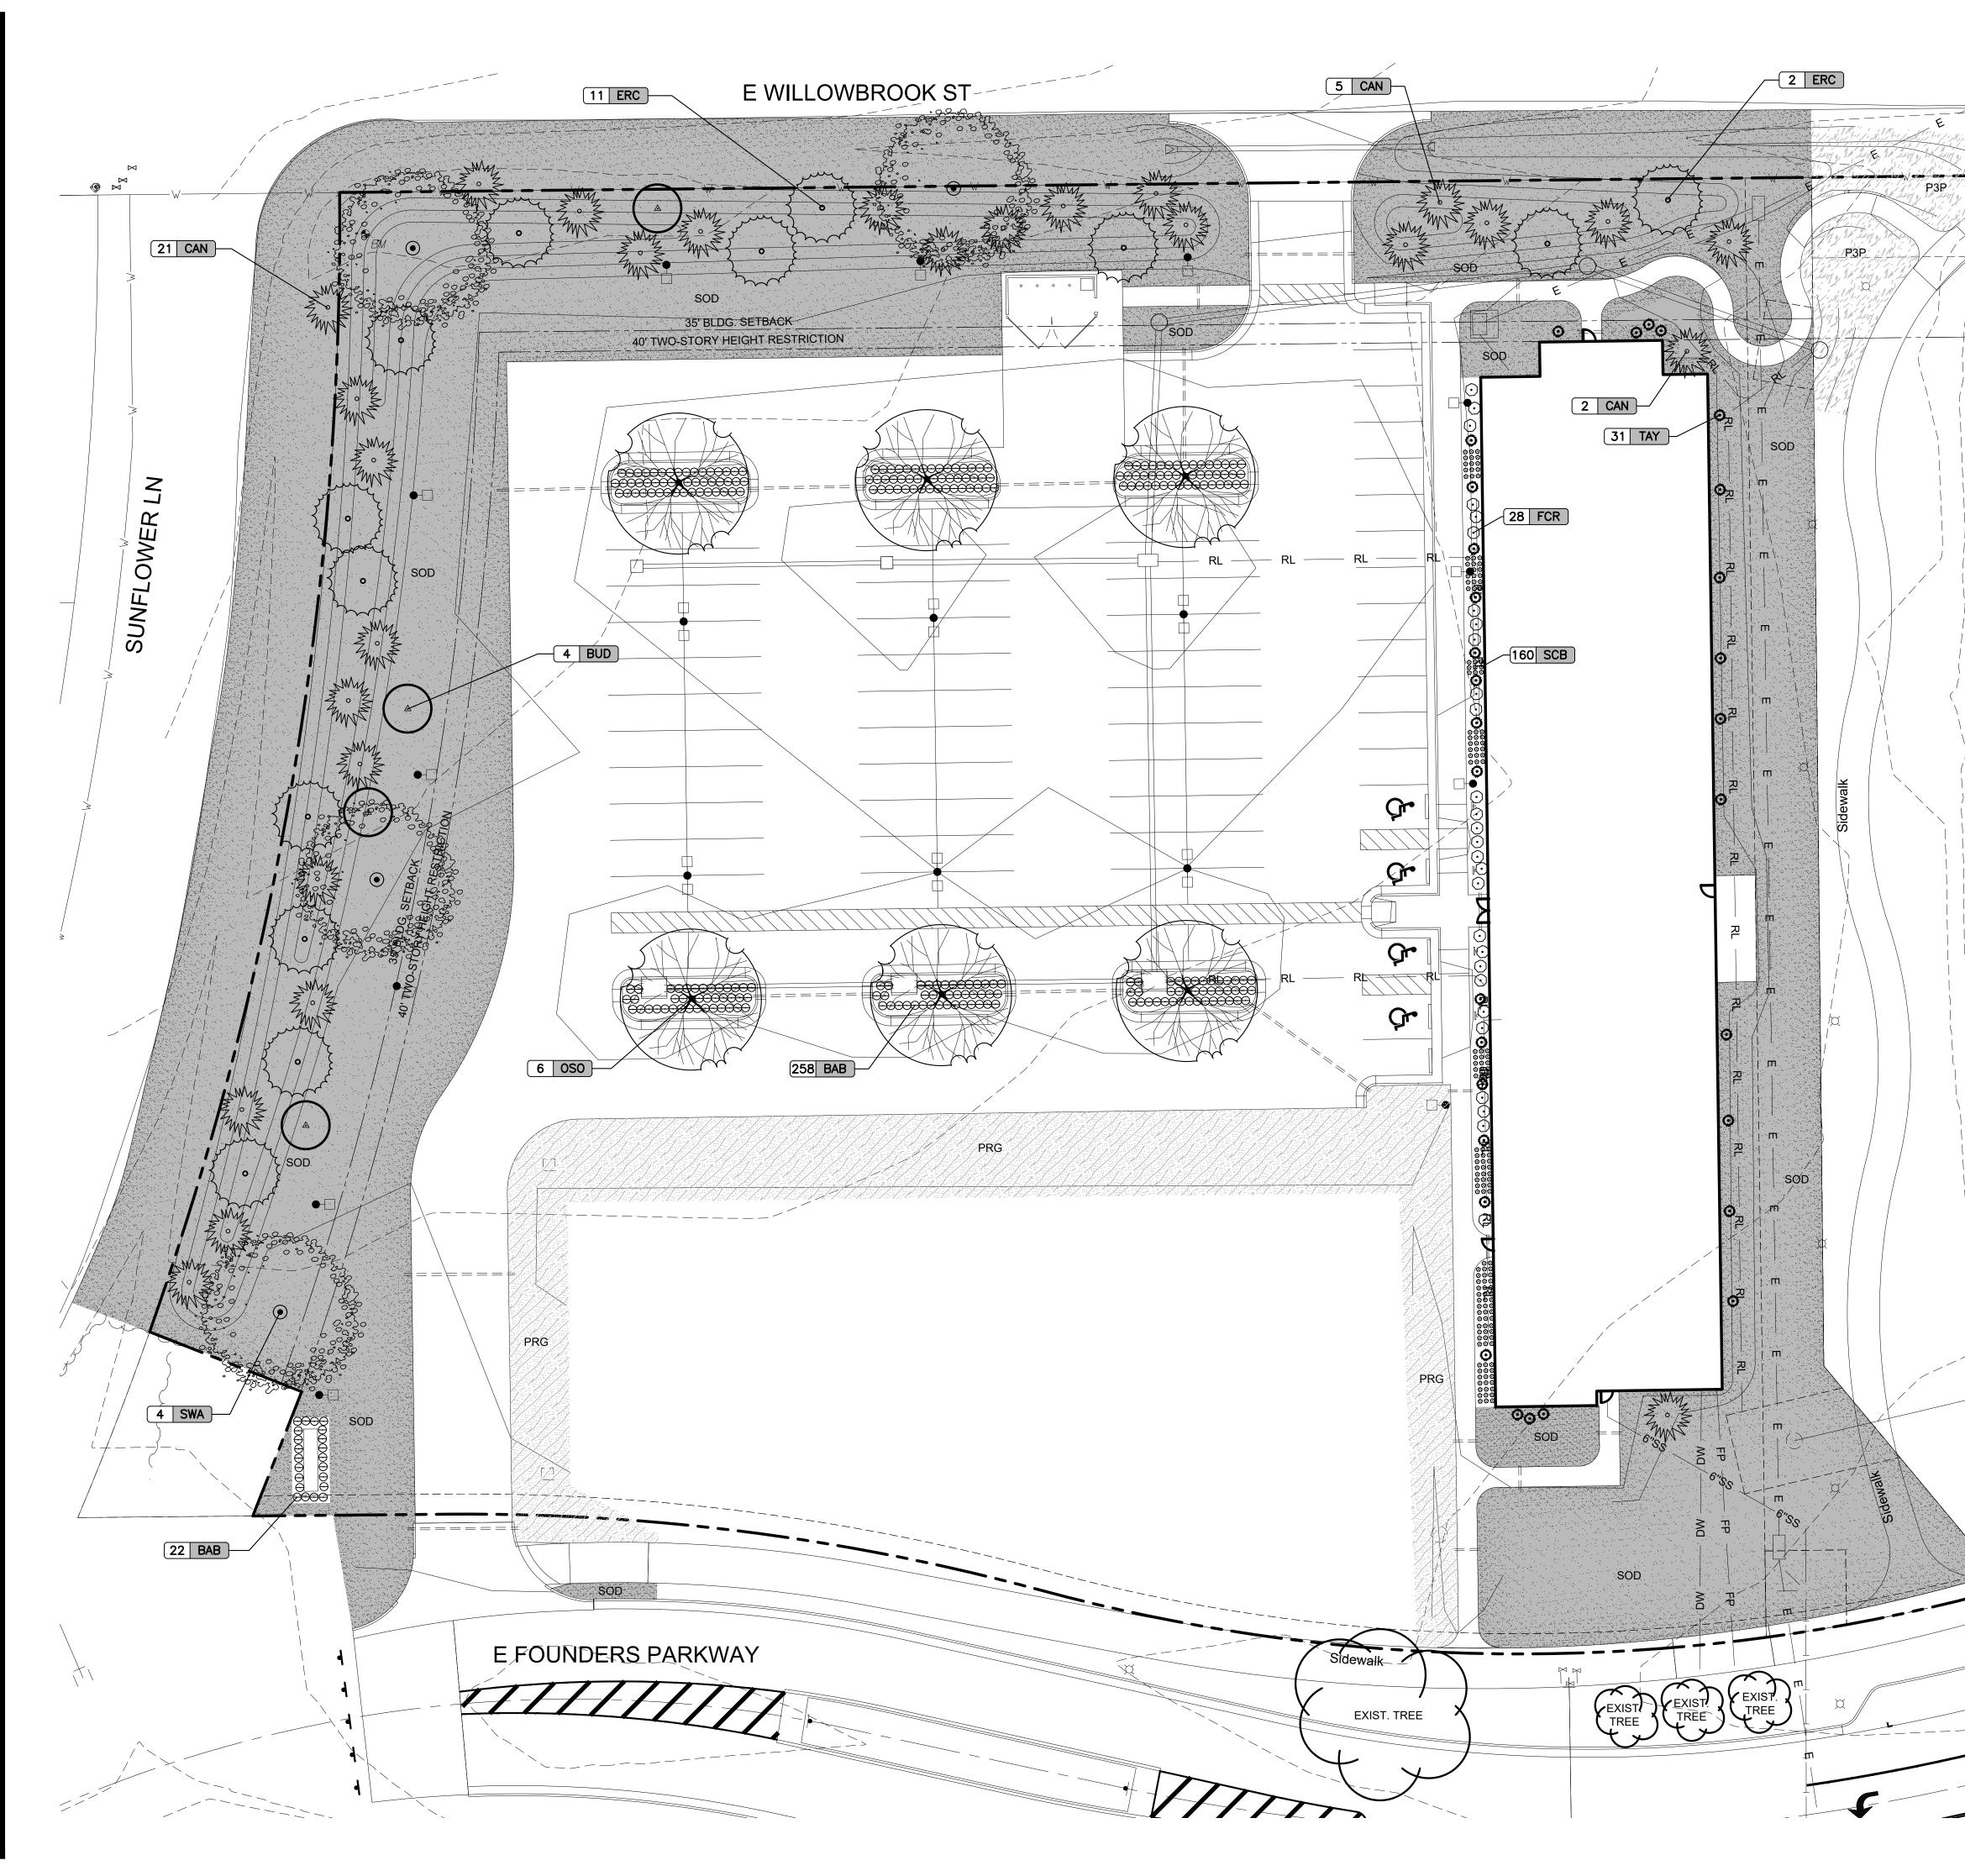



THIS PROJECT IS PART OF THE HERITAGE MIXED-USE SECOND PLANNED UNIT DEVELOPMENT. THE LANDSCAPING PORTION OF THE DEVELOPMENT GUIDELINES STATES THE FOLLOWING:

DUE TO THE URBAN DESIGN OF THIS MIXED-USE PUD, THE LANDSCAPING MAY NOT CONFORM TO ALL ASPECTS OF THE REQUIREMENTS OF THE UDM PART 3.3.4. PARTICULARLY 3.4.7 LANDSCAPING IN STREET YARDS. THE SITE PLAN REVIEW COMMITTEE SHALL USE THE PUD CONCEPT PLAN AND DETAILS THEREIN TO FOCUS DIRECTION AND GOALS IN APPROVING SITE PLANS.

LANDSCAPING CONSISTING OF A 3-FOOT BERM AND 5-FOOT CEDAR TREES PLANTED EVERY 15 FEET SHALL BE REQUIRED ALONG WILLOWBROOK STREET, 400 FEET EAST OF SUNFLOWER LANE AND ALONG SUNFLOWER LANE, 250 FEET SOUTH OF WILLOWBROOK STREET.

STREET YARD CALCULATIONS

FRONTAGE OF SITE = 440'+288'+365'=1,093'-345'(AVE. DEPTH)=748'

LOT DEPTH FACTOR = 15 FEET

 $[\square$

REQUIRED LANDSCAPED STREET YARD = $748 \times 15 = 11,220 \text{ SQ. FT.}$

LANDSCAPED STREET YARD PROVIDED = 17,695 SQ. FT.


STREET YARD TREES REQUIRED = 3 TREES PER 1,000 SQ. FT OF REQUIRED STREET YARD 11.220 x 3 = 33.66 OR 34 TREES

TREES PROVIDED = (48) TREES = 48 TREE EQUIVALENT

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2	END
	EXISTING SANITARY SEWER
	EXISTING WATER LINE
	EXISTING STORM SEWER
	EXISTING UNDERGROUND ELECTRIC
	EXISTING OVERHEAD ELECTRIC
	EXISTING GAS LINE
	EXISTING FIBER OPTIC CABLE
	EXISTING UNDERGROUND TELEPHONE
	EXISTING TV LINE
	EXISTING LIGHT POLE
	EXISTING GRADES
	PROPOSED GRADES
	PROPOSED GRADING MINOR
	PROPOSED GRADING MAJOR
	GARD'N WISE FESCUE SOD
	PERENNIAL RYEGRASS SEED
	PRAIRIE 3 PLUS SEED



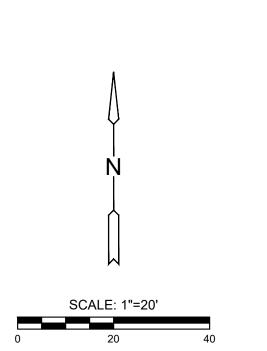

GENERAL LANDSCAPE NOTES

CONTRACTOR SHALL MAKE THEMSELVES FAMILIAR WITH ALL APPLICABLE SPECIFICATIONS RELATED TO THE LANDSCAPE AND IRRIGATION.

2. LANDSCAPE CONTRACTOR IS TO VERIFY THE LOCATION OF ALL UNDERGROUND UTILITIES (INCLUDING THOSE INDICATED ON THE PLAN) PRIOR TO INSTALLATION OF PLANT MATERIA.L. UTILITIES CAN BE FLAGGED BY CALLING 811, OR 1-800-344-7233, OR ONLINE AT www.kansasonecall.com. DAMAGE TO UTILITIES SHALL BE AVOIDED DURING THE COURSE OF WORK. THE LANDSCAPE CONTRACTOR IS RESPONSIBLE FOR REPAIRING ANY AND ALL DAMAGE TO UTILITIES, STRUCTURES, SITE APPURTENANCES, ETC. WHICH OCCUR AS A RESULT OF THE LANDSCAPE CONSTRUCTION.

3. LANDSCAPE CONTRACTOR SHALL COORDINATE WITH THE MASS GRADING CONTRACTOR TO INSURE THEY THOROUGHLY RIP AND ALLEVIATED ALL COMPACTED SOILS FROM THEIR HAULING AND PLACEMENT OPERATIONS.

4. ALL WATER REQUIRED FOR LANDSCAPE OPERATIONS AND FOR ESTABLISHING LANDSCAPE ON THIS SITE WILL BE PROVIDED BY THE OWNER FROM ON-SITE SOURCES AND SUPPLIED TO THE LANDSCAPE CONTRACTOR AT NO CHARGE.

5. PLANTING DATES FOR PLANT MATERIAL SHALL BE DURING THE MONTHS BETWEEN FEB. 15TH AND MAY 31ST OR SEPT. 15TH AND DEC. 15. PLANTING SHALL ONLY BE CONDUCTED WHEN THE GROUND IS NOT FROZEN, SNOW-COVERED, OR IN AN OTHERWISE UNSUITABLE CONDITION FOR PLANTING. DEVIATION FROM THE ABOVE PLANTING DATES WILL ONLY BE PERMITTED WITH APPROVAL FROM THE OWNER'S REPRESENTATIVE.

6. MULCHED LANDSCAPE BED EDGES SHALL BE LINED WITH PRO-STEEL EDGING (OR APPROVED EQUAL).

7. MULCH ADJACENT TO BUILDINGS SHALL BE FOUR (4) INCHES LOWER THAN BUILDING FINISH FLOOR ELEVATION.

8. ALL SHRUB/PERENNIAL PLANTING BEDS SHALL BE TREATED WITH A PRE-EMERGENT HERBICIDE SUCH AS TREFLAN OR EQUAL. APPLY AS PER MANUFACTURER'S RECOMMENDATION. THE PRE-EMERGENT SHALL NOT BE APPLIED UNTIL AFTER ALL PLANTING AND MULCHING WITHIN THESE AREAS ARE COMPLETE. DO NO DISTURB AREAS AFTER APPLICATION. WATER IN AS DIRECTED.

9. INSTALL 3" MIN. DEPTH FINE-SHREDDED, DARK HARDWOOD MULCH IN ALL PLANTING BED AREAS AND WITHIN A 4' DIAMETER CIRCLE AROUND ALL TREES PLANTED IN LAWN AREAS. PULL MULCH AWAY FROM TREE TRUNKS WITHIN 3" OF TRUNK.

10. IF POSSIBLE, BASED ON TIME OF YEAR SITE IS READY FOR LANDSCAPING, PLANT TREES PRIOR TO ROUTING/INSTALLING IRRIGATION LINES AND SUSTAIN TEMPORARILY BY WATERING WITH IRRI-"GATOR" SLOW DRIP IRRIGATION BAGS OR BY HAND WATERING. FOLLOW TREE PLANTING WITH INSTALLATION OF IRRIGATION SYSTEM, THEN BY SODDING AND SEEDING (IF APPLICABLE).

11. FESCUE SOD SHALL BE HARVESTED & PLACED BETWEEN THE DATES OF APRIL 1ST AND JUNE 15TH UNLESS OTHERWISE APPROVED BY THE OWNER'S REPRESENTATIVE. IT IS THE CONTRACTOR'S RESPONSIBILITY TO WATER ALL SOD UNTIL LANDSCAPE JOB IS COMPLETE.

12. AREAS DENOTED AS 'SOD' SHALL BE PLANTED WITH THE FOLLOWING GRASS TYPE:

GARD'N WISE FESCUE/BLUE, OBTAINABLE FROM CRANMER GRASS FARM, INC., 6121 N. 119TH, MAIZE, KANSAS 67101, PH# (316) 722-7230.

13. ALL SOD AREAS SHALL BE INSTALLED AS FOLLOWS: AFTER FINAL GRADE IS ESTABLISHED AND ALL SOIL AREAS DRAIN AS INTENDED, AND ALL SURFACE IRREGULARITIES HAVE BEEN REMOVED. THOROUGHLY PREPARE SODBED BY TILLING TO A MINIMUM DEPTH OF 3" AND HARROWING. ROLL SOD FOLLOWING LAYING FOR GOOD SOD/SOIL CONTACT AND KEEP IN A MOIST (BUT NOT SATURATED) CONDITION FOR FIRST TWO WEEKS TO PROMOTE GOOD ROOTING. FERTILIZE WITH 1 LB. ACTUAL NITROGEN PER 1,000 S.F. AT TIME OF PLANTING.

14. ALL LANDSCAPE AND TURF AREAS SHALL BE WATERED BY AN AUTOMATIC IRRIGATION SYSTEM. IRRIGATION SYSTEM SHALL BE EQUIPPED WITH A RAIN-SENSING DEVICE TO SHUT OFF THE SYSTEM DURING PERIODS OF ADEQUATE RAIN.

15. PLACEMENT OF IRRIGATION CONTROLLER SHALL BE COORDINATED WITH THE OWNER'S REPRESENTATIVE.

16. COORDINATE LANDSCAPE PLANTING WITH IRRIGATION CONTRACTOR. THE TREE PLANTINGS SHALL BE IN PLACE OR STAKED BEFORE IRRIGATION LINE ROUTING BEGINS TO AVOID CONFLICTS. THE IRRIGATION SYSTEM SHALL BE COMPLETE AND FULLY FUNCTIONAL IN ALL LAWN AREAS BEFORE SOD/SEED IS PLACED.

17. ALL PLANTS SHALL CONFORM TO ANSI Z60.1 FOR SIZE AND QUALITY STANDARDS.

18. LABEL EACH PLANT WITH A SECURELY ATTACHED, WATERPROOF TAG BEARING LEGIBLE DESIGNATION OF BOTH BOTANICAL AND COMMON NAME. DO NOT REMOVE UNTIL AFTER PROVISIONAL ACCEPTANCE.

19. SUBSTITUTION OF PLANT SPECIES FOR THOSE LISTED IN THE PLANT LIST IS NOT PERMISSIBLE. ONLY SIZE WILL BE CONSIDERED.

20. ALL PLANTS MUST BE HEALTHY, VIGOROUS MATERIAL; FREE OF PEST AND DISEASES. ALL PLANTS MUST BE CONTAINER-GROWN OR BALLED AND BURLAPPED AS INDICATED IN THE PLANT LIST. ALL TREES SHALL BE STRAIGHT-TRUNKED, OR OF TYPICAL FORM TO THE SPECIES, FULL-HEADED AND MEET THE REQUIREMENTS AS SPECIFIED. ALL TREES MUST BE STAKED.

21. STAKES AND GUYING SHALL BE REMOVED AT THE END OF ONE FULL GROWING SEASON.


22. ALL PLANTS ARE SUBJECT TO THE APPROVAL OF THE LANDSCAPE ARCHITECT BEFORE, DURING, AND AFTER INSTALLATION. REJECTED PLANTS SHALL BE REMOVED IMMEDIATELY.


23. ALL LANDSCAPE PLANTS SHALL BE GUARANTEED FOR ONE YEAR FOLLOWING INITIAL ACCEPTANCE. DEAD OR DEFICIENT PLANTINGS SHALL BE ACCEPTABLY REPLACED, IN PROPER PLANTING SEASON, ONE TIME AT NO COST TO THE OWNER. SOD AREAS MAY BE FINAL ACCEPTED AT TIME OF COMPLETION OF ESTABLISHMENT WITH NO FURTHER GUARANTEE REQUIRED.

24. LANDSCAPE CONTRACTOR SHALL BE RESPONSIBLE FOR MAINTAINING, (INCLUDING WATERING AND MOWING), SOD AREAS UNTIL ACCEPTANCE OF THESE AREAS. WHEN READY, THE LANDSCAPE CONTRACTOR SHALL REQUEST INSPECTION OF ESTABLISHED SODDED AREAS BY THE OWNER'S REPRESENTATIVE.

25. TOPSOIL FOR ALL LANDSCAPE BEDS AND PARKING ISLANDS SHALL BE A MINIMUM OF EIGHTEEN INCHES (18") DEPTH.

PLA	NT SCH	HEDULE			
CODE	QTY	COMMON NAME	BOTANICAL NAME	SIZE	
DECIDU	JOUS TREES				
OSO	6	OSAGE ORANGE	MACLURA POMIFERA	2" CAL. / B&B	
SWA	4	SWAMP WHITE OAK	QUERCUS BICOLOR	3" CAL. / B&B	
EVERG	REEN TREES	3			
CAN	28	CANAERTI JUNIPER	JUNIPERUS VIRGINIANA 'CANAERTII'	7`-8` MIN. HT.	
ERC	13	EASTERN RED CEDAR	JUNIPERUS VIRGINIANA	7`-8` MIN. HT.	
TAY	31	TAYLOR JUNIPER	JUNIPERUS VIRGINIANA 'TAYLOR'	7` - 8` MIN. HT.	
ORNAM	1ENTAL TREE	-8			
BUD	4	EASTERN REDBUD	CERCIS CANADENSIS	2" CAL. / B&B	
SHRUB	S				
FCR	28	FLOWER CARPET® PINK SUPREME GROUNDCOVER ROSE	ROSA X 'NOA168098F'	#1 CONT.	
SCB	160	SUFFRUTICOSA COMMON BOXWOOD	BUXUS SEMPERVIRENS 'SUFFRUTICOSA'	#1 CONT.	
		SSES/PERENNIALS			
BAB	280	BLONDE AMBITION BLUE GRAMA	BOUTELOUA GRACILIS 'BLONDE AMBITION'	#2 CONT.	
CODE	QTY	COMMON NAME	BOTANICAL NAME	SIZE	SPACING
SOD/SE	==D				
P3P	1,826 SF	PRAIRIE 3 PLUS		SEED	
PRG	7,654 SF	PERENNIAL RYEGRASS		SEED	
SOD	51,256 SF	FESCUE: GARD'N WISE 'FES/BLUE MIXTURE'		SOD	

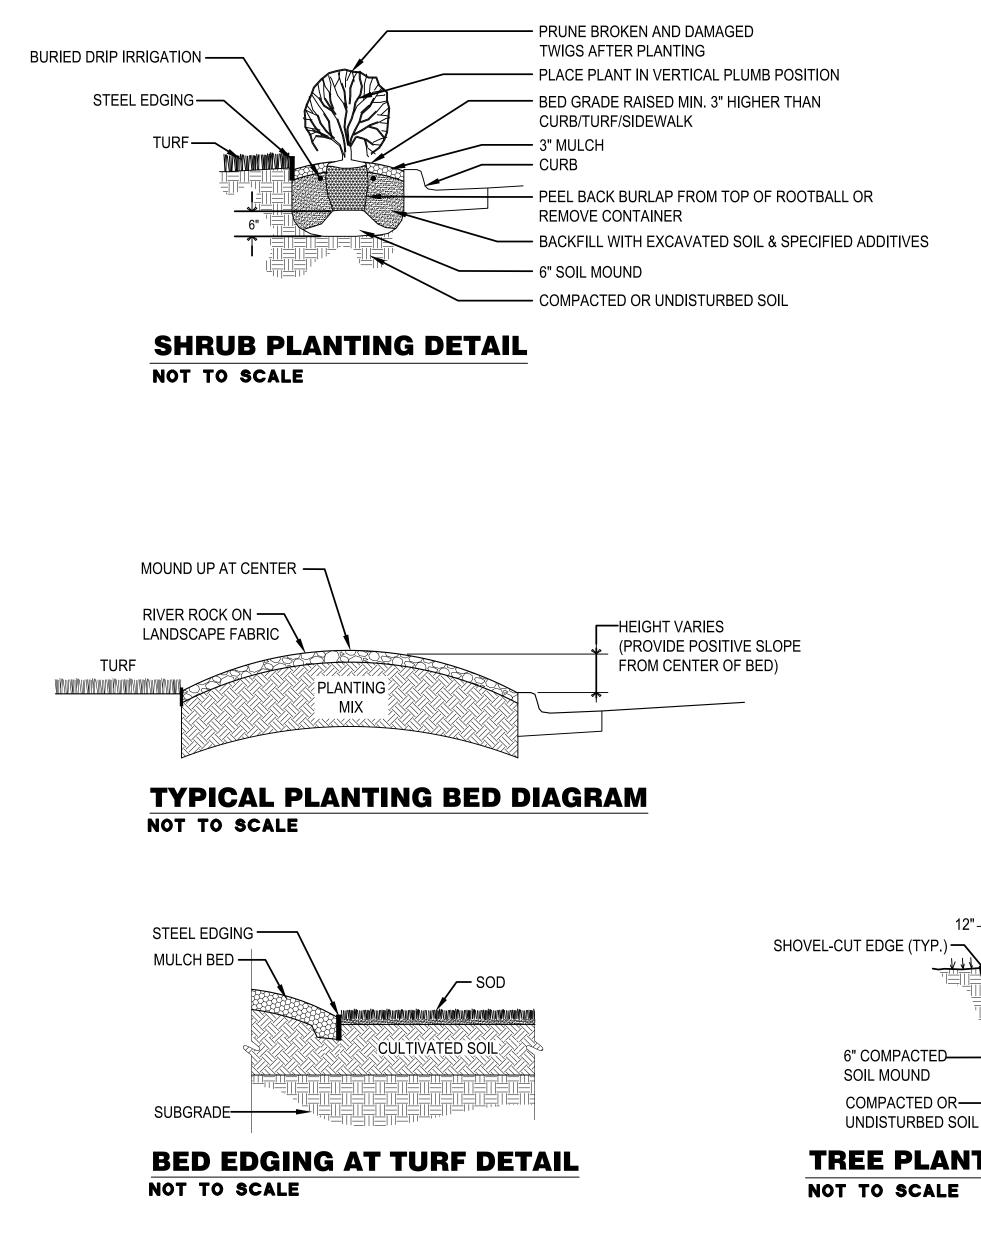

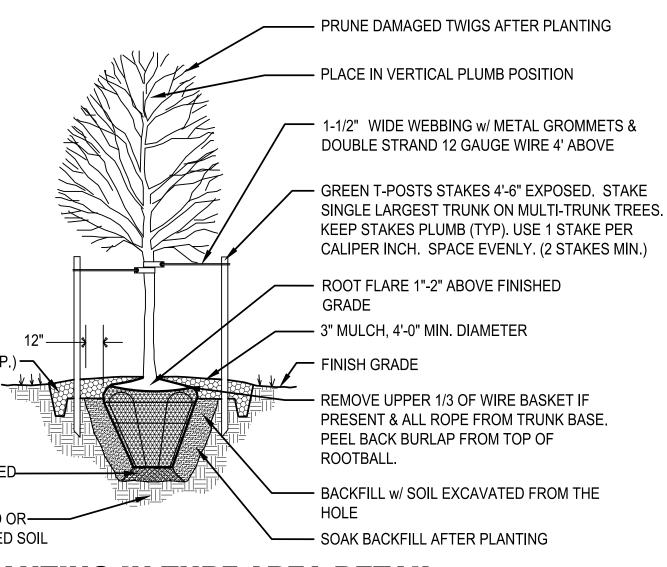

TREE PLANTING IN TURF AREA DETAIL

— 3" MULCH, 4'-0" MIN. DIAMETER - REMOVE UPPER 1/3 OF WIRE BASKET IF PRESENT & ALL ROPE FROM TRUNK BASE. PEEL BACK BURLAP FROM TOP OF - BACKFILL w/ SOIL EXCAVATED FROM THE - SOAK BACKFILL AFTER PLANTING

ANDOVI PRELIMINARY **PERMIT SET** NOT FOR **CONSTRUCTION** DUSTIN LOHMANNKS LA 881FOR PERMIT ONLY01/03/25 01/03/25 **REVISION:** DATE: 1-3-2025 24-3385 JOB: SHEET NO .:

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