
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BASEMENT PLAN NOTES

- SPALLED CONCRETE AND EXPOSED REBAR: REMOVE DELAMINATED AND DAMAGED CONCRETE TO SOUND CONCRETE. DEMO MUST PROVIDE 1" MINIMUM CLEAR ON ALL SIDES OF REBAR. CLEAN AND COAT ALL REBAR, TIE WIRE, AND BAR SUPPORTS WITH SIKA ARMATEC 110 EPOCEM. PATCH WITH SIKAQUICK VOH REPAIR MORTAR. FOR FULL SLAB DEPTH REPAIRS USE SIKACRETE 100 CI CONCRETE MIX.
- SPALLED CONCRETE: REMOVE DELAMINATED AND DAMAGED CONCRETE TO SOUND CONCRETE. PATCH WITH SIKAQUICK VOH REPAIR MORTAR.
- (3) REMOVE AND REPLACE LOOSE MASONRY UNITS.
- (5) REMOVE AND REPLACE HANDRAIL PER ARCHITECT'S SPECIFICATION.

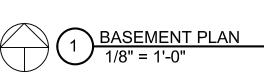

9-19-2025

 $\frac{3}{22-3243}$ SHEET NO.:

B. CONCRETE HONEYCOMBED: REMOVE ALL LOOSE CONCRETE AND PATCH WITH SIKAQUICK VOH REPAIR MORTAR.

C. OVERALL MASONRY CONDITION IS GOOD. CONTRACTOR TO VERIFY LOCATIONS OF CRACKS, VOIDS IN MORTAR, AND CRACKS THROUGH THE BRICK UNITS. LOCATION TO BE REPOINTED PER SPECIFICATIONS. REPLACE / RELOCATE MASONRY UNITS AS NEEDED. SEE SHEET S3.0 FOR EXAMPLES OF AREAS IN NEED OF REPOINTING.

D. COORDINATE WITH MECHANICAL / PLUMBING DRAWINGS FOR ALL SLAB PENETRATIONS.

 $\langle 1 \rangle$

- SPALLED CONCRETE AND EXPOSED REBAR: REMOVE DELAMINATED AND DAMAGED CONCRETE TO SOUND CONCRETE. DEMO MUST PROVIDE 1" MINIMUM CLEAR ON ALL SIDES OF REBAR. CLEAN AND COAT ALL REBAR, TIE WIRE, AND BAR SUPPORTS WITH SIKA ARMATEC 110 EPOCEM. PATCH WITH SIKAQUICK VOH REPAIR MORTAR. FOR FULL SLAB
 - DEPTH REPAIRS USE SIKACRETE 100 CI CONCRETE MIX. 4 VERIFY EXISTING PATCH REMAINS SOLID BY HAMMER SOUNDING METHOD. IF PATCH IS SOLID, NO REPAIR NEEDED. IF PATCH SHOWS SIGNS OF DELAMINATION REPAIR PER

FIRST FLOOR PLAN NOTES

SPALLED CONCRETE REPAIR METHOD. REMOVE DELAMINATED AND DAMAGED CONCRETE TO SOUND CONCRETE AT WINDOW SILL. PATCH WITH SIKAQUICK VOH REPAIR MORTAR.

9-19-2025

22-3243 SHEET NO.: **S1.1**

2. ATTACH PLATE TO ANGLE WITH 3/16" 3"@12" FILLET WELD (EACH SIDE)

CONDITION REPLACE EXISTING LINTEL WITH NEW AS SHOWN.

3. IF EXISTING LINTEL PRESENT. VERIFY CONDITION OF LINTEL TO REMAIN. IF POOR

	^ × ×
	MULTI-WYTH BRICK
	/
	T.O. OPENING X
	1/4" PLATE
3/16 3-12 <u>L-1</u>	


	-LINTEL PER PLAN
8"	
BR'G	1/4" PLATE


PLAN NOTES

- A. <u>EXPOSED CAST-IN CONDUIT:</u> REMOVE DELAMINATED AND DAMAGED CONCRETE TO SOUND CONCRETE. DEMO MUST PROVIDE 1" MINIMUM CLEAR ON ALL SIDES OF CONDUIT. PATCH WITH SIKAQUICK VOH REPAIR MORTAR.
- B. CONCRETE HONEYCOMBED: REMOVE ALL LOOSE CONCRETE AND PATCH WITH SIKAQUICK VOH REPAIR MORTAR.
- C. OVERALL MASONRY CONDITION IS GOOD. CONTRACTOR TO VERIFY LOCATIONS OF CRACKS, VOIDS IN MORTAR, AND CRACKS THROUGH THE BRICK UNITS. LOCATION TO BE REPOINTED PER SPECIFICATIONS. REPLACE / RELOCATE MASONRY UNITS AS NEEDED. SEE SHEET S3.0 FOR EXAMPLES OF AREAS IN NEED OF REPOINTING.
- D. COORDINATE WITH MECHANICAL / PLUMBING DRAWINGS FOR ALL SLAB PENETRATIONS.

SECOND FLOOR PLAN NOTES


- SPALLED CONCRETE: REMOVE DELAMINATED AND DAMAGED CONCRETE TO SOUND CONCRETE. PATCH WITH SIKAQUICK VOH REPAIR MORTAR.
- (3) REMOVE AND REPLACE LOOSE MASONRY UNITS.
- 4 VERIFY EXISTING PATCH REMAINS SOLID BY HAMMER SOUNDING METHOD. IF PATCH IS SOLID, NO REPAIR NEEDED. IF PATCH SHOWS SIGNS OF DELAMINATION REPAIR PER SPALLED CONCRETE REPAIR METHOD.

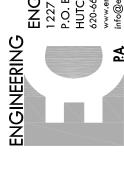

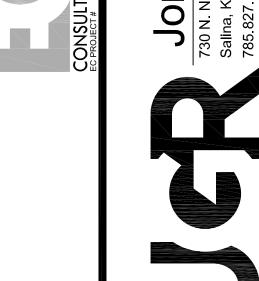

9-19-2025

22-3243 SHEET NO.:

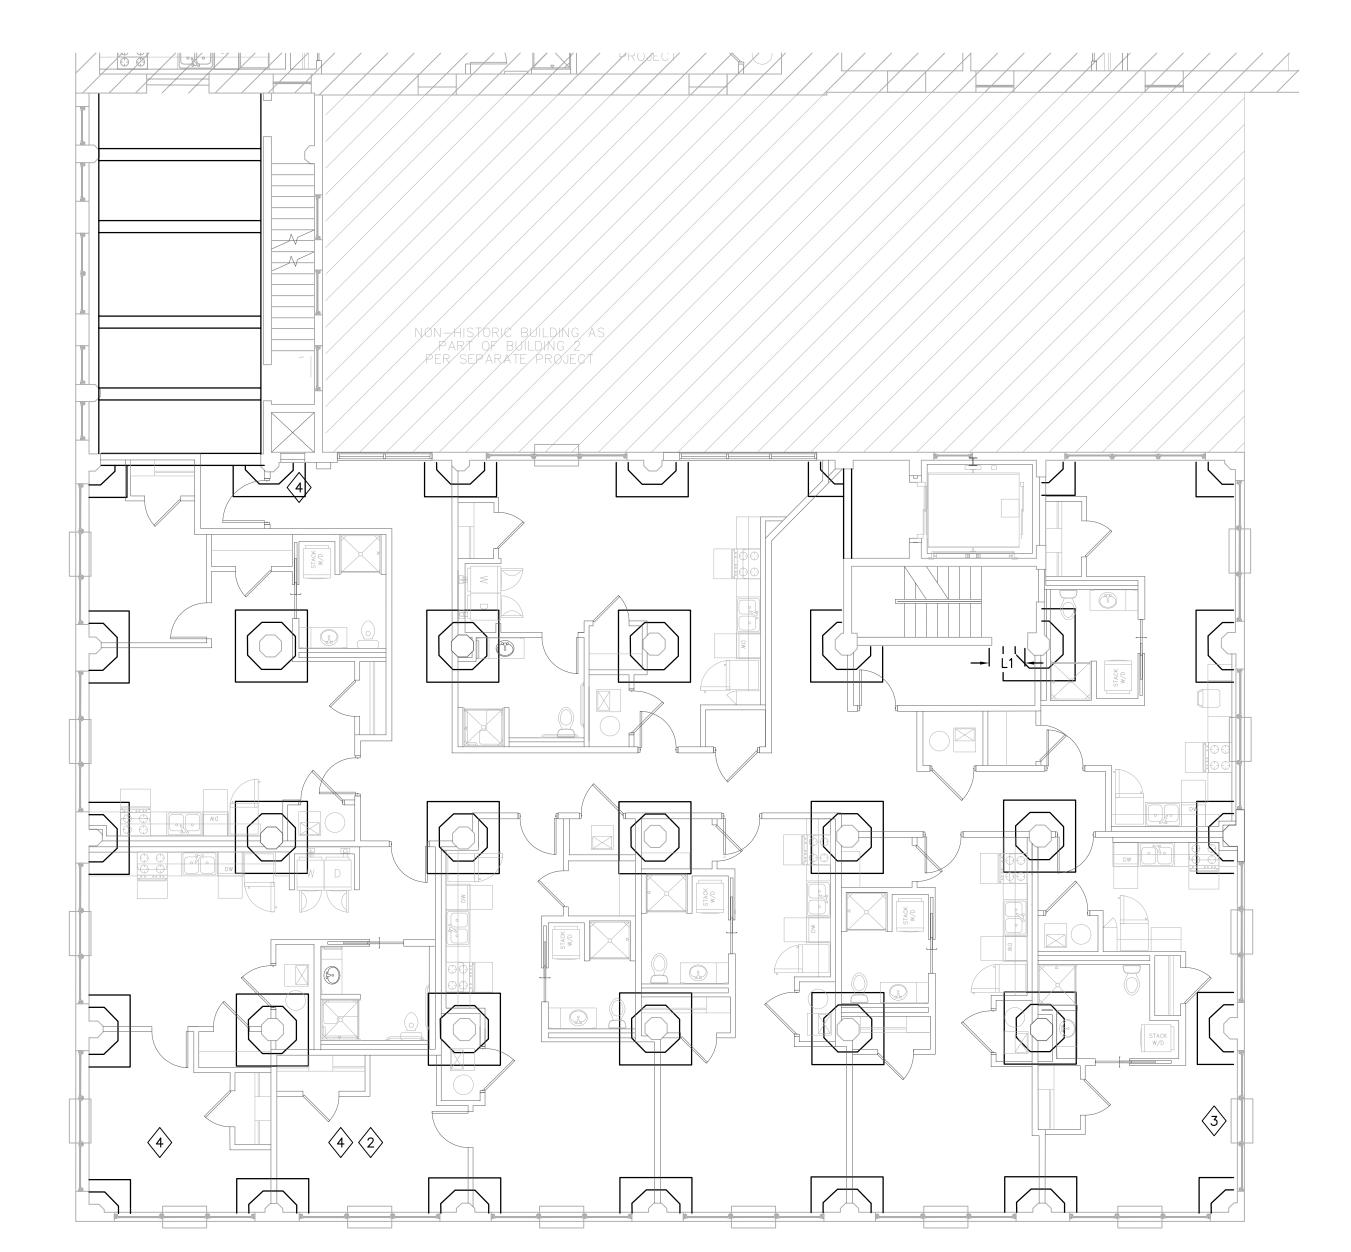


B. CONCRETE HONEYCOMBED: REMOVE ALL LOOSE CONCRETE AND PATCH WITH SIKAQUICK VOH REPAIR MORTAR.

C. OVERALL MASONRY CONDITION IS GOOD. CONTRACTOR TO VERIFY LOCATIONS OF CRACKS, VOIDS IN MORTAR, AND CRACKS THROUGH THE BRICK UNITS. LOCATION TO BE REPOINTED PER SPECIFICATIONS. REPLACE / RELOCATE MASONRY UNITS AS NEEDED. SEE SHEET S3.0 FOR EXAMPLES OF AREAS IN NEED OF REPOINTING.

D. COORDINATE WITH MECHANICAL / PLUMBING DRAWINGS FOR ALL SLAB PENETRATIONS.

- THIRD FLOOR PLAN NOTES
- SPALLED CONCRETE AND EXPOSED REBAR: REMOVE DELAMINATED AND DAMAGED CONCRETE TO SOUND CONCRETE. DEMO MUST PROVIDE 1" MINIMUM CLEAR ON ALL SIDES OF REBAR. CLEAN AND COAT ALL REBAR, TIE WIRE, AND BAR SUPPORTS WITH SIKA ARMATEC 110 EPOCEM. PATCH WITH SIKAQUICK VOH REPAIR MORTAR. FOR FULL SLAB DEPTH REPAIRS USE SIKACRETE 100 CI CONCRETE MIX.
- 4 VERIFY EXISTING PATCH REMAINS SOLID BY HAMMER SOUNDING METHOD. IF PATCH IS SOLID, NO REPAIR NEEDED. IF PATCH SHOWS SIGNS OF DELAMINATION REPAIR PER SPALLED CONCRETE REPAIR METHOD.
- (5) REMOVE AND REPLACE HANDRAIL PER ARCHITECT'S SPECIFICATION.

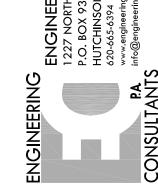



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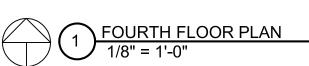
- A. <u>EXPOSED CAST-IN CONDUIT:</u> REMOVE DELAMINATED AND DAMAGED CONCRETE TO SOUND CONCRETE. DEMO MUST PROVIDE 1" MINIMUM CLEAR ON ALL SIDES OF CONDUIT. PATCH WITH SIKAQUICK VOH REPAIR MORTAR.
- B. <u>CONCRETE HONEYCOMBED:</u> REMOVE ALL LOOSE CONCRETE AND PATCH WITH SIKAQUICK VOH REPAIR MORTAR.
- C. OVERALL MASONRY CONDITION IS GOOD. CONTRACTOR TO VERIFY LOCATIONS OF CRACKS, VOIDS IN MORTAR, AND CRACKS THROUGH THE BRICK UNITS. LOCATION TO BE REPOINTED PER SPECIFICATIONS. REPLACE / RELOCATE MASONRY UNITS AS NEEDED. SEE SHEET S3.0 FOR EXAMPLES OF AREAS IN NEED OF REPOINTING.
- D. COORDINATE WITH MECHANICAL / PLUMBING DRAWINGS FOR ALL SLAB PENETRATIONS.

FOURTH FLOOR PLAN NOTES

SPALLED CONCRETE AND EXPOSED REBAR: REMOVE DELAMINATED AND DAMAGED CONCRETE TO SOUND CONCRETE. DEMO MUST PROVIDE 1" MINIMUM CLEAR ON ALL SIDES OF REBAR. CLEAN AND COAT ALL REBAR, TIE WIRE, AND BAR SUPPORTS WITH SIKA ARMATEC 110 EPOCEM. PATCH WITH SIKAQUICK VOH REPAIR MORTAR. FOR FULL SLAB DEPTH REPAIRS USE SIKACRETE 100 CI CONCRETE MIX.



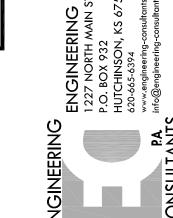

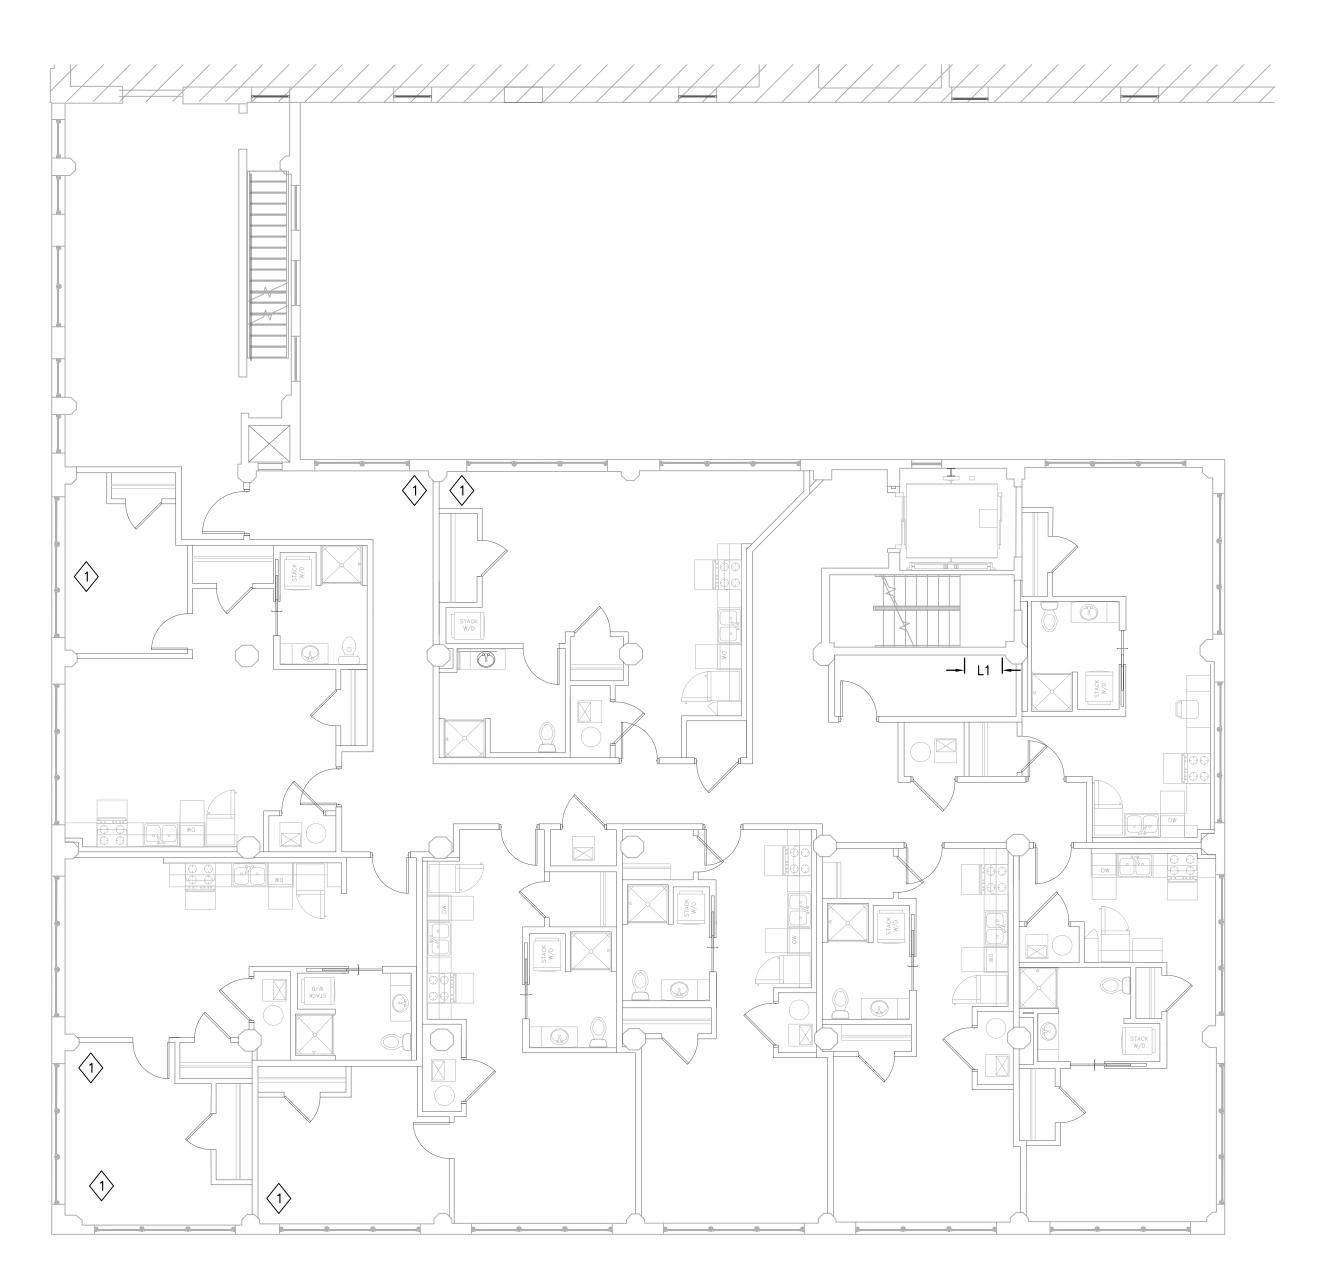

9-19-2025

22-3243 SHEET NO.:

- A. <u>EXPOSED CAST-IN CONDUIT:</u> REMOVE DELAMINATED AND DAMAGED CONCRETE TO SOUND CONCRETE. DEMO MUST PROVIDE 1" MINIMUM CLEAR ON ALL SIDES OF CONDUIT. PATCH WITH SIKAQUICK VOH REPAIR MORTAR.
- B. <u>CONCRETE HONEYCOMBED:</u> REMOVE ALL LOOSE CONCRETE AND PATCH WITH SIKAQUICK VOH REPAIR MORTAR.
- C. OVERALL MASONRY CONDITION IS GOOD. CONTRACTOR TO VERIFY LOCATIONS OF CRACKS, VOIDS IN MORTAR, AND CRACKS THROUGH THE BRICK UNITS. LOCATION TO BE REPOINTED PER SPECIFICATIONS. REPLACE / RELOCATE MASONRY UNITS AS NEEDED. SEE SHEET S3.0 FOR EXAMPLES OF AREAS IN NEED OF REPOINTING.
- D. COORDINATE WITH MECHANICAL / PLUMBING DRAWINGS FOR ALL SLAB PENETRATIONS.

FIFTH FLOOR PLAN NOTES

- SPALLED CONCRETE AND EXPOSED REBAR: REMOVE DELAMINATED AND DAMAGED CONCRETE TO SOUND CONCRETE. DEMO MUST PROVIDE 1" MINIMUM CLEAR ON ALL SIDES OF REBAR. CLEAN AND COAT ALL REBAR, TIE WIRE, AND BAR SUPPORTS WITH SIKA ARMATEC 110 EPOCEM. PATCH WITH SIKAQUICK VOH REPAIR MORTAR. FOR FULL SLAB DEPTH REPAIRS USE SIKACRETE 100 CI CONCRETE MIX.
- REMOVE AND REPLACE LOOSE MASONRY UNITS.



9-19-2025


22-3243 SHEET NO.:

- A. MASONRY CONDITION IS GOOD AT DOG HOUSE. CONTRACTOR TO VERIFY LOCATIONS OF CRACKS, VOIDS IN MORTAR, AND CRACKS THROUGH THE BRICK UNITS. LOCATION TO BE REPOINTED PER SPECIFICATIONS. REPLACE / RELOCATE MASONRY UNITS AS NEEDED. SEE SHEET S3.0 FOR EXAMPLES OF AREAS IN NEED OF REPOINTING.
- B. PARAPET TO BE REPOINTED IN ITS ENTIRETY. REPOINT PER SPECIFICATIONS. REPLACE / RELOCATE MASONRY UNITS AS NEEDED.

STAIR/ELEVATOR PENTHOUSE

ROOF PLAN NOTES

- SPALLED CONCRETE AND EXPOSED REBAR: REMOVE DELAMINATED AND DAMAGED CONCRETE TO SOUND CONCRETE. DEMO MUST PROVIDE 1" MINIMUM CLEAR ON ALL SIDES OF REBAR. CLEAN AND COAT ALL REBAR, TIE WIRE, AND BAR SUPPORTS WITH SIKA ARMATEC 110 EPOCEM. PATCH WITH SIKAQUICK VOH REPAIR MORTAR. FOR FULL SLAB DEPTH REPAIRS USE SIKACRETE 100 CI CONCRETE MIX.
- 7 INSUFFICIENT LADDER AT ROOF. REPLACE WITH ADEQUATE LADDER SYSTEM.

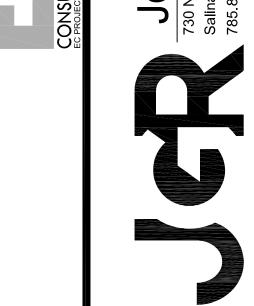

9-19-2025 22-3243 SHEET NO.:

PLAN NOTES

A. ANTICIPATED FLOOR REINFORCEMENT LAYOUT. SHADED AREAS INDICATE SINGLE LAYER OF REINFORCEMENT. SHADED AREAS ARE THE PREFERRED AREA FOR FLOOR PENETRATIONS. COORDINATE WITH MECHANICAL / PLUMBING DRAWINGS FOR LOCATIONS OF SLAB PENETRATIONS. FIELD LOCATE REBAR AT LOCATIONS PRIOR TO CUTTING OPENING. RELOCATE PENETRATION WHERE POSSIBLE TO AVOID CUTTING EXISTING REBAR IN SLAB.

SHEET NO.:

S1.7

9-19-2025 22-3243

C. HATCH PATTERN INDICATES AREA OF REPOINTING REPAIR OF PARAPET. REPOINT PER

SPECIFICATIONS. REPLACE / RELOCATE MASONRY UNITS AS NEEDED.

DEPTH REPAIRS USE SIKACRETE 100 CI CONCRETE MIX. (7) INSUFFICIENT LADDER AT ROOF. REPLACE WITH ADEQUATE LADDER SYSTEM.

(8) REPAIR WINDOW SILL TO ORIGINAL CONDITION.

(9) INFILL MISSING MASONRY UNITS AT PREVIOUS LOWER ROOF LEVEL

(10) REPLACE BROKEN MASONRY UNITS ABOVE WINDOW.

1

1 EAST ELEVATION 1/8" = 1'-0"

91'-1 1/4" BASEMENT

2 WEST ELEVATION 1/8" = 1'-0"

144'-4" FIFTH FLOOR

134'-2 1/2" FOURTH FLOOR

112'-10 1/2" SECOND FLOOR

100'-0" FIRST FLOOR

REVISION:


9-19-2025 22-3243 SHEET NO .:

SPECIFICATIONS. REPLACE / RELOCATE MASONRY UNITS AS NEEDED.

A. REPOINT ALL WINDOW SILLS PER REPOINTING SPECIFICATIONS. B. HATCH PATTERN INDICATES AREA OF REPOINTING REPAIR OF PARAPET. REPOINT PER

MASONRY NOTES

- SPALLED CONCRETE AND EXPOSED REBAR: REMOVE DELAMINATED AND DAMAGED CONCRETE TO SOUND CONCRETE. DEMO MUST PROVIDE 1" MINIMUM CLEAR ON ALL SIDES OF REBAR. CLEAN AND COAT ALL REBAR, TIE WIRE, AND BAR SUPPORTS WITH SIKA ARMATEC 110 EPOCEM. PATCH WITH SIKAQUICK VOH REPAIR MORTAR. FOR FULL SLAB DEPTH REPAIRS USE SIKACRETE 100 CI CONCRETE MIX.
- (2) <u>SPALLED CONCRETE:</u> REMOVE DELAMINATED AND DAMAGED CONCRETE TO SOUND CONCRETE. PATCH WITH SIKAQUICK VOH REPAIR MORTAR.
- 4 VERIFY EXISTING PATCH REMAINS SOLID BY HAMMER SOUNDING METHOD. IF PATCH IS SOLID, NO REPAIR NEEDED. IF PATCH SHOWS SIGNS OF DELAMINATION REPAIR PER SPALLED CONCRETE REPAIR METHOD.
- (11) EPOXY INJECT CONCRETE CRACKS WITH KEMKO EPOXY.
- CONCRETE HONEYCOMBED. REMOVE ALL LOOSE CONCRETE AND PATCH WITH SIKAQUICK VOH REPAIR MORTAR.

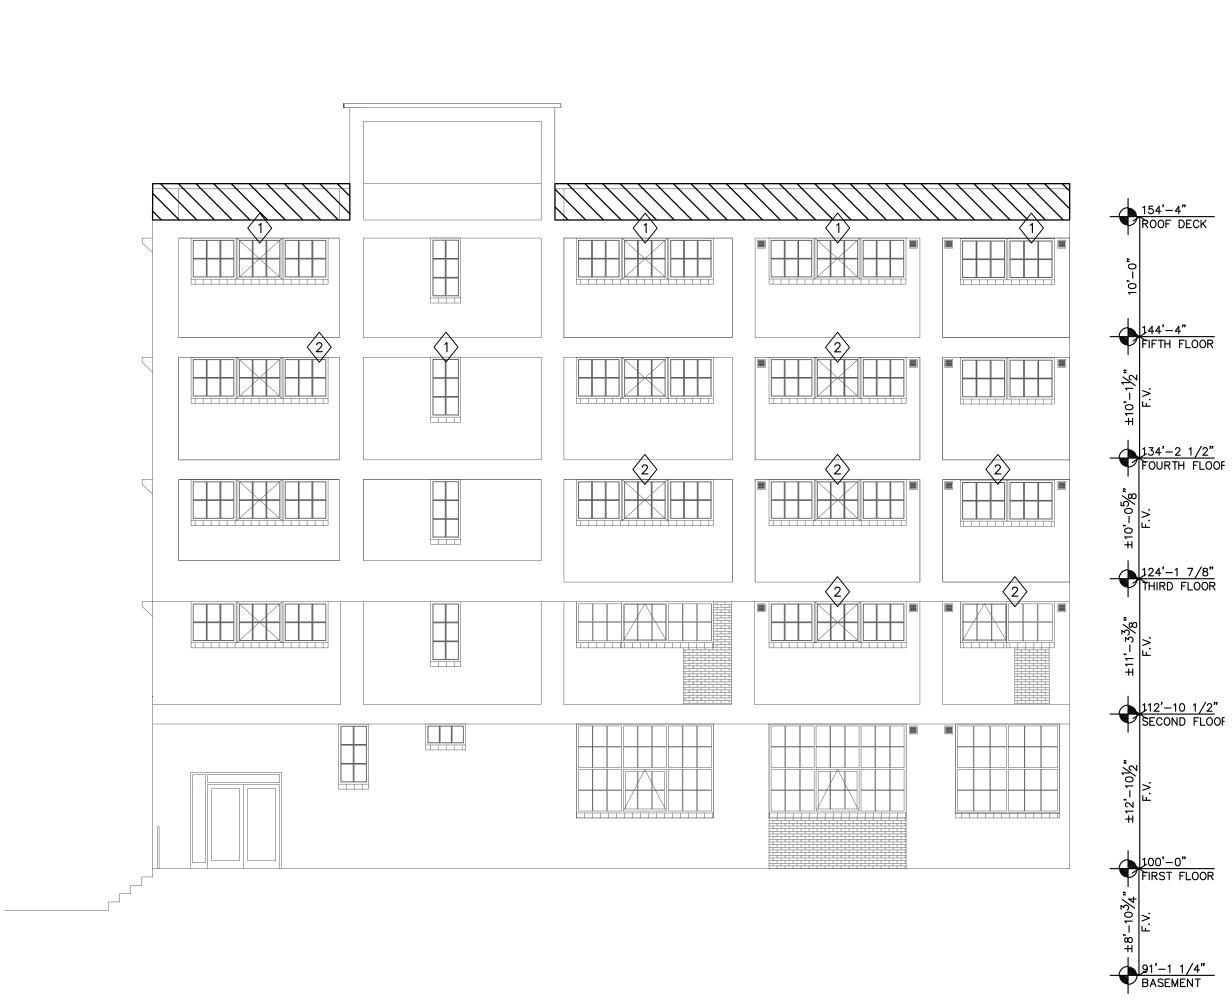

1 SOUTH ELEVATION 1/8" = 1'-0"

2

144'-4" FIFTH FLOOR

134'-2 1/2" FOURTH FLOOR

124'-1 7/8" THIRD FLOOR

112'-10 1/2" SECOND FLOOR

100'-0" FIRST FLOOR

NORTH ELEVATION
1/8" = 1'-0"

HISTORIC

REVISION:

9-19-2025 22-3243 SHEET NO .:

S2.1

9-19-2025 22-3243

SHEET NO.:

S3.0